
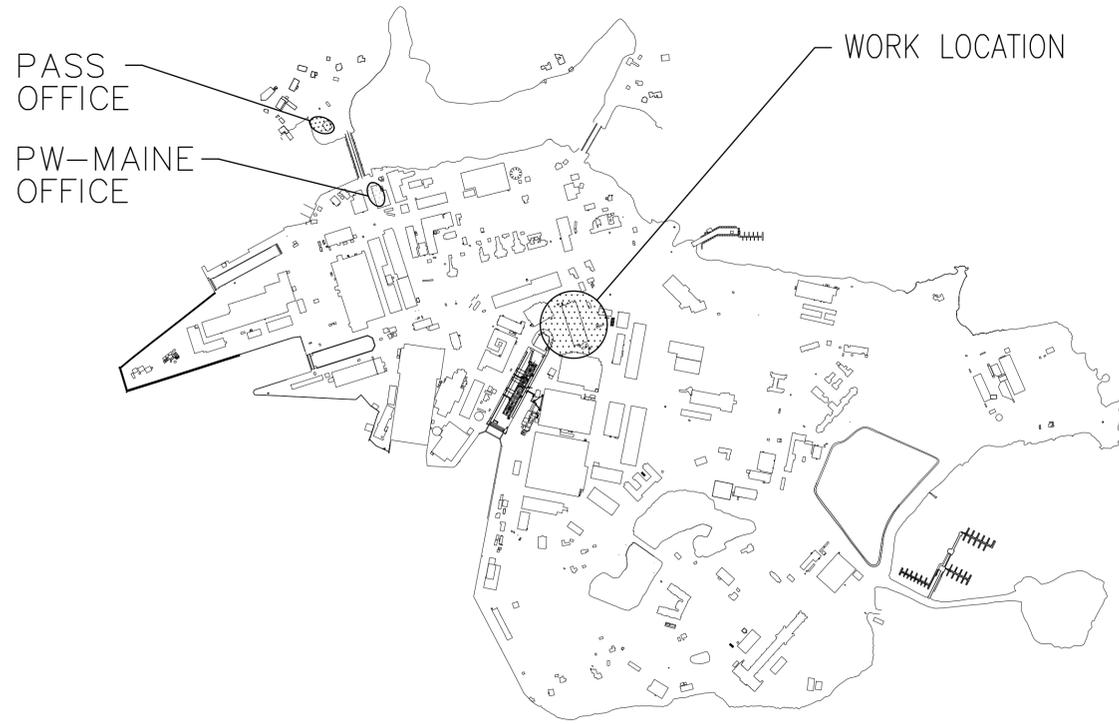


# PORTSMOUTH NAVAL SHIPYARD KITTERY, ME


## BLDG 79 2ND & 3RD FLOOR RENOVATIONS – OPTION 2

### LIST OF DRAWINGS


SHEET	SHEET NO.	PWD-ME NO.	NAVFAC DWG. NO.	DRAWING TITLE
1 OF 6	G001	XXX-XX-XXX	1591147	TITLE SHEET
2 OF 6	G002		1591148	GENERAL NOTES
3 OF 6	G101		1591149	LAYDOWN PLAN
4 OF 6	A101		1591150	ROOF PLAN
5 OF 6	A201		1591151	EXTERIOR ELEVATIONS
6 OF 6	A501		1591152	DETAIL

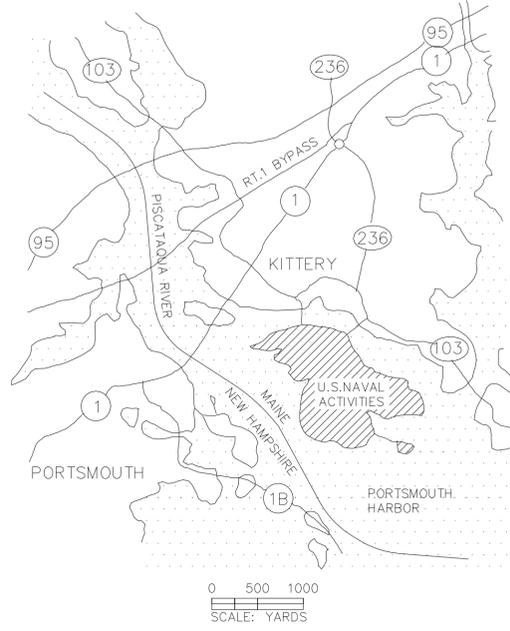

### ELEVATION, SECTION OR DETAIL SYMBOLS

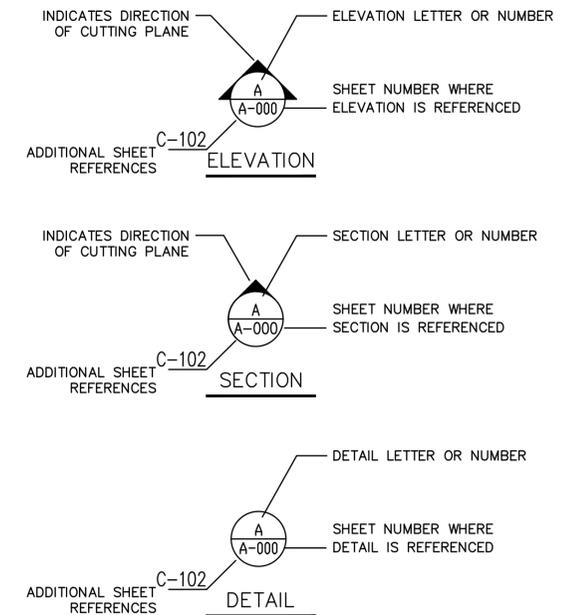

DATE	DESCRIPTION	BY	APPR
09/27/2022 <td>OPTION 2 <td>DM <td>DM </td></td></td>	OPTION 2 <td>DM <td>DM </td></td>	DM <td>DM </td>	DM
	ISSUED FOR BID <td>DM <td>DM </td></td>	DM <td>DM </td>	DM

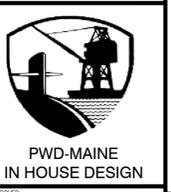

DESIGNER	DON DRIVER
DRAWN BY	DAVID HICKMAN
CHECKED BY	DAVID HOPPER
DESIGN MANAGER	DON DRIVER
PROJECT MANAGER	DAVID HOPPER
HEAD/PM/ME	JEFF HOYT
FIRE PROTECTION	XXX

DEPARTMENT OF THE NAVY  
NAVAL FACILITIES ENGINEERING COMMAND  
NAVAL FACILITIES ENGINEERING COMMAND - MID-ATLANTIC  
PUBLIC WORKS DEPARTMENT - MAINE  
PORTSMOUTH NAVAL SHIPYARD - PORTSMOUTH, ME  
KITTERY, MAINE  
B79 2ND & 3RD FLOOR RENOVATIONS  
- OPTION 2  
TITLE SHEET

PROJECT NO.:	1618057
NAVFAC DRAWING NO.:	1591147
SHEET ##	OF ##
G001	FAC-YR-NUM

FILE NAME: C:\Users\lois.dromas\AppData\Local\Temp\AcPublish\_1466A\2019\_1618057\_Bldg 79 Repair Roof and Reprint Brick Wall Over 1st Floor - Mod 2.dwg LAYOUT NAME: C001 PLOTTED: Thursday, September 29, 2022 - 12:47pm USER: lois.dromas

**GENERAL NOTES**

- PLANS HAVE BEEN COMPILED FROM EXISTING RECORD PLANS, ON-SITE FIELD SURVEY AND OBSERVATION.
- UNLESS OTHERWISE NOTED, ALL EXISTING FEATURES DESIGNATED ON THE PLANS TO REMAIN INCLUDING, BUT NOT LIMITED TO, TREES, SIGNS, SIGN POSTS, CURBS, SIDEWALKS AND BACK OF SIDEWALK FEATURES MUST BE VERIFIED, LOCATED, AND PROTECTED DURING ALL PHASES OF CONSTRUCTION.
- PREVENT ANY DISTURBANCE OR DAMAGE TO ADJACENT PROPERTIES.
- YELLOW PLASTIC:**  
DO NOT USE YELLOW OR ORANGE-YELLOW COLORED MATERIALS FOR THE FOLLOWING PURPOSES: PROTECTIVE CLOTHING, HOODS, SHEETING, TARPS, POLYETHYLENE BOTTLES OR OTHER CONTAINERS, TAPES, BAGS, BANDING, IDENTIFICATION MARKS ON TOOLS, BOUNDARY MARKERS, RIBBONS, VENT DUCTS, ETC. CONTRACTOR GENERATED YELLOW COLORED WASTE MUST BE DISPOSED OF BY THE CONTRACTOR OFF-YARD. SHIPYARD REFUSE CONTAINERS MUST NOT BE USED FOR THE DISPOSAL OF YELLOW COLORED WASTE MATERIALS. YELLOW COLORED ITEMS SUCH AS DESCRIBED ABOVE ARE OF SPECIAL SIGNIFICANCE WITHIN THE SHIPYARD AND ARE SUBJECT TO STRICT CONTROLS. YELLOW COLORED CONTRACT GENERATED DEBRIS MUST BE BAGGED IN NON-TRANSLUCENT CONTAINERS, AND PROMPTLY REMOVED FROM PORTSMOUTH NAVAL SHIPYARD.
- REPORT ALL SPILLS AND LEAKS OF OIL OR OTHER HAZARDOUS SUBSTANCES. (IE OIL, ANTIFREEZE, CHEMICALS, ETC.) OCCURRING DURING THE PERFORMANCE OF THIS CONTRACT IMMEDIATELY UPON DISCOVERY, REGARDLESS OF THE QUANTITY. CALL THE FIRE DEPARTMENT AND CONTRACTING OFFICER TO REPORT THE SPILL. THE GOVERNMENT RESERVES THE RIGHT TO CLEAN UP, PACKAGE AND DISPOSE OF CONTRACTOR SPILLS OCCURRING ON THE SHIPYARD, AND BILL SUCH COSTS TO THE CONTRACTOR.
- UNFORESEEN HAZARDOUS MATERIAL  
THE DESIGN HAS IDENTIFIED MATERIALS SUCH AS PCB, LEAD PAINT, AND FRIABLE AND NON-FRIABLE ASBESTOS. IF ADDITIONAL MATERIAL, NOT INDICATED, THAT MAY BE HAZARDOUS TO HUMAN HEALTH UPON DISTURBANCE DURING CONSTRUCTION OPERATIONS IS ENCOUNTERED, STOP THAT PORTION OF WORK AND NOTIFY THE CONTRACTING OFFICER IMMEDIATELY.

**UTILITY NOTES:**

- PREVENT DEBRIS FROM ENTERING INLETS AND BASINS. PROVIDE AND MAINTAIN INLET PROTECTION FOR THE DURATION OF THE WORK. INSPECT INLETS WEEKLY AND AFTER EACH STORM EVENT, AND REMOVE ACCUMULATED DEBRIS. CLEAN ALL STRUCTURES AT THE COMPLETION OF THE WORK.

**CONSTRUCTION NOTES:**

- AVAILABLE STORAGE AND LAYDOWN AREAS ARE EXPLICITLY SHOWN ON THE DRAWINGS. NO OTHER SPACE IS AVAILABLE. COORDINATE FINAL DETAILS WITH THE CONTRACTING OFFICER.
- ALL CONSTRUCTION MATERIALS MUST BE TRANSPORTED TO AND FROM THE SITE IN COVERED VEHICLES. PROVIDE VACUUM ASSISTED STREET SWEEPER AT THE SITE AS NECESSARY TO KEEP TRAFFIC AREAS CLEAN.
- COORDINATE WITH PORTSMOUTH SHIPYARD OPERATIONS DURING THE PROCESS OF THE WORK.
- SUBMIT A DETAILED CONSTRUCTION SEQUENCING PLAN FOR REVIEW AND APPROVAL PRIOR TO CONSTRUCTION.
- MAINTAIN SECURITY AT ALL TIMES DURING CONSTRUCTION.
- COMPLY WITH ALL APPLICABLE O.S.H.A. REGULATIONS AND SAFETY REQUIREMENTS.
- ALL CONSTRUCTION SIGNS MUST BE DESIGNED TO WITHSTAND 50MPH WINDS VELOCITY WINDS AND BE PREPARED BY A PROFESSIONAL SIGN COMPANY WITH A MINIMUM OF THREE (3) YEARS EXPERIENCE.
- WHERE CONTRACTOR REMOVES EXISTING SITE FEATURES THAT ARE TO REMAIN TO FACILITATE INSTALLATION OF NEW WORK FOR THIS PROJECT, REPLACE THE EXISTING SITE FEATURES AT CONTRACTORS EXPENSE.
- THE CONSTRUCTION LIMIT LINE SHOWN ON DRAWING IS AN APPROXIMATION OF THE CONSTRUCTION LIMITS. THE CONTRACTOR IN COORDINATION WITH THE CONTRACTING OFFICER MAY MODIFY THIS LINE TO ACCOMMODATE THE EFFICIENCY OF CONSTRUCTION PROJECT.

**GENERAL REMOVALS NOTES**

- COORDINATE REMOVAL OF DEBRIS WITH THE CONTRACTING OFFICER TO MINIMIZE DISRUPTION OF SHIPYARD ACTIVITIES. COORDINATE WITH WASTE MANAGEMENT PLAN.
- FILL, PATCH, PAINT OR OTHERWISE REFINISH TO MATCH EXISTING REMAINING SURFACES DISTURBED BY REMOVALS OR RELOCATIONS.
- ANY MATERIALS THAT ARE SUSPECTED TO CONTAIN HAZARDOUS MATERIALS AND DISCOVERED IMMEDIATELY STOP WORK AND REPORT THE CONDITION TO THE CONTRACTING OFFICER.

**GENERAL CONSTRUCTION NOTES**

- WORK INCLUDED IN THIS CONTRACT SHALL CONFORM TO STATE, FEDERAL, NATIONAL AND OTHER CODES AND ORDINANCES THAT APPLY TO THIS PROJECT.
- WORK SHALL BE COMPLETED IN COMPLIANCE WITH INDUSTRY STANDARDS AND PERFORMED IN A WORKMANLIKE PROFESSIONAL MANNER.
- MAINTAIN BUILDING EGRESS PATHS DURING THE ENTIRE CONTRACT PERIOD. COORDINATE WITH CONTRACTING OFFICER.
- DURING THE ENTIRE CONTRACT PERIOD, MAINTAIN THE CONSTRUCTION SITE IN A SECURE, NEAT, CLEAN AND SAFE MANNER.
- ITEMS AND COMPONENTS SHOWN ON THE DRAWINGS SHALL BE PROVIDED BY THE CONTRACTOR UNLESS NOTED AS EXISTING.
- WORK FROM GIVEN DIMENSIONS AND LARGE SCALE DETAILS. DO NOT SCALE DRAWINGS.
- CARE SHALL BE TAKEN TO PROTECT EXISTING SYSTEMS AND SURFACES TO REMAIN. DAMAGE RESULTING FROM THE CONTRACTOR'S OPERATIONS SHALL BE REPAIRED OR REPLACED AS APPROVED BY THE CONTRACTING OFFICER AT NO ADDITIONAL COST TO THE GOVERNMENT.
- OBTAIN APPROVAL FROM THE CONTRACTING OFFICER FOR THE SEQUENCE AND TIMING OF OPERATIONS PRIOR TO COMMENCING WORK.

**ABBREVIATIONS**

⊙	AT	HGT	HEIGHT	TOS	TOP OF STEEL
&	AND	HM	HOLLOW METAL	TOW	TOP OF WALL
±	PLUS OR MINUS	HORIZ	HORIZONTAL	TS	TRANSITION STRIP
ACM	ASBESTOS CONTAINING MATERIAL	HPCA	HIGH PRESSURE COMPRESSED AIR	TYP	TYPICAL
AFF	ABOVE FINISHED FLOOR	HR	HOUR	UNO	UNLESS NOTED OTHERWISE
ALUM	ALUMINUM	IN	INCHES	VCT	VINYL COMPOSITION TILE
BF	BARRIER FREE	INSUL	INSULATED, INSULATION	VERT	VERTICAL
BLDG	BUILDING	LPCA	LOW PRESSURE COMPRESSED AIR	VIF	VERIFY IN FIELD
BOT	BOTTOM	MAX	MAXIMUM	W/	WITH
BS	BOTH SIDES	MDF	MEDIUM DENSITY FIBERBOARD	W	WEST
Q	CENTERLINE	MECH	MECHANICAL	WD	WOOD
CIA	CONTROLLED INDUSTRIAL AREA	MFR	MANUFACTURER	WF	WIDE FLANGE
CLG	CEILING	MIN	MINIMUM	WR	EXTRUDED POLYSTYRENE
CLR	CLEAR	MIR	MIRROR IMAGE		
CMU	CONCRETE MASONRY UNIT	MO	MASONRY OPENING		
COL	COLUMN	MR	MOISTURE RESISTANT		
CONC	CONCRETE	MTL	METAL		
CONT	CONTINUOUS	N	NORTH		
CUST	CUSTODIAL	NIC	NOT IN CONTRACT		
DF	DRINKING FOUNTAIN	NO, #	NUMBER		
DIA	DIAMETER	NOM	NOMINAL		
DN	DOWN	NUC	NUCLEAR		
DWG	DRAWING	OC	ON CENTER		
E	EAST	PBO	PROVIDED BY OTHERS		
EA	EACH	PCB	POLYCHLORINATED BIPHENYL		
EF	EXHAUST FAN	PERP	PERPENDICULAR		
EJ	EXPANSION JOINT	PLAM	PLASTIC LAMINATE		
ELEC	ELECTRIC	PLYWD	PLYWOOD		
ELEV	ELEVATION	PNT	PAINT		
EQ	EQUAL	PSF	POUNDS PER SQUARE FOOT		
EQUIP	EQUIPMENT	PSI	POUNDS PER SQUARE INCH		
EWC	ELECTRIC WATER COOLER	PW	PUBLIC WORKS		
EXIST	EXISTING	PWD	PUBLIC WORKS DEPARTMENT		
EXPR	EXPRESSING	RCB	RUBBER COVE BASE		
FBC	FURNISHED BY CONTRACTOR	RD	ROOF DRAIN		
FBG	FURNISHED BY GOVERNMENT	REINF	REINFORCED		
FE	FIRE EXTINGUISHER	REQD	REQUIRED		
FEC	FIRE EXTINGUISHER CABINET	RO	ROUGH OPENING		
FF	FINISH FLOOR	RM	ROOM		
FL,FLR	FLOOR	RUB	RUBBER		
FNDN	FOUNDATION	S	SOUTH		
FR	FIRE RATED	SIM	SIMILAR		
FRT	FIRE RATED TREATED	SOW	SCOPE OF WORK		
FT	FOOT	SQ	SQUARE		
GA	GAUGE	SSC	SOLID SURFACE COUNTERTOP		
GFGI	GOVERNMENT FURNISHED, GOVERNMENT INSTALLED	STL	STEEL		
GYP BD	GYPSUM BOARD	SYS	SYSTEM		



APPROVED

FOR COMMANDER NAVFAC

ACTIVITY

SATISFACTORY TO DATE

DESIGNER: DON DRIVER

DRAWN BY: DAVID HICKMAN

CHECKED BY: DAVID HOPPER

DESIGN MANAGER: DON DRIVER

PROJECT MANAGER: DAVID HOPPER

HEAD/PM/ME: JEFF HOYT

FIRE PROTECTION: XXX

DEPARTMENT OF THE NAVY  
NAVAL FACILITIES ENGINEERING COMMAND  
NAVAL FACILITIES ENGINEERING COMMAND - MID-ATLANTIC  
PUBLIC WORKS DEPARTMENT - MAINE  
PORTSMOUTH NAVAL SHIPYARD - PORTSMOUTH, MAINE  
KITTERY, MAINE  
B79 2ND & 3RD FLOOR RENOVATIONS  
- OPTION 2  
GENERAL NOTES

PROJECT NO.: 1618057

NAVFAC DRAWING NO.


1591148

SHEET ## OF ##


G002 FAC-YR-NUM

DRAWFORM REVISION: DECEMBER 2018


FILE NAME: C:\Users\lois.dromaszo\AppData\Local\Temp\AcPublish\_1466A\2019\_1618057\_Bldg 79 Repair Roof and Reprint Brick Wall Over 1st Floor - Mod 2.dwg LAYOUT NAME: G002 PLOTTED: Thursday, September 28, 2023 - 12:47pm USER: lois.dromaszo

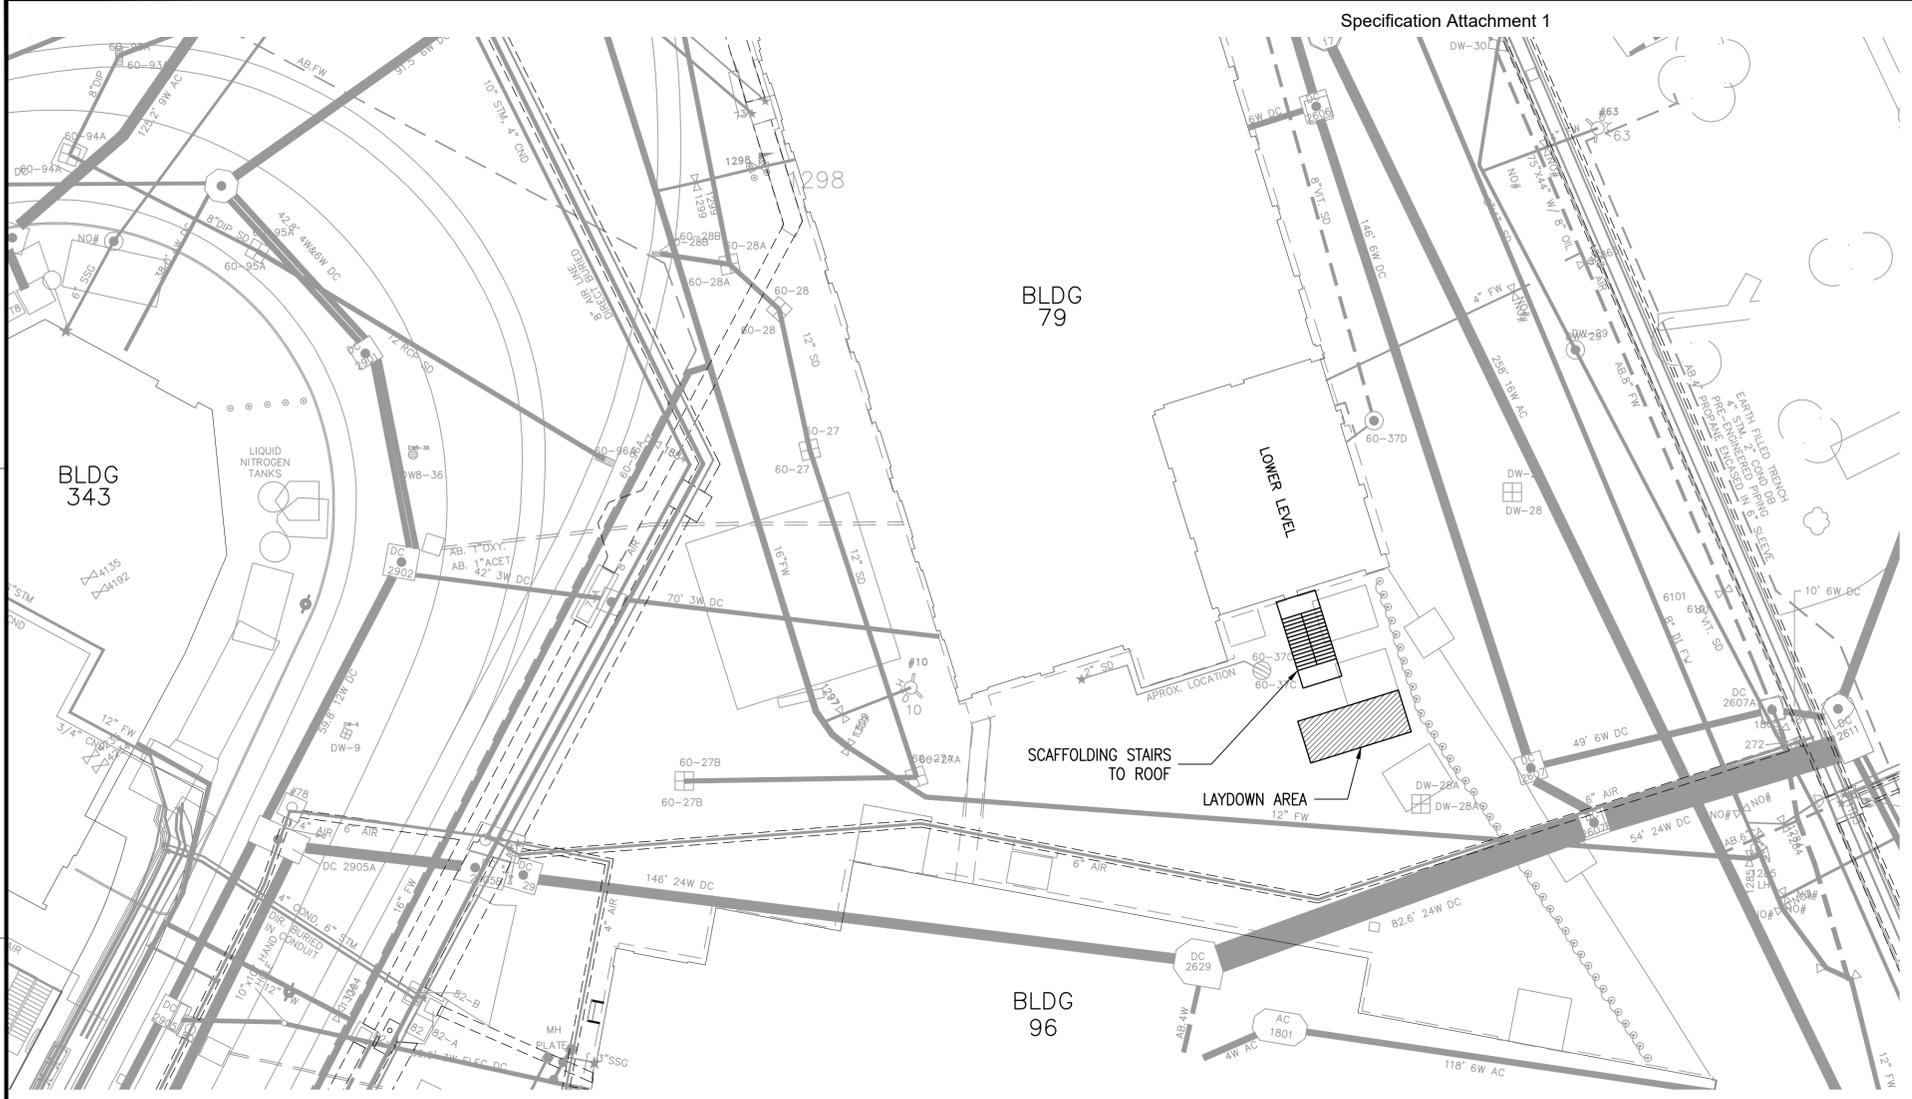

LAYDOWN PLAN  
SCALE: 1:20

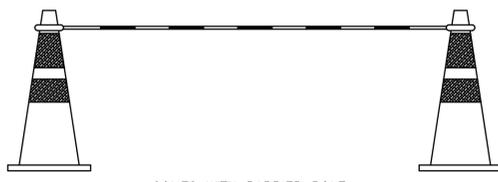


CONES WITH BARRIER POLE

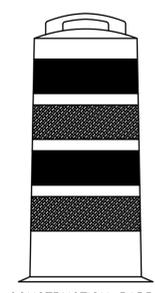

CONSTRUCTION BARREL

**TYPE 1 CONSTRUCTION BARRIER**

1.

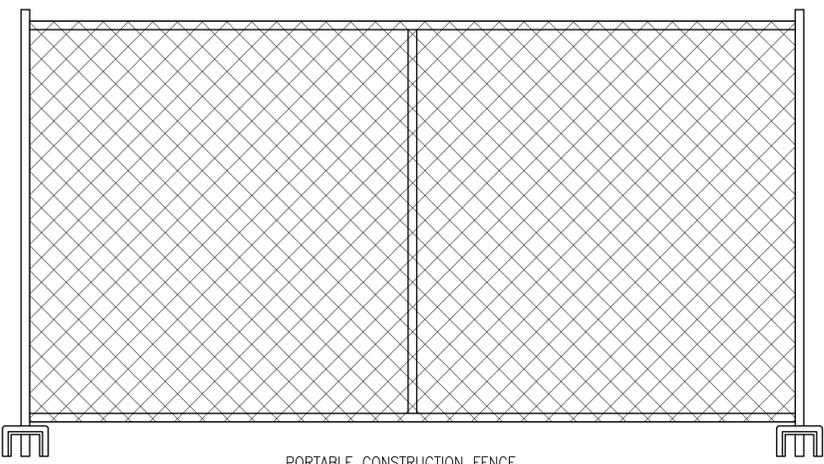

PORTABLE CONSTRUCTION FENCE



**CONSTRUCTION AREA  
AUTHORIZED PERSONNEL  
ONLY**

CONTRACTOR NAME 

CONSTRUCTION BARRIER SIGN

GENERAL CONSTRUCTION NOTES

1. ALL BARRIERS AND SIGNAGE SHALL MEET THE REQUIREMENTS OF EM-385-1-1
2. PROVIDE MINIMUM TYPE 1 CONSTRUCTION BARRIER AROUND PERIMETER OF CONSTRUCTION AREA.
3. CONSTRUCTION BARRIER SIGNS SHALL BE POSTED MINIMUM 150 FEET AROUND PERIMETER OF CONSTRUCTION AREA.
4. CONTRACTOR SHALL COORDINATE LAYOUT AND OPENING IN FIELD WITH CM/ET.
5. BARRIER LAYOUT SHALL NOT BE CHANGED WITHOUT PRIOR APPROVAL OF CM/ET.
6. IF AT ANYTIME IT IS DETERMINED THAT THE RISK TO THE PUBLIC CHANGES BASED ON THE CONTRACTORS WORK, THE CONTRACTOR SHALL TAKE IMMEDIATE ACTION TO ADDRESS ANY RISK TO THE PUBLIC.

**GRAPHIC SCALE**

1" = 20'



CHECK GRAPHIC SCALE BEFORE USING

REV	DATE	DESCRIPTION
1	09/27/2022	DD
0	MM/DD/YYYY	DM
		APPR





PWD-MAINE  
IN HOUSE DESIGN

DESIGNER	DON DRIVER
DRAWN BY	DAVID HICKMAN
CHECKED BY	DAVID HOPPER
DESIGN MANAGER	DON DRIVER
PROJECT MANAGER	DAVID HOPPER
TEAM/PLANE	JEFF HOYT
FIRE PROTECTION	XXX

DEPARTMENT OF THE NAVY  
 NAVAL FACILITIES ENGINEERING COMMAND - MID-ATLANTIC  
 PUBLIC WORKS DEPARTMENT - MAINE  
 PORTSMOUTH NAVAL SHIPYARD  
 KITTERY, MAINE  
**B79 2ND & 3RD FLOOR RENOVATIONS - OPTION 2**  
 LAYDOWN PLAN

PROJECT NO.:	1618057
NAVFAC DRAWING NO.:	1591149
SHEET ## OF ##	G1101 FAC-YR-NUM

FILE NAME: C:\Users\kous.dromas\AppData\Local\Temp\AcPublish\_1466A\2019\_1618057\_Bldg 79 Repair Roof and Reprint Brick Wall Over 1st Floor - Mod 2.dwg LAYOUT NAME: C1101 - PLOTTED: Thursday, September 29, 2022 - 12:47pm USER: kous.dromas

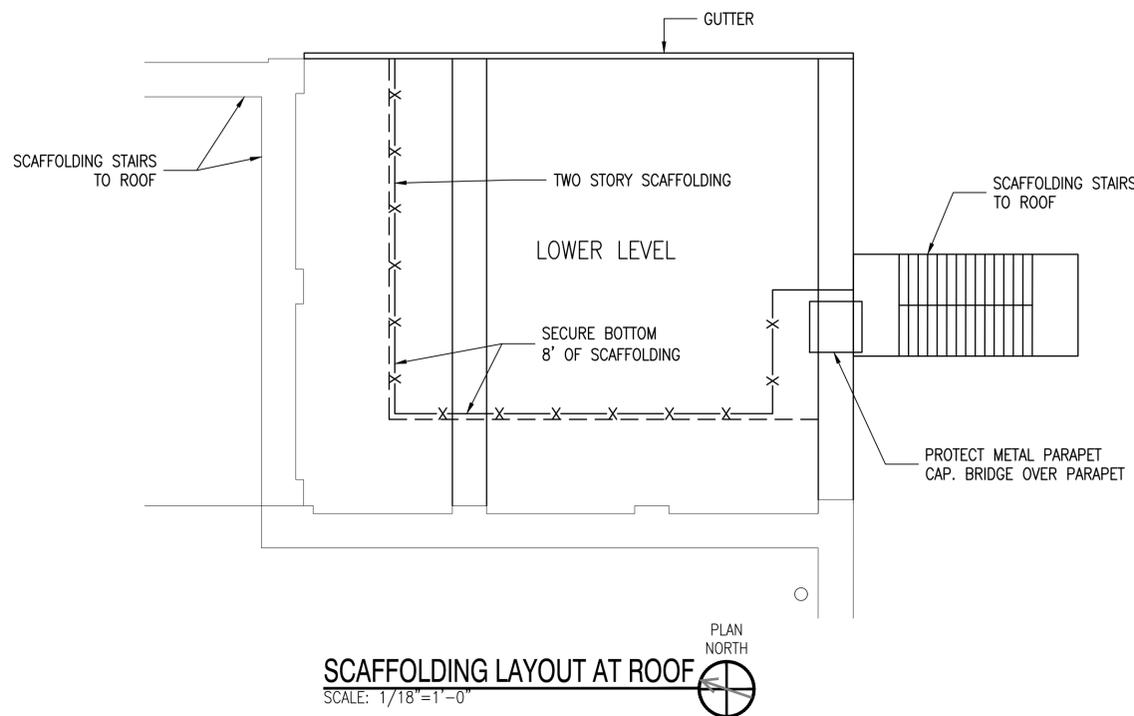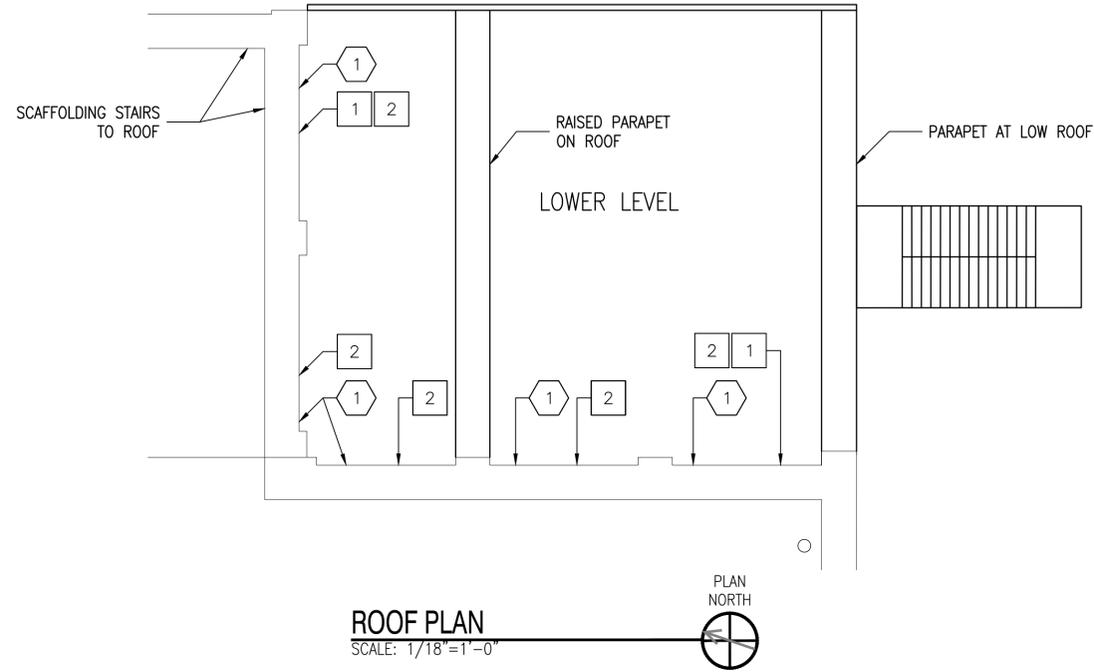

GENERAL SHEET NOTES

1. CONTRACTOR SHALL MAINTAIN SECURITY AT SECOND FLOOR WINDOWS AND SCAFFOLDING.
2. SCAFFOLDING MUST BE SECURED AT GROUND LEVEL AT END OF EACH WORK DAY.

NO	DESCRIPTION	DATE	DM	APPR
1	OPTION 2	09/27/2022	DD	
0	ISSUED FOR BID	MM/DD/YYYY	DM	



DEMOLITION KEYNOTES


1. REMOVE EXISTING SECURITY AT SECOND FLOOR WINDOWS. (5 TOTAL)



KEYNOTES

1. REPOINT EXISTING MASONRY WALL AND PILASTERS ON BOTH WALLS.
2. REINSTALL EXISTING SECURITY SCREENS AFTER MASONRY REPOINTING AND REPAIRS.

APPROVED	
FOR COMMANDER NAFAC	
ACTIVITY	
SATISFACTORY TO	DATE
DESIGNER	DON DRIVER
DRAWN BY	DAVID HICKMAN
CHECKED BY	DAVID HOPPER
DESIGN MANAGER	DON DRIVER
PROJECT MANAGER	DAVID HOPPER
HEAD/PM/LE	JEFF HOYT
FIRE PROTECTION	XXX

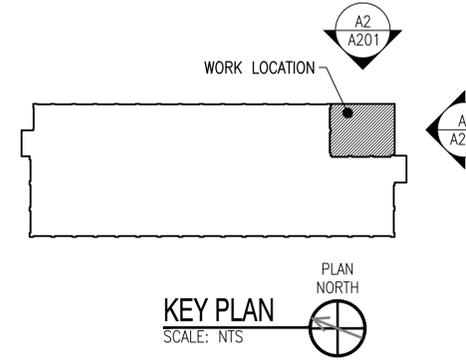

GRAPHIC SCALE





CHECK GRAPHIC SCALE BEFORE USING

DEPARTMENT OF THE NAVY  
 NAVAL FACILITIES ENGINEERING COMMAND  
 NAVAL FACILITIES ENGINEERING COMMAND - MID-ATLANTIC  
 PUBLIC WORKS DEPARTMENT - MAINE  
 PORTSMOUTH NAVAL SHIPYARD  
 NAVAL SHIPYARD - PORTSMOUTH, MAINE  
 KITTERY, MAINE  
 B79 2ND & 3RD FLOOR RENOVATIONS  
 - OPTION 2  
 ROOF PLANS

PROJECT NO.:	1618057
NAFAC DRAWING NO.:	1591150
SHEET ## OF ##	A101 FAC-YR-NUM

FILE NAME: C:\Users\lois.dromas\AppData\Local\Temp\AcPublish\_1466A\2019\_1618057\_Bldg 79 Repair Roof and Reprint Brick Wall Over 1st Floor - Mod 2.dwg LAYOUT NAME: A101 PLOTTED: Thursday, September 29, 2022 - 12:47pm USER: lois.dromas

FILE NAME: C:\Users\lois.dromas\AppData\Local\Temp\AcPublish\_1466A\2019\_1618057\_Bldg 79 Repair Roof and Repaint Brick Wall Over 1st Floor - Mod 2.dwg LAYOUT NAME: A201 PLOTTED: Thursday, September 29, 2022 - 12:47pm USER: lois.dromas

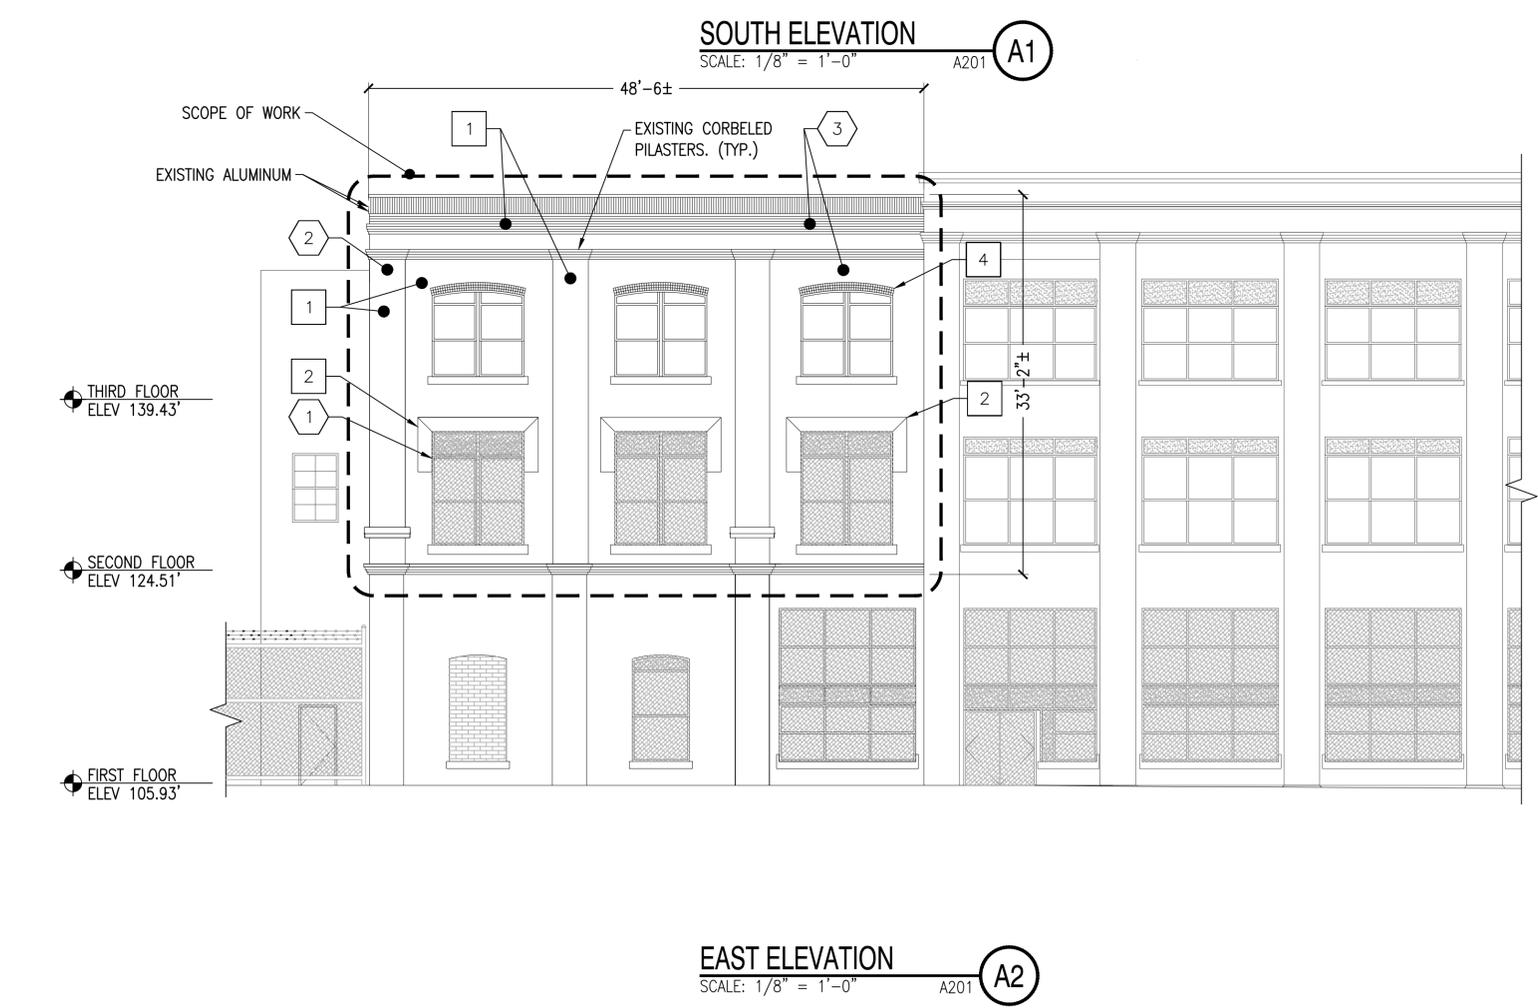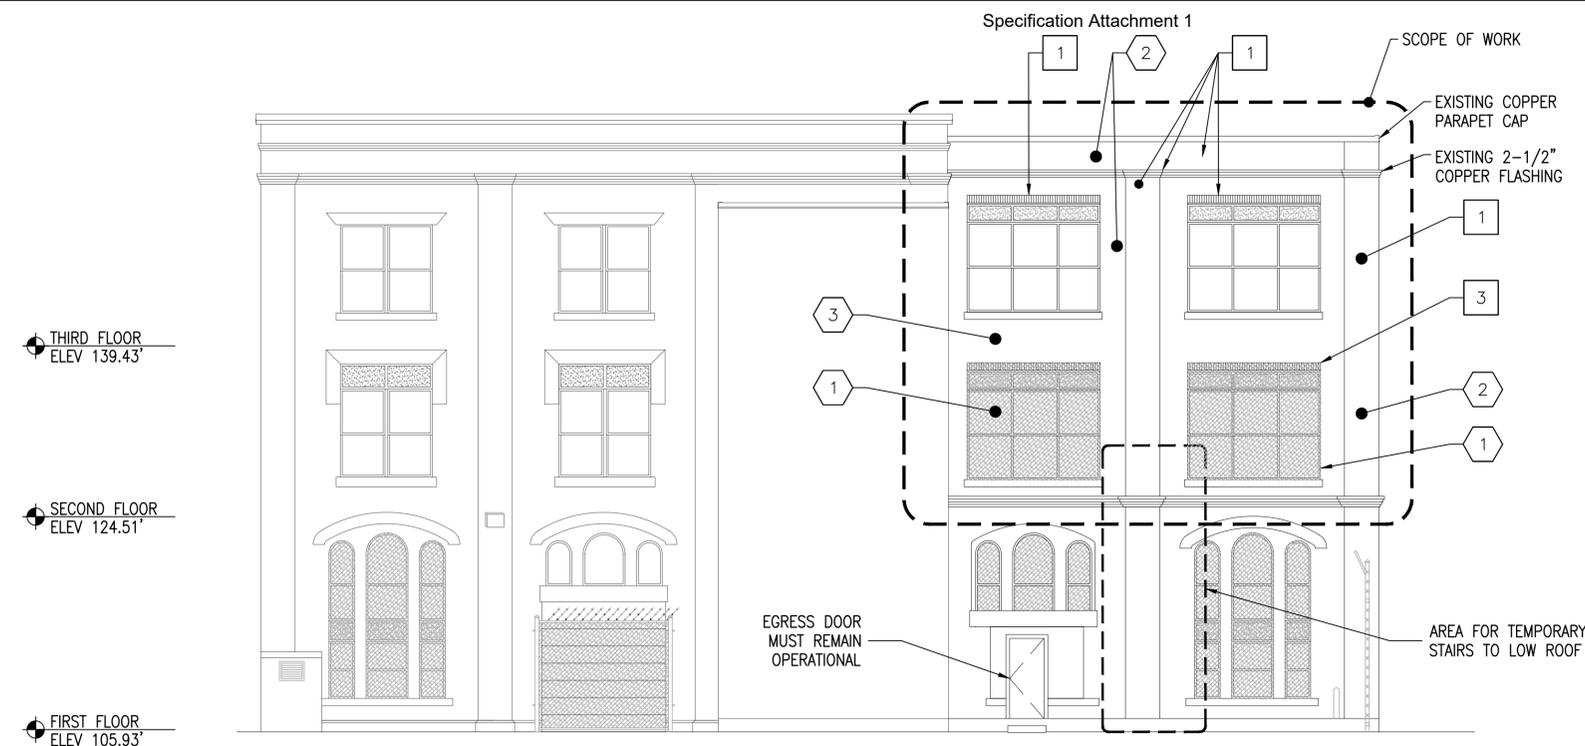

### GENERAL SHEET NOTES


1. CONTRACTOR TO REPOINT 100% OF ALL MASONRY AT BOTH ELEVATIONS.
2. EXISTING ALUMINUM WINDOWS TO REMAIN IN PLACE.
3. REPLACEMENT BRICKS FOR REMOVED BRICKS SHALL MATCH EXISTING.

### DEMOLITION KEYNOTES

1. REMOVE SECURITY SCREENS FROM SECOND FLOOR WINDOWS. (TYP. OF 5). STORE FOR REUSE.
2. REMOVE ALL ABANDONED METAL ANCHORS (TYP.)
3. REMOVE ALL DETERIORATED BRICK MASONRY.

### KEYNOTES

1. REPOINT BRICK MASONRY INCLUDING WALLS, PILASTERS, AND CORBELS.
2. REPOINT JOINTS OF BRICK AND STONE MASONRY.
3. REPOINT BRICK SOLDIERS AT WINDOW HEADS.
4. REPOINT ARCHED BRICK ROWLOCKS AT WINDOW HEADS.

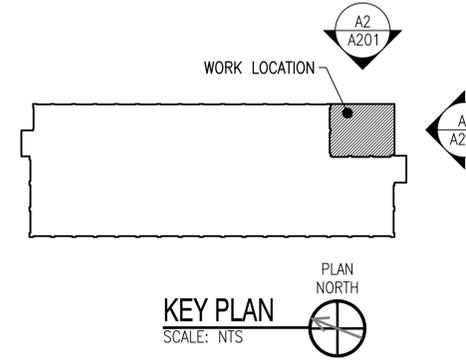

### GRAPHIC SCALE





NO.	DESCRIPTION	DATE	BY	APPR.
1	OPTION 2	09/27/2022	DD	
0	ISSUED FOR BID	MM/DD/YYYY	DM	



DESIGNER	DON DRIVER
DRAWN BY	DAVID HICKMAN
CHECKED BY	DAVID HOPPER
DESIGN MANAGER	DON DRIVER
PROJECT MANAGER	DAVID HOPPER
TEAM/PM	JEFF HOYT
FIRE PROTECTION	XXX




DEPARTMENT OF THE NAVY  
 NAVAL FACILITIES ENGINEERING COMMAND  
 NAVAL FACILITIES ENGINEERING COMMAND - MID-ATLANTIC  
 PUBLIC WORKS DEPARTMENT - MAINE  
 PORTSMOUTH NAVAL SHIPYARD  
 KITTERY, MAINE  
**B79 2ND & 3RD FLOOR RENOVATIONS - OPTION 2**  
 EXTERIOR ELEVATIONS

PROJECT NO.:	1618057
NAVFAC DRAWING NO.:	1591151
SHEET ## OF ##	A201 FAC-YR-NUM

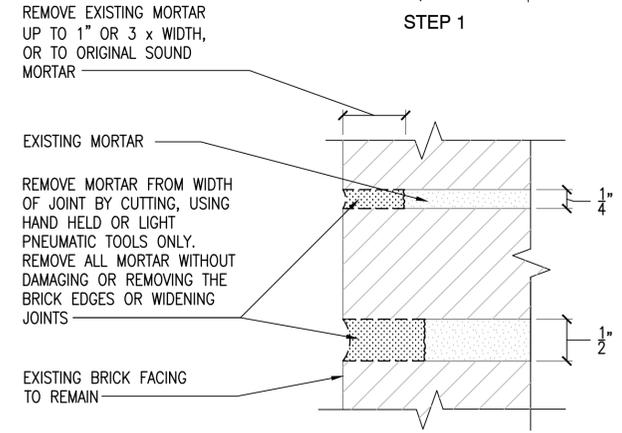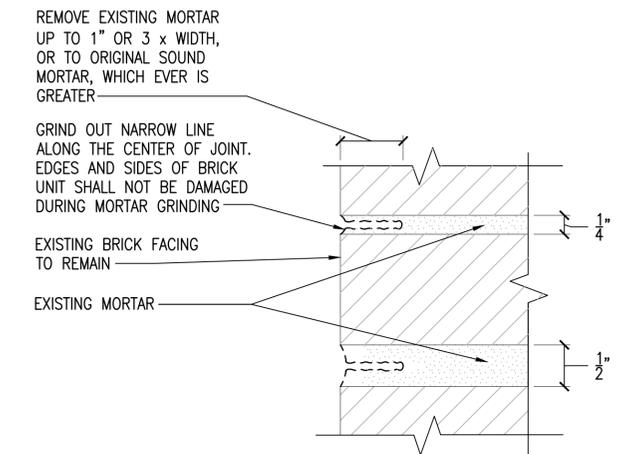

NOTE: MORTAR REPOINTING METHODS WILL BE COORDINATED AND APPROVED BY PWD-ME CULTURAL RESOURCES.

**DETERIORATED MORTAR REMOVAL PROCEDURES**  
SCALE: NTS 1

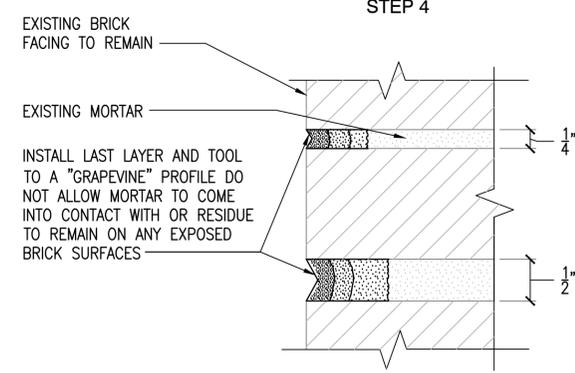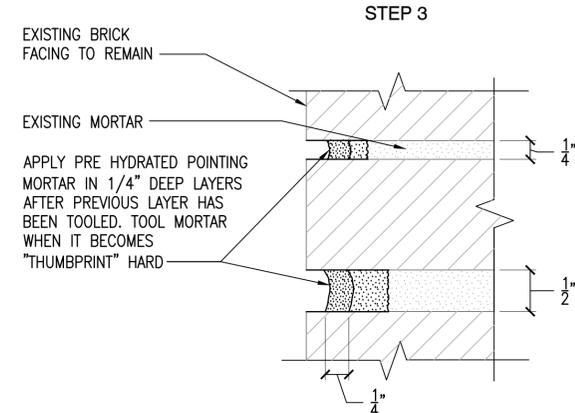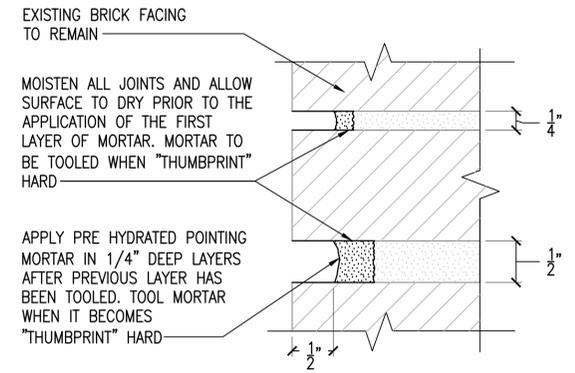

NOTE: REFER TO STEP 1 AND STEP 2, ON SHEET AD501 FOR MORTAR REMOVAL PROCEDURES. MORTAR REPOINTING METHODS WILL BE COORDINATED AND APPROVED BY PWD-ME CULTURAL RESOURCES.

**TYPICAL REPOINTING PROCEDURES**  
SCALE: NTS 2

FILE NAME: C:\Users\lois.dromaszo\AppData\Local\Temp\AcPublish\_1466A\2019\_1618057\_Bldg 79 Repair Roof and Repaint Brick Wall Over 1st Floor - Mod 2.dwg LAYOUT NAME: A501 PLOTTED: Thursday, September 29, 2022 - 12:47pm USER: lois.dromaszo

NO.	DESCRIPTION	DATE	APPR.
1	OPTION 2	09/27/2022	DD
0	ISSUED FOR BID	MM/DD/YYYY	DM
	SM		APPR



APPROVED
FOR COMMANDER NAVFAC
ACTIVITY
SATISFACTORY TO DATE
DESIGNER DON DRIVER
DRAWN BY DAVID HICKMAN
CHECKED BY DAVID HOPPER
DESIGN MANAGER DON DRIVER
PROJECT MANAGER DAVID HOPPER
LEAD/PM/ME JEFF HOYT
FIRE PROTECTION XXX

DEPARTMENT OF THE NAVY  
NAVAL FACILITIES ENGINEERING COMMAND  
NAVAL FACILITIES ENGINEERING COMMAND - MID-ATLANTIC  
PUBLIC WORKS DEPARTMENT - MAINE  
PORTSMOUTH NAVAL SHIPYARD  
PORTSMOUTH NAVAL SHIPYARD - KITTERY, MAINE  
B79 2ND & 3RD FLOOR RENOVATIONS  
- OPTION 2  
DETAILS

PROJECT NO.: 1618057
NAVFAC DRAWING NO. 1591152
SHEET ## OF ##
A501 FAC-YR-NUM