

[illegible]

FILE NAME: \\ghdnet\gnd\US\Charlottesville\Projects\565\11203457\Digital_Design\1 - CAD\3.1.2 - Sheet\05b - Architecture\2022_11_18_Frm\1372148-A-002.dwg LAYOUT NAME: A-002 PLOTTED: Monday, December 05, 2022 - 1:39pm USER: rsoath


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FILE NAME: \\gfhed\gfhed\US\Charity\Projects\565\11203457\Digital_Design\1 - CAD\3.1.2 - Sheet\05b - Architecture\2022\11-18-Final\1372148-A-003.dwg LAYOUT NAME: A-003 PLOTTED: Monday, December 05, 2022 - 1:39pm USER: roath


TOILET ACCESSORY SCHEDULE AND MOUNTING DIAGRAM

ACCESSORY#	TA-1	TA-2	TA-3	TA-4	TA-5	TA-6	TA-7	TA-8	TA-9	TA-10	TA-11	TA-12
ILLUSTRATION:												
ACCESSORY ITEM:	GRAB BAR - 18"	GRAB BAR - 42"	GRAB BAR - 36"	SEAT COVER DISPENSER	WALL MOUNTED SOAP DISPENSER	TOILET TISSUE DISPENSER (TWIN JUMBO ROLL)	MIRROR	PAPER TOWEL DISPENSER	SANITARY NAPKIN DISPOSAL UNIT	HOOK	SHOWER CURTAIN ROD	SHOWER CURTAIN
RESPONSIBILITY:	CFCI	CFCI	CFCI	CFCI	CFCI	CFCI	CFCI	CFCI	CFCI	CFCI	CFCI	CFCI
BLOCKING TYPE:	A1 (OR PARTITION MOUNTED)	A1 (OR PARTITION MOUNTED)	A1 (OR PARTITION MOUNTED)	A1	A1	C1 (OR PARTITION MOUNTED)	C1	A2	A1 (OR PARTITION MOUNTED)	C1 (OR DOOR MOUNTED)	--	--
MANUFACTURER:	--	--	--	--	KUTOL	TORK	--	TORK	--	--	--	--
MODEL NUMBER:	--	--	--	--	SS001BK31	56TR	--	772828	--	--	--	--
NOTES:	1. REFER TO ENLARGED TOILET PLANS, INTERIOR ELEVATIONS, ETC. FOR LOCATION AND QUANTITIES OF ITEMS. 2. MOUNTING HEIGHTS ARE SET FROM FINISH FLOOR TO THE TOP OF THE UNIT, UNLESS OTHERWISE NOTED. GRAB BAR HEIGHTS ARE FROM FINISH FLOOR TO CENTERLINE OF BAR. 3. PROVIDE BLOCKING, HANGERS AND SIMILAR REINFORCEMENTS & PREPARATIONS AS NECESSARY IN CONCEALED SPACES FOR ATTACHMENT OF ITEMS. COORDINATE SIZE, SPACING, ATTACHMENT TEMPLATES & OTHER INSTALLATION REQUIREMENTS. 4. PROVIDE COAT HOOKS IN TOILET STALLS.											


TOILET FIXTURE MOUNTING DIAGRAM

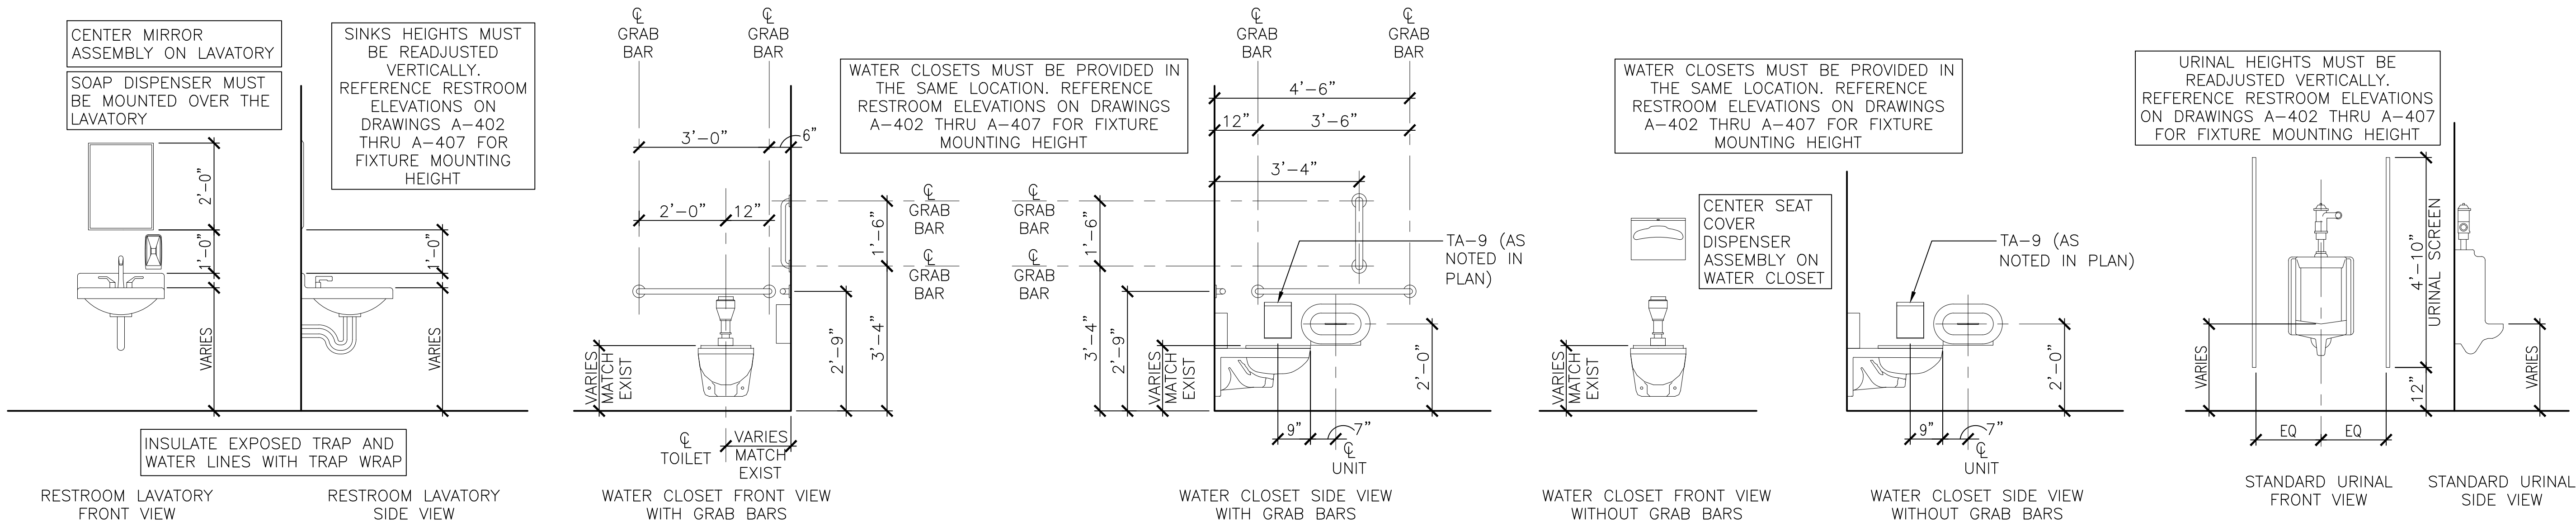

DRYING AREA AND SHOWER LAYOUTS - FIRST AND SECOND FLOOR LOCATIONS

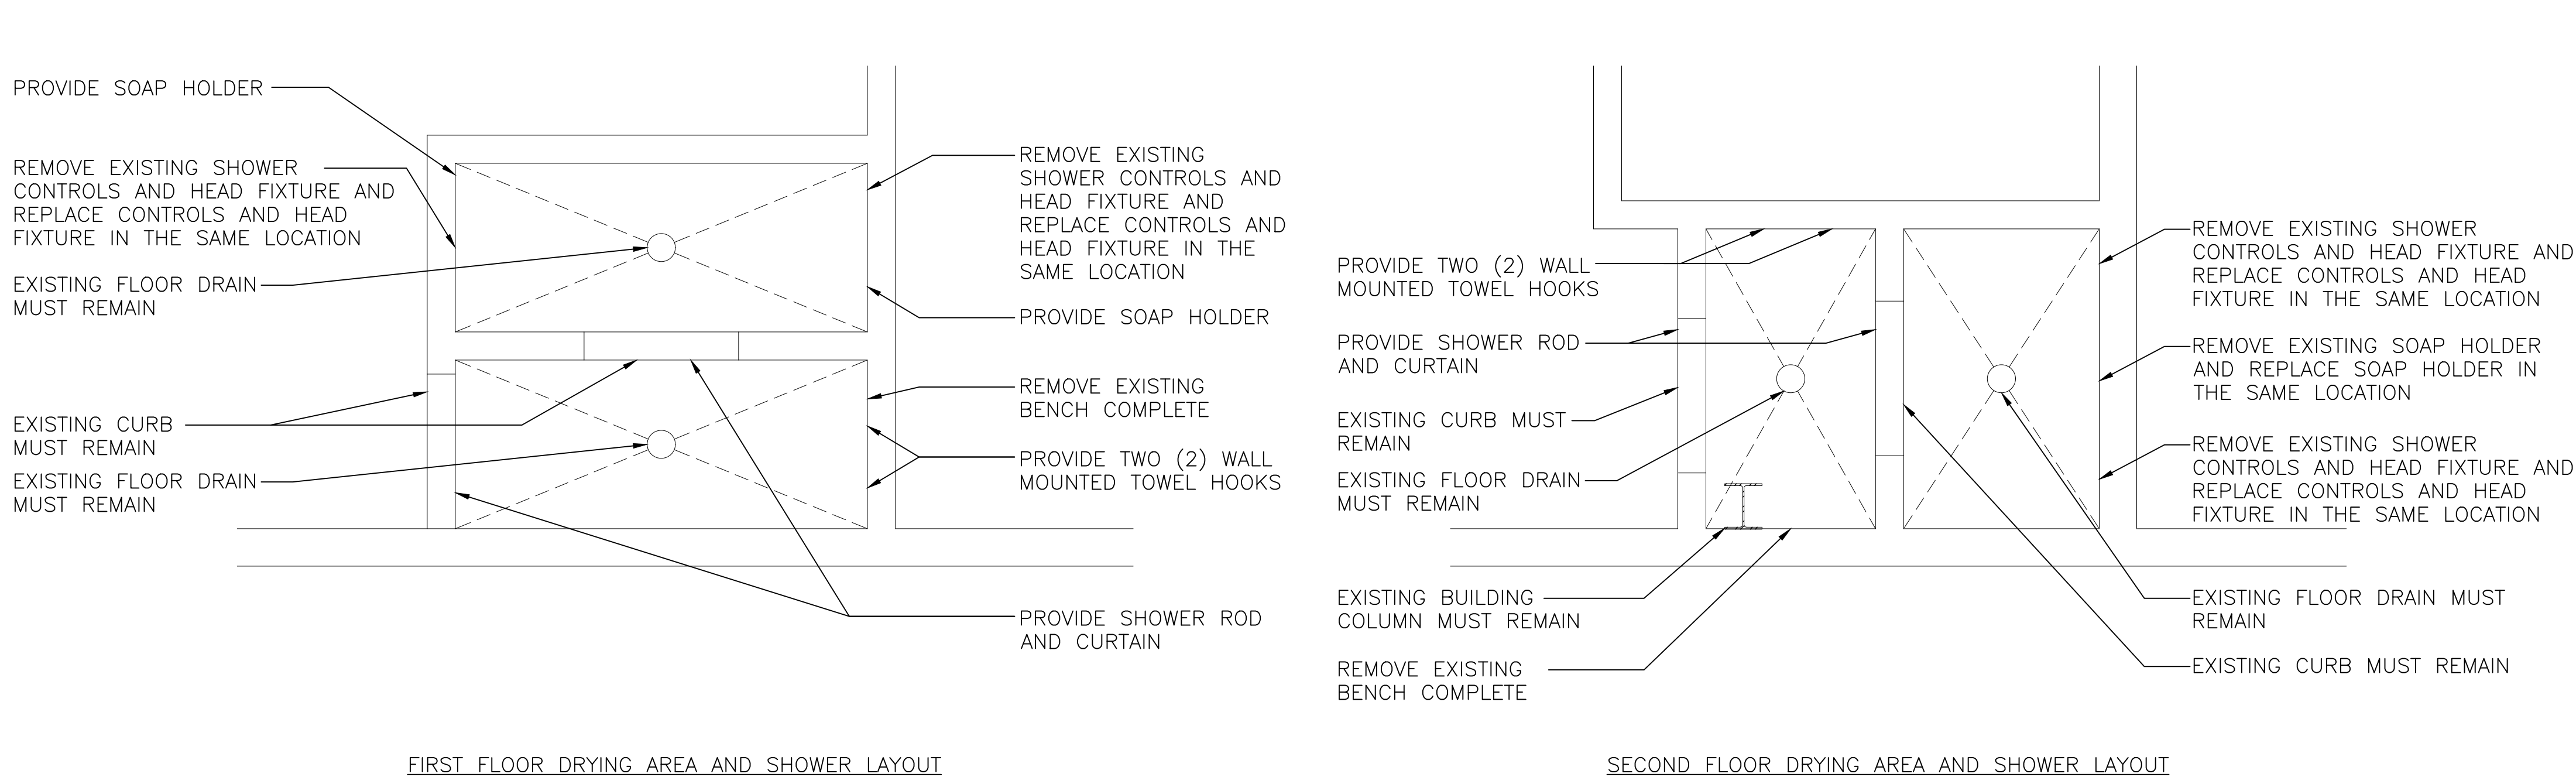

VANITY SECTION

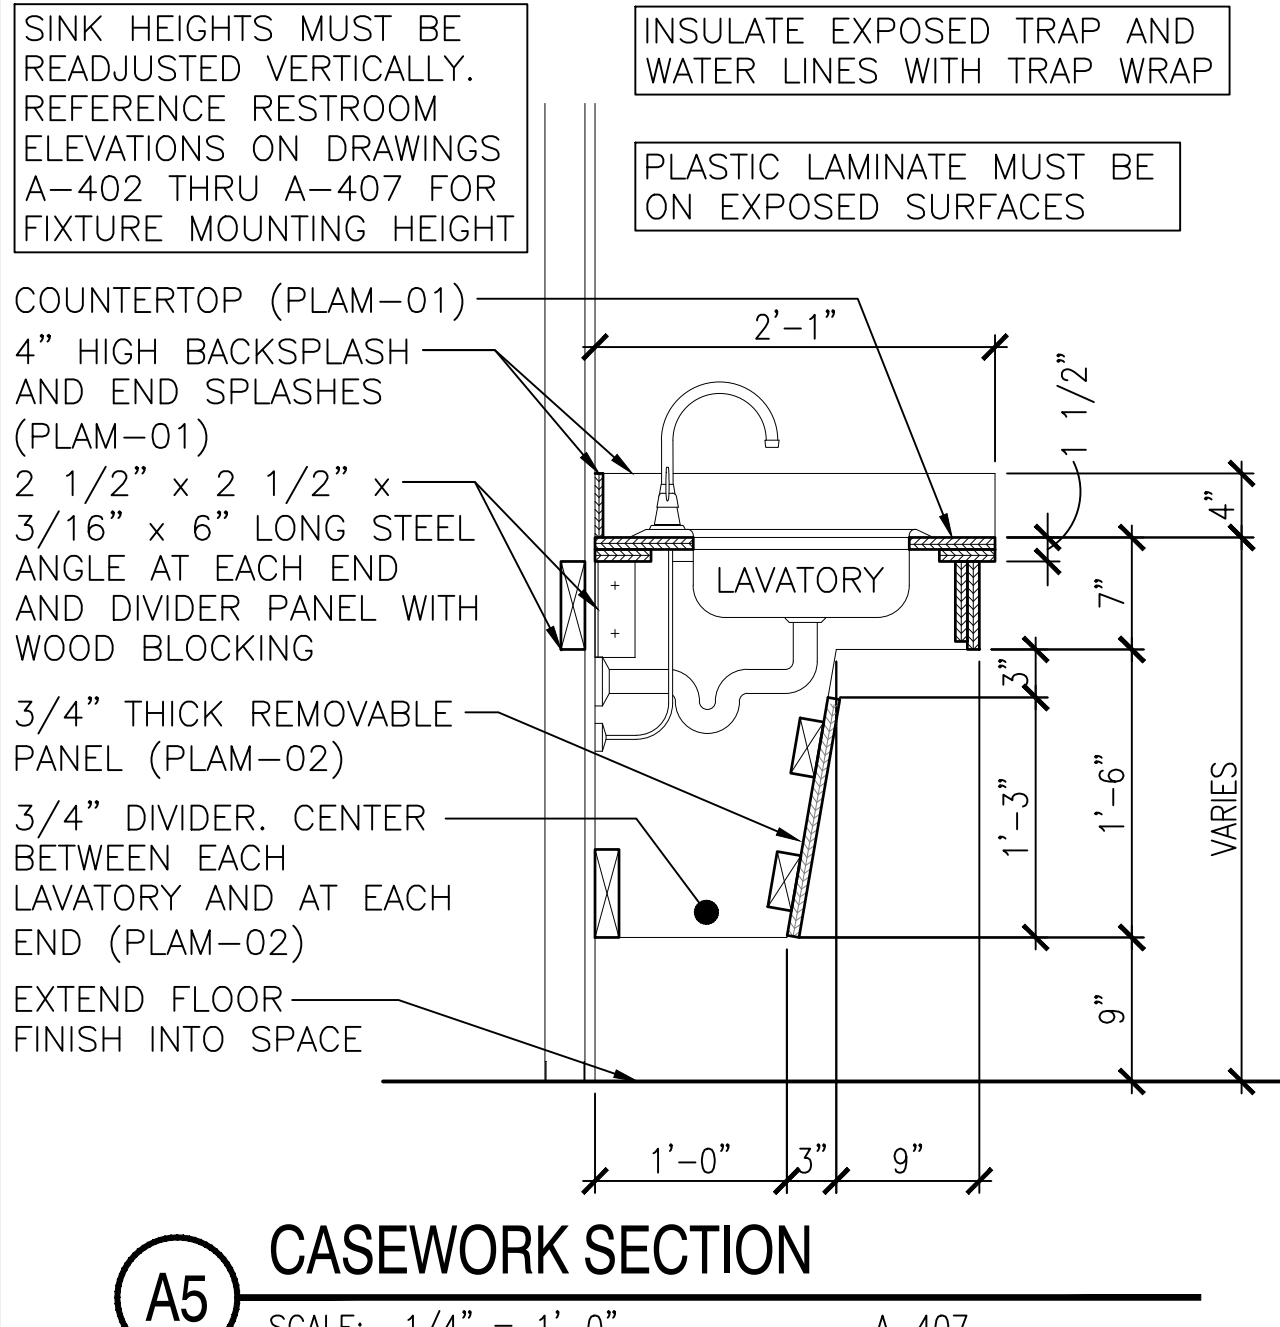

A5 CASEWORK SECTION SCALE: 1/4" = 1'-0" A-407

NAVFAC logo and project information.

GHD logo and project information.

Project information and title block.

FILE NAME: \\ghrd\g\ad\US\Charlity\Projects\565\11203457\Digital_Design\1 - CAD\3.1.2 - Sheet\05b - Architecture\2022 11 18 From\1372148-A-010.dwg LAYOUT NAME: A-010 PLOTTED: Monday, December 05, 2022 - 1:39pm USER: roath

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INTERIOR FINISH SCHEDULE - 1ST FLOOR (01) - REFERENCE FINISH FLOOR BID OPTIONS AND FINISH FLOOR PLANS

	ROOM		FLOOR	BASE	WALL MATERIAL	WALL FINISH					CEILING		REMARKS
	NO	NAME				--	N	E	S	W	MAT'L	HT	
MODULE 3	301	P.R. SHOP	EXISTING	EXISTING	MASONRY	PNT01	--	--	--	--	PNT01	10'-0"	REPLACE CEILING
	302	POWER PLANTS	EXISTING	EXISTING	MASONRY	PNT01	--	--	--	--	ACP01	10'-0"	REPLACE CEILING
	303	HEAD	CT01	CTB01	MASONRY	CT03	--	--	--	--	PNT01	9'-0"	REPLACE CEILING
	304	I.W.T. SHOP	EXISTING	EXISTING	MASONRY	PNT01	--	--	--	--	ACP01	9'-0"	REPLACE CEILING
	305	VAULT	EXISTING	EXISTING	MASONRY	--	--	--	--	--	EXIST	EXIST	--
	306	I.W.T. OFFICE	EXISTING	EXISTING	MASONRY	PNT01	--	--	--	--	ACP01	9'-0"	REPLACE CEILING
	307	LOGS AND RECORDS	EXISTING	EXISTING	MASONRY	PNT01	--	--	--	--	ACP01	9'-0"	REPLACE CEILING
	308	A.M.E. SHOP	EXISTING	EXISTING	MASONRY	PNT01	--	--	--	--	ACP01	9'-0"	REPLACE CEILING
	309	A.M.E. WORKSPACE	EXISTING	EXISTING	MASONRY	PNT01	--	--	--	--	ACP01	9'-0"	REPLACE CEILING
	310	AIRFRAMES	EXISTING	EXISTING	MASONRY	PNT01	--	--	--	--	PNT01	15'-0"	EXPOSED CEILING
	311	CORROSION CONTROL	EXISTING	EXISTING	MASONRY	PNT01	--	--	--	--	PNT01	15'-0"	EXPOSED CEILING
	312	MECHANICAL ROOM	EXISTING	EXISTING	MASONRY	PNT01	--	--	--	--	PNT01	15'-0"	EXPOSED CEILING
	313	LOUNGE	EXISTING	EXISTING	MASONRY	PNT01	--	--	--	--	ACP01	9'-0"	REPLACE CEILING
	314	STORAGE	EXISTING	EXISTING	MASONRY	PNT01	--	--	--	--	PNT01	9'-0"	REPLACE CEILING
	315	LOCKER ROOM	EXISTING	EXISTING	MASONRY	PNT01	--	--	--	--	ACP01	9'-0"	REPLACE CEILING
	316	AV/ARM DIV. OFFICE	EXISTING	EXISTING	MASONRY	PNT01	--	--	--	--	ACP01	9'-0"	SEE NOTES A-011
	317	FEMALE HEAD	CT01	CTB01	MASONRY	CT03	--	--	--	--	PNT01	9'-0"	REPLACE CEILING
	318	WOMEN'S LOCKER ROOM	CT01	CTB01	MASONRY	CT03	--	--	--	--	PNT01	9'-0"	REPLACE CEILING
	318A	MEN'S LOCKER ROOM	EXISTING	EXISTING	MASONRY	PNT01	--	--	--	--	PNT01	9'-0"	REPLACE CEILING
	319	DRYING AREA	CT02	CTB01	MASONRY	CT03	--	--	--	--	PNT01	8'-0"	REPLACE CEILING
	320	SHOWER	CT02	CTB01	MASONRY	CT03	--	--	--	--	PNT01	8'-0"	REPLACE CEILING
	321	COFFEE MESS	EXISTING	EXISTING	MASONRY	PNT01	--	--	--	--	ACP01	9'-0"	REPLACE CEILING
	322	STORAGE	EXISTING	EXISTING	MASONRY	PNT01	--	--	--	--	ACP01	9'-0"	SEE NOTES A-011
	323	JANITOR'S CLOSET	EXISTING	EXISTING	MASONRY	PNT01	--	--	--	--	PNT01	9'-0"	REPLACE CEILING
	324	CAREER INFO	EXISTING	EXISTING	MASONRY	PNT01	--	--	--	--	ACP01	10'-0"	REPLACE CEILING
	53A	STAIR	EXISTING	EXISTING	MASONRY	PNT01	--	--	--	--	PNT01	VARIES	REPLACE CEILING
	53B	STAIR	EXISTING	EXISTING	MASONRY	PNT01	--	--	--	--	PNT01	VARIES	REPLACE CEILING
	C30	CORRIDOR	EXISTING	EXISTING	MASONRY	PNT01	--	--	--	--	ACP01	8'-0"	REPLACE CEILING
	C31	CORRIDOR	EXISTING	EXISTING	MASONRY	PNT01	--	--	--	--	ACP01	8'-0"	REPLACE CEILING
	C32	CORRIDOR	EXISTING	EXISTING	MASONRY	PNT01	--	--	--	--	ACP01	8'-0"	REPLACE CEILING

FINISH LEGEND

FINISH NO	MATERIAL	MANUFACTURER	STYLE NAME / NO	COLOR	SIZE	DESCRIPTION / REMARKS
ACP01	ACOUSTIC CEILING PANEL	--	--	WHITE	SEE SPECIFICATION	BLACK IN 132 AND 342
CT01	PORCELAIN FLOOR TILE	--	--	BEIGE	2" X 2"	FIELD FLOOR TILE
CT02	PORCELAIN FLOOR TILE	--	--	BEIGE	1" X 1"	SHOWER FLOOR TILE
CT03	PORCELAIN WALL TILE	--	--	BEIGE	6" X 6"	FIELD WALL TILE
CTB01	PORCELAIN WALL BASE	--	--	BEIGE	6" X 6"	--
CONC01	CONCRETE SEALER	--	--	CLEAR	--	--
EPOXY01	RESINOUS FLOOR	--	--	GRAY	--	3-COAT SYSTEM
EPOXY03	RESINOUS FLOOR	--	--	GRAY	--	BID OPTION
GR01	GROUT	--	--	IVORY	--	USE FOR CT
PLAM01	PLASTIC LAMINATE	--	--	BLUE	--	COUNTERTOP
PLAM02	PLASTIC LAMINATE	--	--	BEIGE	--	VANITY PANELS
PNT01	PAINT	--	--	27780 (WHITE)	--	FEDERAL STANDARD
PNT02	PAINT	--	--	25048 (BLUE)	--	FEDERAL STANDARD
T1	TRANSITION STRIP	--	--	--	--	DOOR THRESHOLD
T2	TRANSITION STRIP	--	--	--	--	EXISTING/PORCELAIN TILE
TP01	TOILET PARTITION	--	--	BLUE	--	--
RB02	RUBBER WALL BASE	--	--	GRAY	--	BID OPTION
VCT01	VINYL COMPOSITION TILE	--	--	GRAY	12" X 12"	BID OPTION

FINISH SCHEDULE

FINISH NO	MATERIAL	MANUFACTURER	STYLE NAME / NO	COLOR	SIZE	DESCRIPTION / REMARKS
CMU-1	EXTERIOR MASONRY WALL UP TO 7'-4" AFF	SEE SPECIFICATION	ACCENT	FEDERAL STANDARD 25048 (BLUE)	--	NAVAL AIR STATION OCEANA INSTALLATION APPEARANCE PLAN
CMU-2	EXTERIOR MASONRY WALL ABOVE 7'-4" ELEVATION	SEE SPECIFICATION	BODY 1	FEDERAL STANDARD 27780 (WHITE)	--	NAVAL AIR STATION OCEANA INSTALLATION APPEARANCE PLAN
CMU-3	INTERIOR MASONRY WALLS	SEE SPECIFICATION	BODY 1	FEDERAL STANDARD 27780 (WHITE)	--	NAVAL AIR STATION OCEANA INSTALLATION APPEARANCE PLAN
DOOR-1	EXTERIOR DOORS AND FRAMES	SEE SPECIFICATION	ACCENT	FEDERAL STANDARD 25048 (BLUE)	--	NAVAL AIR STATION OCEANA INSTALLATION APPEARANCE PLAN
DOOR-2	INTERIOR DOORS AND FRAMES	SEE SPECIFICATION	BODY 1	FEDERAL STANDARD 27780 (WHITE)	--	NAVAL AIR STATION OCEANA INSTALLATION APPEARANCE PLAN
STEEL-1	EXTERIOR STRUCTURAL STEEL	SEE SPECIFICATION	BODY 1	FEDERAL STANDARD 27780 (WHITE)	--	NAVAL AIR STATION OCEANA INSTALLATION APPEARANCE PLAN
STEEL-2	INTERIOR STRUCTURAL STEEL	SEE SPECIFICATION	BODY 1	FEDERAL STANDARD 27780 (WHITE)	--	NAVAL AIR STATION OCEANA INSTALLATION APPEARANCE PLAN
TRIM-1	GUTTERS, TRIM AND FLASHING	SEE SPECIFICATION	ACCENT	FEDERAL STANDARD 25048 (BLUE)	--	NAVAL AIR STATION OCEANA INSTALLATION APPEARANCE PLAN
TRIM-2	DOWNSPOUTS	SEE SPECIFICATION	BODY 1	FEDERAL STANDARD 27780 (WHITE)	--	NAVAL AIR STATION OCEANA INSTALLATION APPEARANCE PLAN

INTERIOR FINISH SCHEDULE - 1ST FLOOR (01) - REFERENCE FINISH FLOOR BID OPTIONS AND FINISH FLOOR PLANS

	ROOM		FLOOR	BASE	WALL MATERIAL	WALL FINISH					CEILING		REMARKS
	NO	NAME				---	N	E	S	W	MAT'L	HT	
MODULE 1	100	HANGAR	CONC01/ EPOXY01	--	VARIES	--	PNT01	PNT01	VARIES	PNT01	PNT01	VARIES	SEE FINISH PLAN
	101	IWSR	EXISTING	EXISTING	MASONRY	PNT01	--	--	--	--	ACP01	10'-0"	REPLACE CEILING
	102	SHOP	EXISTING	EXISTING	MASONRY	PNT01	--	--	--	--	ACP01	10'-0"	REPLACE CEILING
	103	FEMALE HEAD	CT01	CTB01	MASONRY	CT03	--	--	--	--	PNT01	9'-0"	REPLACE CEILING
	104	SHOP	EXISTING	EXISTING	MASONRY	PNT01	--	--	--	--	ACP01	9'-0"	REPLACE CEILING
	105	VAULT	EXISTING	EXISTING	MASONRY	--	--	--	--	--	EXIST	EXIST	--
	106	SHOP	EXISTING	EXISTING	MASONRY	PNT01	--	--	--	--	ACP01	9'-0"	REPLACE CEILING
	107	MAINTENANCE	EXISTING	EXISTING	MASONRY	PNT01	--	--	--	--	ACP01	9'-0"	REPLACE CEILING
	108	DIV CHIEF AND OFFICERS	EXISTING	EXISTING	MASONRY	PNT01	--	--	--	--	ACP01	9'-0"	REPLACE CEILING
	109	CPO MESS	EXISTING	EXISTING	MASONRY	PNT01	--	--	--	--	ACP01	9'-0"	REPLACE CEILING
	110	SHOP	EXISTING	EXISTING	MASONRY	PNT01	--	--	--	--	PNT01	15'-0"	EXPOSED CEILING
	111	SHOP	EXISTING	EXISTING	MASONRY	PNT01	--	--	--	--	PNT01	15'-0"	EXPOSED CEILING
	112	MECHANICAL EQUIPMENT	EXISTING	EXISTING	MASONRY	PNT01	--	--	--	--	PNT01	15'-0"	EXPOSED CEILING
	113	LOUNGE	EXISTING	EXISTING	MASONRY	PNT01	--	--	--	--	ACP01	9'-0"	REPLACE CEILING
	114	SHOP	EXISTING	EXISTING	MASONRY	PNT01	--	--	--	--	PNT01	9'-0"	REPLACE CEILING
	115	QA	EXISTING	EXISTING	MASONRY	PNT01	--	--	--	--	ACP01	9'-0"	SEE NOTES A-011
	116	QA	EXISTING	EXISTING	MASONRY	PNT01	--	--	--	--	ACP01	9'-0"	SEE NOTES A-011
	117	MALE HEAD	CT01	CTB01	MASONRY	CT03	--	--	--	--	PNT01	9'-0"	REPLACE CEILING
	118	LOCKER ROOM	CT01	CTB01	MASONRY	CT03	--	--	--	--	PNT01	9'-0"	REPLACE CEILING
	118A	SHOP	EXISTING	EXISTING	MASONRY	PNT01	--	--	--	--	PNT01	9'-0"	REPLACE CEILING
	119	DRYING AREA	CT02	CTB01	MASONRY	CT03	--	--	--	--	PNT01	8'-0"	REPLACE CEILING
	120	SHOWER	CT02	CTB01	MASONRY	CT03	--	--	--	--	PNT01	8'-0"	REPLACE CEILING
	121	SHOP	EXISTING	EXISTING	MASONRY	PNT01	--	--	--	--	ACP01	9'-0"	REPLACE CEILING
	122	STORAGE	EXISTING	EXISTING	MASONRY	PNT01	--	--	--	--	ACP01	9'-0"	REPLACE CEILING
	123	JANITOR'S CLOSET	EXISTING	EXISTING	MASONRY	PNT01	--	--	--	--	PNT01	9'-0"	REPLACE CEILING
	124	IWSR CLASSROOM	EXISTING	EXISTING	MASONRY	PNT01	--	--	--	--	ACP01	10'-0"	SEE NOTES A-011
	51A	STAIR	EXISTING	EXISTING	MASONRY	PNT01	--	--	--	--	PNT01	VARIES	REPLACE CEILING
	51B	STAIR	EXISTING	EXISTING	MASONRY	PNT01	--	--	--	--	PNT01	VARIES	REPLACE CEILING
	C10	CORRIDOR	EXISTING	EXISTING	MASONRY	PNT01	--	--	--	--	ACP01	8'-0"	REPLACE CEILING
	C11	CORRIDOR	EXISTING	EXISTING	MASONRY	PNT01	--	--	--	--	ACP01	8'-0"	REPLACE CEILING
	C12	CORRIDOR	EXISTING	EXISTING	MASONRY	PNT01	--	--	--	--	ACP01	8'-0"	REPLACE CEILING
MODULE 2	201	MAINTENANCE	EXISTING	EXISTING	MASONRY	PNT01	--	--	--	--	ACP01	10'-0"	REPLACE CEILING
	202	SHOP	EXISTING	EXISTING	MASONRY	PNT01	--	--	--	--	ACP01	10'-0"	REPLACE CEILING
	203	FEMALE HEAD	CT01	CTB01	MASONRY	CT03	--	--	--	--	PNT01	9'-0"	REPLACE CEILING
	204	SHOP	EXISTING	EXISTING	MASONRY	PNT01	--	--	--	--	ACP01	9'-0"	REPLACE CEILING
	205	VAULT	EXISTING	EXISTING	MASONRY	--	--	--	--	--	EXIST	EXIST	--
	206	PHASED MAINTENANCE	EXISTING	EXISTING	MASONRY	PNT01	--	--	--	--	ACP01	9'-0"	REPLACE CEILING
	207	MAINTENANCE CONTROL	EXISTING	EXISTING	MASONRY	PNT01	--	--	--	--	ACP01	9'-0"	REPLACE CEILING
	209	MAINTENANCE CONTROL	EXISTING	EXISTING	MASONRY	PNT01	--	--	--	--	ACP01	9'-0"	REPLACE CEILING
	210	SHOP	EXISTING	EXISTING	MASONRY	PNT01	--	--	--	--	PNT01	15'-0"	EXPOSED CEILING
	211	TARPS SHOP	EXISTING	EXISTING	MASONRY	PNT01	--	--	--	--	PNT01	15'-0"	EXPOSED CEILING
	212	MECHANICAL EQUIPMENT	EXISTING	EXISTING	MASONRY	PNT01	--	--	--	--	PNT01	15'-0"	EXPOSED CEILING
	213	CPO LOUNGE	EXISTING	EXISTING	MASONRY	PNT01	--	--	--	--	ACP01	9'-0"	REPLACE CEILING
	214	OFFICE	EXISTING	EXISTING	MASONRY	PNT01	--	--	--	--	PNT01	9'-0"	REPLACE CEILING
	215	MATERIAL CONTROL	EXISTING	EXISTING	MASONRY	PNT01	--	--	--	--	ACP01	9'-0"	SEE NOTES A-011
	216	MATERIAL ADMINISTRATION	EXISTING	EXISTING	MASONRY	PNT01	--	--	--	--	ACP01	9'-0"	SEE NOTES A-011
	217	MALE HEAD	CT01	CTB01	MASONRY	CT03	--	--	--	--	PNT01	9'-0"	REPLACE CEILING
	218	LOCKER ROOM	CT01	CTB01	MASONRY	CT03	--	--	--	--	PNT01	9'-0"	REPLACE CEILING
	219	DRYING AREA	CT02	CTB01	MASONRY	CT03	--	--	--	--	PNT01	8'-0"	REPLACE CEILING
	219	QUALITY ASSURANCE	EXISTING	EXISTING	MASONRY	PNT01	--	--	--	--	PNT01	9'-0"	REPLACE CEILING
	220	SHOWER	CT02	CTB01	MASONRY	CT03	--	--	--	--	PNT01	8'-0"	REPLACE CEILING
	221	MATERIAL CONTROL	EXISTING	EXISTING	MASONRY	PNT01	--	--	--	--	ACP01	9'-0"	REPLACE CEILING
	222	MAIL ROOM	EXISTING	EXISTING	MASONRY	PNT01	--	--	--	--	ACP01	9'-0"	REPLACE CEILING
	223	JANITOR'S CLOSET	EXISTING	EXISTING	MASONRY	PNT01	--	--	--	--	PNT01	9'-0"	REPLACE CEILING
	224	PARTS	EXISTING	EXISTING	MASONRY	PNT01	--	--	--	--	ACP01	10'-0"	REPLACE CEILING
	225	FOAM ROOM	CONC01	--	MASONRY	PNT01	--	--	--	--	PNT01	VARIES	EXPOSED CEILING
	225A	FIRE ALARM CLOSET	CONC01	--	MASONRY	PNT01	--	--	--	--	PNT01	VARIES	EXPOSED CEILING
	226	M. G. SETS	EXISTING	EXISTING	MASONRY	PNT01	--	--	--	--	PNT01	VARIES	EXPOSED CEILING
	227	MECHANICAL ROOM	EXISTING	EXISTING	MASONRY	PNT01	--	--	--	--	PNT01	VARIES	EXPOSED CEILING
	229	MAINTENANCE TRAINING	EXISTING	EXISTING	MASONRY	PNT01	--	--	--	--	PNT01	VARIES	EXPOSED CEILING
	52A	STAIR	EXISTING	EXISTING	MASONRY	PNT01	--	--	--	--	PNT01	VARIES	REPLACE CEILING
	52B	STAIR	EXISTING	EXISTING	MASONRY	PNT01	--	--	--	--	PNT01	VARIES	REPLACE CEILING
C20	CORRIDOR	EXISTING	EXISTING	MASONRY	PNT01	--	--	--	--	ACP01	8'-0"	REPLACE CEILING	
C21	CORRIDOR	EXISTING	EXISTING	MASONRY	PNT01	--	--	--	--	ACP01	8'-0"	REPLACE CEILING	
C22	CORRIDOR	EXISTING	EXISTING	MASONRY	PNT01	--	--	--	--	ACP01	8'-0"	REPLACE CEILING	

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INTERIOR FINISH SCHEDULE - 2ND FLOOR (02) - REFERENCE FINISH FLOOR PLANS

	ROOM		FLOOR	BASE	WALL MATERIAL	WALL FINISH					CEILING		REMARKS
	NO	NAME				--	N	E	S	W	MAT'L	HT	
MODULE 3	330	ADP	EXISTING	EXISTING	MASONRY	PNT01	--	--	--	--	ACP01	9'-0"	REPLACE CEILING
	330A	STORAGE	EXISTING	EXISTING	MASONRY	PNT01	--	--	--	--	ACP01	9'-0"	REPLACE CEILING
	331	SKEDS/TRAINING	EXISTING	EXISTING	MASONRY	PNT01	--	--	--	--	ACP01	9'-0"	REPLACE CEILING
	331A	OPS/O	EXISTING	EXISTING	MASONRY	PNT01	--	--	--	--	ACP01	9'-0"	REPLACE CEILING
	332	INTEL	EXISTING	EXISTING	MASONRY	PNT01	--	--	--	--	ACP01	9'-0"	REPLACE CEILING
	333	SAFE	EXISTING	EXISTING	MASONRY	--	--	--	--	--	EXIST	EXIST	--
	334	CONFERENCE	EXISTING	EXISTING	MASONRY	PNT01	--	--	--	--	ACP01	9'-0"	REPLACE CEILING
	335	SAFETY	EXISTING	EXISTING	MASONRY	PNT01	--	--	--	--	ACP01	9'-0"	REPLACE CEILING
	336A	PAO/COFFEE MESS	EXISTING	EXISTING	MASONRY	PNT01	--	--	--	--	ACP01	9'-0"	REPLACE CEILING
	336B	DEBRIEF	EXISTING	EXISTING	MASONRY	PNT01	--	--	--	--	ACP01	9'-0"	REPLACE CEILING
	336	BRIEF 1	EXISTING	EXISTING	MASONRY	PNT01	--	--	--	--	ACP01	9'-0"	REPLACE CEILING
	337	BRIEF 2	EXISTING	EXISTING	MASONRY	PNT01	--	--	--	--	ACP01	9'-0"	REPLACE CEILING
	338	BRANCH 01/DIV 0	EXISTING	EXISTING	MASONRY	PNT01	--	--	--	--	ACP01	9'-0"	REPLACE CEILING
	339	JANITOR'S CLOSET	EXISTING	EXISTING	MASONRY	PNT01	--	--	--	--	ACP01	9'-0"	REPLACE CEILING
	340	1ST LT	EXISTING	EXISTING	MASONRY	PNT01	--	--	--	--	PNT01	9'-0"	REPLACE CEILING
	341	FEMALE HEAD	CT01	CTB01	MASONRY	CT03	--	--	--	--	PNT01	9'-0"	REPLACE CEILING
	342	JACK ERNIE	EXISTING	EXISTING	MASONRY	PNT01	--	--	--	--	ACP01	9'-0"	REPLACE CEILING (BLACK)
	348	READY ROOM	EXISTING	EXISTING	MASONRY	PNT01	--	--	--	--	ACP01	9'-0"	REPLACE CEILING
	347	X.O.	EXISTING	EXISTING	MASONRY	PNT01	--	--	--	--	ACP01	9'-0"	REPLACE CEILING
	348	PASS	EXISTING	EXISTING	MASONRY	PNT01	--	--	--	--	ACP01	9'-0"	REPLACE CEILING
	349	HEAD	CT01	CTB01	MASONRY	CT03	--	--	--	--	ACP01	9'-0"	REPLACE CEILING
	350	C.O.	EXISTING	EXISTING	MASONRY	PNT01	--	--	--	--	ACP01	9'-0"	REPLACE CEILING
	351	RECEPTION	EXISTING	EXISTING	MASONRY	PNT01	--	--	--	--	ACP01	9'-0"	REPLACE CEILING
	352	ADMIN	EXISTING	EXISTING	MASONRY	PNT01	--	--	--	--	ACP01	9'-0"	REPLACE CEILING
	353	CMC	EXISTING	EXISTING	MASONRY	PNT01	--	--	--	--	ACP01	9'-0"	REPLACE CEILING
	355	MALE HEAD	CT01	CTB01	MASONRY	CT03	--	--	--	--	PNT01	9'-0"	REPLACE CEILING
	356	LOCKER ROOM	CT01	CTB01	MASONRY	CT03	--	--	--	--	PNT01	9'-0"	REPLACE CEILING
	357	DRYING AREA	CT02	CTB01	MASONRY	CT03	--	--	--	--	PNT01	8'-0"	REPLACE CEILING
	358	SHOWER	CT02	CTB01	MASONRY	CT03	--	--	--	--	PNT01	8'-0"	REPLACE CEILING
	359	STORAGE	EXISTING	EXISTING	MASONRY	PNT01	--	--	--	--	ACP01	9'-0"	REPLACE CEILING
	53A	STAIR	EXISTING	EXISTING	MASONRY	PNT01	--	--	--	--	PNT01	VARIES	REPLACE CEILING
	53B	STAIR	EXISTING	EXISTING	MASONRY	PNT01	--	--	--	--	PNT01	VARIES	REPLACE CEILING
	C30	CORRIDOR	EXISTING	EXISTING	MASONRY	PNT01	--	--	--	--	ACP01	8'-0"	REPLACE CEILING


GENERAL FINISH NOTES

- EXTERIOR PAINTING: PREPARE AND PAINT MASONRY WALLS, ROOF STEEL STRUCTURE, PIPES, CONDUITS, METAL PANELS, DOORS, DOOR FRAMES, GUTTERS, DOWNSPOUTS, METAL LADDERS, RAIN LEADERS AND METAL ROOFING. REFERENCE ARCHITECTURAL DRAWING SERIES A-200 FOR ADDITIONAL INFORMATION.
- INTERIOR PAINTING: PREPARE AND PAINT MASONRY WALLS, HANGAR ROOF STEEL STRUCTURE (TRUSSES, JOISTS, ROOF DECK), DRAFT CURTAINS, PIPES AND CONDUITS.
- REFERENCE ARCHITECTURAL DRAWING SERIES A-120 FOR REFLECTED CEILING PLANS AND CEILING WORK / FINISHES.
- REFERENCE ARCHITECTURAL DRAWING SERIES A-130 FOR FINISH FLOOR PLAN, AREAS OF WORK AND HANGAR FLOOR STRIPING NOTES.
- EXISTING HANGAR EXTERIOR SIGNAGE MUST BE REMOVED, STORED AND SALVAGED FOR INSTALLATION ONCE CONSTRUCTION ACTIVITIES HAVE BEEN COMPLETED. REFERENCE ARCHITECTURAL DRAWING SERIES A-200 FOR ADDITIONAL INFORMATION.
- RAKE OUT AND PROVIDE CONTINUOUS SEALANT AT MASONRY CONTROL JOINTS.

FLOOR REMOVAL COORDINATION NOTES

- THE FOLLOWING NOTES COORDINATE WITH THE BID OPTIONS REFERENCED ON DRAWING A-001.
- PRIOR TO REMOVAL OF FLOOR FINISHES REFERENCE ENVIRONMENTAL DOCUMENTS FOR ADDITIONAL INFORMATION.
 - ROOMS 115, 116, 124, 316 AND 322 CONTAIN VINYL TILE BELOW THE CARPET FINISH. PRIOR TO REMOVAL OF THIS FLOOR TILE REFERENCE ENVIRONMENTAL DOCUMENTS FOR ADDITIONAL INFORMATION.
 - FLOOR REMOVAL IN ROOMS THAT CONTAIN CARPET MUST INCLUDE CARPET PADDING, UNDERLAYMENTS AND ADHESIVE.
 - FLOOR REMOVAL IN ROOMS THAT CONTAIN VINYL TILE MUST INCLUDE UNDERLAYMENTS AND ADHESIVE.

FLOOR TRANSITION DETAIL

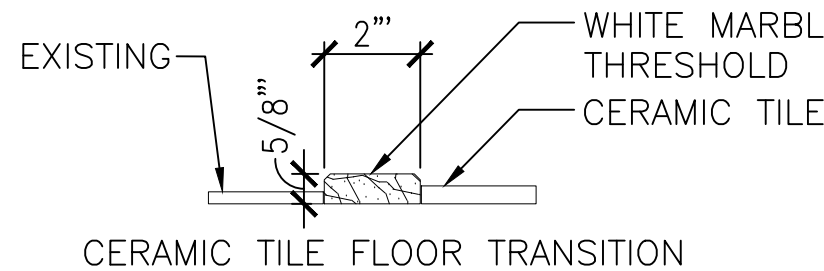

PAINT REMOVAL AND SURFACE PREPARATION GENERAL NOTES

- REFERENCE DOCUMENT OC-SOP-WA-14 / SURFACE PREPARATION AND PAINTING STANDARD OPERATING PROCEDURE (SOP) DATED MARCH 1, 2019. THIS DOCUMENT OUTLINES THE VARIOUS PAINT REMOVAL OPTIONS, PROCEDURES AND TESTING REQUIRED.
- REFERENCE DRAWING A-002 FOR EXTERIOR STRUCTURAL ROOF STEEL PAINT REMOVAL AND PAINT APPLICATION NOTES.
- REFERENCE ENVIRONMENTAL DOCUMENTS FOR ADDITIONAL INFORMATION PRIOR TO PAINT REMOVAL.
- ABRASIVE BLASTING IS NOT ALLOWED.
- HAND TOOLING AND PREPARATION BY HAND IS THE PREFERRED METHOD OF PAINT REMOVAL.
- IF THE WATER REMOVAL OPERATION IS UTILIZED, THE WASTEWATER MUST BE TESTED PRIOR TO DISCHARGING INTO THE SANITARY SEWER SYSTEM. THE WASTEWATER MUST NOT BE DISCHARGED INTO THE STORM SEWER SYSTEM.

EXISTING MASONRY PAINT REMOVAL & PAINTING GENERAL NOTES

THE EXISTING EXTERIOR MASONRY WALL IS IN DISREPAIR AND MUST BE PATCHED, REPAIRED AND PAINTED. THIS SCOPE OF WORK INCLUDES BOTH THE EXTERIOR AND THE INTERIOR FACES OF THE MASONRY WALL. THE EXISTING MASONRY SURFACES CONTAIN MULTIPLE COATS OF PAINT. REMOVE THE EXISTING COATS OF PAINT TO EXPOSE THE ORIGINAL / EXISTING FACE OF MASONRY. REFERENCE THE PAINT REMOVAL NOTES ON THIS SHEET FOR ADDITIONAL INFORMATION. REFERENCE THE ARCHITECTURAL DRAWING SERIES A-200 FOR AREAS OF DAMAGED MASONRY, TYPE OF DAMAGE AND THE REPAIR DETAIL.

PAINT REMOVAL NOTE:
REMOVE THE EXISTING PAINT AND PREPARE MASONRY SURFACES FOR PAINT COATING. PREVENT FOREIGN OBJECT DEBRIS CREATED DURING THIS PROCESS AS THIS IS AN ENVIRONMENTAL CONCERN. PROVIDE A PAINT REMOVAL ACTION PLAN THAT ADDRESSES METHODS FOR REMOVING PAINT, DEBRIS COLLECTION, ENVIRONMENTAL IMPACTS AND EXISTING MASONRY PREPARATION FOR COATINGS. PROVIDE ACTION PLAN TO THE CONTRACTING OFFICER FOR REVIEW AND APPROVAL.

PAINTING NOTE:
PREVENT WINDBORNE PAINT CREATED DURING THIS PROCESS AS THIS IS AN ENVIRONMENTAL CONCERN. PROVIDE A PAINT APPLICATION PLAN TO THE CONTRACTING OFFICER FOR REVIEW AND APPROVAL.

INTERIOR FINISH SCHEDULE - 2ND FLOOR (02) - REFERENCE FINISH FLOOR PLANS

	ROOM		FLOOR	BASE	WALL MATERIAL	WALL FINISH					CEILING		REMARKS
	NO	NAME				--	N	E	S	W	MAT'L	HT	
MODULE 1	130A	BRIEF ROOM 1	EXISTING	EXISTING	MASONRY	PNT01	--	--	--	--	ACP01	9'-0"	REPLACE CEILING
	130	BREAK ROOM	EXISTING	EXISTING	MASONRY	PNT01	--	--	--	--	ACP01	9'-0"	REPLACE CEILING
	131	OPS	EXISTING	EXISTING	MASONRY	PNT01	--	--	--	--	ACP01	9'-0"	REPLACE CEILING
	132	INTEL	EXISTING	EXISTING	MASONRY	PNT01	--	--	--	--	ACP01	9'-0"	REPLACE CEILING (BLACK)
	133	SAFE	EXISTING	EXISTING	MASONRY	--	--	--	--	--	EXIST	EXIST	--
	134	JOPA	EXISTING	EXISTING	MASONRY	PNT01	--	--	--	--	ACP01	9'-0"	REPLACE CEILING
	135	CONFERENCE ROOM	EXISTING	EXISTING	MASONRY	PNT01	--	--	--	--	ACP01	9'-0"	REPLACE CEILING
	136	PARALOFT	EXISTING	EXISTING	MASONRY	PNT01	--	--	--	--	ACP01	9'-0"	REPLACE CEILING
	137	SAFETY NATOPS	EXISTING	EXISTING	MASONRY	PNT01	--	--	--	--	ACP01	9'-0"	REPLACE CEILING
	138	INFORM SYSTEM	EXISTING	EXISTING	MASONRY	PNT01	--	--	--	--	ACP01	9'-0"	REPLACE CEILING
	139	JANITOR'S CLOSET	EXISTING	EXISTING	MASONRY	PNT01	--	--	--	--	ACP01	9'-0"	REPLACE CEILING
	140	CCC	EXISTING	EXISTING	MASONRY	PNT01	--	--	--	--	PNT01	9'-0"	REPLACE CEILING
	141	FEMALE HEAD	CT01	CTB01	MASONRY	CT03	--	--	--	--	PNT01	9'-0"	REPLACE CEILING
	142	BRIEF ROOM 2	EXISTING	EXISTING	MASONRY	PNT01	--	--	--	--	ACP01	9'-0"	REPLACE CEILING
	145	CMC	EXISTING	EXISTING	MASONRY	PNT01	--	--	--	--	ACP01	9'-0"	REPLACE CEILING
	146	COMBAT ADMIN	EXISTING	EXISTING	MASONRY	PNT01	--	--	--	--	ACP01	9'-0"	REPLACE CEILING
	147	X.O.	EXISTING	EXISTING	MASONRY	PNT01	--	--	--	--	ACP01	9'-0"	REPLACE CEILING
	148	PASS	EXISTING	EXISTING	MASONRY	PNT01	--	--	--	--	ACP01	9'-0"	REPLACE CEILING
	149	HEAD	CT01	CTB01	MASONRY	CT03	--	--	--	--	ACP01	9'-0"	REPLACE CEILING
	150	C.O.	EXISTING	EXISTING	MASONRY	PNT01	--	--	--	--	ACP01	9'-0"	REPLACE CEILING
	151	RECEPTION	EXISTING	EXISTING	MASONRY	PNT01	--	--	--	--	ACP01	9'-0"	REPLACE CEILING
	152	READY ROOM	EXISTING	EXISTING	MASONRY	PNT01	--	--	--	--	ACP01	9'-0"	REPLACE CEILING
	155	MALE HEAD	CT01	CTB01	MASONRY	CT03	--	--	--	--	PNT01	9'-0"	REPLACE CEILING
	156	LOCKER ROOM	CT01	CTB01	MASONRY	CT03	--	--	--	--	PNT01	9'-0"	REPLACE CEILING
	157	DRYING AREA	CT02	CTB01	MASONRY	CT03	--	--	--	--	PNT01	8'-0"	REPLACE CEILING
	158	SHOWER	CT02	CTB01	MASONRY	CT03	--	--	--	--	PNT01	8'-0"	REPLACE CEILING
	159	1ST LT	EXISTING	EXISTING	MASONRY	PNT01	--	--	--	--	ACP01	9'-0"	REPLACE CEILING
	51A	STAIR	EXISTING	EXISTING	MASONRY	PNT01	--	--	--	--	PNT01	VARIES	REPLACE CEILING
	51B	STAIR	EXISTING	EXISTING	MASONRY	PNT01	--	--	--	--	PNT01	VARIES	REPLACE CEILING
	C13	CORRIDOR	EXISTING	EXISTING	MASONRY	PNT01	--	--	--	--	ACP01	8'-0"	REPLACE CEILING
	230A	PROJECTION ROOM	EXISTING	EXISTING	MASONRY	PNT01	--	--	--	--	ACP01	9'-0"	REPLACE CEILING
	230	BRIEF 1	EXISTING	EXISTING	MASONRY	PNT01	--	--	--	--	ACP01	9'-0"	REPLACE CEILING
	230B	BRIEF 1	EXISTING	EXISTING	MASONRY	PNT01	--	--	--	--	ACP01	9'-0"	REPLACE CEILING
	231	JOPA	EXISTING	EXISTING	MASONRY	PNT01	--	--	--	--	ACP01	9'-0"	REPLACE CEILING
	232	MISSION PLANNING	EXISTING	EXISTING	MASONRY	PNT01	--	--	--	--	ACP01	9'-0"	REPLACE CEILING
	233	SAFE	EXISTING	EXISTING	MASONRY	--	--	--	--	--	EXIST	EXIST	--
	234	OPS/SKEDS	EXISTING	EXISTING	MASONRY	PNT01	--	--	--	--	ACP01	9'-0"	REPLACE CEILING
	235	OPS	EXISTING	EXISTING	MASONRY	PNT01	--	--	--	--	ACP01	9'-0"	REPLACE CEILING
	236	INTEL	EXISTING	EXISTING	MASONRY	PNT01	--	--	--	--	ACP01	9'-0"	REPLACE CEILING
	236A	PROJECTION ROOM	EXISTING	EXISTING	MASONRY	PNT01	--	--	--	--	ACP01	9'-0"	REPLACE CEILING
	237	SAFETY	EXISTING	EXISTING	MASONRY	PNT01	--	--	--	--	ACP01	9'-0"	REPLACE CEILING
	238	WORD PROCESSING	EXISTING	EXISTING	MASONRY	PNT01	--	--	--	--	ACP01	9'-0"	REPLACE CEILING
	239	JANITOR'S CLOSET	EXISTING	EXISTING	MASONRY	PNT01	--	--	--	--	ACP01	9'-0"	REPLACE CEILING
	240	FEMALE HEAD	CT01	CTB01	MASONRY	CT03	--	--	--	--	PNT01	9'-0"	REPLACE CEILING
	241	MALE HEAD	CT01	CTB01	MASONRY	CT03	--	--	--	--	PNT01	9'-0"	REPLACE CEILING
	242	CCC/ADP	EXISTING	EXISTING	MASONRY	PNT01	--	--	--	--	ACP01	9'-0"	REPLACE CEILING
	245	READY ROOM	EXISTING	EXISTING	MASONRY	PNT01	--	--	--	--	ACP01	9'-0"	REPLACE CEILING
	247	X.O.	EXISTING	EXISTING	MASONRY	PNT01	--	--	--	--	ACP01	9'-0"	REPLACE CEILING
	248	PASS	EXISTING	EXISTING	MASONRY	PNT01	--	--	--	--	ACP01	9'-0"	REPLACE CEILING
	249	HEAD	CT01	CTB01	MASONRY	CT03	--	--	--	--	ACP01	9'-0"	REPLACE CEILING
	250	C.O.	EXISTING	EXISTING	MASONRY	PNT01	--	--	--	--	ACP01	9'-0"	REPLACE CEILING
	251	RECEPTION	EXISTING	EXISTING	MASONRY	PNT01	--	--	--	--	ACP01	9'-0"	REPLACE CEILING
	252	ADMIN	EXISTING	EXISTING	MASONRY	PNT01	--	--	--	--	ACP01	9'-0"	REPLACE CEILING
	253	CMC	EXISTING	EXISTING	MASONRY	PNT01	--	--	--	--	ACP01	10'-0"	REPLACE CEILING
	255	MALE HEAD	CT01	CTB01	MASONRY	CT03	--	--	--	--	PNT01	9'-0"	REPLACE CEILING
	256	LOCKER ROOM	CT01	CTB01	MASONRY	CT03	--	--	--	--	PNT01	9'-0"	REPLACE CEILING
	257	DRYING AREA	CT02	CTB01	MASONRY	CT03	--	--	--	--	PNT01	8'-0"	REPLACE CEILING
	258	SHOWER	CT02	CTB01	MASONRY	CT03	--	--	--	--	PNT01	8'-0"	REPLACE CEILING
	259	1ST LT	EXISTING	EXISTING	MASONRY	PNT01	--	--	--	--	ACP01	VARIES	REPLACE CEILING
	52A	STAIR	EXISTING	EXISTING	MASONRY	PNT01	--	--	--	--	PNT01	VARIES	REPLACE CEILING
	52B	STAIR	EXISTING	EXISTING	MASONRY	PNT01	--	--	--	--	PNT01	VARIES	REPLACE CEILING
	C23	CORRIDOR	EXISTING	EXISTING	MASONRY	PNT01	--	--	--	--	ACP01	8'-0"	REPLACE CEILING


EXISTING LOCKERS NOTE

SALVAGE EXISTING LOCKERS FOR REUSE. THE EXISTING LOCKERS LOCATED THROUGHOUT 01 AND 02 AREAS MUST BE REMOVED PRIOR TO THE COMMENCEMENT OF CONSTRUCTION ACTIVITIES. PROTECT LOCKERS FROM DAMAGE, REMOVE FROM THE CONSTRUCTION SITE, AND SAFELY STORE THEM. AT THE END OF CONSTRUCTION, THE LOCKERS MUST BE REINSTALLED.




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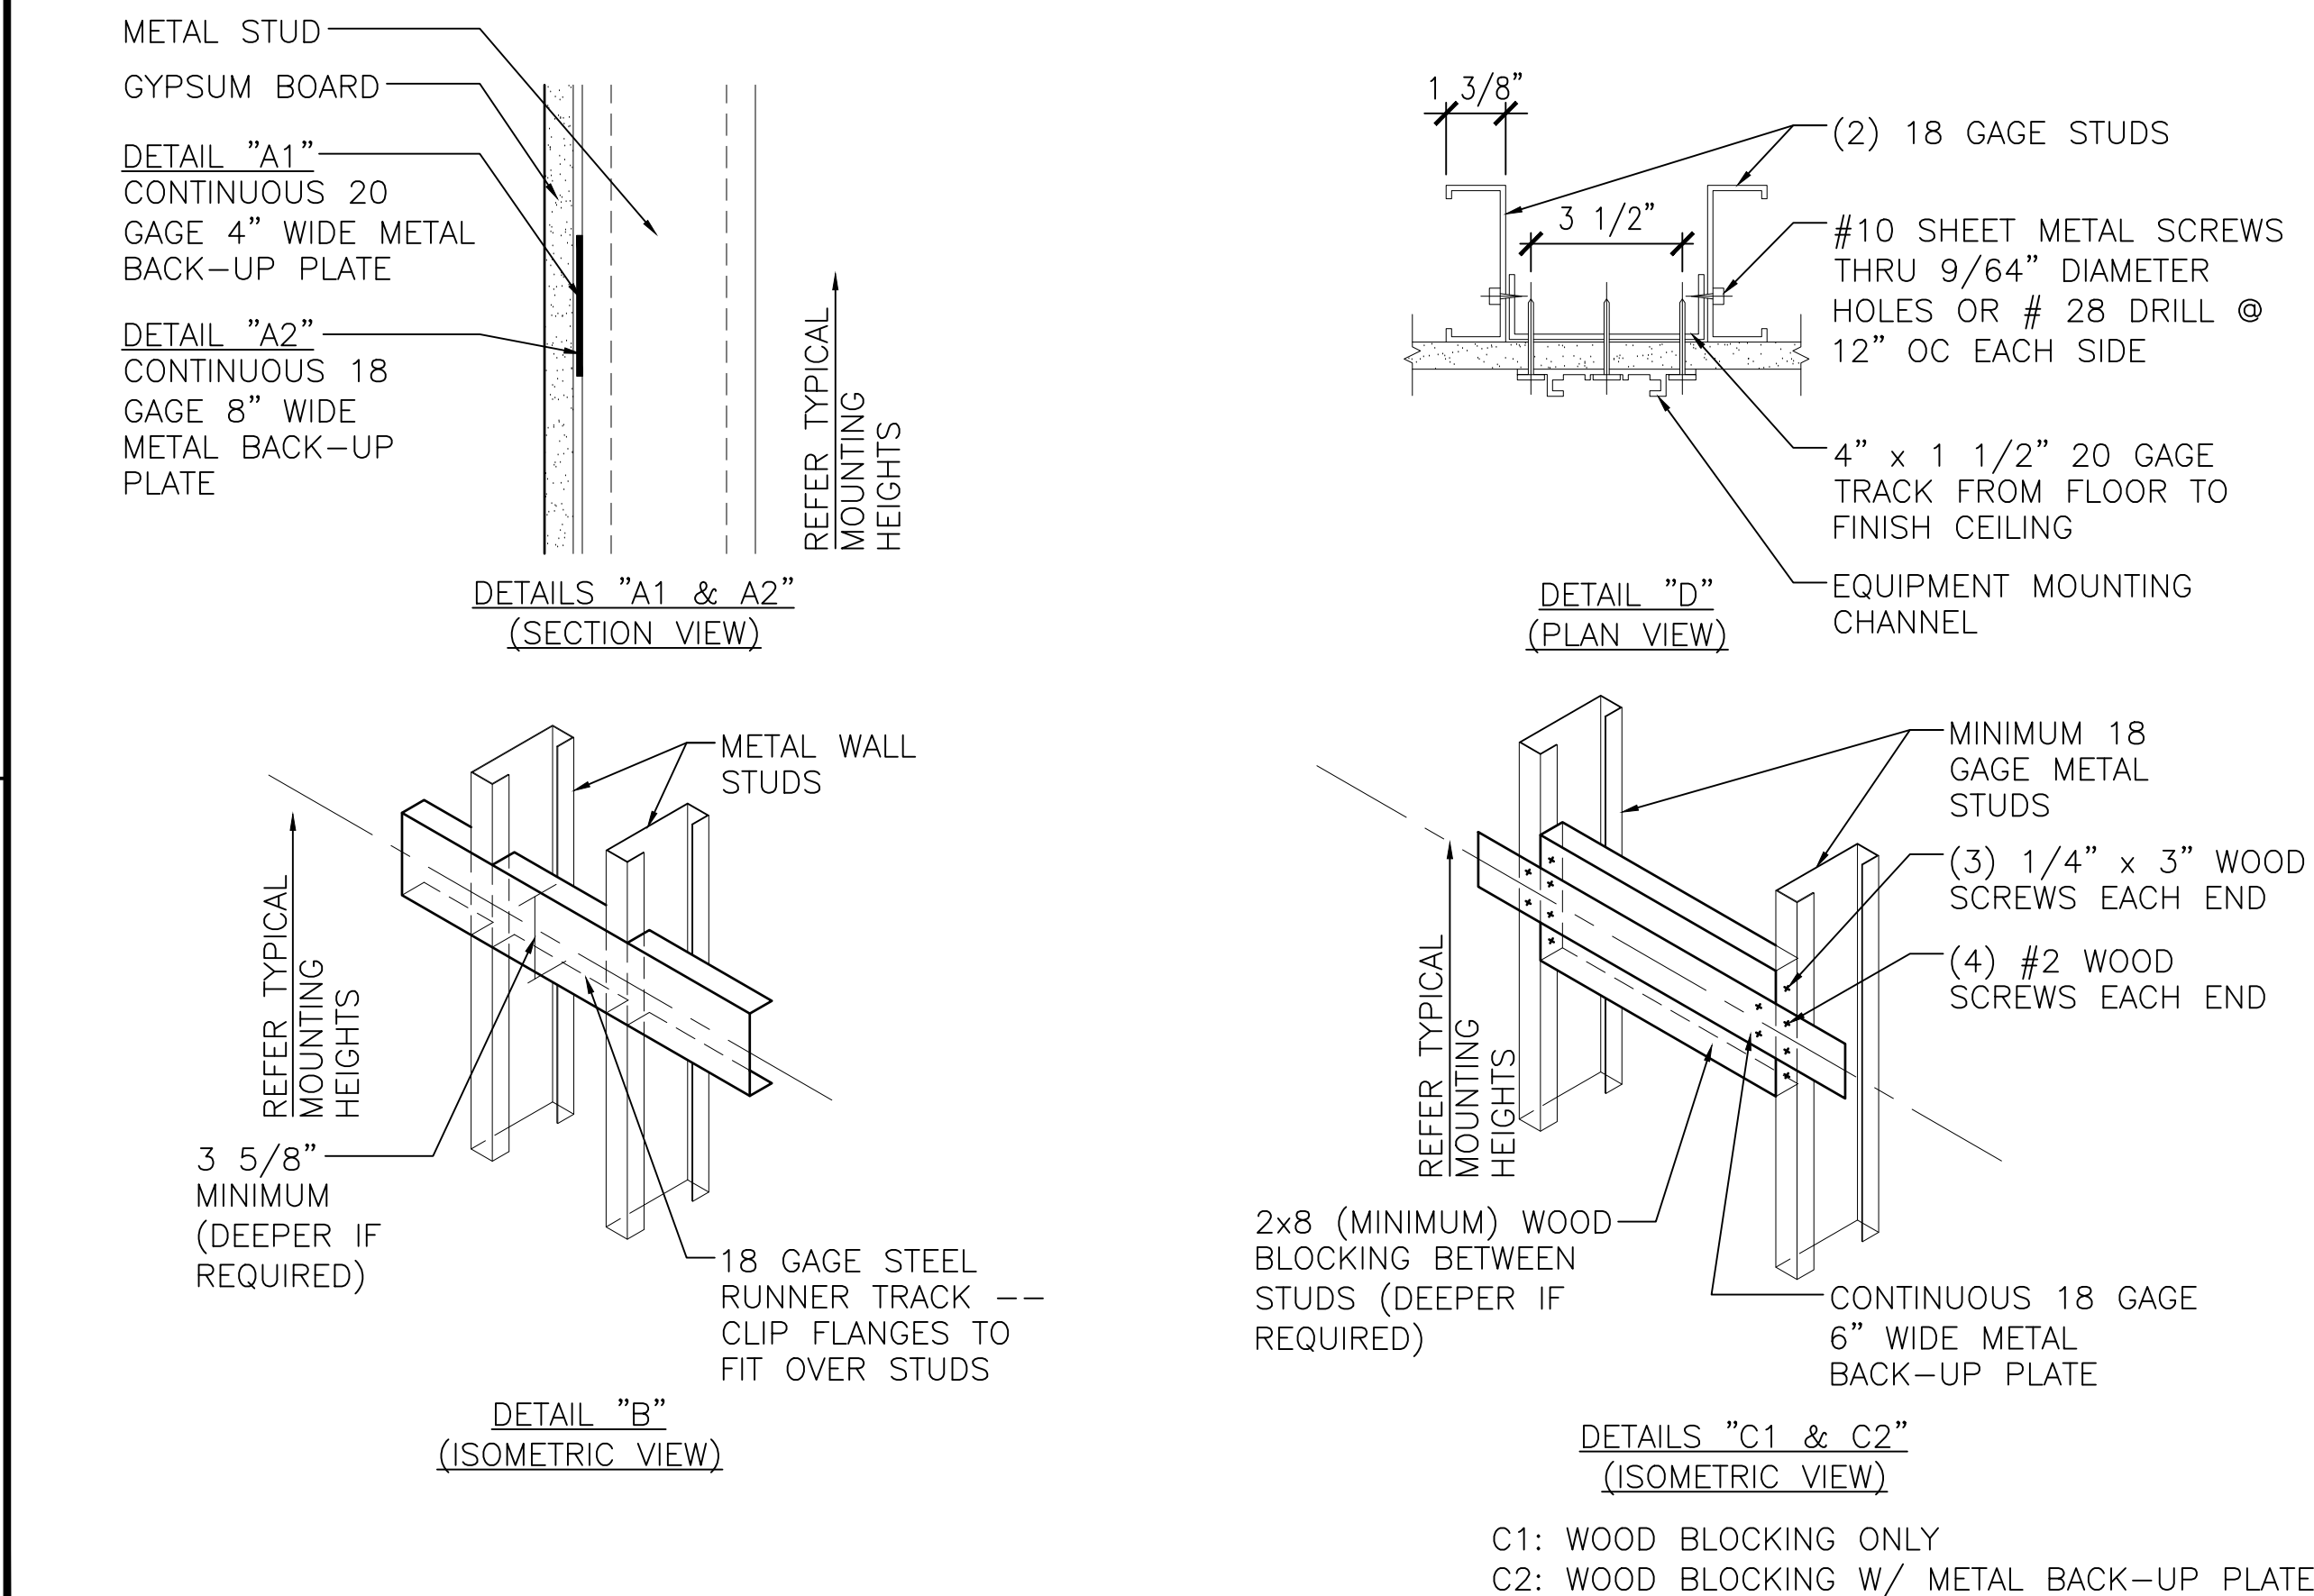
PARTITION FRAMING AND DETAILS

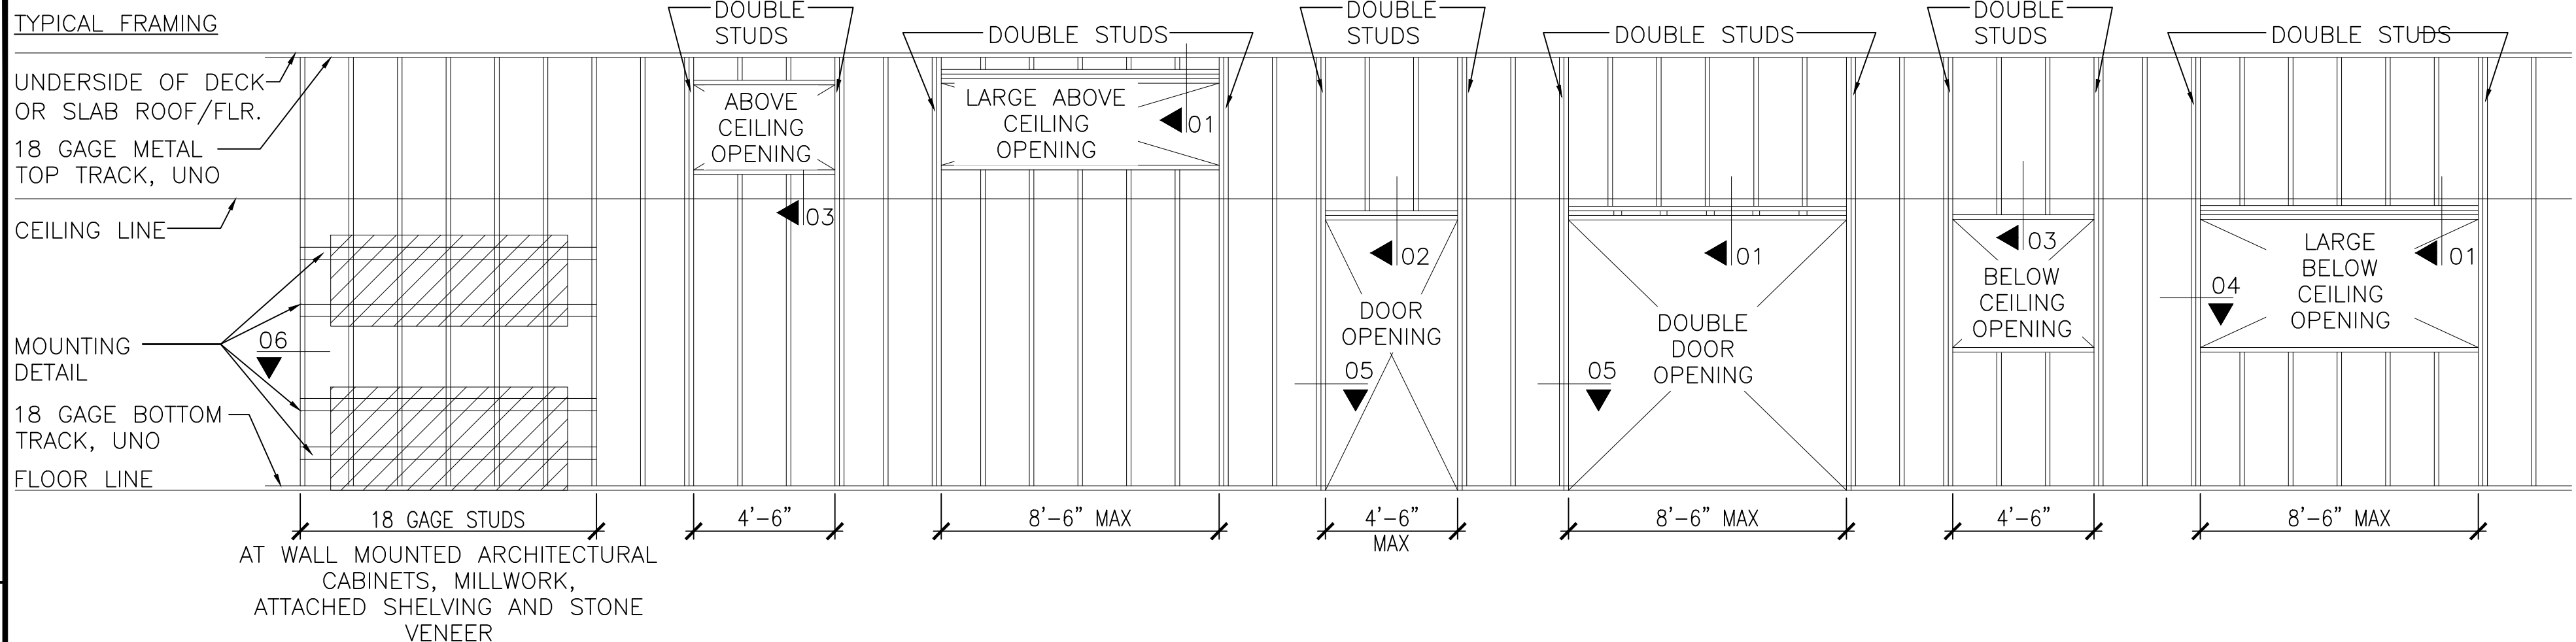


FRAMING DETAILS

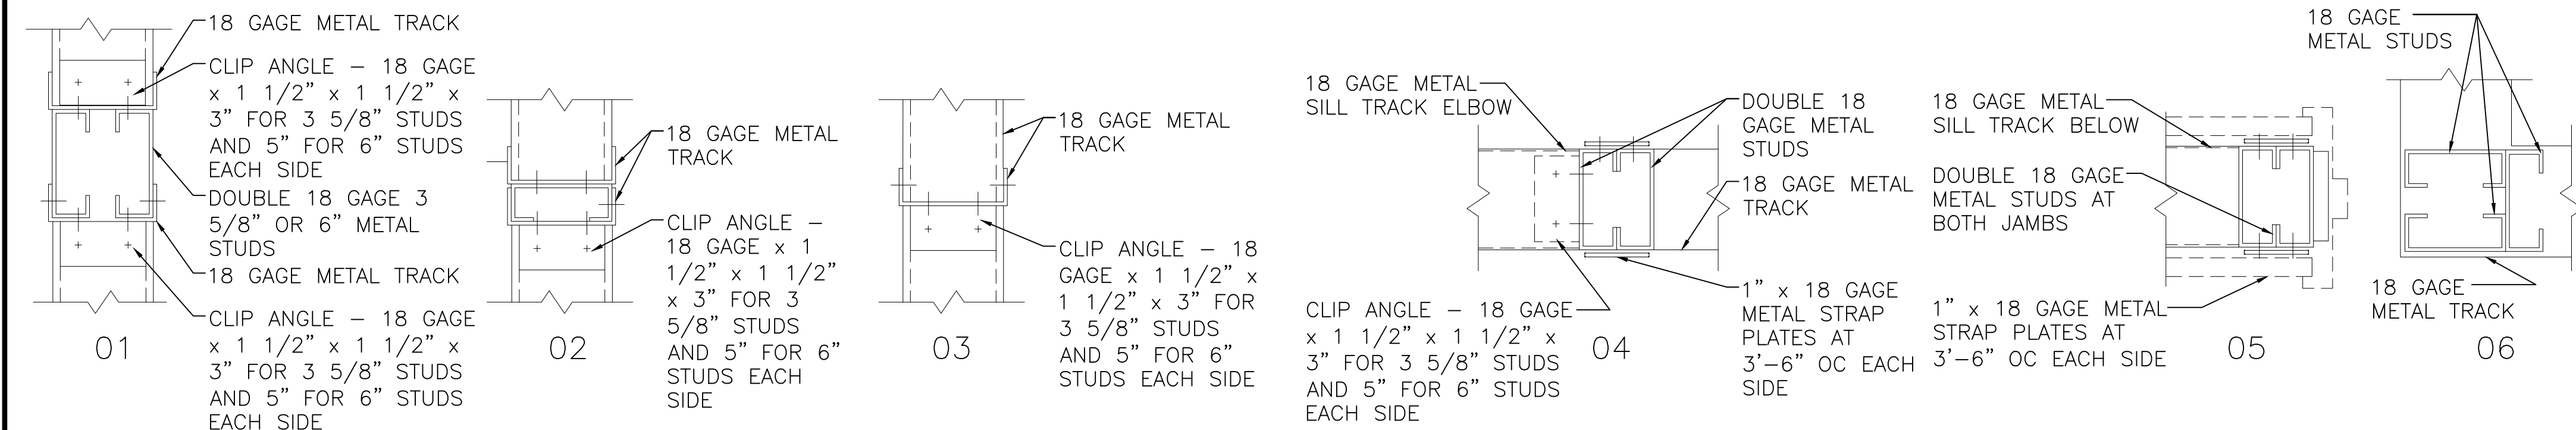

BLOCKING AND MOUNTING DETAILS



BLOCKING MUST BE FLUSH WITH FACE OF STUD
KERF BLOCKING AT BACKSIDE OF STUD

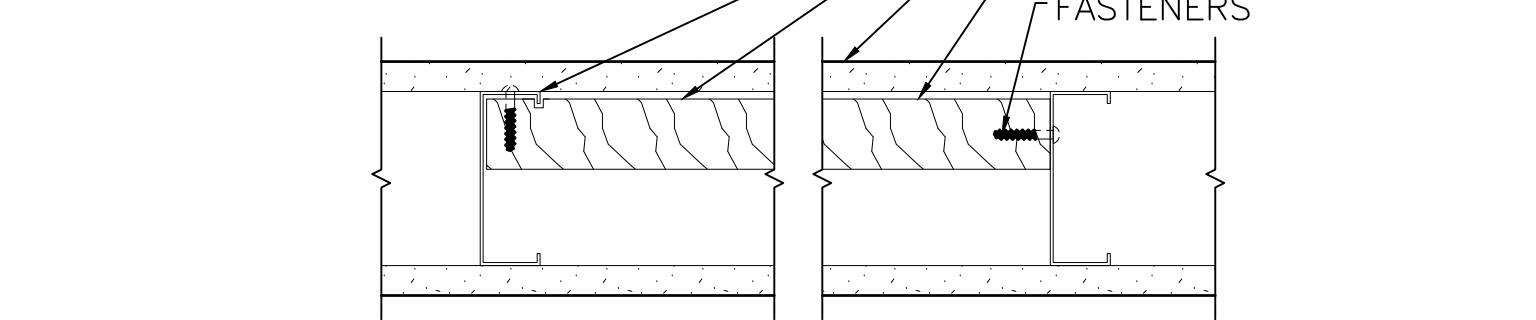

PROVIDE WOOD BLOCKING FOR WALL MOUNTED EQUIPMENT, INCLUDING CASEWORK, SHELVING, GRAB BARS, AND HANDRAILS AS FOLLOWS:
A. LOADS UNDER 200 POUNDS: CLIP METAL STUD RETURN FLANGE AT BLOCKING LOCATION TO FORM TAB. BEND TAB FLUSH WITH FACE OF STUD FLANGE AND ATTACH WOOD BLOCKING AS INDICATED
B. LOADS OVER 200 POUNDS: AS ABOVE, BUT WITH 2x4xWIDTH OF STUD WOOD CLEAT ATTACHED TO STUD BELOW BLOCKING

MASONRY LINTEL SCHEDULE


MASONRY OPENING WIDTH	6" OR 8" MASONRY WALL	12" MASONRY WALL	BEARING
2'-0" TO 5'-4"	2-#5	3-#4	8"
5'-4" TO 8'-8"	2-#6	3-#5	8"
8'-8" TO 12'-0"	2-#6	3-#5	1'-4"

NOTE: CONCRETE MASONRY LINTELS MUST BE FILLED WITH MASONRY GROUT.
NOTE: UNSCHEDULED OPENINGS INCLUDING OPENINGS FOR MECHANICAL WORK MUST BE PROVIDED WITH LINTELS IN ACCORDANCE WITH THIS SCHEDULE. FOR OPENINGS LESS THAN 2'-0", USE 3/8" BY 3 1/2" PLATE LINTEL BEARING 8" ON EACH END.

PARTITION TYPE NOTES

1. PROVIDE CONTROL JOINTS IN GYPSUM WALLBOARD PARTITIONS AT 30'-0" OC MAXIMUM OR AS INDICATED ON FLOOR PLANS.
2. ONE SIDE OF GYPSUM WALLBOARD MAY BE WHEN UNUSED SPACE (IE, UNDER STAIR) OR UNFINISHED TENANT SPACE EXISTS ON ONE SIDE, EXCEPT WHERE REQUIRED FOR FIRE RATING.
3. STUD SPACING MUST BE 16" ON CENTER UNLESS OTHERWISE NOTED.
4. PARTITION SYMBOL INDICATIONS ON FLOOR PLANS DESIGNATE THE ENTIRE LENGTH OF WALL INDICATED UNLESS INTERRUPTED BY ANOTHER SYMBOL.
5. UTILIZE EXTENDED TRACKS WITH SLOTTED HOLES AT TOPS OF PARTITIONS WHEREVER ATTACHING TO STRUCTURE ABOVE TO ALLOW FOR DEFLECTION.
6. SUBSTITUTE MOISTURE RESISTANT BOARD (PURPLE BOARD) FOR WET LOCATIONS (TOILETS, LOCKER ROOMS) OR WHERE SCHEDULED TO RECEIVE CERAMIC TILE OR STONE. FOR OTHER WET APPLICATIONS SUCH AS SHOWERS, USE CEMENTITIOUS TILE BACKER BOARDS.
7. GYPSUM BOARDS MUST BE HELD UP 1/4" TO 3/8" FROM TOP OF FLOOR SLAB.
8. PROVIDE CONTINUOUS SEALANT UNDER METAL TRACKS AND AT PERIMETER OF GYPSUM BOARD PANELS AT STC RATED ASSEMBLIES.
9. METAL STUD PARTITIONS SCHEDULED TO SUPPORT WALL MOUNTED CASEWORK OR EQUIPMENT MUST HAVE 18 GAGE MINIMUM STUDS FOR THE ENTIRE LENGTH OF THE CASEWORK.
10. PROVIDE WOOD OR METAL BLOCKING FOR WALL MOUNTED EQUIPMENT, INCLUDING CASEWORK, GRAB BARS, SHELVING, HANDRAILS, TOILET PARTITIONS, ETC. SEE DETAIL "A" ON THIS SHEET FOR BLOCKING.
11. PROVIDE DOUBLED 18 GAGE MINIMUM STUDS AROUND DOOR, WINDOW OR CASED OPENINGS UNLESS OTHERWISE NOTED.
12. WHERE SOUND ATTENUATION BLANKETS ARE INDICATED, PROVIDE THERMAFIBER OR EQUAL. WHERE BATT INSULATION IS INDICATED PROVIDE THERMAL FIBERGLASS INSULATION WITH VAPOR RETARDER.
13. STC RATINGS ARE SHOWN FOR KNOWN TEST ASSEMBLIES FOR THE STUD SIZE INDICATED. FOR OTHER STUD SIZES COMPLY WITH REQUIREMENTS OF CLOSEST SIMILAR ASSEMBLY.
14. MINIMUM STC RATING 40 IS REQUIRED UNLESS OTHERWISE NOTED.
15. SUSPENDED CEILINGS SHOWN REPRESENT THE MOST TYPICAL CONDITIONS. REFER TO REFLECTED CEILING PLANS, FINISH SCHEDULES, AND OTHER DETAILS FOR SPECIFIC CEILINGS.

CONTROL JOINT DETAILS

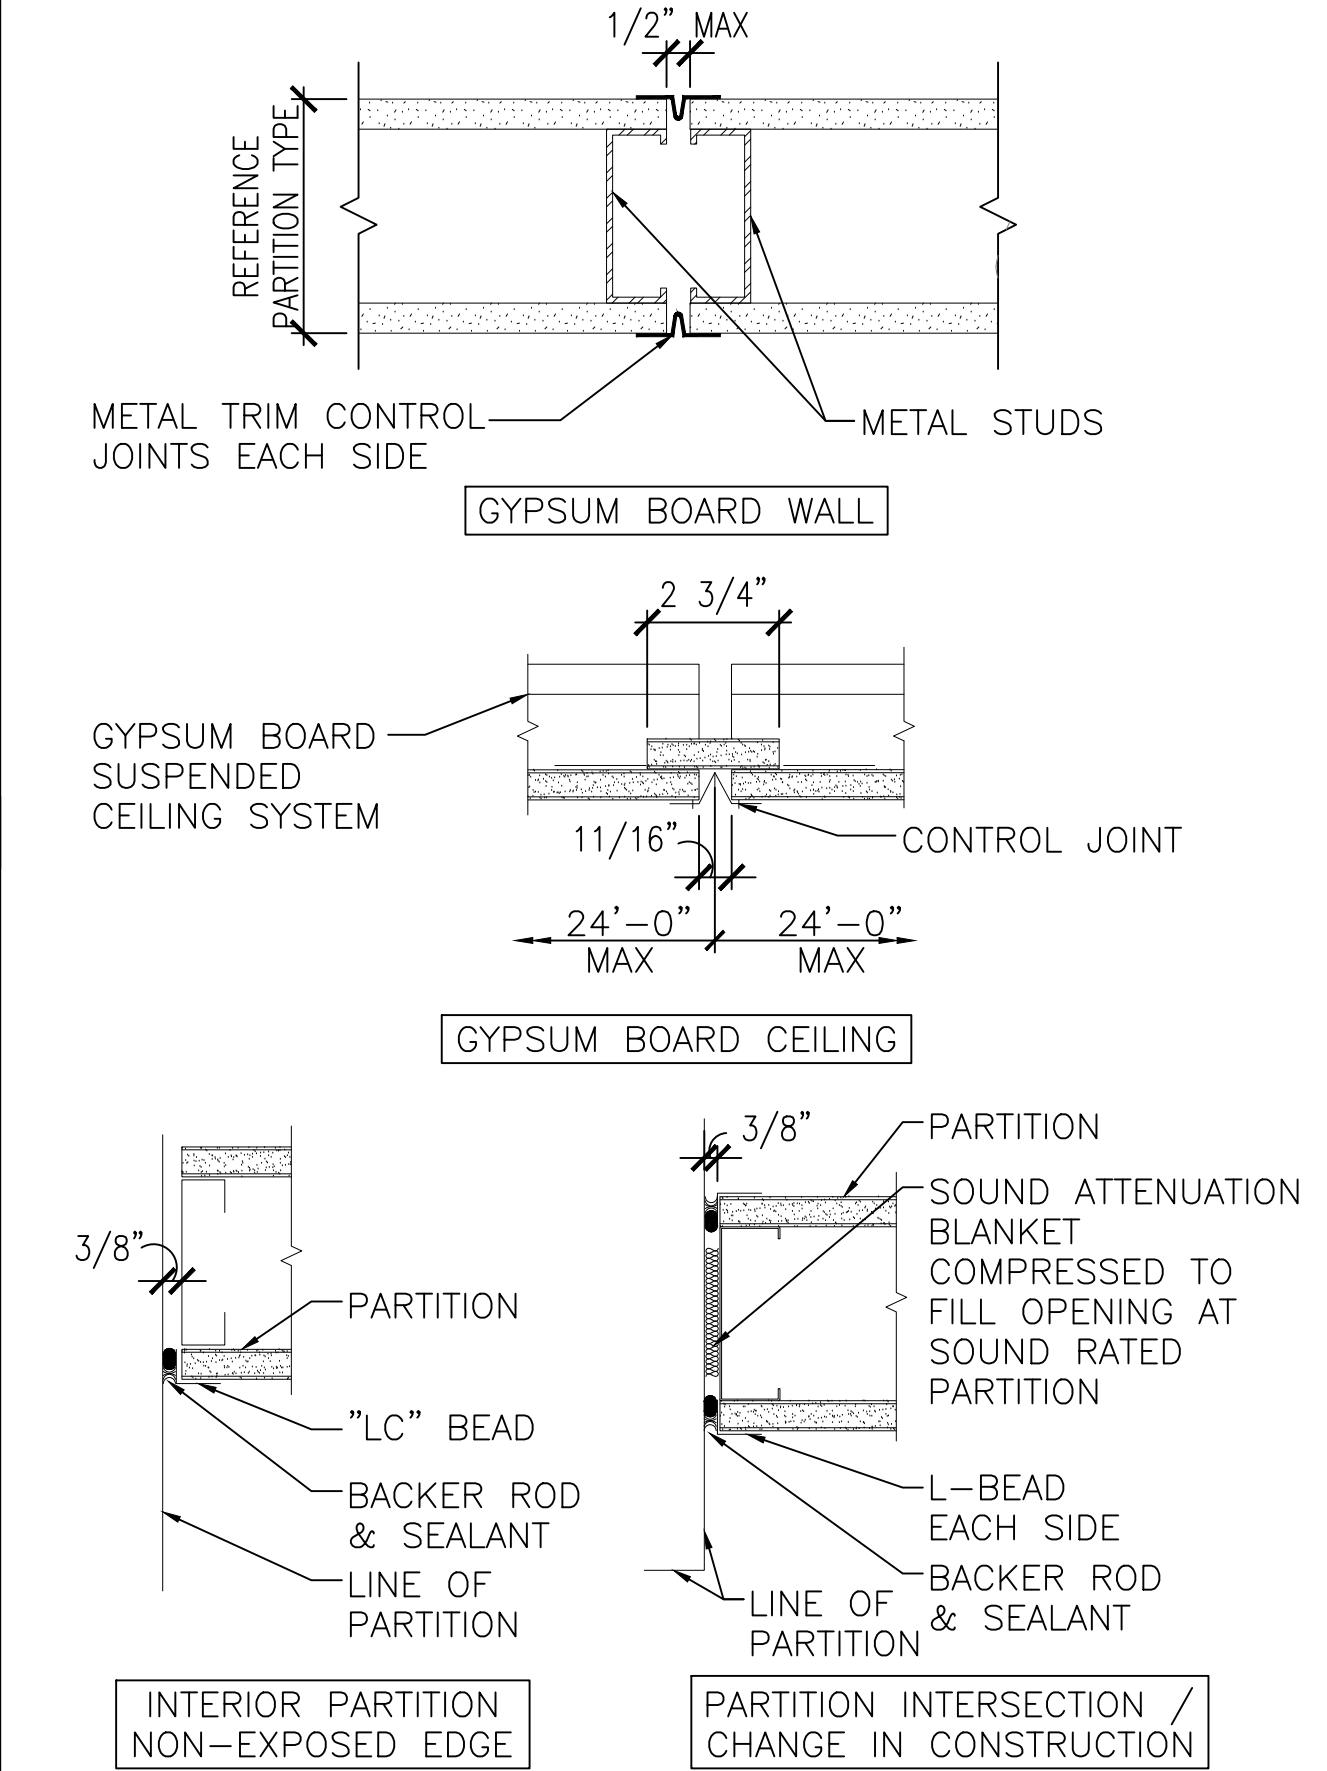

APPROVED BY KYLE STRAUSBAUGH, NAVFAC FEAD DIRECTOR - FWD OCEANA, VA EMAIL: kyle.strausbaugh@navfac.navy.mil

12/06/2022

DES: JMT/DRW JMT/CHK DRY

FM/DM EAW/CWJ

BRANCH MANAGER CGM

CHIEF ENG/ARCH EJA

FIRE PROTECTION DSN

NAVAL FACILITIES ENGINEERING SYSTEMS COMMAND ~ MID-ALANTIC NAVAL STATION - NORFOLK, VA VIRGINIA BEACH, VA

HANGAR 404 FIRE PROTECTION AND BUILDING ENVELOPE REPAIRS

PARTITION FRAMING AND BLOCKING DETAILS

SCALE: AS NOTED

PROJECT NO.: 1372148

CONSTR. CONTR. NO.

NAVFAC DRAWING NO. 12821670

SHEET 63 OF 382

A-020


DRAWING REVISION: 07 AUG 2018

FILE NAME: \\gdrnet\gnd\US\Chantilly\Projects\585\11203487\Digital_Design\1 - CAD\3.1.2 - Sheet\05b - Architectural\2022 11 18 Final\1372 48-A-030.dwg PLOTJOB: Monday, December 05, 2022 - 1:39pm USER: nsch


1ST FLOOR DOOR SCHEDULE - NOTE: EXTERIOR AND INTERIOR DOORS AND DOOR FRAMES MUST BE PAINTED TO MATCH ADJACENT WALL COLOR OR AS NOTED																							GENERAL DOOR AND FRAME NOTES									
DOOR NO.	DOOR						FRAME		HARDWARE	LABEL	REMARKS	DOOR NO.	DOOR						FRAME		HARDWARE	LABEL	REMARKS									
	WIDTH	HEIGHT	THICKNESS	MATERIAL	TYPE	GLASS	MATERIAL	DETAIL					WIDTH	HEIGHT	THICKNESS	MATERIAL	TYPE	GLASS	MATERIAL	DETAIL												
010A	6'-0"	7'-2"	1 3/4"	EXIST	EXIST	EXIST	EXIST	EXIST	EXIST	EXIST	EXISTING TO REMAIN	202B	3'-0"	7'-2"	1 3/4"	EXIST	EXIST	EXIST	EXIST	EXIST	EXIST	EXIST	EXIST	EXISTING TO REMAIN								
010B	6'-0"	7'-0"	1 3/4"	HM	E	TEMP	EXIST	A5/A032	4	-	PAIR OF 3'-0" X 7'-2" DOORS/LEVEL 4	202C	3'-0"	7'-2"	1 3/4"	EXIST	EXIST	EXIST	EXIST	EXIST	EXIST	EXIST	EXIST	EXISTING TO REMAIN								
011A	3'-0"	7'-2"	1 3/4"	EXIST	EXIST	EXIST	EXIST	EXIST	EXIST	EXIST	EXISTING TO REMAIN	203A	2'-8"	7'-2"	1 3/4"	EXIST	EXIST	EXIST	EXIST	EXIST	EXIST	EXIST	EXIST	EXISTING TO REMAIN								
011B	3'-0"	7'-2"	1 3/4"	EXIST	EXIST	EXIST	EXIST	EXIST	EXIST	EXIST	EXISTING TO REMAIN	204A	3'-0"	7'-2"	1 3/4"	EXIST	EXIST	EXIST	EXIST	EXIST	EXIST	EXIST	EXIST	EXISTING TO REMAIN								
012A	6'-0"	7'-2"	1 3/4"	EXIST	EXIST	EXIST	EXIST	EXIST	EXIST	EXIST	EXISTING TO REMAIN	204B	3'-0"	7'-2"	1 3/4"	EXIST	EXIST	EXIST	EXIST	EXIST	EXIST	EXIST	EXIST	EXISTING TO REMAIN								
012B	6'-0"	7'-2"	1 3/4"	HM	E	TEMP	EXIST	A5/A032	4	-	PAIR OF 3'-0" X 7'-2" DOORS/LEVEL 4	205A	3'-0"	7'-2"	1 3/4"	EXIST	VAULT	-	EXIST	EXIST	EXIST	EXIST	EXIST	EXISTING VAULT DOOR TO REMAIN								
020A	6'-0"	7'-2"	1 3/4"	EXIST	EXIST	EXIST	EXIST	EXIST	EXIST	EXIST	EXISTING TO REMAIN	207A	3'-0"	7'-2"	1 3/4"	EXIST	EXIST	EXIST	EXIST	EXIST	EXIST	EXIST	EXIST	EXISTING TO REMAIN								
020B	6'-0"	7'-2"	1 3/4"	HM	E	TEMP	EXIST	A5/A032	4	-	PAIR OF 3'-0" X 7'-2" DOORS/LEVEL 4	207B	3'-0"	7'-2"	1 3/4"	EXIST	EXIST	EXIST	EXIST	EXIST	EXIST	EXIST	EXIST	EXISTING TO REMAIN								
021A	3'-0"	7'-2"	1 3/4"	EXIST	EXIST	EXIST	EXIST	EXIST	EXIST	EXIST	EXISTING TO REMAIN	209A	3'-0"	7'-2"	1 3/4"	EXIST	EXIST	EXIST	EXIST	EXIST	EXIST	EXIST	EXIST	EXISTING TO REMAIN								
021B	3'-0"	7'-2"	1 3/4"	EXIST	EXIST	EXIST	EXIST	EXIST	EXIST	EXIST	EXISTING TO REMAIN	209B	3'-0"	7'-2"	1 3/4"	EXIST	EXIST	EXIST	EXIST	EXIST	EXIST	EXIST	EXIST	EXISTING TO REMAIN								
022A	6'-0"	7'-2"	1 3/4"	EXIST	EXIST	EXIST	EXIST	EXIST	EXIST	EXIST	EXISTING TO REMAIN	209C	3'-0"	7'-2"	1 3/4"	EXIST	EXIST	EXIST	EXIST	EXIST	REMARKS	EXIST	EXISTING TO REMAIN / REPLACE KICKPLATE									
022B	6'-0"	7'-2"	1 3/4"	HM	E	TEMP	EXIST	A5/A032	4	-	PAIR OF 3'-0" X 7'-2" DOORS/LEVEL 4	209D	3'-0"	7'-2"	1 3/4"	EXIST	EXIST	EXIST	EXIST	EXIST	REMARKS	EXIST	EXISTING TO REMAIN / REPLACE KICKPLATE									
030A	6'-0"	7'-2"	1 3/4"	HM	E	TEMP	EXIST	A3/A032	5	1 HR	PAIR OF 3'-0" X 7'-2" DOORS/LEVEL 3	210A	6'-0"	7'-2"	1 3/4"	EXIST	EXIST	EXIST	EXIST	EXIST	EXIST	EXIST	EXIST	EXISTING TO REMAIN								
030B	6'-0"	7'-2"	1 3/4"	HM	E	TEMP	EXIST	A5/A032	4	-	PAIR OF 3'-0" X 7'-2" DOORS/LEVEL 4	210B	3'-0"	7'-2"	1 3/4"	EXIST	EXIST	EXIST	EXIST	EXIST	EXIST	EXIST	EXIST	EXISTING TO REMAIN								
031A	3'-0"	7'-2"	1 3/4"	EXIST	EXIST	EXIST	EXIST	EXIST	REMARKS	EXIST	EXISTING TO REMAIN / REPLACE LOCK AND LATCH	211A	5'-0"	7'-2"	1 3/4"	EXIST	EXIST	EXIST	EXIST	EXIST	EXIST	EXIST	EXIST	EXISTING TO REMAIN								
031B	3'-0"	7'-2"	1 3/4"	EXIST	EXIST	EXIST	EXIST	EXIST	EXIST	EXIST	EXISTING TO REMAIN	212A	7'-0"	7'-2"	1 3/4"	HM	F	-	EXIST	A5/A032	3	-	PAIR OF 3'-6" X 7'-2" DOORS/LOUVERS/LEVEL 4									
032A	6'-0"	7'-2"	1 3/4"	HM	E	TEMP	EXIST	A3/A032	5	1 HR	PAIR OF 3'-0" X 7'-2" DOORS/FRAME TO REMAIN/LEVEL 3	213A	3'-0"	7'-2"	1 3/4"	EXIST	EXIST	EXIST	EXIST	EXIST	REMARKS	EXIST	EXISTING TO REMAIN / REPLACE KICKPLATE									
032B	6'-0"	7'-2"	1 3/4"	HM	E	TEMP	EXIST	A3/A032	4	-	PAIR OF 3'-0" X 7'-2" DOORS/LEVEL 4	213B	5'-0"	7'-2"	1 3/4"	HM	D	-	EXIST	A5/A032	3	-	PAIR OF 2'-6" X 7'-2" DOORS/LEVEL 4									
051A	3'-0"	7'-2"	1 3/4"	EXIST	EXIST	EXIST	EXIST	EXIST	EXIST	EXIST	EXISTING TO REMAIN	214A	3'-0"	7'-2"	1 3/4"	EXIST	EXIST	EXIST	EXIST	EXIST	EXIST	EXIST	EXIST	EXISTING TO REMAIN								
051B	3'-0"	7'-2"	1 3/4"	EXIST	EXIST	EXIST	EXIST	EXIST	REMARKS	EXIST	EXISTING TO REMAIN / REPLACE LOCK AND LATCH	215A	3'-0"	7'-2"	1 3/4"	EXIST	EXIST	EXIST	EXIST	EXIST	EXIST	EXIST	EXIST	EXISTING TO REMAIN								
052A	3'-0"	7'-2"	1 3/4"	EXIST	EXIST	EXIST	EXIST	EXIST	REMARKS	EXIST	EXISTING TO REMAIN / REPLACE DOOR CLOSER	216A	3'-0"	7'-2"	1 3/4"	EXIST	EXIST	EXIST	EXIST	EXIST	REMARKS	EXIST	EXISTING TO REMAIN / REPLACE KICKPLATE									
052B	3'-0"	7'-2"	1 3/4"	EXIST	EXIST	EXIST	EXIST	EXIST	EXIST	EXIST	EXISTING TO REMAIN	216B	3'-0"	7'-2"	1 3/4"	EXIST	EXIST	EXIST	EXIST	EXIST	REMARKS	EXIST	EXISTING / REPLACE DOOR CLOSER AND KICKPLATE									
053A	3'-0"	7'-2"	1 3/4"	EXIST	EXIST	EXIST	EXIST	EXIST	REMARKS	EXIST	EXISTING TO REMAIN / REPLACE LOCK AND LATCH	217A	2'-8"	7'-2"	1 3/4"	EXIST	EXIST	EXIST	EXIST	EXIST	EXIST	EXIST	EXIST	EXISTING TO REMAIN								
053B	3'-0"	7'-2"	1 3/4"	EXIST	EXIST	EXIST	EXIST	EXIST	EXIST	EXIST	EXISTING TO REMAIN	219A	2'-8"	7'-2"	1 3/4"	EXIST	EXIST	EXIST	EXIST	EXIST	REMARKS	EXIST	EXISTING TO REMAIN / REPLACE KICKPLATE									
100A	6'-0"	7'-2"	1 3/4"	HM	E	TEMP	EXIST	A5/A032	2	-	PAIR OF 3'-0" X 7'-2" DOORS/LEVEL 4	221A	2'-8"	7'-2"	1 3/4"	EXIST	EXIST	EXIST	EXIST	EXIST	EXIST	EXIST	EXIST	EXISTING TO REMAIN								
100B	3'-0"	7'-2"	1 3/4"	HM	B	TEMP	EXIST	A5/A032	1	-	LEVEL 4	221B	3'-0"	7'-2"	1 3/4"	EXIST	EXIST	EXIST	EXIST	EXIST	EXIST	EXIST	EXIST	EXISTING TO REMAIN								
100C	3'-0"	7'-2"	1 3/4"	HM	B	TEMP	EXIST	A5/A032	1	-	LEVEL 4	222A	3'-0"	7'-2"	1 3/4"	EXIST	EXIST	EXIST	EXIST	EXIST	EXIST	EXIST	EXIST	EXISTING TO REMAIN								
100D	6'-0"	7'-2"	1 3/4"	HM	E	TEMP	EXIST	A5/A032	2	-	PAIR OF 3'-0" X 7'-2" DOORS/LEVEL 4	223A	3'-0"	7'-2"	1 3/4"	EXIST	EXIST	EXIST	EXIST	EXIST	REMARKS	EXIST	EXISTING TO REMAIN / REPLACE KICKPLATE									
101A	8'-0"	9'-10"	1 3/4"	EXIST	EXIST	EXIST	EXIST	EXIST	EXIST	EXIST	EXISTING TO REMAIN / REPLACE DOOR CLOSER	224A	3'-0"	7'-2"	1 3/4"	EXIST	EXIST	EXIST	EXIST	EXIST	EXIST	EXIST	EXIST	EXISTING TO REMAIN								
101B	3'-0"	7'-2"	1 3/4"	EXIST	EXIST	EXIST	EXIST	EXIST	EXIST	EXIST	EXISTING TO REMAIN / REPLACE DOOR CLOSER	225A	10'-0"	9'-10"	1 3/4"	HM	D	-	EXIST	A5/A032	3	-	PAIR OF 5'-0" X 9'-10" DOORS/LEVEL 4									
101C	3'-0"	7'-2"	1 3/4"	EXIST	EXIST	EXIST	EXIST	EXIST	REMARKS	EXIST	EXISTING / REPLACE CYPHER LOCK, LATCH, KICKPLATE	225B	3'-0"	7'-2"	1 3/4"	HM	-	-	HM	A1/A032	7	-	LEVEL 2									
101D	6'-0"	7'-2"	1 3/4"	HM	D	-	EXIST	A5/A032	3	-	PAIR OF 3'-0" X 7'-2" DOORS/LEVEL 4	226A	6'-0"	7'-2"	1 3/4"	HM	D	-	EXIST	A5/A032	3	-	PAIR OF 3'-0" X 7'-2" DOORS/LEVEL 4									
102A	8'-0"	9'-10"	1 3/4"	EXIST	EXIST	EXIST	EXIST	EXIST	EXIST	EXIST	EXISTING TO REMAIN	227A	6'-0"	7'-2"	1 3/4"	HM	D	-	EXIST	A5/A032	3	-	PAIR OF 3'-0" X 7'-2" DOORS/LEVEL 4									
102B	3'-0"	7'-2"	1 3/4"	EXIST	EXIST	EXIST	EXIST	EXIST	EXIST	EXIST	EXISTING TO REMAIN	229A	5'-0"	7'-2"	1 3/4"	HM	D	-	EXIST	A5/A032	3	-	PAIR OF 2'-6" X 7'-2" DOORS/LEVEL 4									
102C	3'-0"	7'-2"	1 3/4"	EXIST	EXIST	EXIST	EXIST	EXIST	EXIST	EXIST	EXISTING TO REMAIN	301A	8'-0"	9'-10"	1 3/4"	EXIST	EXIST	EXIST	EXIST	EXIST	EXIST	EXIST	EXIST	EXISTING TO REMAIN								
103A	2'-8"																															



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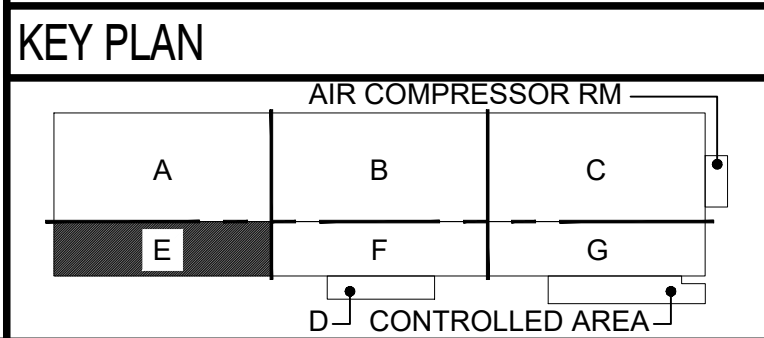
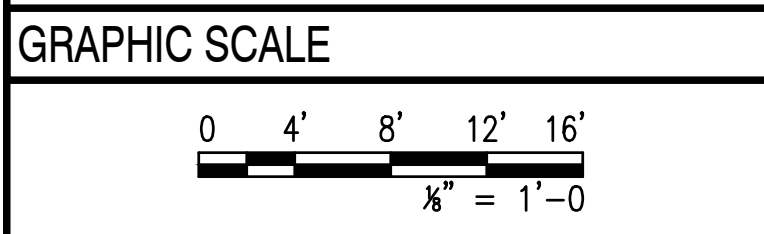

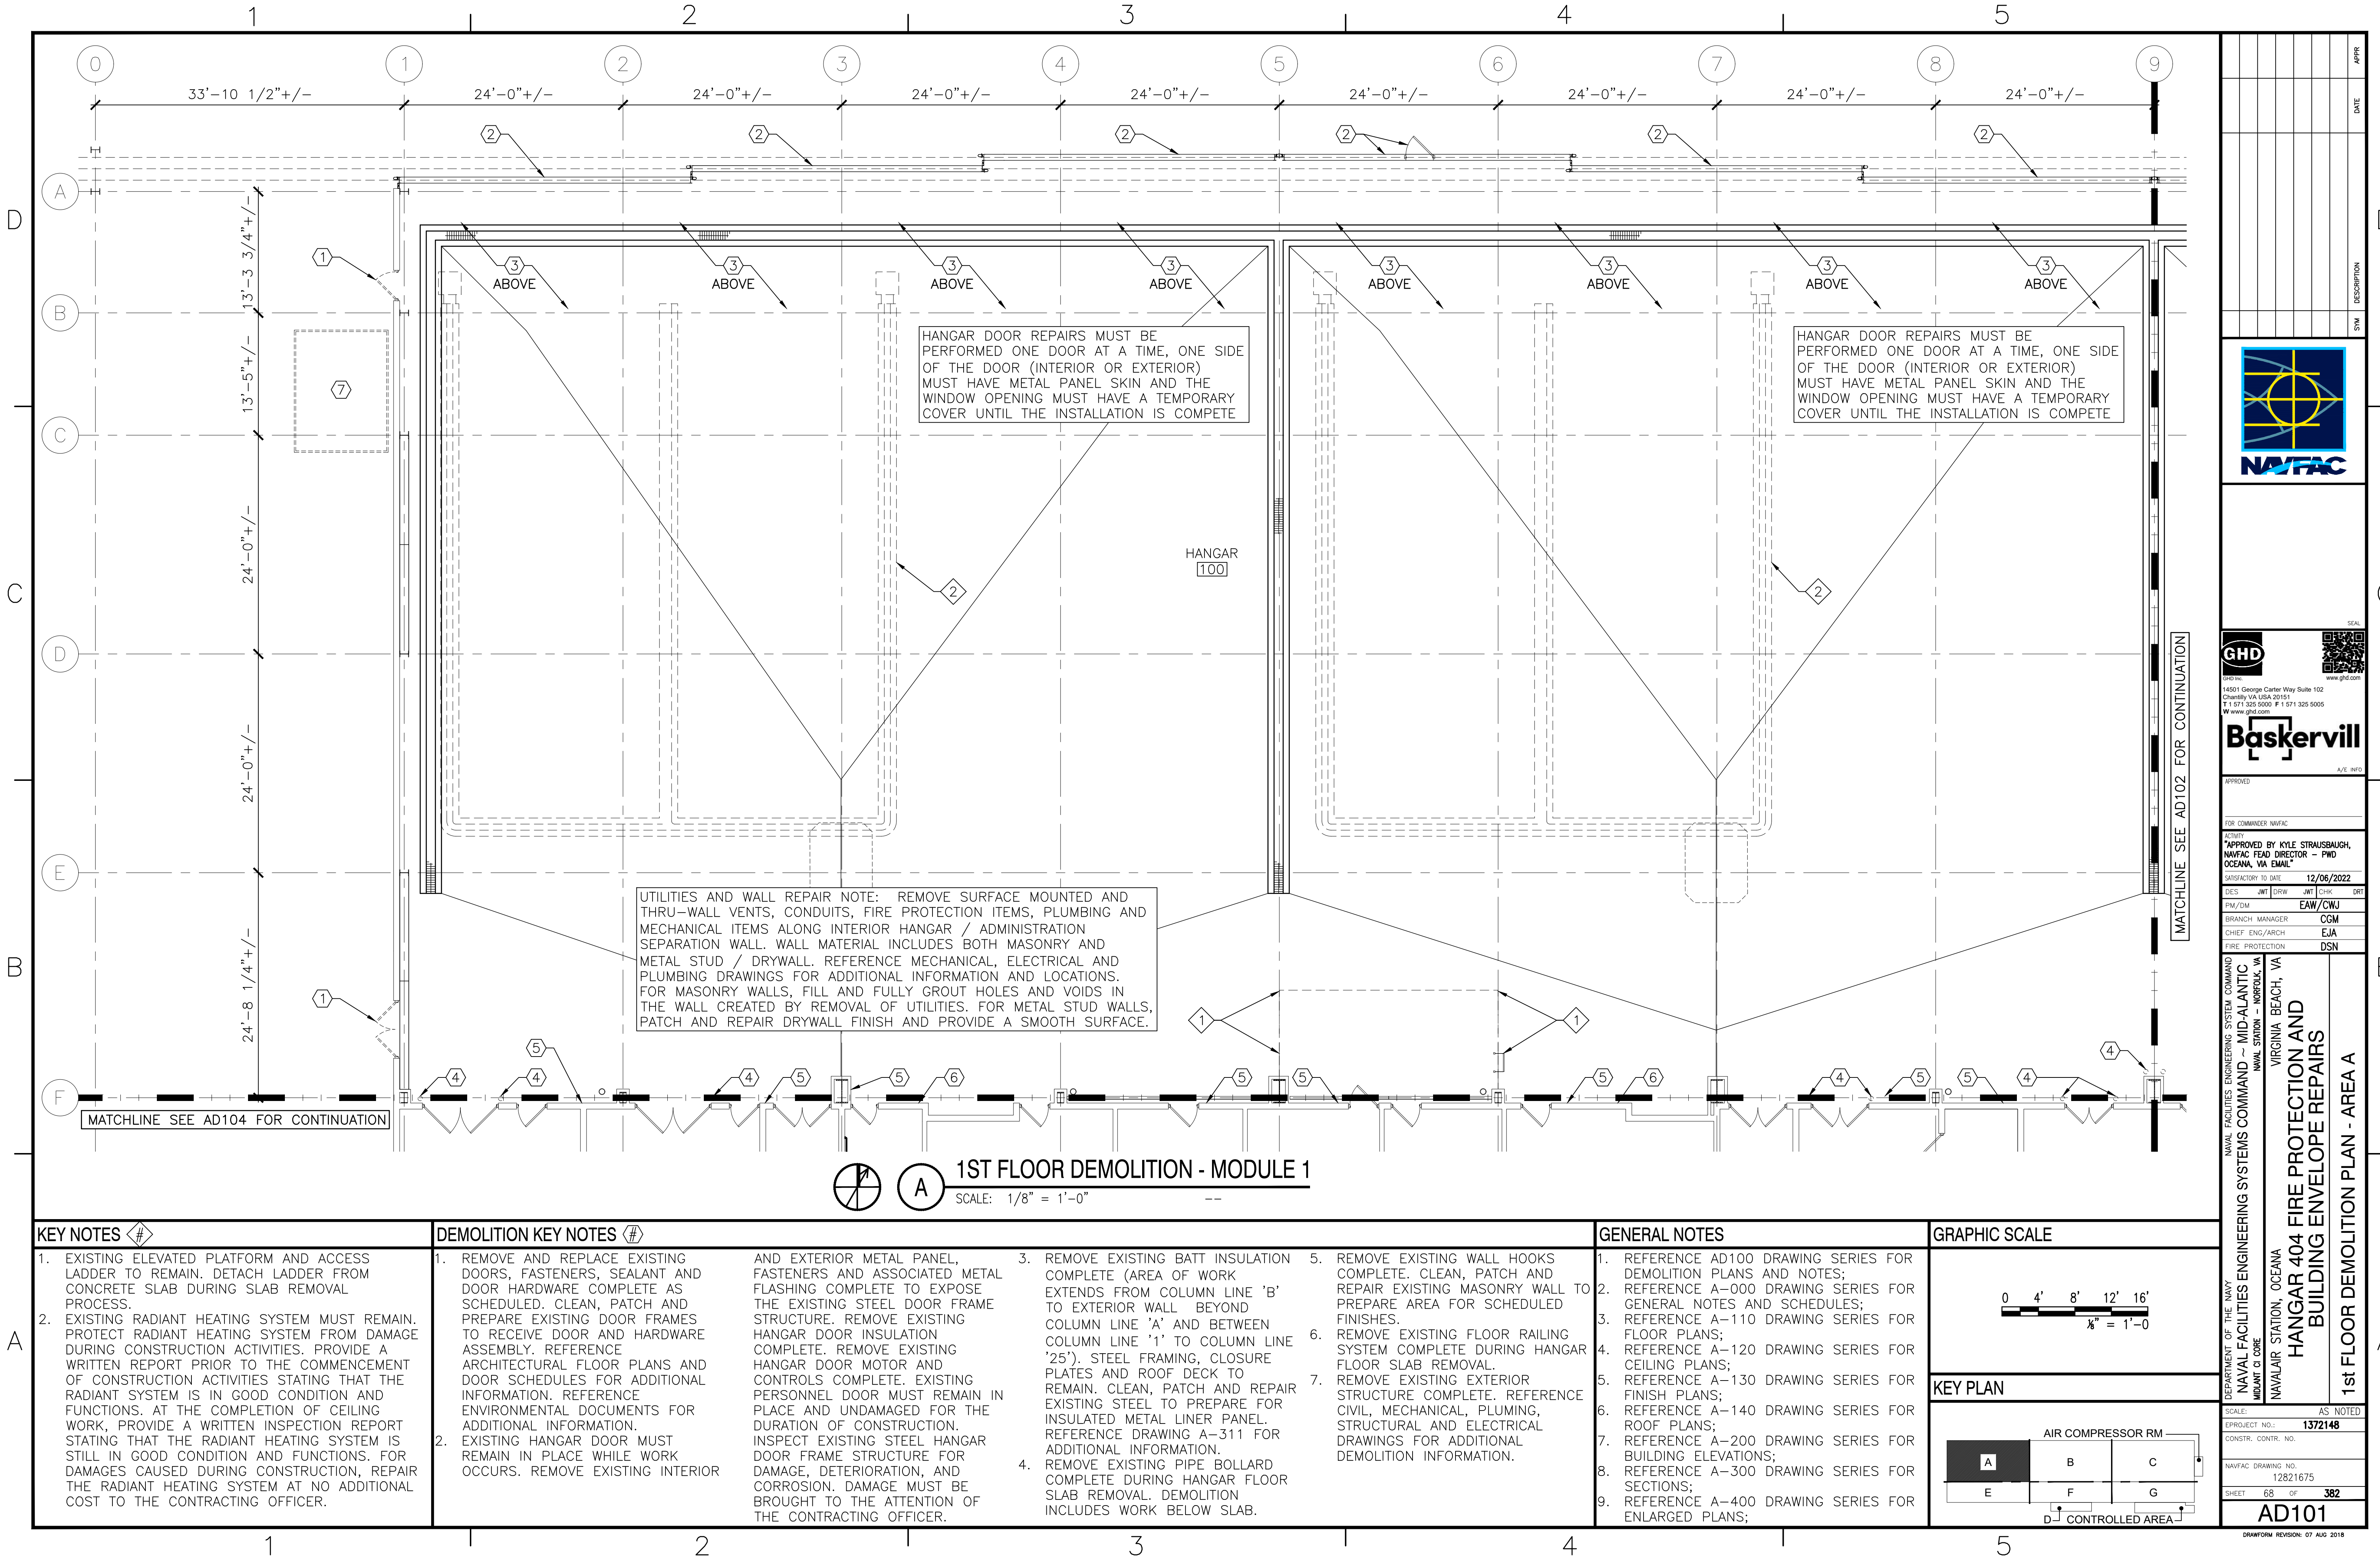
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EXISTING CANOPY NOTES	EXTERIOR WALL NOTES	DEMOLITION KEY NOTES (#)
REMOVE EXISTING CANOPY ROOF MEMBRANE, ROOF INSULATION, TAPERED CANTS, WOOD BLOCKING, FLASHING AT CMU WALL, ROOF DRAIN, DOWNSPOUT AND PERIMETER GRAVEL STOP COMPLETE. EXISTING STEEL TUBE FRAMING, STEEL ANGLES AND STEEL ROOF DECK MUST REMAIN. PROVIDE TAPERED INSULATION TO ACHIEVE THE SLOPE NEEDED TO DRAIN. ROOF MEMBRANE AND INSULATION MUST MATCH THAT OF THE HANGAR ROOF/OFFICE ROOFS. PROVIDE CONTINUOUS FLASHING AT THE CMU WALL AND PERIMETER OF CANOPY. PROVIDE ROOF DRAIN OF THE SAME SIZE AND LOCATION. PROVIDE DOWNSPOUT AS SHOWN. THE DOWNSPOUT MUST DAYLIGHT TO CONCRETE SPLASH BLOCK. CAP THE EXISTING CONNECTION TO THE UNDERGROUND SYSTEM.	<div>1. REMOVE SURFACE MOUNTED AND THRU-WALL VENTS, CONDUITS, FIRE PROTECTION ITEMS, PLUMBING AND MECHANICAL ITEMS ALONG EXTERIOR MASONRY WALLS. REFERENCE MECHANICAL, ELECTRICAL AND PLUMBING DRAWINGS FOR ADDITIONAL INFORMATION AND LOCATIONS. FILL AND FULLY GROUT HOLES AND VOIDS IN THE WALL CREATED BY REMOVAL OF UTILITIES; REMOVE EXISTING WALL FURRING ALONG COLUMN LINE 'H' COMPLETE INCLUDING BUT NOT LIMITED TO FINISH MATERIALS AND STUDS TO EXPOSE EXISTING MASONRY WALL. PATCH AND REPAIR FLOORS AND WALLS AND PREPARE AREA TO RECEIVE FINISHES.</div> <div>2. CLEAN, PATCH AND REPAIR WALL AREAS BEHIND EXISTING STEEL COLUMNS ALONG COLUMN LINE 'H' TO EXTENT POSSIBLE.</div>	<div>1. REMOVE AND REPLACE EXISTING DOORS, FASTENERS, SEALANT AND DOOR HARDWARE COMPLETE AS SCHEDULED. CLEAN, PATCH AND PREPARE EXISTING DOOR FRAMES TO RECEIVE DOOR AND HARDWARE ASSEMBLY. REFERENCE ARCHITECTURAL FLOOR PLANS AND DOOR SCHEDULES FOR ADDITIONAL INFORMATION. REFERENCE ENVIRONMENTAL DOCUMENTS FOR ADDITIONAL INFORMATION.</div> <div>2. REMOVE EXISTING CONCRETE SLAB ON GRADE TO EXPOSE EXISTING UNDERGROUND SANITARY LINE FOR REPLACEMENT. REFERENCE PLUMBING DRAWINGS FOR ROUTING AND STRUCTURAL DRAWINGS FOR SLAB DETAILS. THE AREAS OF WORK ARE DENOTED PER THE FOLLOWING MARKING;</div> <div>3. REMOVE PLUMBING FIXTURE COMPLETE. PREPARE AREA TO RECEIVE PLUMBING FIXTURE. REFERENCE PLUMBING DRAWINGS FOR PLUMBING FIXTURE SCHEDULE.</div> <div>4. REMOVE TOILET PARTITIONS, URINAL SCREENS AND TOILET ACCESSORIES COMPLETE INCLUDING BUT NOT LIMITED TO PAPER TOWEL DISPENSERS, SOAP DISPENSERS, TOILET PAPER DISPENSERS AND GRAB BARS. PATCH AND REPAIR MASONRY WALLS TO RECEIVE FINISHES AND PARTITIONS, URINAL SCREENS AND TOILET ACCESSORIES.</div> <div>5. REMOVE EXISTING FINISH FLOOR AND WALL MATERIALS COMPLETE. PATCH AND REPAIR CONCRETE FLOORS AND MASONRY WALLS. PREPARE AREAS TO RECEIVE FINISHES.</div> <div>6. REMOVE EXISTING SHOWER HEAD, FIXTURES AND CONTROLS COMPLETE. PREPARE AREA TO RECEIVE SHOWER HEADS, FIXTURES AND CONTROLS.</div> <div>7. REMOVE EXISTING COUNTERTOP, MILLWORK PANELS AND SUPPORTS COMPLETE. PATCH AND REPAIR MASONRY WALLS TO RECEIVE COUNTERTOPS, PANELS AND SUPPORTS.</div> <div>8. REMOVE EXISTING THRU-WALL MECHANICAL UNIT AND INFILL OPENING WITH MASONRY OF SAME SIZE (8-INCH CMU) TO PROVIDE A FLAT SURFACE. ALIGN FINISHED SURFACE WITH EXISTING ADJACENT SURFACE AND PREPARE AREA TO RECEIVE FINISHES;</div> <div>9. REMOVE EXISTING THRU-WALL MECHANICAL UNIT AND PREPARED OPENING TO RECEIVE WINDOW AS SHEDULED.</div> <div>10. REMOVE EXISTING WALL FURRING COMPLETE. REFERENCE EXTERIOR WALL NOTES ON THIS DRAWING FOR ADDITIONAL INFORMATIONAL.</div>

- GENERAL NOTES**
- REFERENCE AD100 DRAWING SERIES FOR DEMOLITION PLANS AND NOTES;
 - REFERENCE A-000 DRAWING SERIES FOR GENERAL NOTES AND SCHEDULES;
 - REFERENCE A-110 DRAWING SERIES FOR FLOOR PLANS;
 - REFERENCE A-120 DRAWING SERIES FOR CEILING PLANS;
 - REFERENCE A-130 DRAWING SERIES FOR FINISH PLANS;
 - REFERENCE A-140 DRAWING SERIES FOR ROOF PLANS;
 - REFERENCE A-200 DRAWING SERIES FOR BUILDING ELEVATIONS;
 - REFERENCE A-300 DRAWING SERIES FOR SECTIONS;
 - REFERENCE A-400 DRAWING SERIES FOR ENLARGED PLANS;

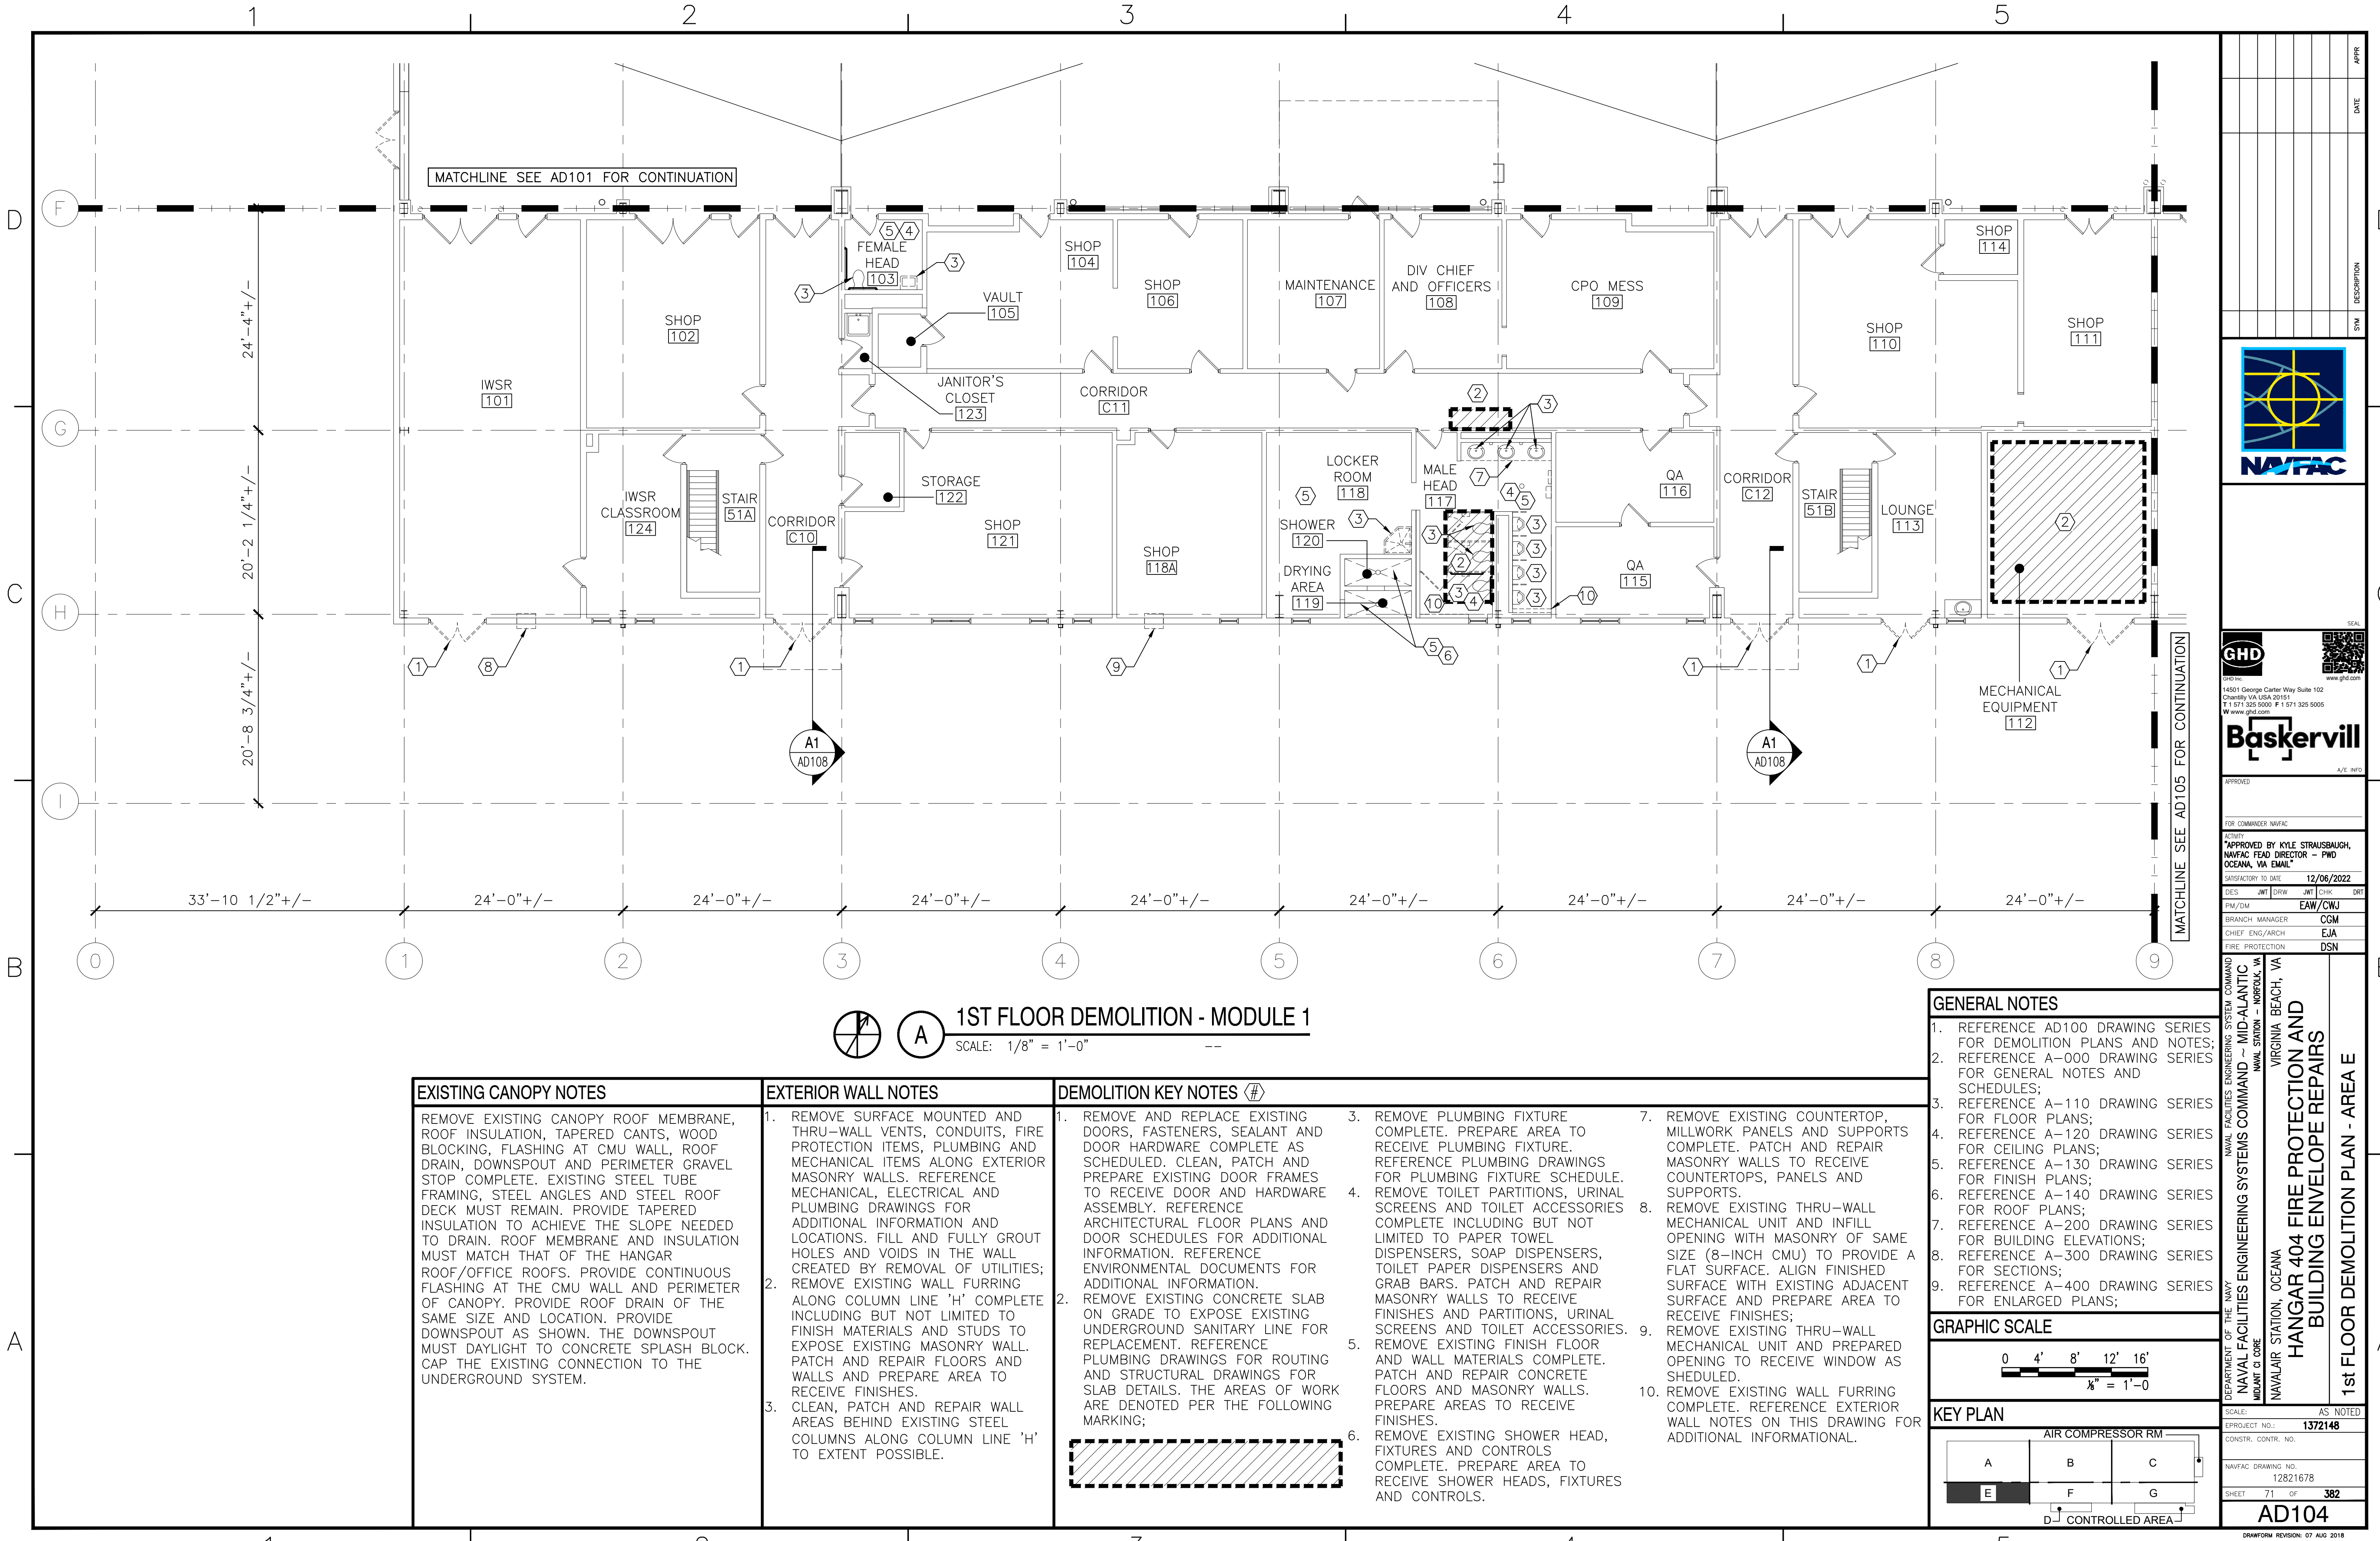

APPR

DATE

DESCRIPTION

SYM

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A/E 10/20

APPROVED

FOR COMMANDER NAVFAC

APPROVED BY KYLE STRAUSBAUGH,
NAVFAC HEAD DIRECTOR - PWD
OCEANA, VA EMAIL

SATISFACTORY TO DATE 12/06/2022

DES JMT DRW JMT CHK DRT

PM/DM EAW/CWJ

BRANCH MANAGER CGM

CHIEF ENG/ARCH EJA

FIRE PROTECTION DSN

NAVFAC FACILITIES ENGINEERING SYSTEMS COMMAND ~ MID-ATLANTIC
NAVAL STATION - NORFOLK, VA
VIRGINIA BEACH, VA

DEPARTMENT OF THE NAVY
NAVFAC FACILITIES ENGINEERING SYSTEMS COMMAND
NAVAL STATION - NORFOLK, VA

NAVFAC DRAWING NO. 12821678

SHEET 71 OF 382


AD104

DRAWING REVISION: 07 AUG 2018

HANGAR 404 FIRE PROTECTION AND BUILDING ENVELOPE REPAIRS

1st FLOOR DEMOLITION PLAN - AREA E



FILE NAME: \\gdrnet\gnd\US\Chantilly\Projects\5485\11203487\Digital_Design\1 - CAD\3.1.2 - Sheet\05b - Architectural\2022 11 18 Final\1372148-AD105.dwg LAYOUT NAME: Layout1 PLOTTED: Monday, December 05, 2022 - 1:40pm USER: msash

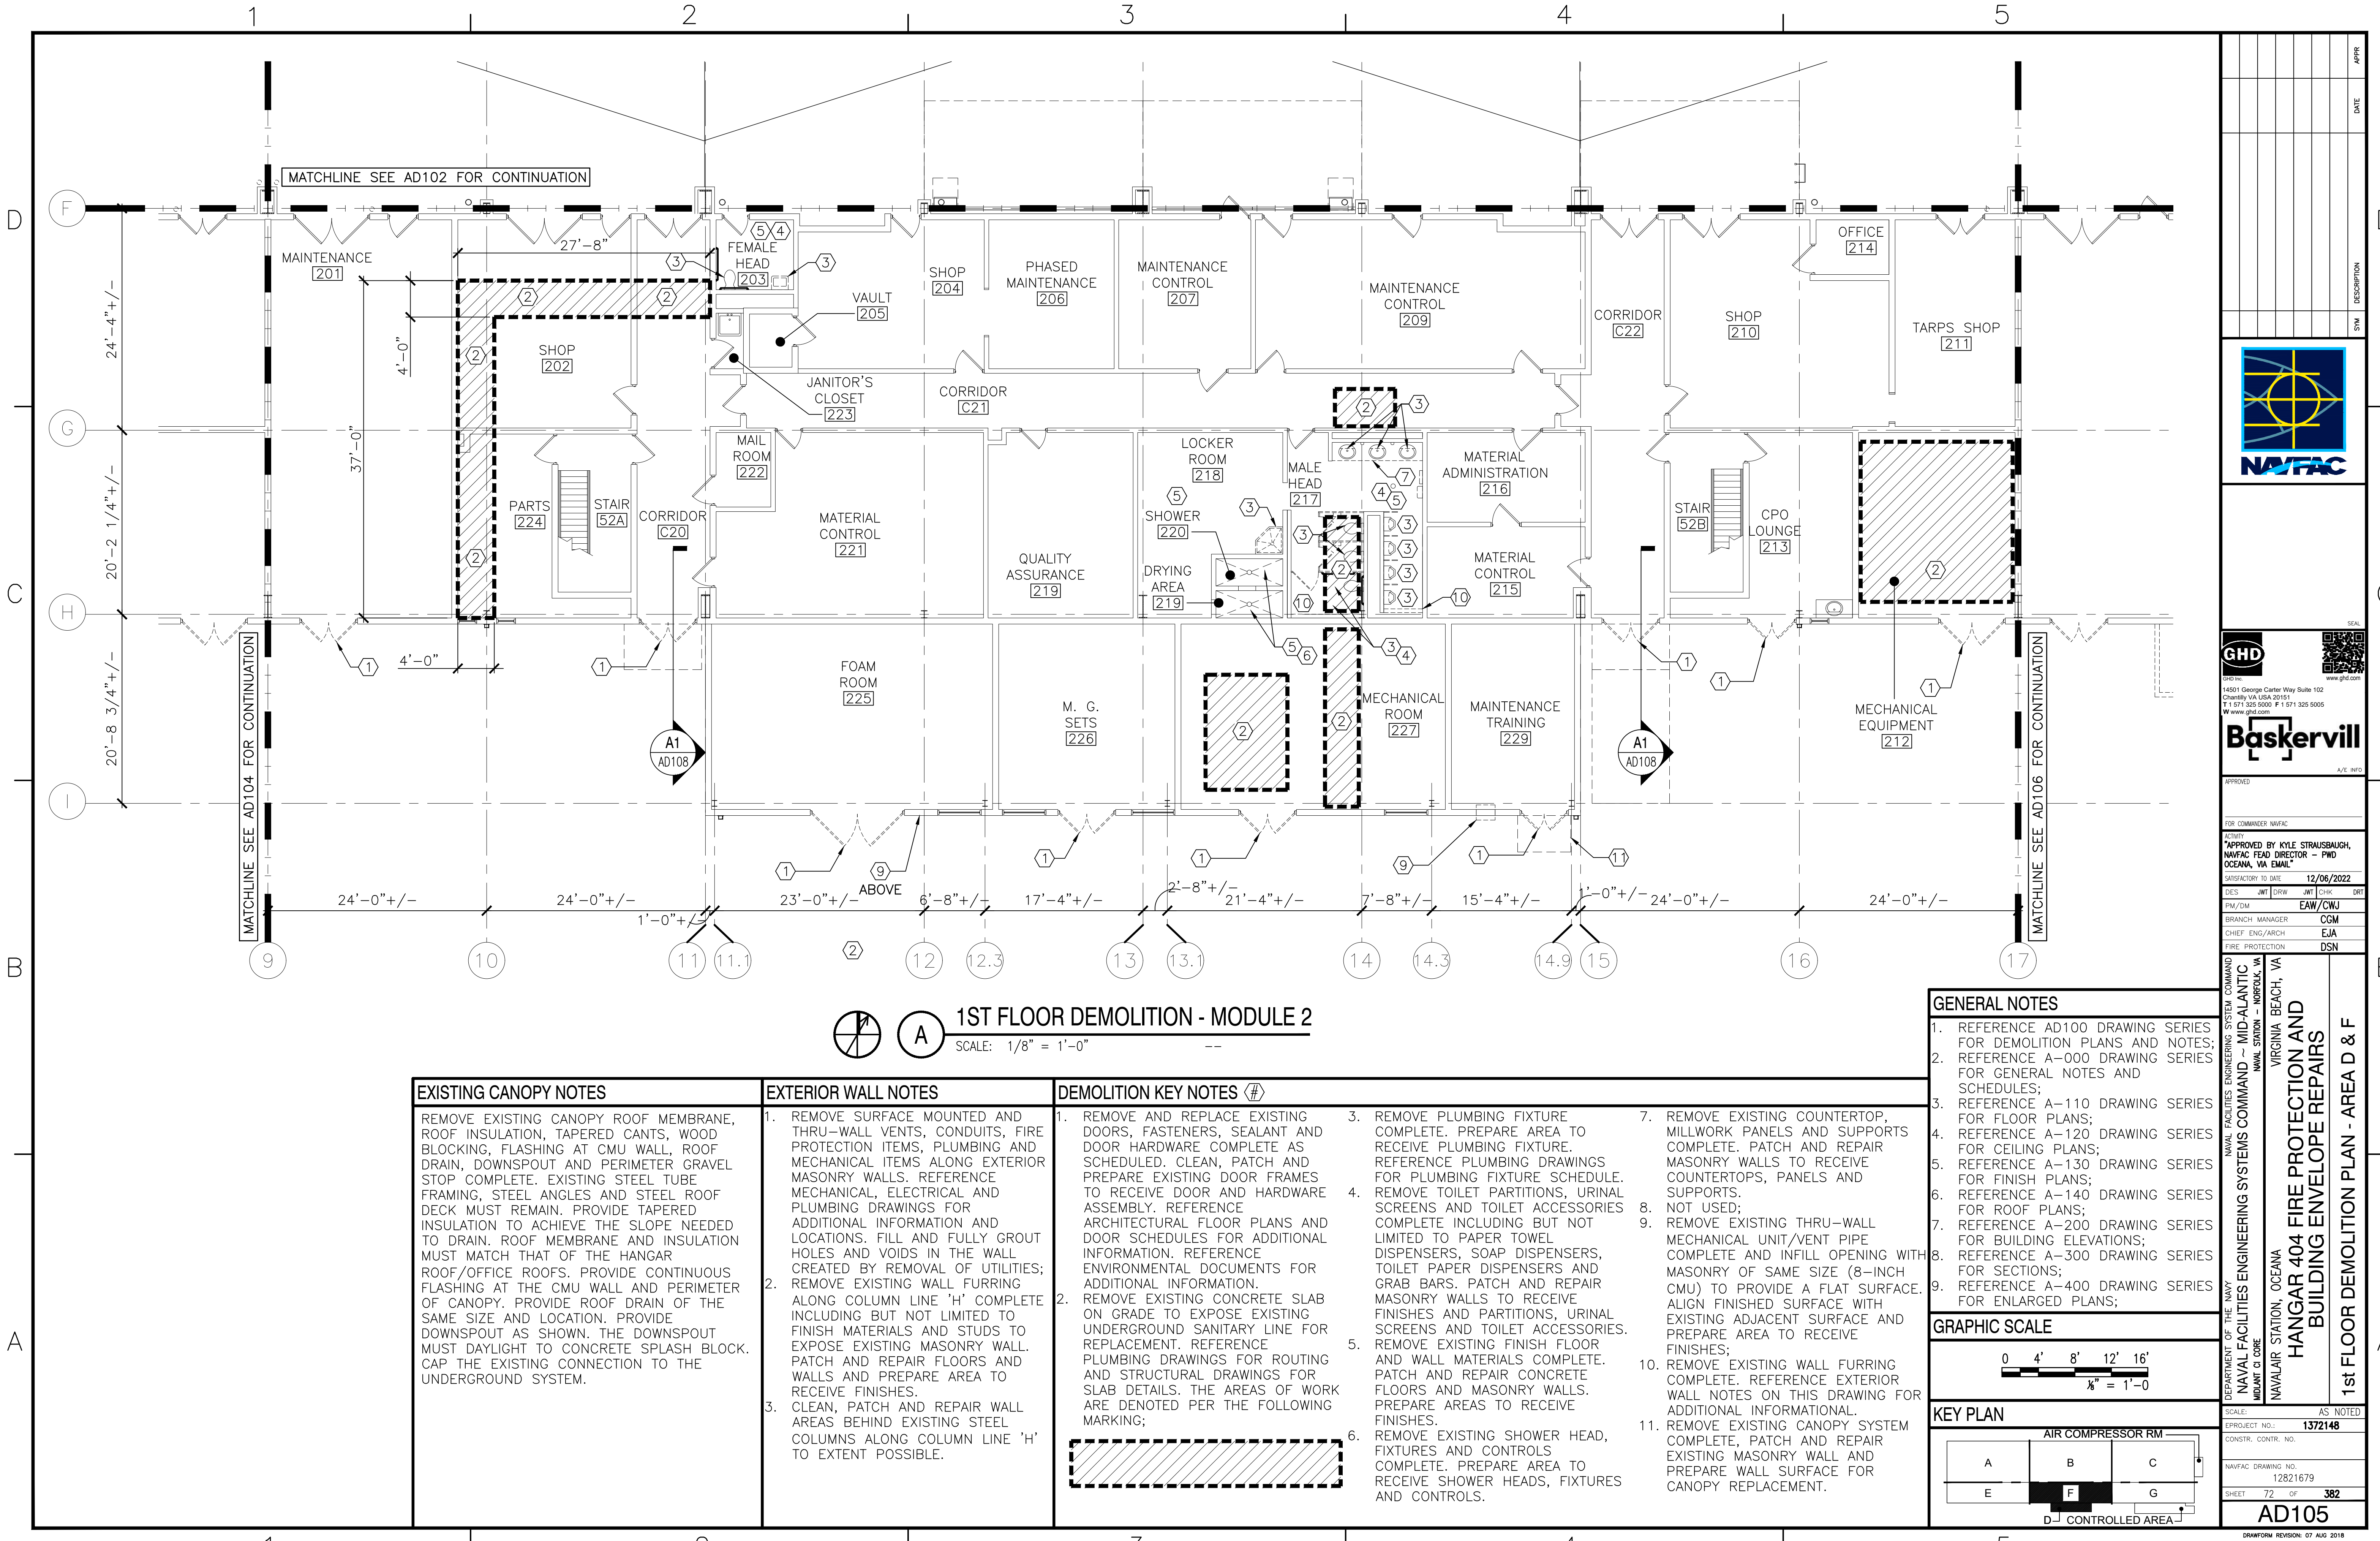

1ST FLOOR DEMOLITION - MODULE 2
SCALE: 1/8" = 1'-0"

EXISTING CANOPY NOTES	EXTERIOR WALL NOTES	DEMOLITION KEY NOTES (#)
REMOVE EXISTING CANOPY ROOF MEMBRANE, ROOF INSULATION, TAPERED CANTS, WOOD BLOCKING, FLASHING AT CMU WALL, ROOF DRAIN, DOWNSPOUT AND PERIMETER GRAVEL STOP COMPLETE. EXISTING STEEL TUBE FRAMING, STEEL ANGLES AND STEEL ROOF DECK MUST REMAIN. PROVIDE TAPERED INSULATION TO ACHIEVE THE SLOPE NEEDED TO DRAIN. ROOF MEMBRANE AND INSULATION MUST MATCH THAT OF THE HANGAR ROOF/OFFICE ROOFS. PROVIDE CONTINUOUS FLASHING AT THE CMU WALL AND PERIMETER OF CANOPY. PROVIDE ROOF DRAIN OF THE SAME SIZE AND LOCATION. PROVIDE DOWNSPOUT AS SHOWN. THE DOWNSPOUT MUST DAYLIGHT TO CONCRETE SPLASH BLOCK. CAP THE EXISTING CONNECTION TO THE UNDERGROUND SYSTEM.	1. REMOVE SURFACE MOUNTED AND THRU-WALL VENTS, CONDUITS, FIRE PROTECTION ITEMS, PLUMBING AND MECHANICAL ITEMS ALONG EXTERIOR MASONRY WALLS. REFERENCE MECHANICAL, ELECTRICAL AND PLUMBING DRAWINGS FOR ADDITIONAL INFORMATION AND LOCATIONS. FILL AND FULLY GROUT HOLES AND VOIDS IN THE WALL CREATED BY REMOVAL OF UTILITIES; REMOVE EXISTING WALL FURRING ALONG COLUMN LINE 'H' COMPLETE INCLUDING BUT NOT LIMITED TO FINISH MATERIALS AND STUDS TO EXPOSE EXISTING MASONRY WALL. PATCH AND REPAIR FLOORS AND WALLS AND PREPARE AREA TO RECEIVE FINISHES. 2. CLEAN, PATCH AND REPAIR WALL AREAS BEHIND EXISTING STEEL COLUMNS ALONG COLUMN LINE 'H' TO EXTENT POSSIBLE.	1. REMOVE AND REPLACE EXISTING DOORS, FASTENERS, SEALANT AND DOOR HARDWARE COMPLETE AS SCHEDULED. CLEAN, PATCH AND PREPARE EXISTING DOOR FRAMES TO RECEIVE DOOR AND HARDWARE ASSEMBLY. REFERENCE ARCHITECTURAL FLOOR PLANS AND DOOR SCHEDULES FOR ADDITIONAL INFORMATION. REFERENCE ENVIRONMENTAL DOCUMENTS FOR ADDITIONAL INFORMATION. 2. REMOVE EXISTING CONCRETE SLAB ON GRADE TO EXPOSE EXISTING UNDERGROUND SANITARY LINE FOR REPLACEMENT. REFERENCE PLUMBING DRAWINGS FOR ROUTING AND STRUCTURAL DRAWINGS FOR SLAB DETAILS. THE AREAS OF WORK ARE DENOTED PER THE FOLLOWING MARKING; 3. REMOVE PLUMBING FIXTURE COMPLETE. PREPARE AREA TO RECEIVE PLUMBING FIXTURE. REFERENCE PLUMBING DRAWINGS FOR PLUMBING FIXTURE SCHEDULE. 4. REMOVE TOILET PARTITIONS, URINAL SCREENS AND TOILET ACCESSORIES COMPLETE INCLUDING BUT NOT LIMITED TO PAPER TOWEL DISPENSERS, SOAP DISPENSERS, TOILET PAPER DISPENSERS AND GRAB BARS. PATCH AND REPAIR MASONRY WALLS TO RECEIVE FINISHES AND PARTITIONS, URINAL SCREENS AND TOILET ACCESSORIES. 5. REMOVE EXISTING FINISH FLOOR AND WALL MATERIALS COMPLETE. PATCH AND REPAIR CONCRETE FLOORS AND MASONRY WALLS. PREPARE AREAS TO RECEIVE FINISHES. 6. REMOVE EXISTING SHOWER HEAD, FIXTURES AND CONTROLS COMPLETE. PREPARE AREA TO RECEIVE SHOWER HEADS, FIXTURES AND CONTROLS. 7. REMOVE EXISTING COUNTERTOP, MILLWORK PANELS AND SUPPORTS COMPLETE. PATCH AND REPAIR MASONRY WALLS TO RECEIVE COUNTERTOPS, PANELS AND SUPPORTS. 8. NOT USED; 9. REMOVE EXISTING THRU-WALL MECHANICAL UNIT/VENT PIPE COMPLETE AND INFILL OPENING WITH MASONRY OF SAME SIZE (8-INCH CMU) TO PROVIDE A FLAT SURFACE. ALIGN FINISHED SURFACE WITH EXISTING ADJACENT SURFACE AND PREPARE AREA TO RECEIVE FINISHES; 10. REMOVE EXISTING WALL FURRING COMPLETE. REFERENCE EXTERIOR WALL NOTES ON THIS DRAWING FOR ADDITIONAL INFORMATIONAL. 11. REMOVE EXISTING CANOPY SYSTEM COMPLETE, PATCH AND REPAIR EXISTING MASONRY WALL AND PREPARE WALL SURFACE FOR CANOPY REPLACEMENT.

- GENERAL NOTES**
- REFERENCE AD100 DRAWING SERIES FOR DEMOLITION PLANS AND NOTES;
 - REFERENCE A-000 DRAWING SERIES FOR GENERAL NOTES AND SCHEDULES;
 - REFERENCE A-110 DRAWING SERIES FOR FLOOR PLANS;
 - REFERENCE A-120 DRAWING SERIES FOR CEILING PLANS;
 - REFERENCE A-130 DRAWING SERIES FOR FINISH PLANS;
 - REFERENCE A-140 DRAWING SERIES FOR ROOF PLANS;
 - REFERENCE A-200 DRAWING SERIES FOR BUILDING ELEVATIONS;
 - REFERENCE A-300 DRAWING SERIES FOR SECTIONS;
 - REFERENCE A-400 DRAWING SERIES FOR ENLARGED PLANS;

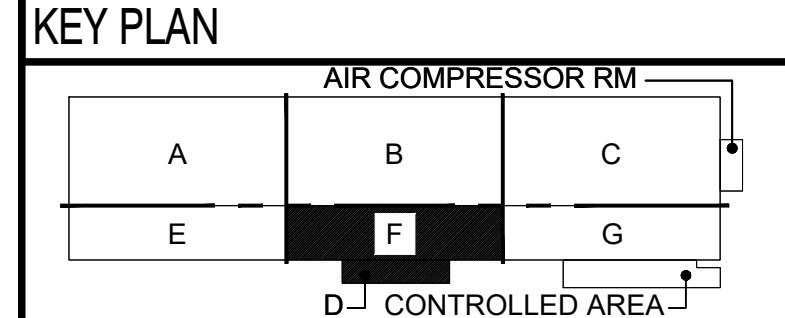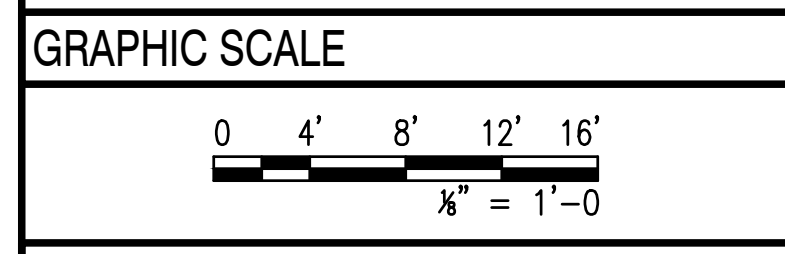

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Baskervill

APPROVED

FOR COMMANDER NAVFAC

*APPROVED BY KYLE STRAUSBAUGH,
NAVFAC HEAD DIRECTOR - PWD
OCEANA, VA EMAIL*

SATISFACTORY TO DATE: 12/06/2022

DES	JMT	DRW	JMT	CHK	DRT
PM/DM				EAW/CWJ	
BRANCH				CMG	
CHIEF				EJA	
FIRE PROTECTION				DSN	

DEPARTMENT OF THE NAVY
NAVFACILITIES ENGINEERING SYSTEMS COMMAND
NAVFAC STATION - OCEANA
VIRGINIA BEACH, VA


NAVFAC STATION - OCEANA
VIRGINIA BEACH, VA

HANGAR 404 FIRE PROTECTION AND
BUILDING ENVELOPE REPAIRS

1st FLOOR DEMOLITION PLAN - AREA D & F

SCALE: AS NOTED
PROJECT NO.: 1372148
CONSTR. CONTR. NO.
NAVFAC DRAWING NO.
12821679
SHEET 72 OF 382
AD105
DRAWING REVISION: 07 AUG 2018

FILE NAME: \\gdrna\gnd\US\Chantilly\Projects\5485\11203487\Digital_Design\1 - CAD\3.1.2 - Sheet\05b - Architectural\2022 11 18 Final\1372 48-AD106.dwg LAYOUT NAME: Layout1 PLOTED: Monday, December 05, 2022 - 1:40pm USER: nash

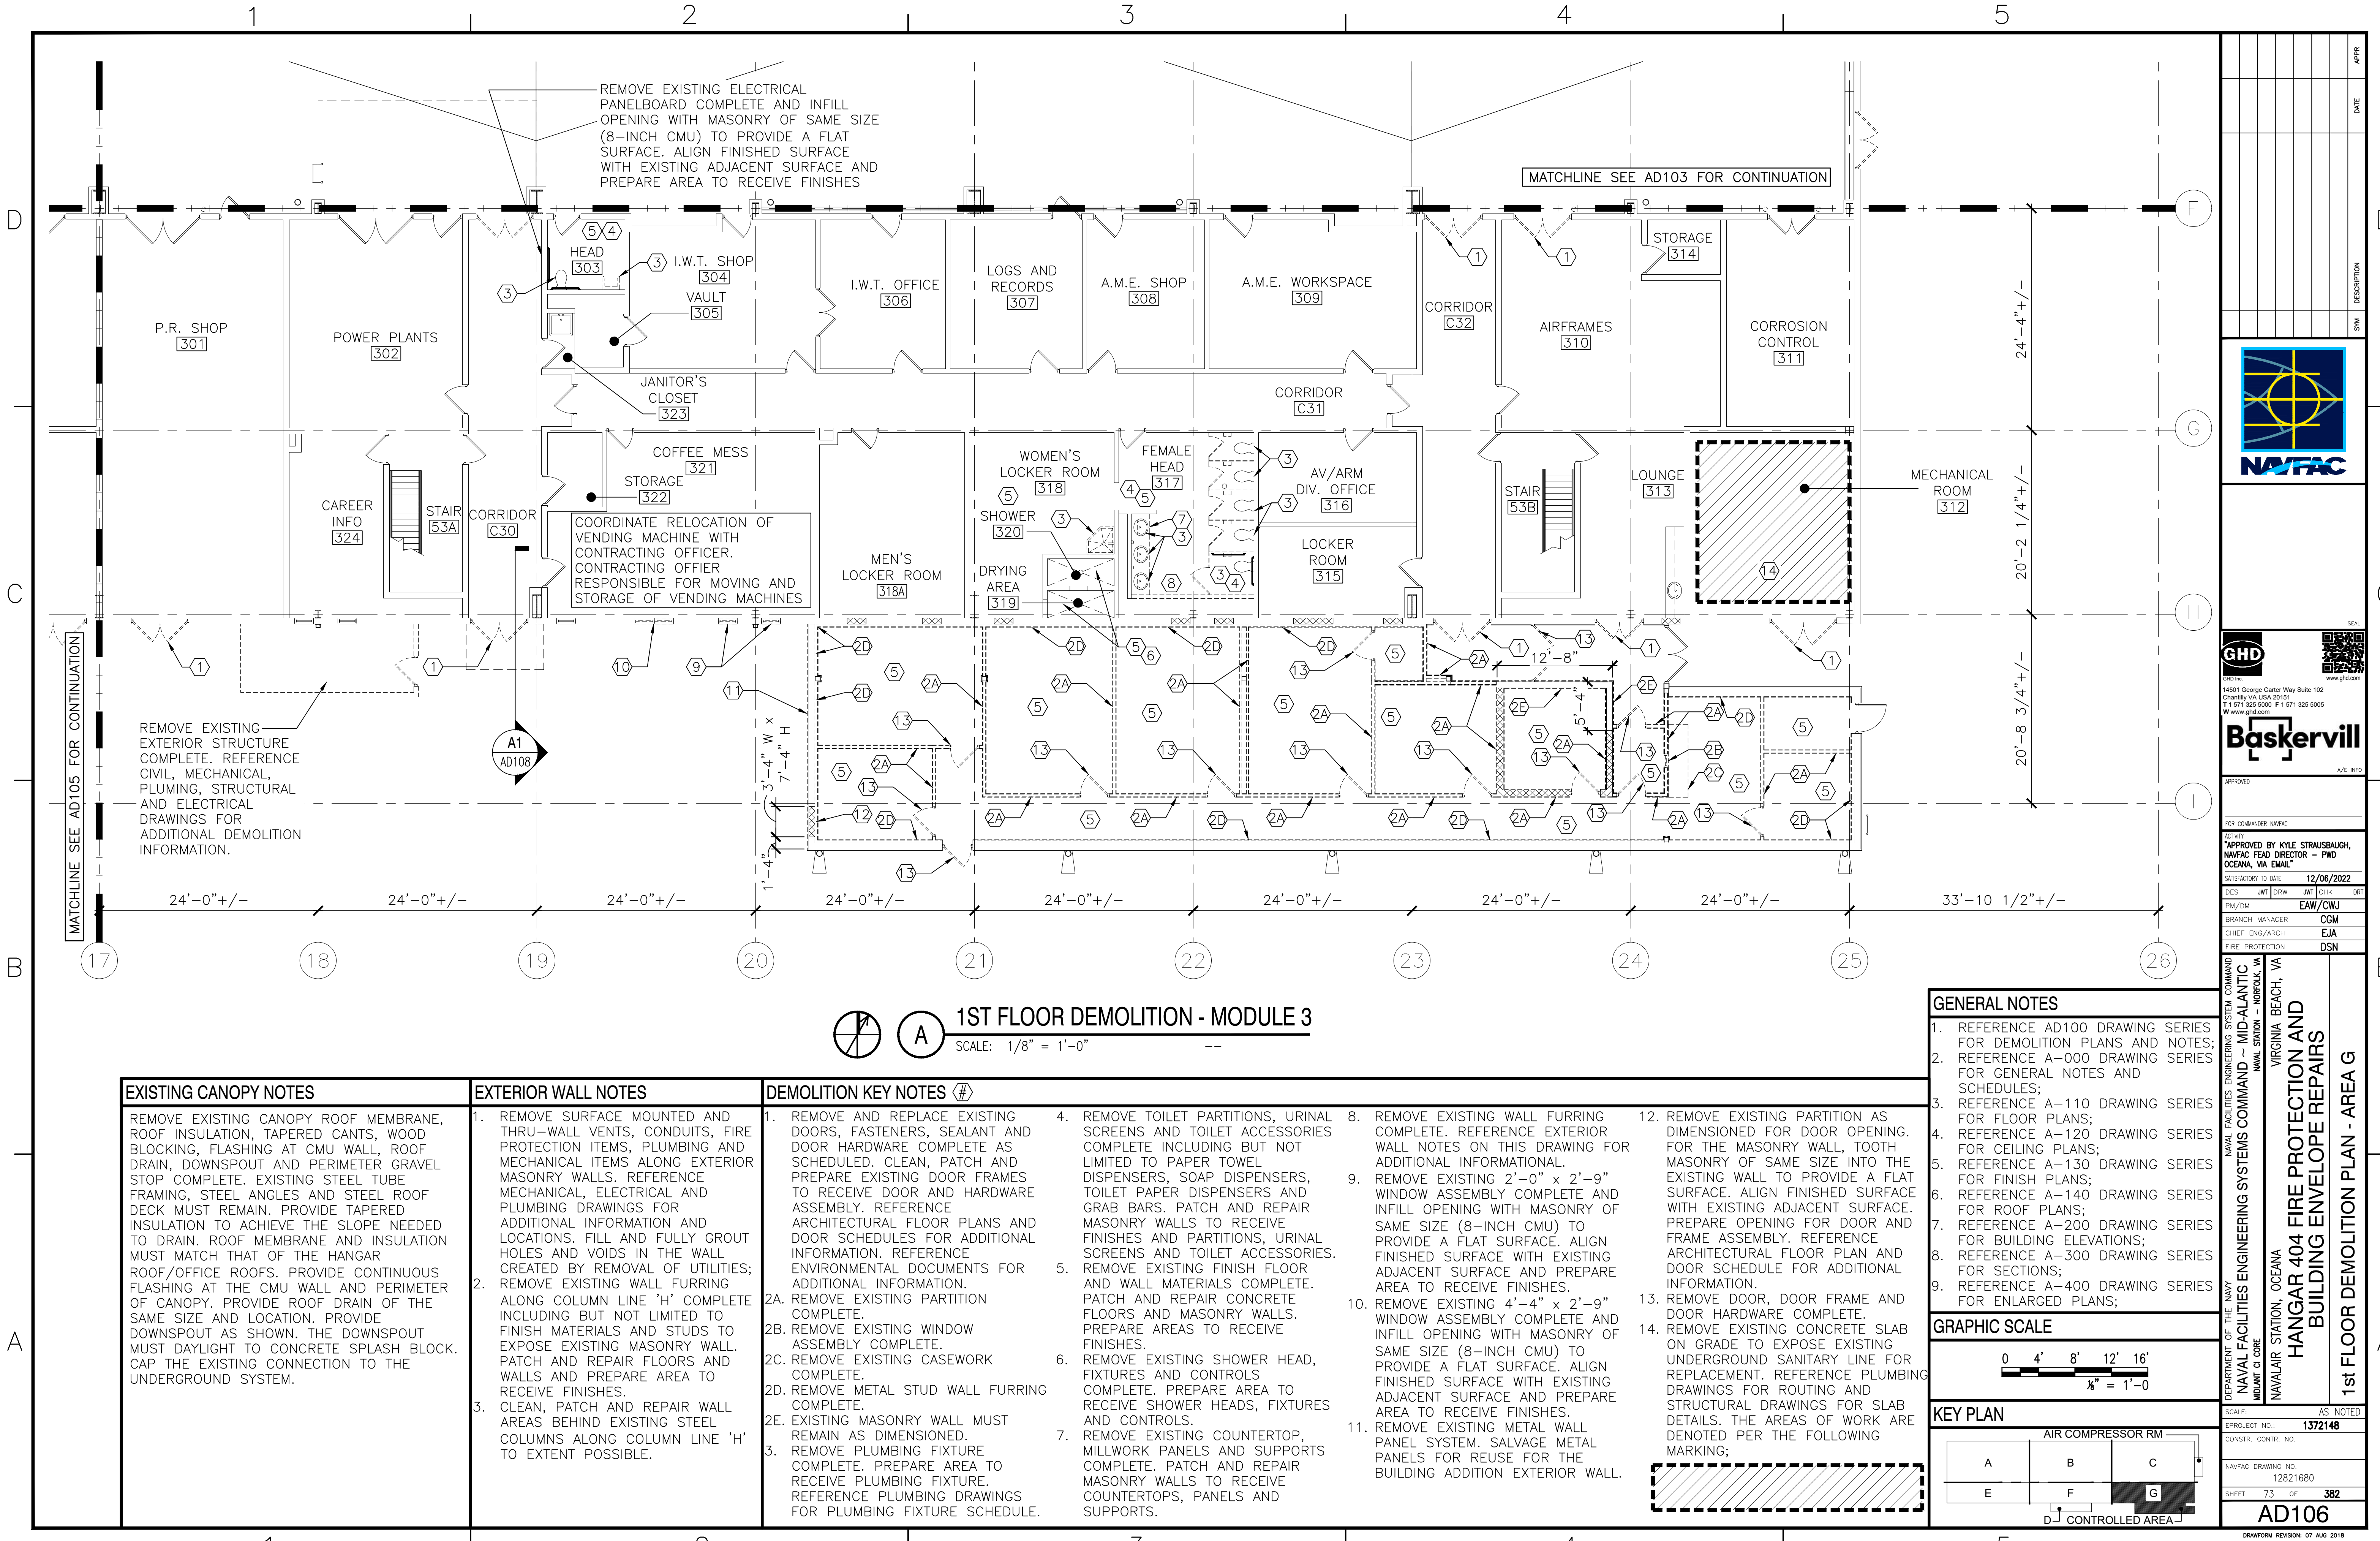

EXISTING CANOPY NOTES	EXTERIOR WALL NOTES	DEMOLITION KEY NOTES (#)
REMOVE EXISTING CANOPY ROOF MEMBRANE, ROOF INSULATION, TAPERED CANTS, WOOD BLOCKING, FLASHING AT CMU WALL, ROOF DRAIN, DOWNSPOUT AND PERIMETER GRAVEL STOP COMPLETE. EXISTING STEEL TUBE FRAMING, STEEL ANGLES AND STEEL ROOF DECK MUST REMAIN. PROVIDE TAPERED INSULATION TO ACHIEVE THE SLOPE NEEDED TO DRAIN. ROOF MEMBRANE AND INSULATION MUST MATCH THAT OF THE HANGAR ROOF/OFFICE ROOFS. PROVIDE CONTINUOUS FLASHING AT THE CMU WALL AND PERIMETER OF CANOPY. PROVIDE ROOF DRAIN OF THE SAME SIZE AND LOCATION. PROVIDE DOWNSPOUT AS SHOWN. THE DOWNSPOUT MUST DAYLIGHT TO CONCRETE SPLASH BLOCK. CAP THE EXISTING CONNECTION TO THE UNDERGROUND SYSTEM.	<div>1. REMOVE SURFACE MOUNTED AND THRU-WALL VENTS, CONDUITS, FIRE PROTECTION ITEMS, PLUMBING AND MECHANICAL ITEMS ALONG EXTERIOR MASONRY WALLS. REFERENCE MECHANICAL, ELECTRICAL AND PLUMBING DRAWINGS FOR ADDITIONAL INFORMATION AND LOCATIONS. FILL AND FULLY GROUT HOLES AND VOIDS IN THE WALL CREATED BY REMOVAL OF UTILITIES; REMOVE EXISTING WALL FURRING ALONG COLUMN LINE 'H' COMPLETE INCLUDING BUT NOT LIMITED TO FINISH MATERIALS AND STUDS TO EXPOSE EXISTING MASONRY WALL. PATCH AND REPAIR FLOORS AND WALLS AND PREPARE AREA TO RECEIVE FINISHES.</div> <div>2. CLEAN, PATCH AND REPAIR WALL AREAS BEHIND EXISTING STEEL COLUMNS ALONG COLUMN LINE 'H' TO EXTENT POSSIBLE.</div>	<div>1. REMOVE AND REPLACE EXISTING DOORS, FASTENERS, SEALANT AND DOOR HARDWARE COMPLETE AS SCHEDULED. CLEAN, PATCH AND PREPARE EXISTING DOOR FRAMES TO RECEIVE DOOR AND HARDWARE ASSEMBLY. REFERENCE ARCHITECTURAL FLOOR PLANS AND DOOR SCHEDULES FOR ADDITIONAL INFORMATION. REFERENCE ENVIRONMENTAL DOCUMENTS FOR ADDITIONAL INFORMATION.</div> <div>2A. REMOVE EXISTING PARTITION COMPLETE.</div> <div>2B. REMOVE EXISTING WINDOW ASSEMBLY COMPLETE.</div> <div>2C. REMOVE EXISTING CASEWORK COMPLETE.</div> <div>2D. REMOVE METAL STUD WALL FURRING COMPLETE.</div> <div>2E. EXISTING MASONRY WALL MUST REMAIN AS DIMENSIONED.</div> <div>3. REMOVE PLUMBING FIXTURE COMPLETE. PREPARE AREA TO RECEIVE PLUMBING FIXTURE. REFERENCE PLUMBING DRAWINGS FOR PLUMBING FIXTURE SCHEDULE.</div> <div>4. REMOVE TOILET PARTITIONS, URINAL SCREENS AND TOILET ACCESSORIES COMPLETE INCLUDING BUT NOT LIMITED TO PAPER TOWEL DISPENSERS, SOAP DISPENSERS, TOILET PAPER DISPENSERS AND GRAB BARS. PATCH AND REPAIR MASONRY WALLS TO RECEIVE FINISHES AND PARTITIONS, URINAL SCREENS AND TOILET ACCESSORIES.</div> <div>5. REMOVE EXISTING FINISH FLOOR AND WALL MATERIALS COMPLETE. PATCH AND REPAIR CONCRETE FLOORS AND MASONRY WALLS. PREPARE AREAS TO RECEIVE FINISHES.</div> <div>6. REMOVE EXISTING SHOWER HEAD, FIXTURES AND CONTROLS COMPLETE. PREPARE AREA TO RECEIVE SHOWER HEADS, FIXTURES AND CONTROLS.</div> <div>7. REMOVE EXISTING COUNTERTOP, MILLWORK PANELS AND SUPPORTS COMPLETE. PATCH AND REPAIR MASONRY WALLS TO RECEIVE COUNTERTOPS, PANELS AND SUPPORTS.</div> <div>8. REMOVE EXISTING WALL FURRING COMPLETE. REFERENCE EXTERIOR WALL NOTES ON THIS DRAWING FOR ADDITIONAL INFORMATIONAL.</div> <div>9. REMOVE EXISTING 2'-0" x 2'-9" WINDOW ASSEMBLY COMPLETE AND INFILL OPENING WITH MASONRY OF SAME SIZE (8-INCH CMU) TO PROVIDE A FLAT SURFACE. ALIGN FINISHED SURFACE WITH EXISTING ADJACENT SURFACE AND PREPARE AREA TO RECEIVE FINISHES.</div> <div>10. REMOVE EXISTING 4'-4" x 2'-9" WINDOW ASSEMBLY COMPLETE AND INFILL OPENING WITH MASONRY OF SAME SIZE (8-INCH CMU) TO PROVIDE A FLAT SURFACE. ALIGN FINISHED SURFACE WITH EXISTING ADJACENT SURFACE AND PREPARE AREA TO RECEIVE FINISHES.</div> <div>11. REMOVE EXISTING METAL WALL PANEL SYSTEM. SALVAGE METAL PANELS FOR REUSE FOR THE BUILDING ADDITION EXTERIOR WALL.</div> <div>12. REMOVE EXISTING PARTITION AS DIMENSIONED FOR DOOR OPENING. FOR THE MASONRY WALL, TOOTH MASONRY OF SAME SIZE INTO THE EXISTING WALL TO PROVIDE A FLAT SURFACE. ALIGN FINISHED SURFACE WITH EXISTING ADJACENT SURFACE. PREPARE OPENING FOR DOOR AND FRAME ASSEMBLY. REFERENCE ARCHITECTURAL FLOOR PLAN AND DOOR SCHEDULE FOR ADDITIONAL INFORMATION.</div> <div>13. REMOVE DOOR, DOOR FRAME AND DOOR HARDWARE COMPLETE.</div> <div>14. REMOVE EXISTING CONCRETE SLAB ON GRADE TO EXPOSE EXISTING UNDERGROUND SANITARY LINE FOR REPLACEMENT. REFERENCE PLUMBING DRAWINGS FOR ROUTING AND STRUCTURAL DRAWINGS FOR SLAB DETAILS. THE AREAS OF WORK ARE DENOTED PER THE FOLLOWING MARKING;</div>

- GENERAL NOTES
1. REFERENCE AD100 DRAWING SERIES FOR DEMOLITION PLANS AND NOTES;

2. REFERENCE A-000 DRAWING SERIES FOR GENERAL NOTES AND SCHEDULES;

3. REFERENCE A-110 DRAWING SERIES FOR FLOOR PLANS;

4. REFERENCE A-120 DRAWING SERIES FOR CEILING PLANS;



5. REFERENCE A-130 DRAWING SERIES FOR FINISH PLANS;

6. REFERENCE A-140 DRAWING SERIES FOR ROOF PLANS;

7. REFERENCE A-200 DRAWING SERIES FOR BUILDING ELEVATIONS;

8. REFERENCE A-300 DRAWING SERIES FOR SECTIONS;

9. REFERENCE A-400 DRAWING SERIES FOR ENLARGED PLANS;

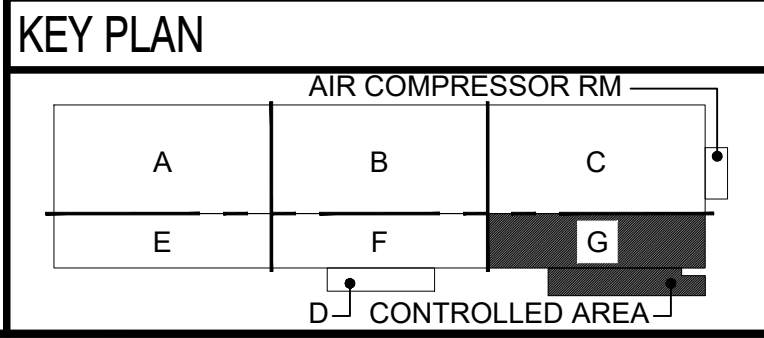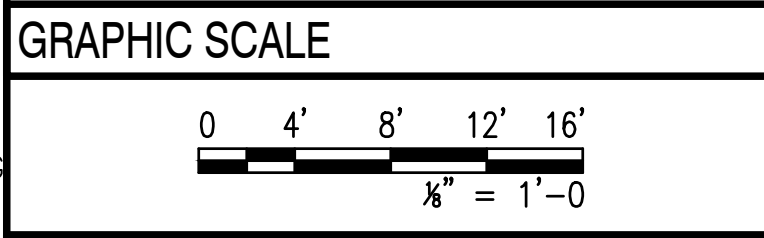

APPROVED

FOR COMMANDER NAVFAC

APPROVED BY KYLE STRAUSBAUGH,
NAVFAC HEAD DIRECTOR - PWD
OCEANA, VA EMAIL

SATISFACTORY TO DATE 12/06/2022

DES JMT DRW JMT CHK DRT

PM/DM EAW/CWJ

BRANCH MANAGER CGM

CHIEF ENG/ARCH EJA

FIRE PROTECTION DSN

NAVFAC

GHD

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DEPARTMENT OF THE NAVY

NAVAL FACILITIES ENGINEERING SYSTEMS COMMAND

NAVAL STATION - NORFOLK, VA

VIRGINIA BEACH, VA

NAVFAC DRAWING NO. 12821680

SHEET 73 OF 382

AD106

HANGAR 404 FIRE PROTECTION AND BUILDING ENVELOPE REPAIRS

1st FLOOR DEMOLITION PLAN - AREA G

SCALE: AS NOTED


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CONSTR. CONTR. NO.

NAVJAG DRAWING NO. 12821680

DATE: 07 AUG 2018

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MECHANICAL DEMOLITION AND ACCESS NOTE: PER ITEMS KEYNOTED PER THE FOLLOWING SYMBOL, [M], SELECTIVELY REMOVE EXISTING CMU/MASONRY WALL TO GAIN ACCESS TO MECHANICAL ELEMENTS AS NOTED ON THE MECHANICAL DRAWINGS. AT THE COMPLETION OF WORK, INFILL OPENING WITH MASONRY OF SAME SIZE (6-INCH OR 8-INCH CMU) TO PROVIDE A FLAT SURFACE. ALIGN FINISHED SURFACE WITH EXISTING ADJACENT SURFACE AND PREPARE AREA TO RECEIVE FINISHES

MATCHLINE SEE AD101 FOR CONTINUATION


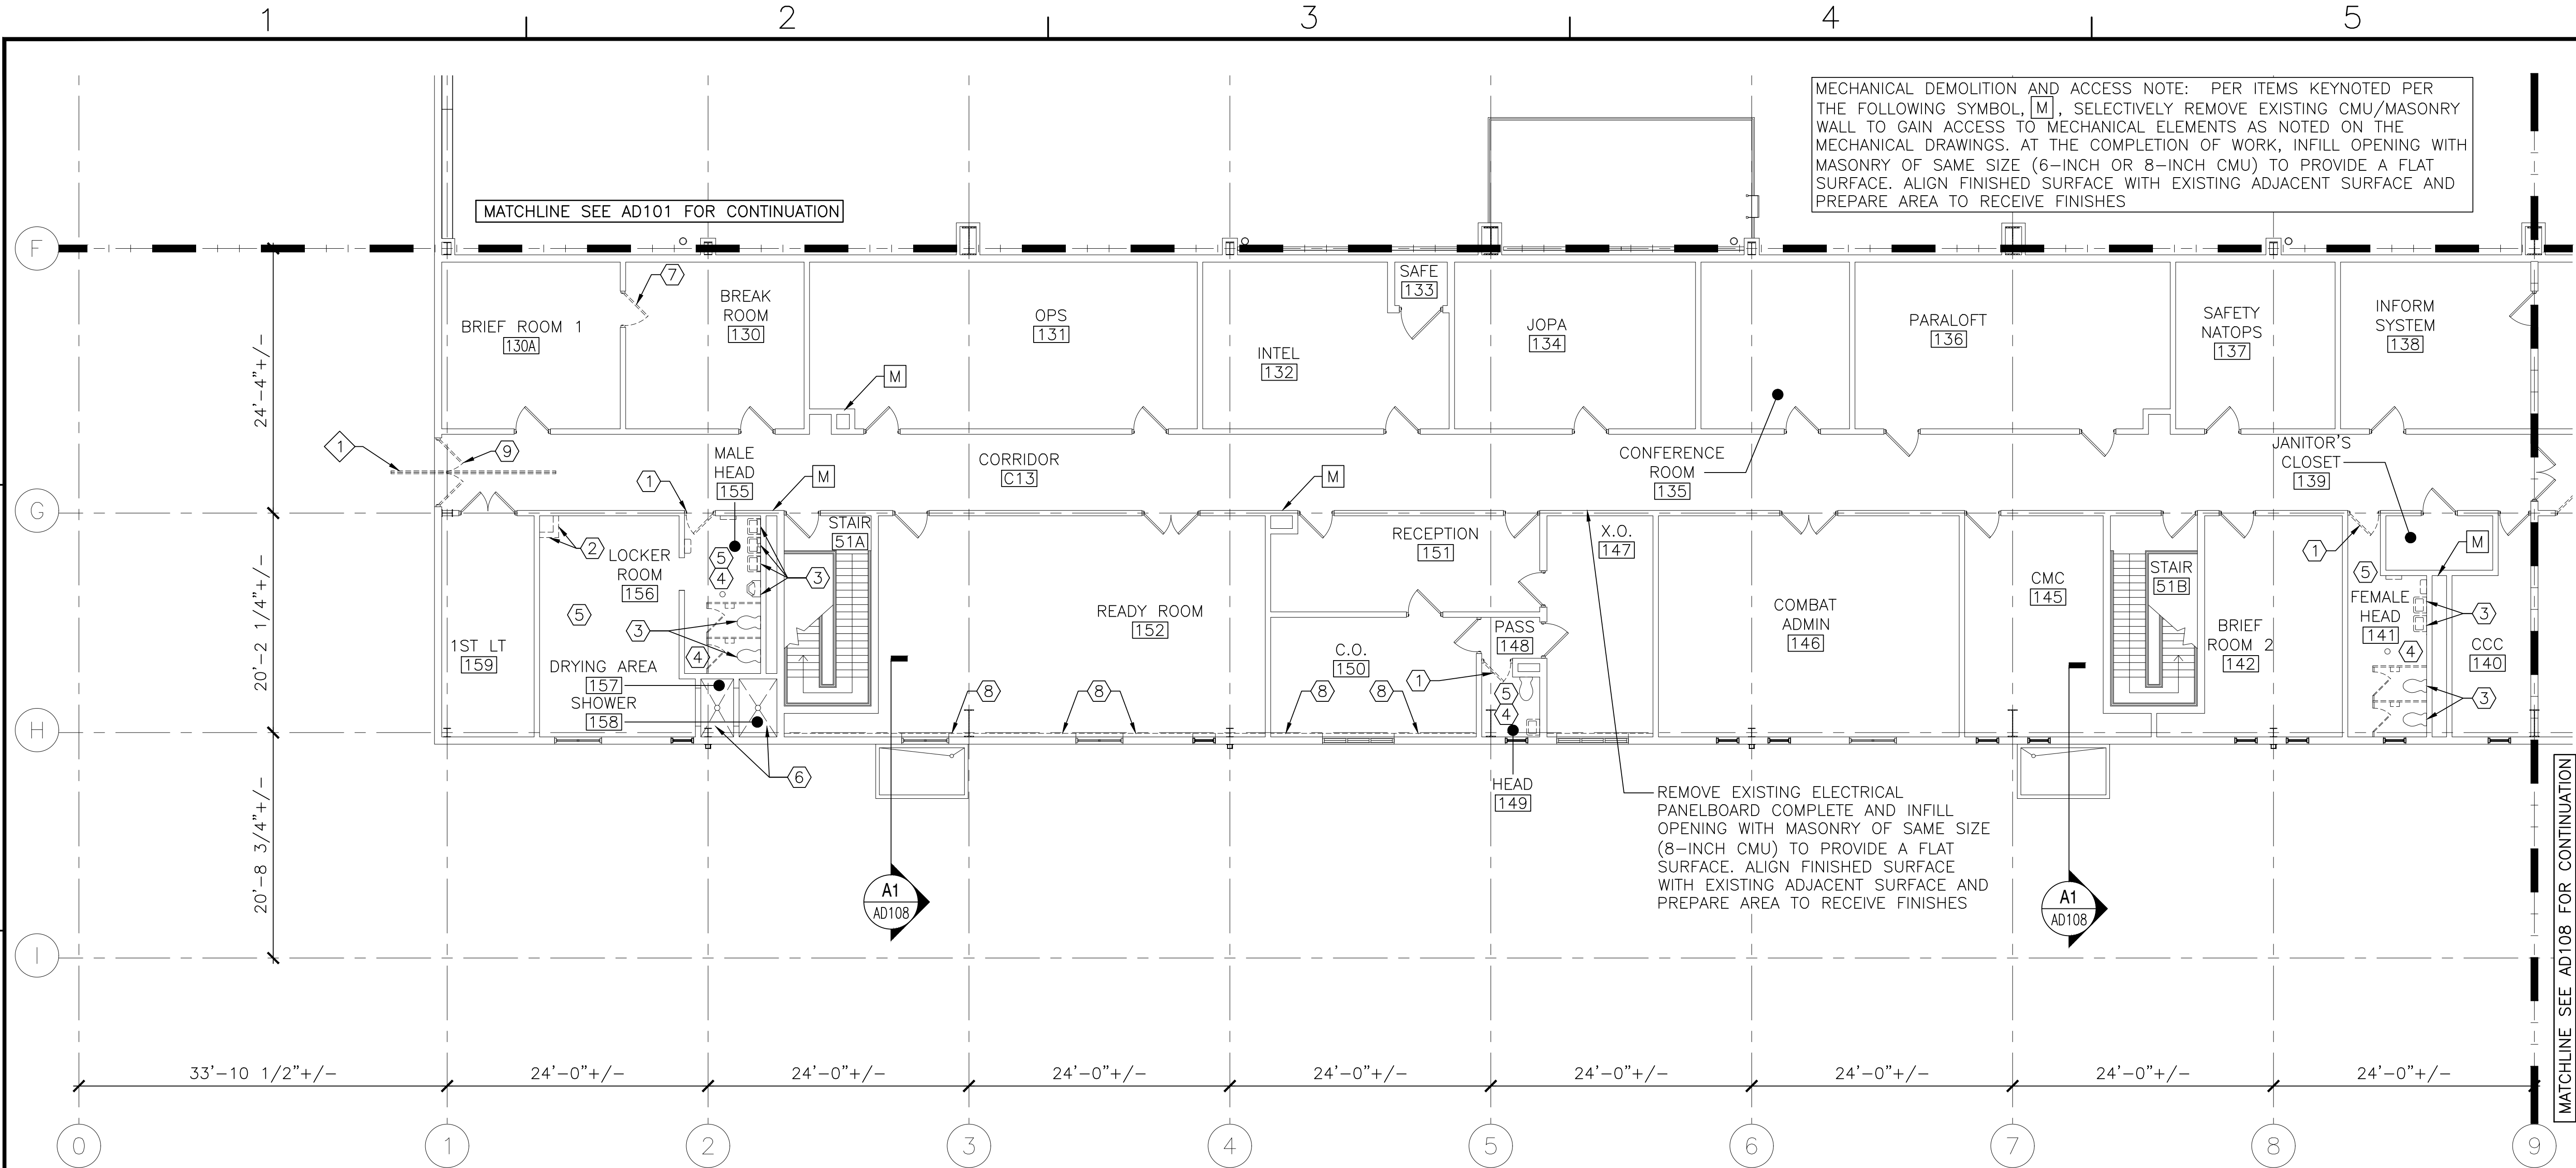
MATCHLINE SEE AD108 FOR CONTINUATION

MONORAIL NOTES

REMOVE EXISTING MONORAIL AND SUPPORTING STEEL COMPLETE. STEEL FRAMING INCLUDES S6 X 12.5 (15'-2" +/- LENGTH), 2 1/2" X 2 1/2" X 3/16" STEEL ANGLE HANGERS/BRACING, W8 X 10 (7'-0" +/- LENGTH) AND W8 X 10 (12'-4" +/- LENGTH) AT UNDERSIDE OF EXISTING ROOF STEEL INCLUDING CLIP ANGLE CONNECTIONS. EXISTING ROOF STEEL MUST REMAIN AND MUST REMAIN UNDAMAGED DURING STEEL REMOVAL.

EXISTING CANOPY NOTES

REMOVE EXISTING CANOPY ROOF MEMBRANE, ROOF INSULATION, TAPERED CANTS, WOOD BLOCKING, FLASHING AT CMU WALL, ROOF DRAIN, DOWNSPOUT AND PERIMETER GRAVEL STOP COMPLETE. EXISTING STEEL TUBE FRAMING, STEEL ANGLES AND STEEL ROOF DECK MUST REMAIN. PROVIDE TAPERED INSULATION TO ACHIEVE THE SLOPE NEEDED TO DRAIN. ROOF MEMBRANE AND INSULATION MUST MATCH THAT OF THE HANGAR ROOF/OFFICE ROOFS. PROVIDE CONTINUOUS FLASHING AT THE CMU WALL AND PERIMETER OF CANOPY. PROVIDE ROOF DRAIN OF THE SAME SIZE AND LOCATION. PROVIDE DOWNSPOUT AS SHOWN. THE DOWNSPOUT MUST DAYLIGHT TO CONCRETE SPLASH BLOCK. CAP THE EXISTING CONNECTION TO THE UNDERGROUND SYSTEM.

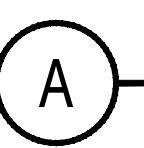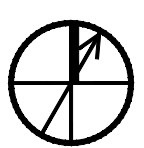



2ND FLOOR DEMOLITION - MODULE 1

SCALE: 1/8" = 1'-0"

- EXTERIOR WALL NOTES
- REMOVE SURFACE MOUNTED AND THRU-WALL VENTS, CONDUITS, FIRE PROTECTION ITEMS, PLUMBING AND MECHANICAL ITEMS ALONG EXTERIOR MASONRY WALLS. REFERENCE MECHANICAL, ELECTRICAL AND PLUMBING DRAWINGS FOR ADDITIONAL INFORMATION AND LOCATIONS. FILL AND FULLY GROUT HOLES AND VOIDS IN THE WALL CREATED BY REMOVAL OF UTILITIES;
 - REMOVE EXISTING WALL FURRING ALONG COLUMN LINE 'H' COMPLETE INCLUDING BUT NOT LIMITED TO FINISH MATERIALS AND STUDS TO EXPOSE EXISTING MASONRY WALL. PATCH AND REPAIR FLOORS AND WALLS AND PREPARE AREA TO RECEIVE FINISHES.
 - CLEAN, PATCH AND REPAIR WALL AREAS BEHIND EXISTING STEEL COLUMNS ALONG COLUMN LINE 'H' TO EXTENT POSSIBLE.

- DEMOLITION KEY NOTES
- REMOVE AND REPLACE EXISTING DOORS, FASTENERS, SEALANT AND DOOR HARDWARE COMPLETE AS SCHEDULED. CLEAN, PATCH AND PREPARE EXISTING DOOR FRAMES TO RECEIVE DOOR AND HARDWARE ASSEMBLY. REFERENCE ARCHITECTURAL FLOOR PLANS AND DOOR SCHEDULES FOR ADDITIONAL INFORMATION. REFERENCE ENVIRONMENTAL DOCUMENTS FOR ADDITIONAL INFORMATION.
 - REMOVE EXISTING PARTITION COMPLETE TO GAIN ACCESS TO THE EXISTING MECHANICAL SYSTEM. COORDINATE DEMOLITION WITH MECHANICAL DRAWINGS.
 - REMOVE PLUMBING FIXTURE COMPLETE. PREPARE AREA TO RECEIVE PLUMBING FIXTURE. REFERENCE PLUMBING DRAWINGS FOR PLUMBING FIXTURE SCHEDULE.
 - REMOVE TOILET PARTITIONS, URINAL SCREENS AND TOILET ACCESSORIES COMPLETE INCLUDING BUT NOT LIMITED TO PAPER TOWEL DISPENSERS, SOAP DISPENSERS, TOILET PAPER DISPENSERS AND GRAB BARS. PATCH AND REPAIR MASONRY WALLS TO RECEIVE FINISHES AND PARTITIONS, URINAL SCREENS AND TOILET ACCESSORIES.
 - REMOVE EXISTING FINISH FLOOR AND WALL MATERIALS COMPLETE. PATCH AND REPAIR CONCRETE FLOORS AND MASONRY WALLS. PREPARE AREAS TO RECEIVE FINISHES.
 - REMOVE EXISTING SHOWER HEAD, FIXTURES AND CONTROLS COMPLETE. PREPARE AREA TO RECEIVE SHOWER HEADS, FIXTURES AND CONTROLS.
 - REMOVE EXISTING DOORS, DOOR FRAMES, FASTENERS, SEALANT AND DOOR HARDWARE COMPLETE AND INFILL OPENING WITH MASONRY OF SAME SIZE TO PROVIDE A FLAT SURFACE. ALIGN FINISHED SURFACE WITH EXISTING ADJACENT SURFACE AND PREPARE AREA TO RECEIVE FINISHES;
 - REMOVE EXISTING WALL FURRING COMPLETE. REFERENCE EXTERIOR WALL NOTES ON THIS DRAWING FOR ADDITIONAL INFORMATIONAL.
 - REMOVE AND REPLACE EXISTING DOOR, DOOR HARDWARE AND DOOR FRAME COMPLETE. REFERENCE ARCHITECTURAL FLOOR PLANS AND DOOR SCHEDULES FOR ADDITIONAL INFORMATION. REFERENCE ENVIRONMENTAL DOCUMENTS FOR ADDITIONAL INFORMATION.

- GENERAL NOTES
- REFERENCE AD100 DRAWING SERIES FOR DEMOLITION PLANS AND NOTES;
 - REFERENCE A-000 DRAWING SERIES FOR GENERAL NOTES AND SCHEDULES;
 - REFERENCE A-110 DRAWING SERIES FOR FLOOR PLANS;
 - REFERENCE A-120 DRAWING SERIES FOR CEILING PLANS;
 - REFERENCE A-130 DRAWING SERIES FOR FINISH PLANS;
 - REFERENCE A-140 DRAWING SERIES FOR ROOF PLANS;
 - REFERENCE A-200 DRAWING SERIES FOR BUILDING ELEVATIONS;
 - REFERENCE A-300 DRAWING SERIES FOR SECTIONS;
 - REFERENCE A-400 DRAWING SERIES FOR ENLARGED PLANS;

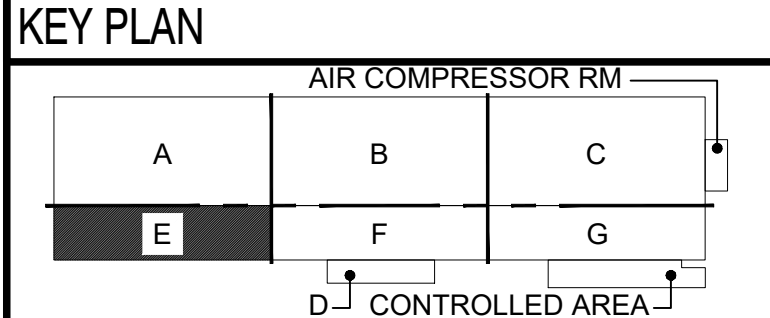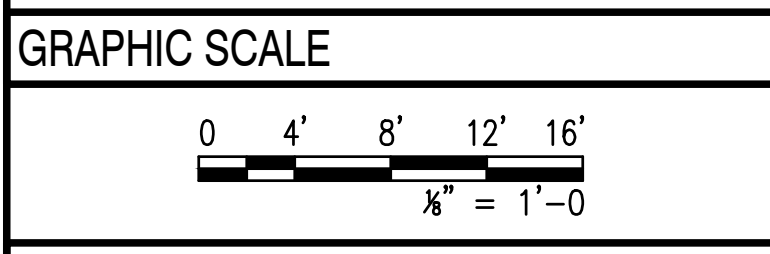

APPROVED

FOR COMMANDER NAVFAC

APPROVED BY KYLE STRAUSBAUGH,
NAVFAC HEAD DIRECTOR - PWD
OCEANA, VA EMAIL: kyle.strausbaugh@navfac.navy.mil

SATISFACTORY TO DATE: 12/06/2022

DES	JMT	DRW	JMT	CHK	DRT
PM/DM				EAU/CWJ	
BRANCH	MANAGER			CGM	
CHIEF	ENG/ARCH			EJA	
FIRE	PROTECTION			DSN	

DEPARTMENT OF THE NAVY
NAVAL FACILITIES ENGINEERING SYSTEMS COMMAND
NAVAL STATION - NORFOLK, VA
NAVAL STATION - OCEANA, VIRGINIA BEACH, VA

HANGAR 404 FIRE PROTECTION AND BUILDING ENVELOPE REPAIRS

2nd FLOOR DEMOLITION PLAN - AREA E

SCALE: AS NOTED

PROJECT NO.: 1372148

CONSTR. CONTR. NO.

NAVFAC DRAWING NO. 12821681

SHEET 74 OF 382

AD107

DRAWING REVISION: 07 AUG 2018

NAVFAC

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W www.nvf.com

Baskervill

A/E 10/20

APPROVED

DATE


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SYN

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FILE NAME: \\gdnr\gnd\US\Chantilly\Projects\585\1120348\Digital_Design\1 - CAD\3.1.2 - Sheet\05b - Architectural\2022 11 18 Final\137248-AD110.dwg LAYOUT NAME: Layout1 PLOTTED: Monday, December 05, 2022 - 1:40pm USER: nsash



APPR	DATE	SYN	DESCRIPTION

FOR COMMANDER NAVFAC			
APPROVED BY KYLE STRAUSBAUGH, NAVFAC HEAD DIRECTOR - PWD OCEANA, VA EMAIL			
SATISFACTORY TO DATE		12/06/2022	
DES	JMT	DRW	JWT
PM/DM	EAW/CWJ		
BRANCH	MANAGER CGM		
CHIEF	ENG/ARCH EJA		
FIRE PROTECTION	DSN		

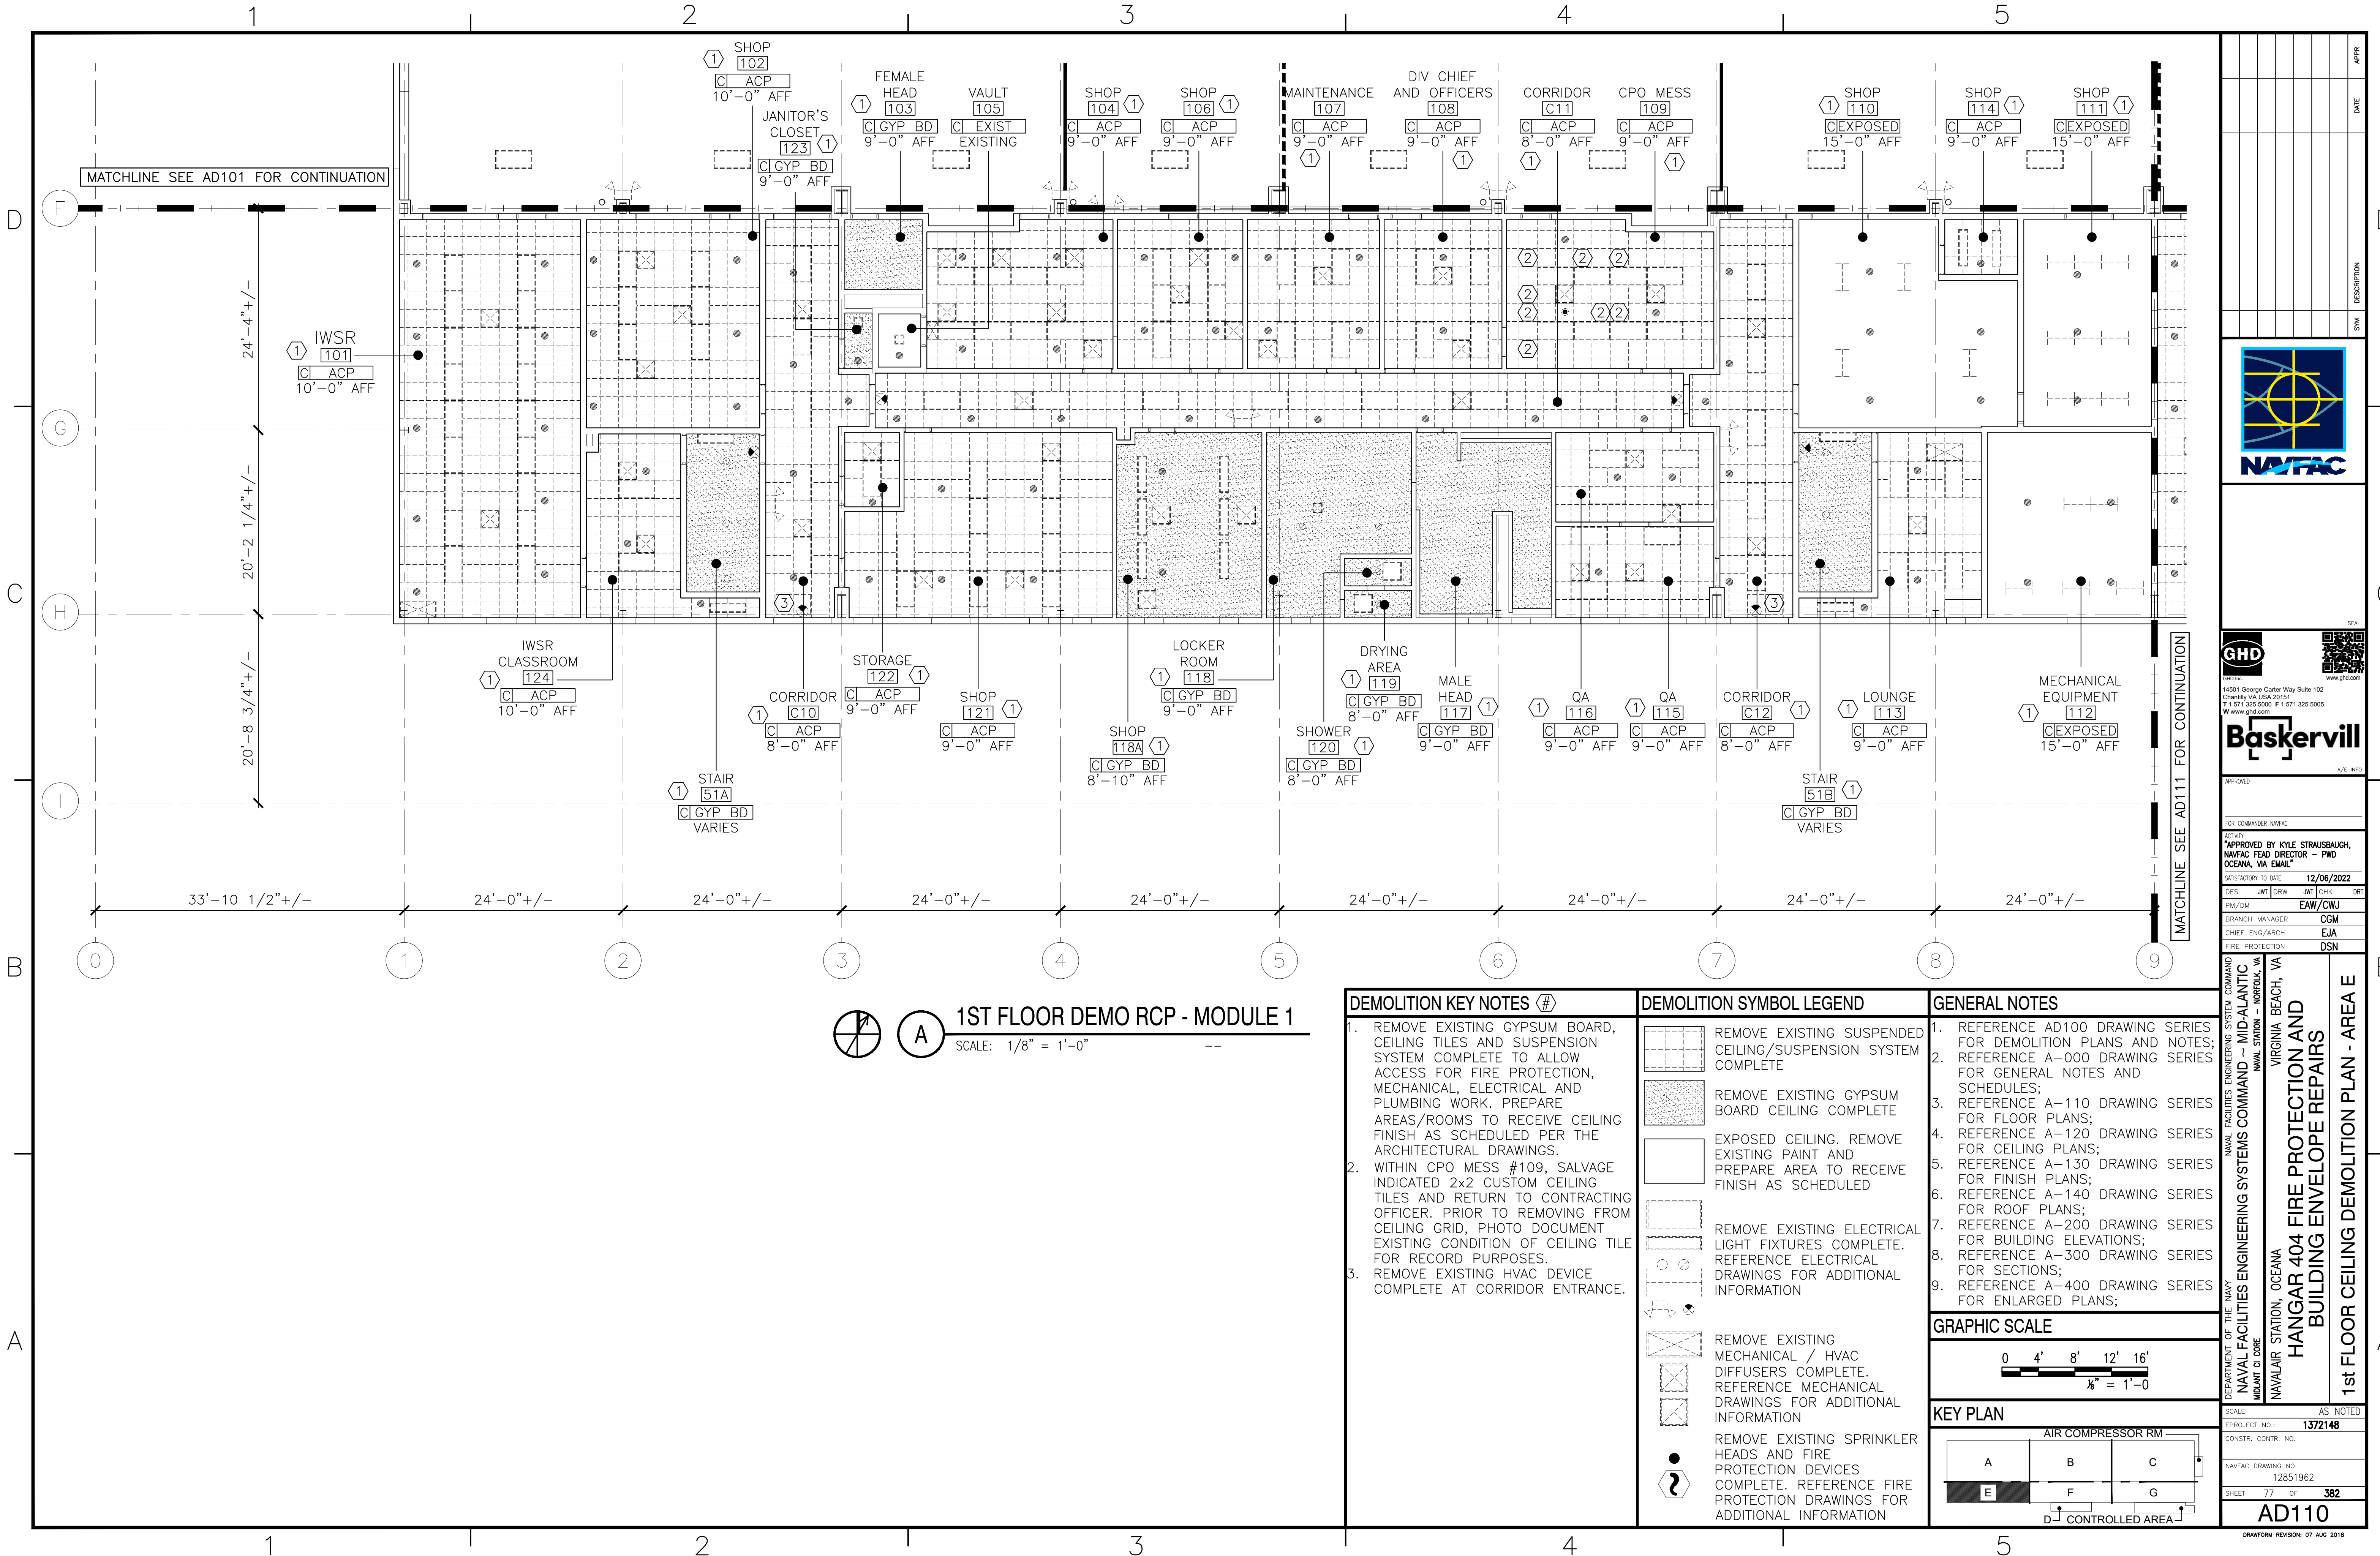
DEPARTMENT OF THE NAVY
NAVAL FACILITIES ENGINEERING SYSTEMS COMMAND
NAVAL STATION - NORFOLK, VA

NAVAL AIR STATION, OCEANA
HANGAR 404 FIRE PROTECTION AND BUILDING ENVELOPE REPAIRS

1st FLOOR CEILING DEMOLITION PLAN - AREA E

SCALE:	AS NOTED
PROJECT NO.:	1372148
CONSTR. CONTR. NO.	
NAVFAC DRAWING NO.	12851962
SHEET	77 OF 382
AD110	
DRAWING REVISION: 07 AUG 2018	

FILE NAME: \\gdnr\gnd\US\Chantilly\Projects\585\11203487\Digital_Design\1 - CAD\3.1.2 - Sheet\05b - Architectural\2022 11 18 Final\137248-AD111.dwg LAYOUT NAME: Layout1 PLOTED: Monday, December 05, 2022 - 1:40pm USER: nash

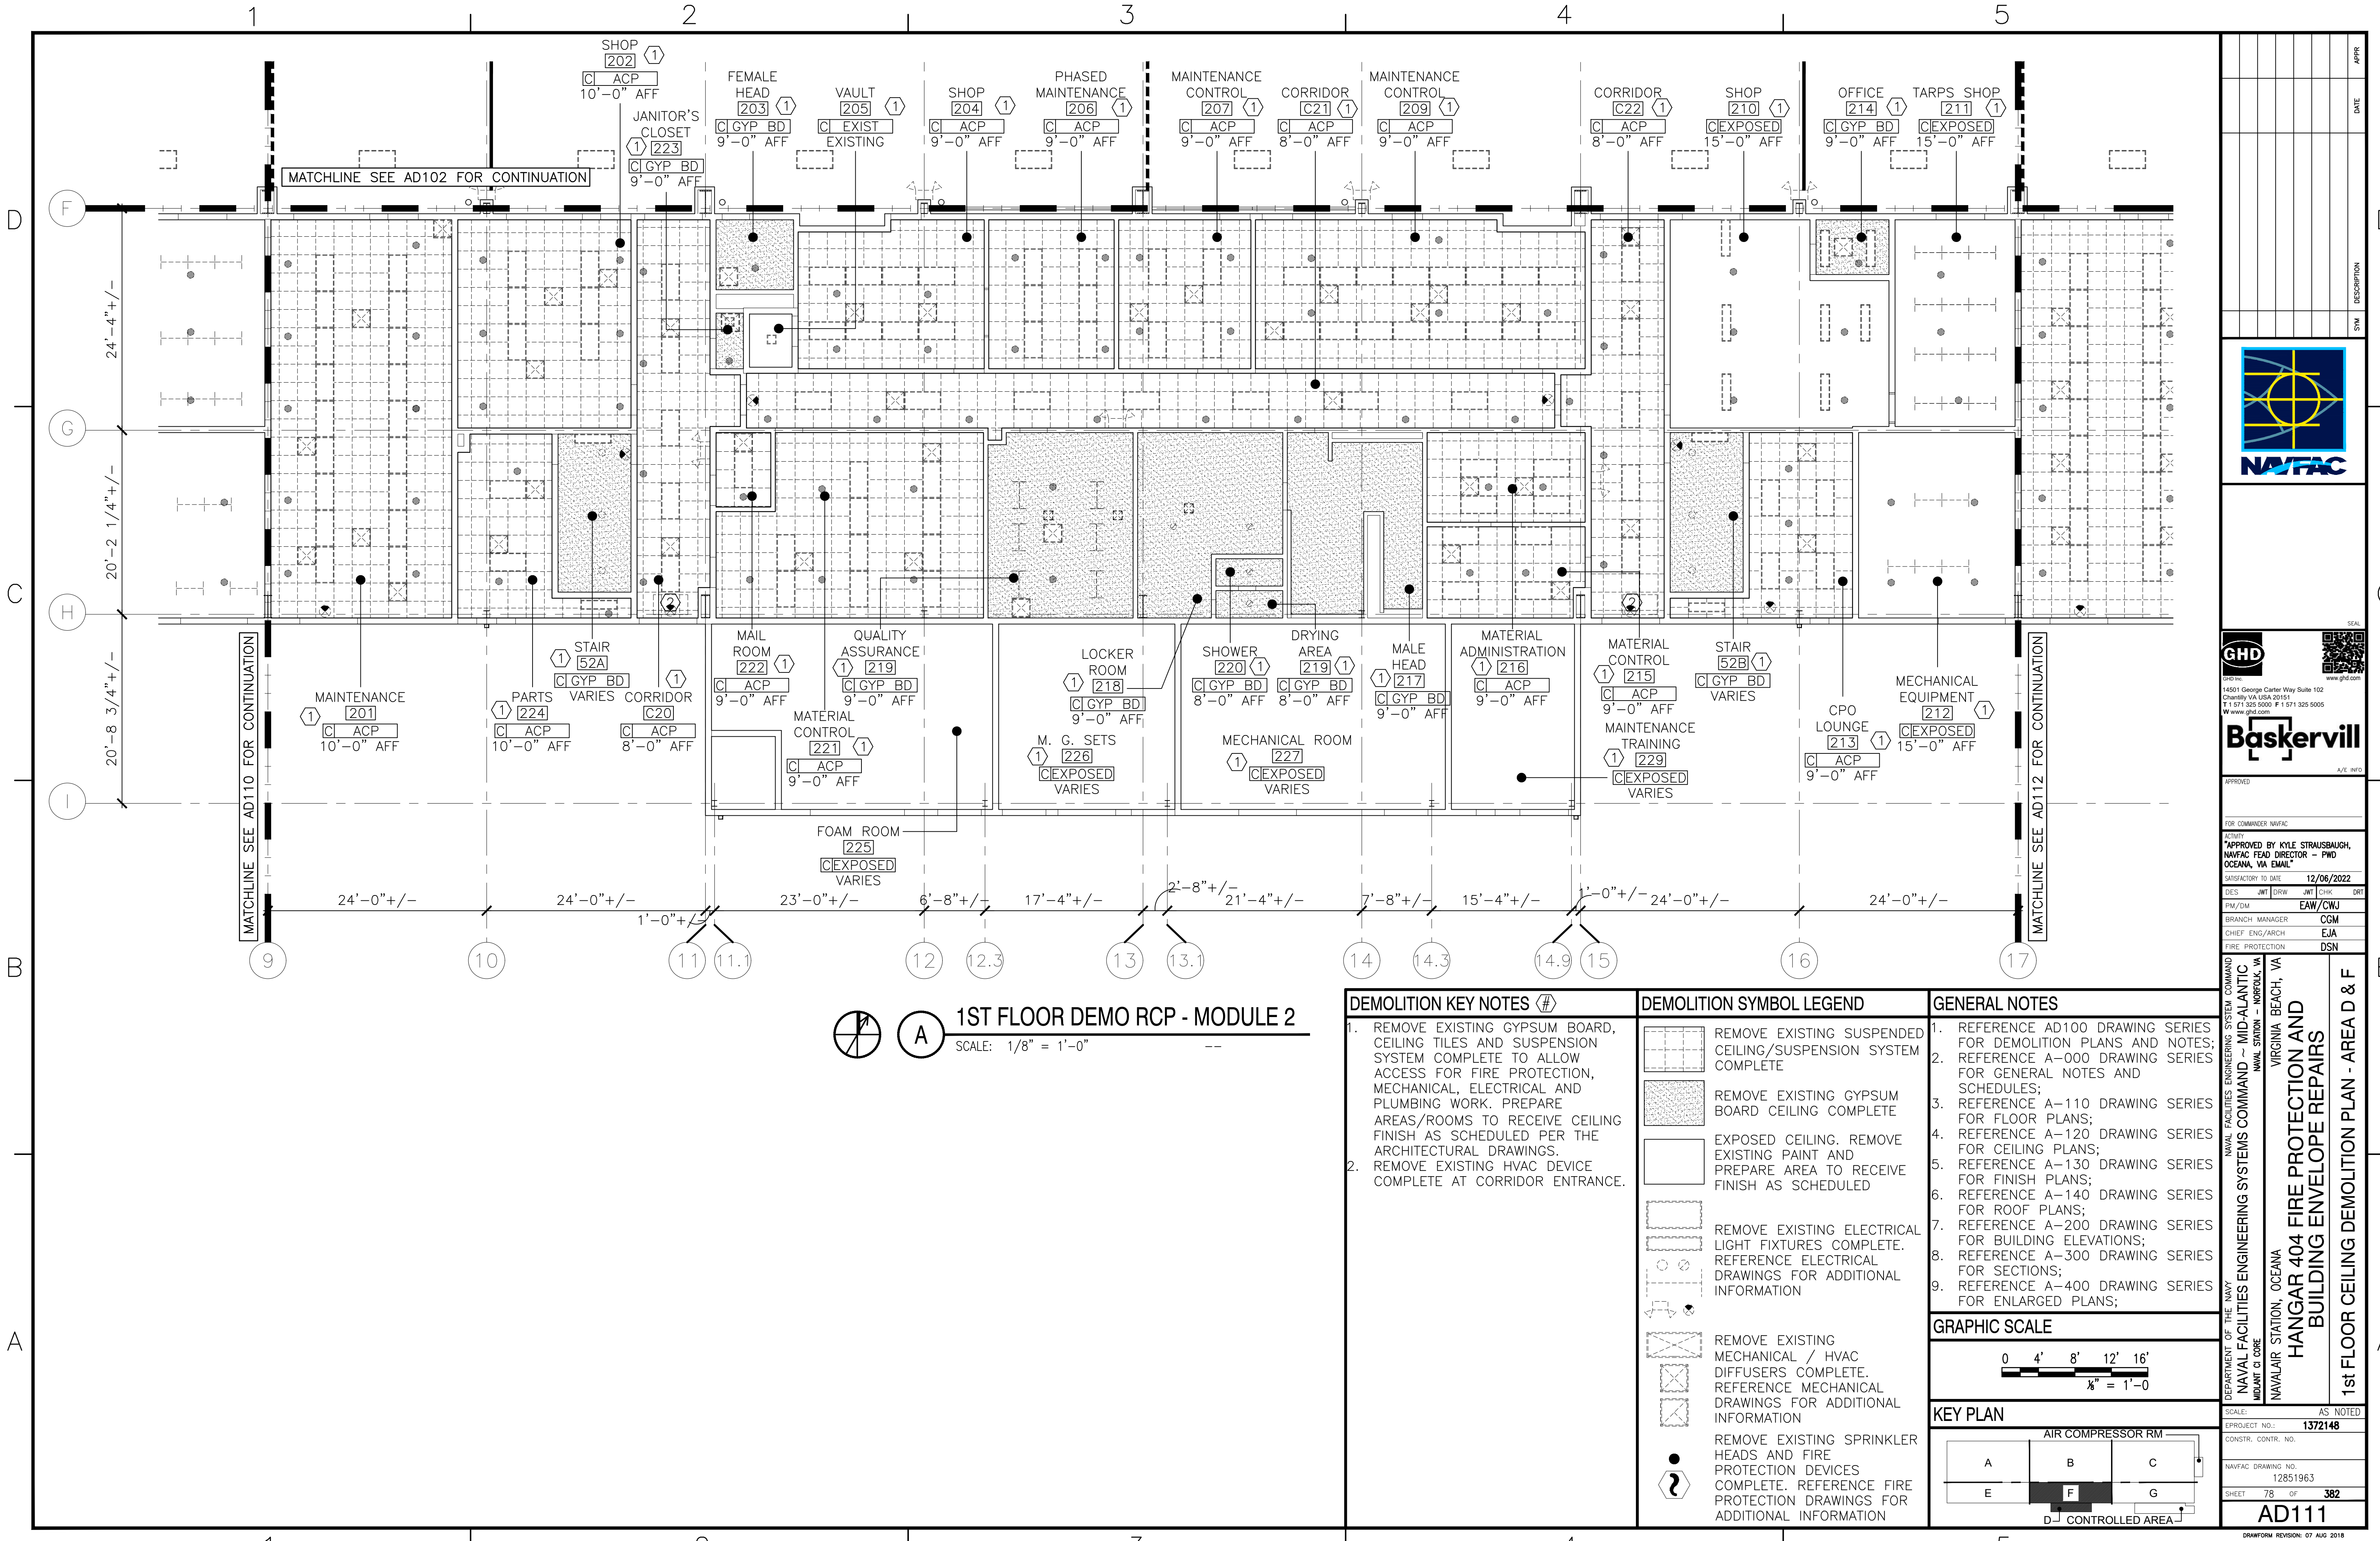

DEMOLITION KEY NOTES (#)	DEMOLITION SYMBOL LEGEND	GENERAL NOTES
1. REMOVE EXISTING GYPSUM BOARD, CEILING TILES AND SUSPENSION SYSTEM COMPLETE TO ALLOW ACCESS FOR FIRE PROTECTION, MECHANICAL, ELECTRICAL AND PLUMBING WORK. PREPARE AREAS/ROOMS TO RECEIVE CEILING FINISH AS SCHEDULED PER THE ARCHITECTURAL DRAWINGS. 2. REMOVE EXISTING HVAC DEVICE COMPLETE AT CORRIDOR ENTRANCE.	<div><div></div>REMOVE EXISTING SUSPENDED CEILING/SUSPENSION SYSTEM COMPLETE</div> <div><div></div>REMOVE EXISTING GYPSUM BOARD CEILING COMPLETE</div> <div><div></div>EXPOSED CEILING. REMOVE EXISTING PAINT AND PREPARE AREA TO RECEIVE FINISH AS SCHEDULED</div> <div><div></div>REMOVE EXISTING ELECTRICAL LIGHT FIXTURES COMPLETE. REFERENCE ELECTRICAL DRAWINGS FOR ADDITIONAL INFORMATION</div> <div><div></div>REMOVE EXISTING MECHANICAL / HVAC DIFFUSERS COMPLETE. REFERENCE MECHANICAL DRAWINGS FOR ADDITIONAL INFORMATION</div> <div><div></div>REMOVE EXISTING SPRINKLER HEADS AND FIRE PROTECTION DEVICES COMPLETE. REFERENCE FIRE PROTECTION DRAWINGS FOR ADDITIONAL INFORMATION</div>	1. REFERENCE AD100 DRAWING SERIES FOR DEMOLITION PLANS AND NOTES; 2. REFERENCE A-000 DRAWING SERIES FOR GENERAL NOTES AND SCHEDULES; 3. REFERENCE A-110 DRAWING SERIES FOR FLOOR PLANS; 4. REFERENCE A-120 DRAWING SERIES FOR CEILING PLANS; 5. REFERENCE A-130 DRAWING SERIES FOR FINISH PLANS; 6. REFERENCE A-140 DRAWING SERIES FOR ROOF PLANS; 7. REFERENCE A-200 DRAWING SERIES FOR BUILDING ELEVATIONS; 8. REFERENCE A-300 DRAWING SERIES FOR SECTIONS; 9. REFERENCE A-400 DRAWING SERIES FOR ENLARGED PLANS;
GRAPHIC SCALE 0 4' 8' 12' 16' 1/8" = 1'-0"		
KEY PLAN AIR COMPRESSOR RM A B C E F G D CONTROLLED AREA		

14501 George Carter Way Suite 102
Chantilly VA USA 20151
T 1 571 325 5000 F 1 571 325 5005
W www.gnd.com

Baskervill
A/E 06/20

APPROVED	FOR COMMANDER NAVFAC				
APPROVED BY KYLE STRAUSBAUGH, NAVFAC HEAD DIRECTOR - PWD OCEANA, VA EMAIL					
SATISFACTORY TO DATE	12/06/2022				
DES	JMT	DRW	JMT	CHK	DRT
PM/DM	EAW/CWJ				
BRANCH	MANAGER CGM				
CHIEF	ENG/ARCH EJA				
FIRE PROTECTION	DSN				

DEPARTMENT OF THE NAVY
NAVFACILITIES ENGINEERING SYSTEMS COMMAND
NAVFAC STATION - OCEANA
NAVFAC STATION - NORFOLK, VA


VIRGINIA BEACH, VA

**HANGAR 404 FIRE PROTECTION AND
BUILDING ENVELOPE REPAIRS**

1st FLOOR CEILING DEMOLITION PLAN - AREA D & F

SCALE:	AS NOTED
PROJECT NO.:	1372148
CONSTR. CONTR. NO.	
NAVFAC DRAWING NO.	12851963
SHEET	78 OF 382
AD111	
DRAWING REVISION: 07 AUG 2018	

FILE NAME: \\gdnr\gnd\US\Chantilly\Projects\585\11203487\Digital_Design\1 - CAD\3.1.2 - Sheet\05b - Architectural\2022\1118 Final\172148-AD112.dwg LAYOUT NAME: Layout1 PLOTED: Monday, December 05, 2022 - 1:40pm USER: nsash

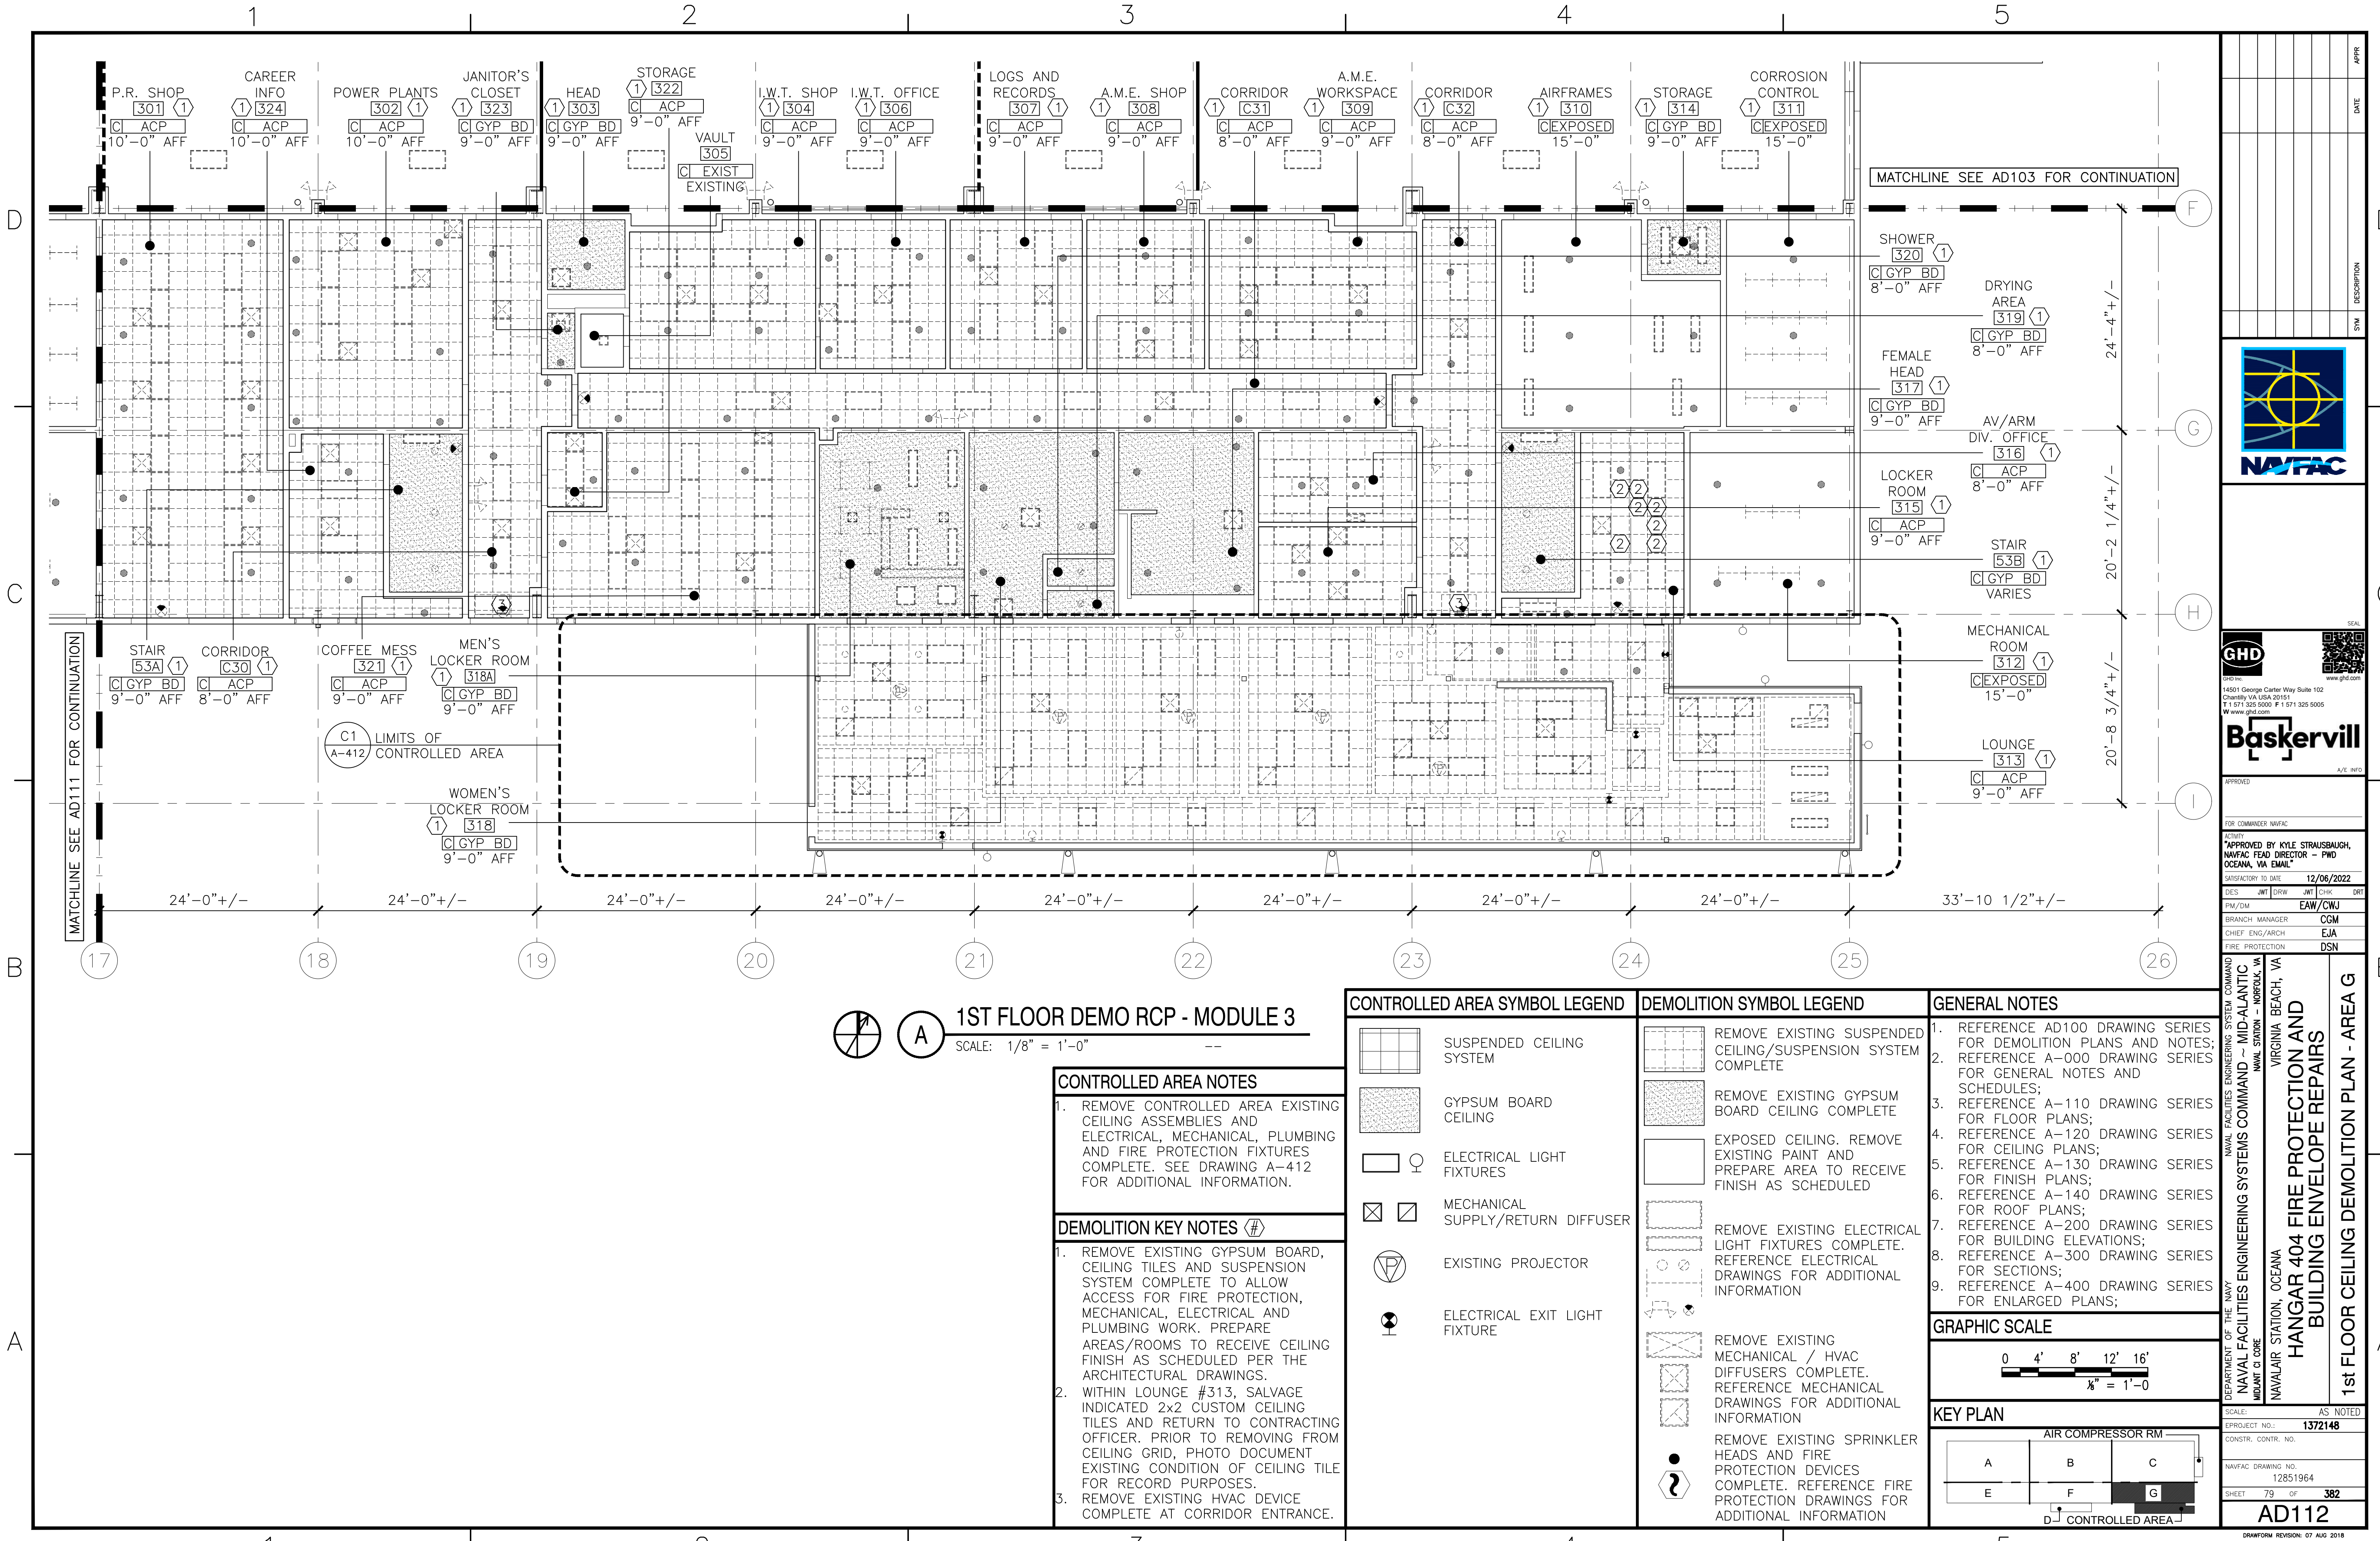

A

1ST FLOOR DEMO RCP - MODULE 3

SCALE: 1/8" = 1'-0"

CONTROLLED AREA NOTES

1. REMOVE CONTROLLED AREA EXISTING CEILING ASSEMBLIES AND ELECTRICAL, MECHANICAL, PLUMBING AND FIRE PROTECTION FIXTURES COMPLETE. SEE DRAWING A-412 FOR ADDITIONAL INFORMATION.

DEMOLITION KEY NOTES (#)

1. REMOVE EXISTING GYPSUM BOARD, CEILING TILES AND SUSPENSION SYSTEM COMPLETE TO ALLOW ACCESS FOR FIRE PROTECTION, MECHANICAL, ELECTRICAL AND PLUMBING WORK. PREPARE AREAS/ROOMS TO RECEIVE CEILING FINISH AS SCHEDULED PER THE ARCHITECTURAL DRAWINGS.
2. WITHIN LOUNGE #313, SALVAGE INDICATED 2x2 CUSTOM CEILING TILES AND RETURN TO CONTRACTING OFFICER. PRIOR TO REMOVING FROM CEILING GRID, PHOTO DOCUMENT EXISTING CONDITION OF CEILING TILE FOR RECORD PURPOSES.
3. REMOVE EXISTING HVAC DEVICE COMPLETE AT CORRIDOR ENTRANCE.

CONTROLLED AREA SYMBOL LEGEND

	SUSPENDED CEILING SYSTEM
	GYPSUM BOARD CEILING
	ELECTRICAL LIGHT FIXTURES
	MECHANICAL SUPPLY/RETURN DIFFUSER
	EXISTING PROJECTOR
	ELECTRICAL EXIT LIGHT FIXTURE


DEMOLITION SYMBOL LEGEND

	REMOVE EXISTING SUSPENDED CEILING/SUSPENSION SYSTEM COMPLETE
	REMOVE EXISTING GYPSUM BOARD CEILING COMPLETE
	EXPOSED CEILING. REMOVE EXISTING PAINT AND PREPARE AREA TO RECEIVE FINISH AS SCHEDULED
	REMOVE EXISTING ELECTRICAL LIGHT FIXTURES COMPLETE. REFERENCE ELECTRICAL DRAWINGS FOR ADDITIONAL INFORMATION
	REMOVE EXISTING MECHANICAL / HVAC DIFFUSERS COMPLETE. REFERENCE MECHANICAL DRAWINGS FOR ADDITIONAL INFORMATION
	REMOVE EXISTING SPRINKLER HEADS AND FIRE PROTECTION DEVICES COMPLETE. REFERENCE FIRE PROTECTION DRAWINGS FOR ADDITIONAL INFORMATION


GENERAL NOTES

1. REFERENCE AD100 DRAWING SERIES FOR DEMOLITION PLANS AND NOTES;
2. REFERENCE A-000 DRAWING SERIES FOR GENERAL NOTES AND SCHEDULES;
3. REFERENCE A-110 DRAWING SERIES FOR FLOOR PLANS;
4. REFERENCE A-120 DRAWING SERIES FOR CEILING PLANS;
5. REFERENCE A-130 DRAWING SERIES FOR FINISH PLANS;
6. REFERENCE A-140 DRAWING SERIES FOR ROOF PLANS;
7. REFERENCE A-200 DRAWING SERIES FOR BUILDING ELEVATIONS;
8. REFERENCE A-300 DRAWING SERIES FOR SECTIONS;
9. REFERENCE A-400 DRAWING SERIES FOR ENLARGED PLANS;

GRAPHIC SCALE

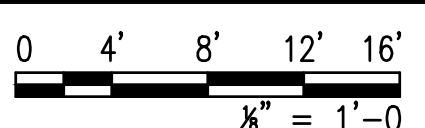


KEY PLAN

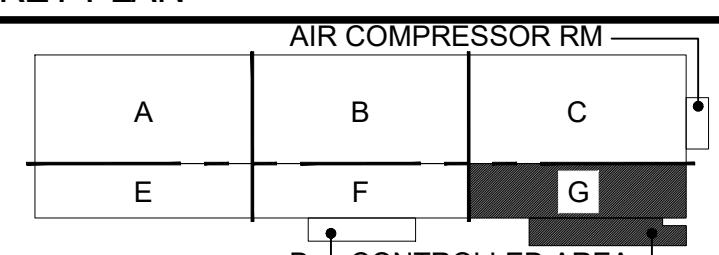

APPROVED		DATE	APPR
FOR COMMANDER NAVFAC			
APPROVED BY KYLE STRAUSBAUGH, NAVFAC HEAD DIRECTOR - PWD OCEANA, VA EMAIL			
SATISFACTORY TO DATE: 12/06/2022			
DES	JMT	DRW	JMT
PM/DM			EAU/CWJ
BRANCH MANAGER			CGM
CHIEF ENG/ARCH			EJA
FIRE PROTECTION			DSN
NAVAL FACILITIES ENGINEERING SYSTEMS COMMAND - MID-ATLANTIC NAVAL STATION - NORFOLK, VA			
NAVAL AIR STATION, OCEANA VIRGINIA BEACH, VA			
HANGAR 404 FIRE PROTECTION AND BUILDING ENVELOPE REPAIRS			
1st FLOOR CEILING DEMOLITION PLAN - AREA G			
SCALE: AS NOTED			
PROJECT NO.: 1372148			
CONSTR. CONTR. NO.			
NAVFAC DRAWING NO. 12851964			
SHEET 79 OF 382			
AD112			
DRAWING REVISION: 07 AUG 2018			

FILE NAME: C:\Users\rsnash\Desktop\1372148-AD113.dwg LAYOUT NAME: Layout1 PLOTTED: Tuesday, December 06, 2022 - 8:15am USER: rsnash

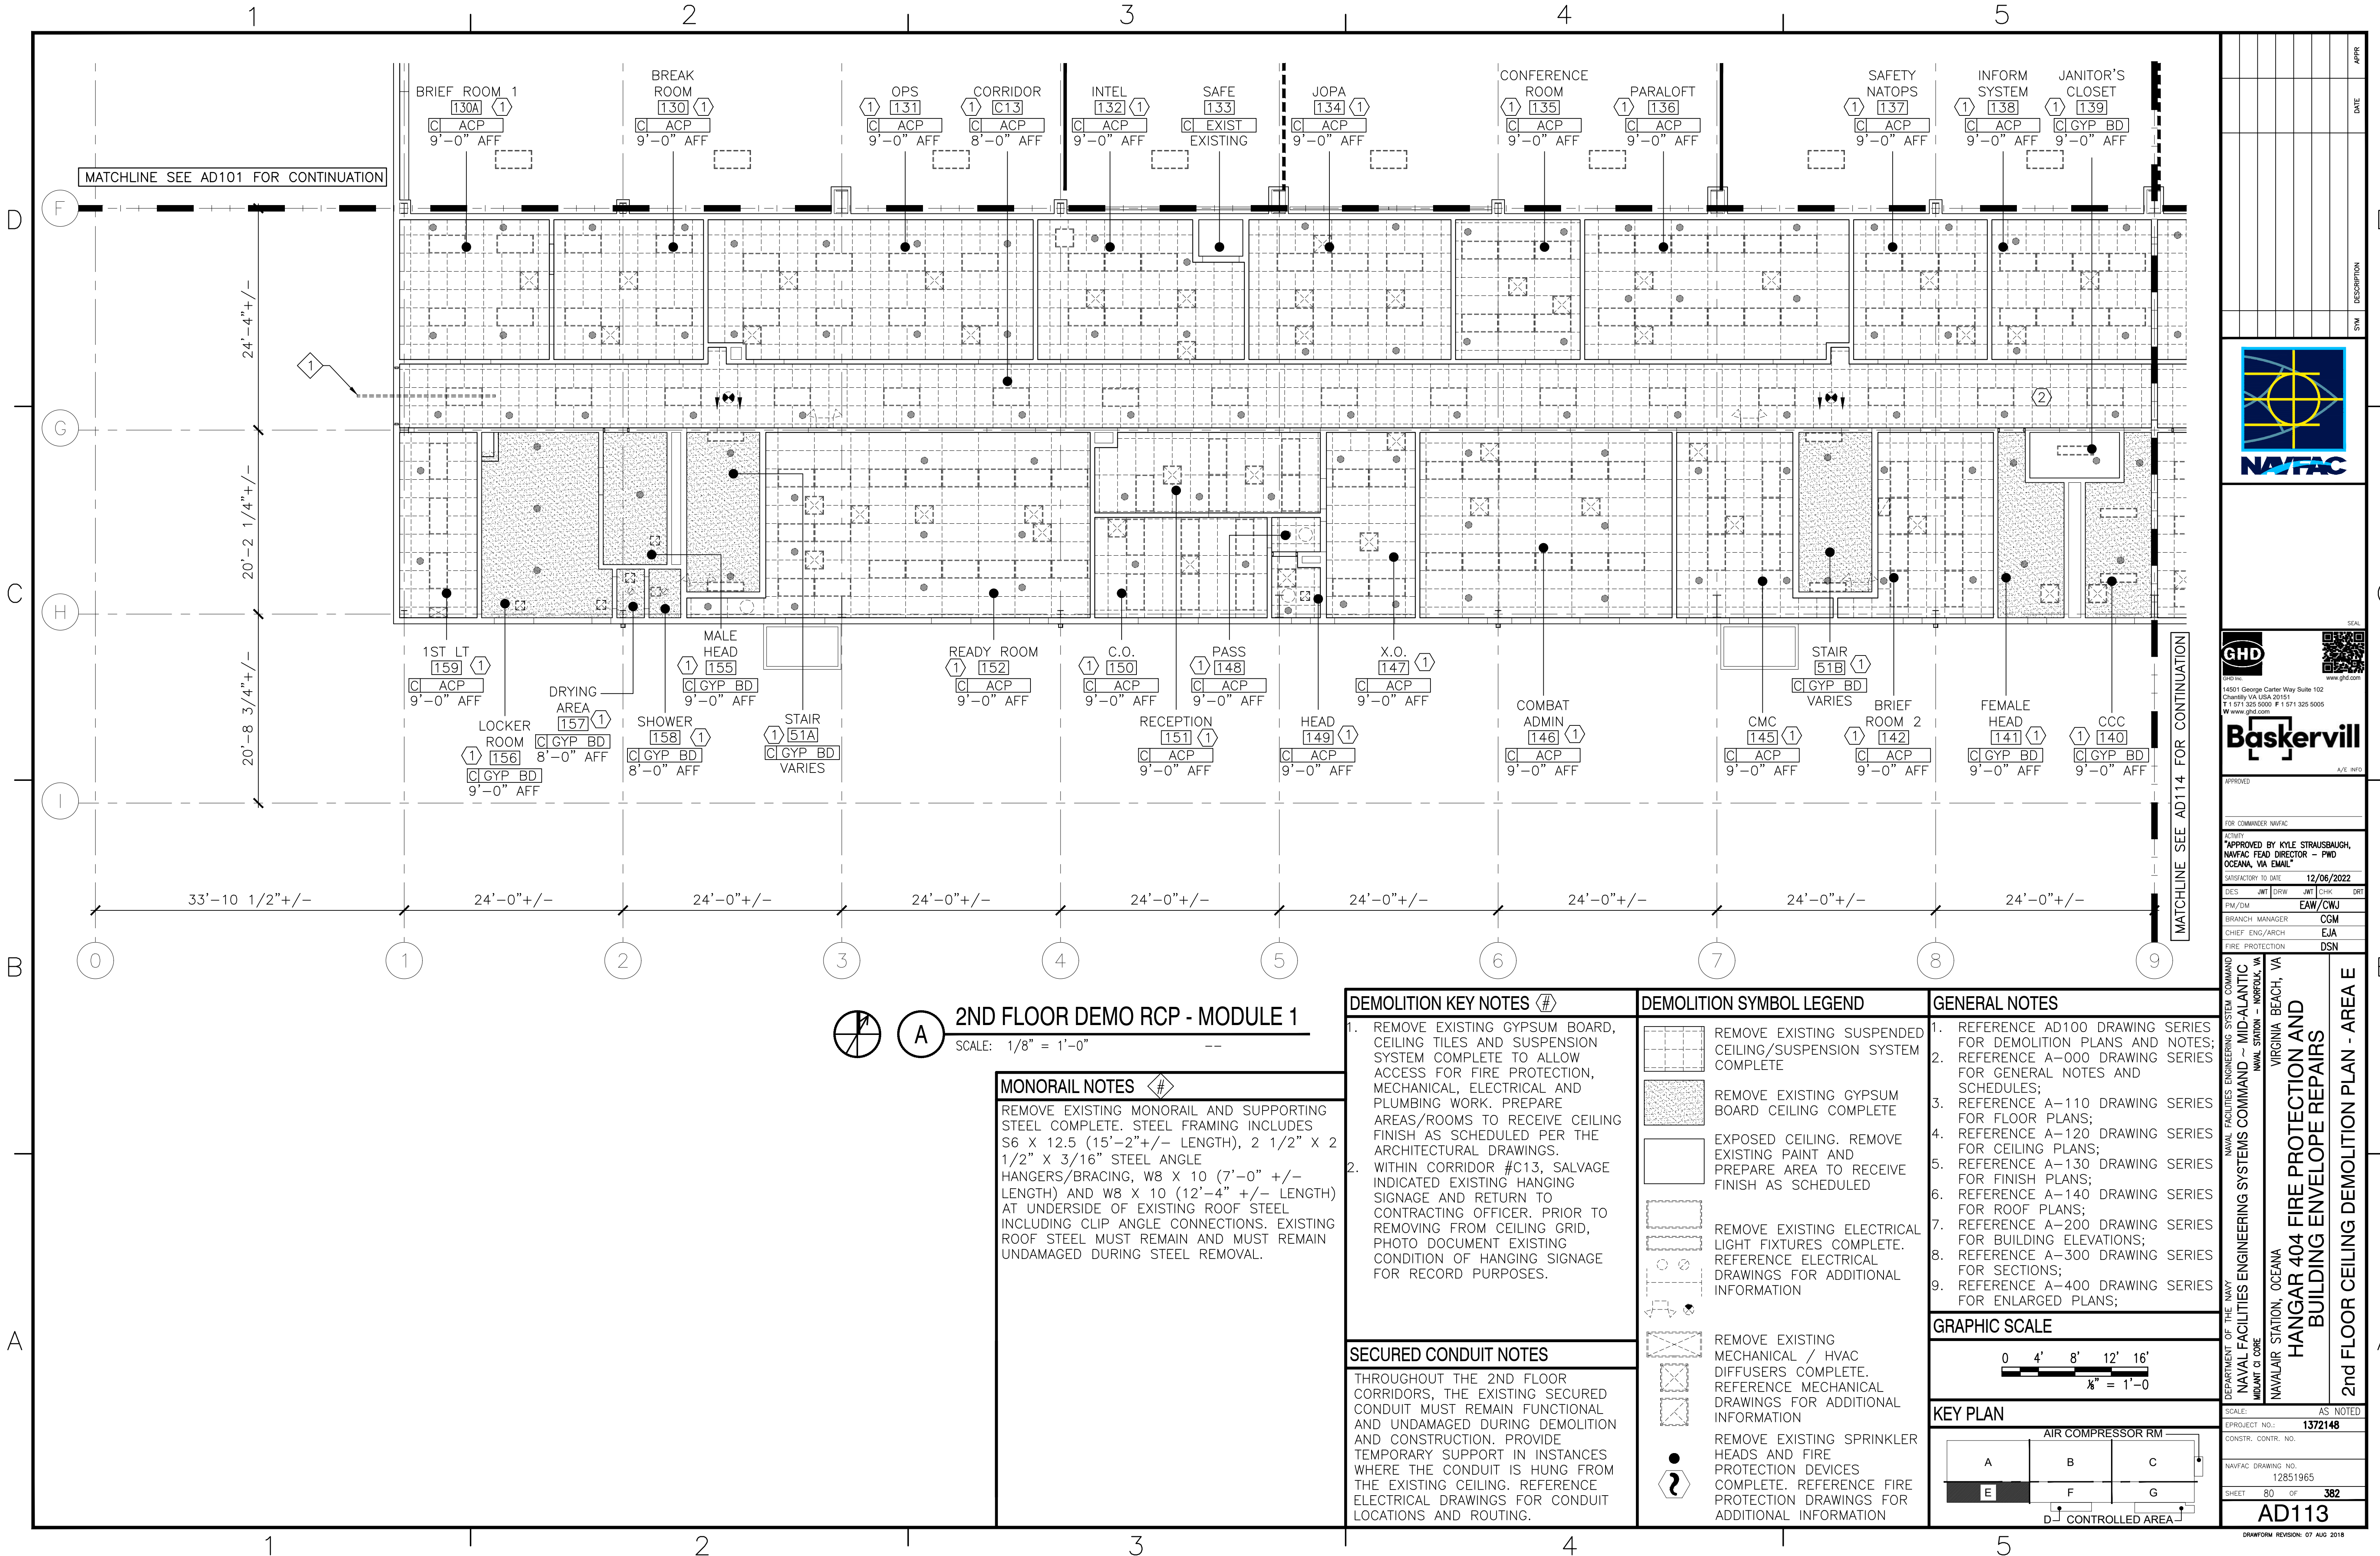

A

2ND FLOOR DEMO RCP - MODULE 1

SCALE: 1/8" = 1'-0"

MONORAIL NOTES

REMOVE EXISTING MONORAIL AND SUPPORTING STEEL COMPLETE. STEEL FRAMING INCLUDES S6 X 12.5 (15'-2" +/- LENGTH), 2 1/2" X 2 1/2" X 3/16" STEEL ANGLE HANGERS/BRACING, W8 X 10 (7'-0" +/- LENGTH) AND W8 X 10 (12'-4" +/- LENGTH) AT UNDERSIDE OF EXISTING ROOF STEEL INCLUDING CLIP ANGLE CONNECTIONS. EXISTING ROOF STEEL MUST REMAIN AND MUST REMAIN UNDAMAGED DURING STEEL REMOVAL.

DEMOLITION KEY NOTES

- REMOVE EXISTING GYPSUM BOARD, CEILING TILES AND SUSPENSION SYSTEM COMPLETE TO ALLOW ACCESS FOR FIRE PROTECTION, MECHANICAL, ELECTRICAL AND PLUMBING WORK. PREPARE AREAS/ROOMS TO RECEIVE CEILING FINISH AS SCHEDULED PER THE ARCHITECTURAL DRAWINGS.
- WITHIN CORRIDOR #C13, SALVAGE INDICATED EXISTING HANGING SIGNAGE AND RETURN TO CONTRACTING OFFICER. PRIOR TO REMOVING FROM CEILING GRID, PHOTO DOCUMENT EXISTING CONDITION OF HANGING SIGNAGE FOR RECORD PURPOSES.

SECURED CONDUIT NOTES

THROUGHOUT THE 2ND FLOOR CORRIDORS, THE EXISTING SECURED CONDUIT MUST REMAIN FUNCTIONAL AND UNDAMAGED DURING DEMOLITION AND CONSTRUCTION. PROVIDE TEMPORARY SUPPORT IN INSTANCES WHERE THE CONDUIT IS HUNG FROM THE EXISTING CEILING. REFERENCE ELECTRICAL DRAWINGS FOR CONDUIT LOCATIONS AND ROUTING.


DEMOLITION SYMBOL LEGEND

- REMOVE EXISTING SUSPENDED CEILING/SUSPENSION SYSTEM COMPLETE
- REMOVE EXISTING GYPSUM BOARD CEILING COMPLETE
- EXPOSED CEILING. REMOVE EXISTING PAINT AND PREPARE AREA TO RECEIVE FINISH AS SCHEDULED
- REMOVE EXISTING ELECTRICAL LIGHT FIXTURES COMPLETE. REFERENCE ELECTRICAL DRAWINGS FOR ADDITIONAL INFORMATION
- REMOVE EXISTING MECHANICAL / HVAC DIFFUSERS COMPLETE. REFERENCE MECHANICAL DRAWINGS FOR ADDITIONAL INFORMATION
- REMOVE EXISTING SPRINKLER HEADS AND FIRE PROTECTION DEVICES COMPLETE. REFERENCE FIRE PROTECTION DRAWINGS FOR ADDITIONAL INFORMATION


GENERAL NOTES

- REFERENCE AD100 DRAWING SERIES FOR DEMOLITION PLANS AND NOTES;
- REFERENCE A-000 DRAWING SERIES FOR GENERAL NOTES AND SCHEDULES;
- REFERENCE A-110 DRAWING SERIES FOR FLOOR PLANS;
- REFERENCE A-120 DRAWING SERIES FOR CEILING PLANS;
- REFERENCE A-130 DRAWING SERIES FOR FINISH PLANS;
- REFERENCE A-140 DRAWING SERIES FOR ROOF PLANS;
- REFERENCE A-200 DRAWING SERIES FOR BUILDING ELEVATIONS;
- REFERENCE A-300 DRAWING SERIES FOR SECTIONS;
- REFERENCE A-400 DRAWING SERIES FOR ENLARGED PLANS;

GRAPHIC SCALE

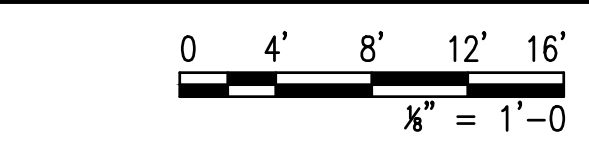


KEY PLAN

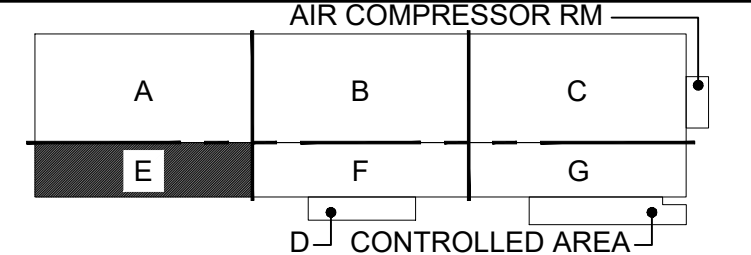

APPR	DATE	SYN	DESCRIPTION
APPROVED FOR COMMANDER NAVFAC			
APPROVED BY KYLE STRAUSSBAUGH, NAVFAC HEAD DIRECTOR - PWD OCEANA, VA EMAIL			
SATISFACTORY TO DATE: 12/06/2022			
DES	JMT	DRW	JMT
PM/DM			EAU/CWJ
BRANCH			CGM
CHIEF			EJA
FIRE PROTECTION			DSN
NAVAL FACILITIES ENGINEERING SYSTEMS COMMAND - MID-ATLANTIC NAVAL STATION - NORFOLK, VA			
VIRGINIA BEACH, VA			
NAVAL STATION, OCEANA			
HANGAR 404 FIRE PROTECTION AND BUILDING ENVELOPE REPAIRS			
2nd FLOOR CEILING DEMOLITION PLAN - AREA E			
SCALE: AS NOTED			
PROJECT NO.: 1372148			
CONSTR. CONTR. NO.			
NAVFAC DRAWING NO. 12851965			
SHEET 80 OF 382			
AD113			
DRAWING REVISION: 07 AUG 2018			

FILE NAME: C:\Users\rsnash\Desktop\404 Arch Dwg\1372148-AD114.dwg PLOTTED: Tuesday, December 06, 2022 - 8:15am USER: rsnash

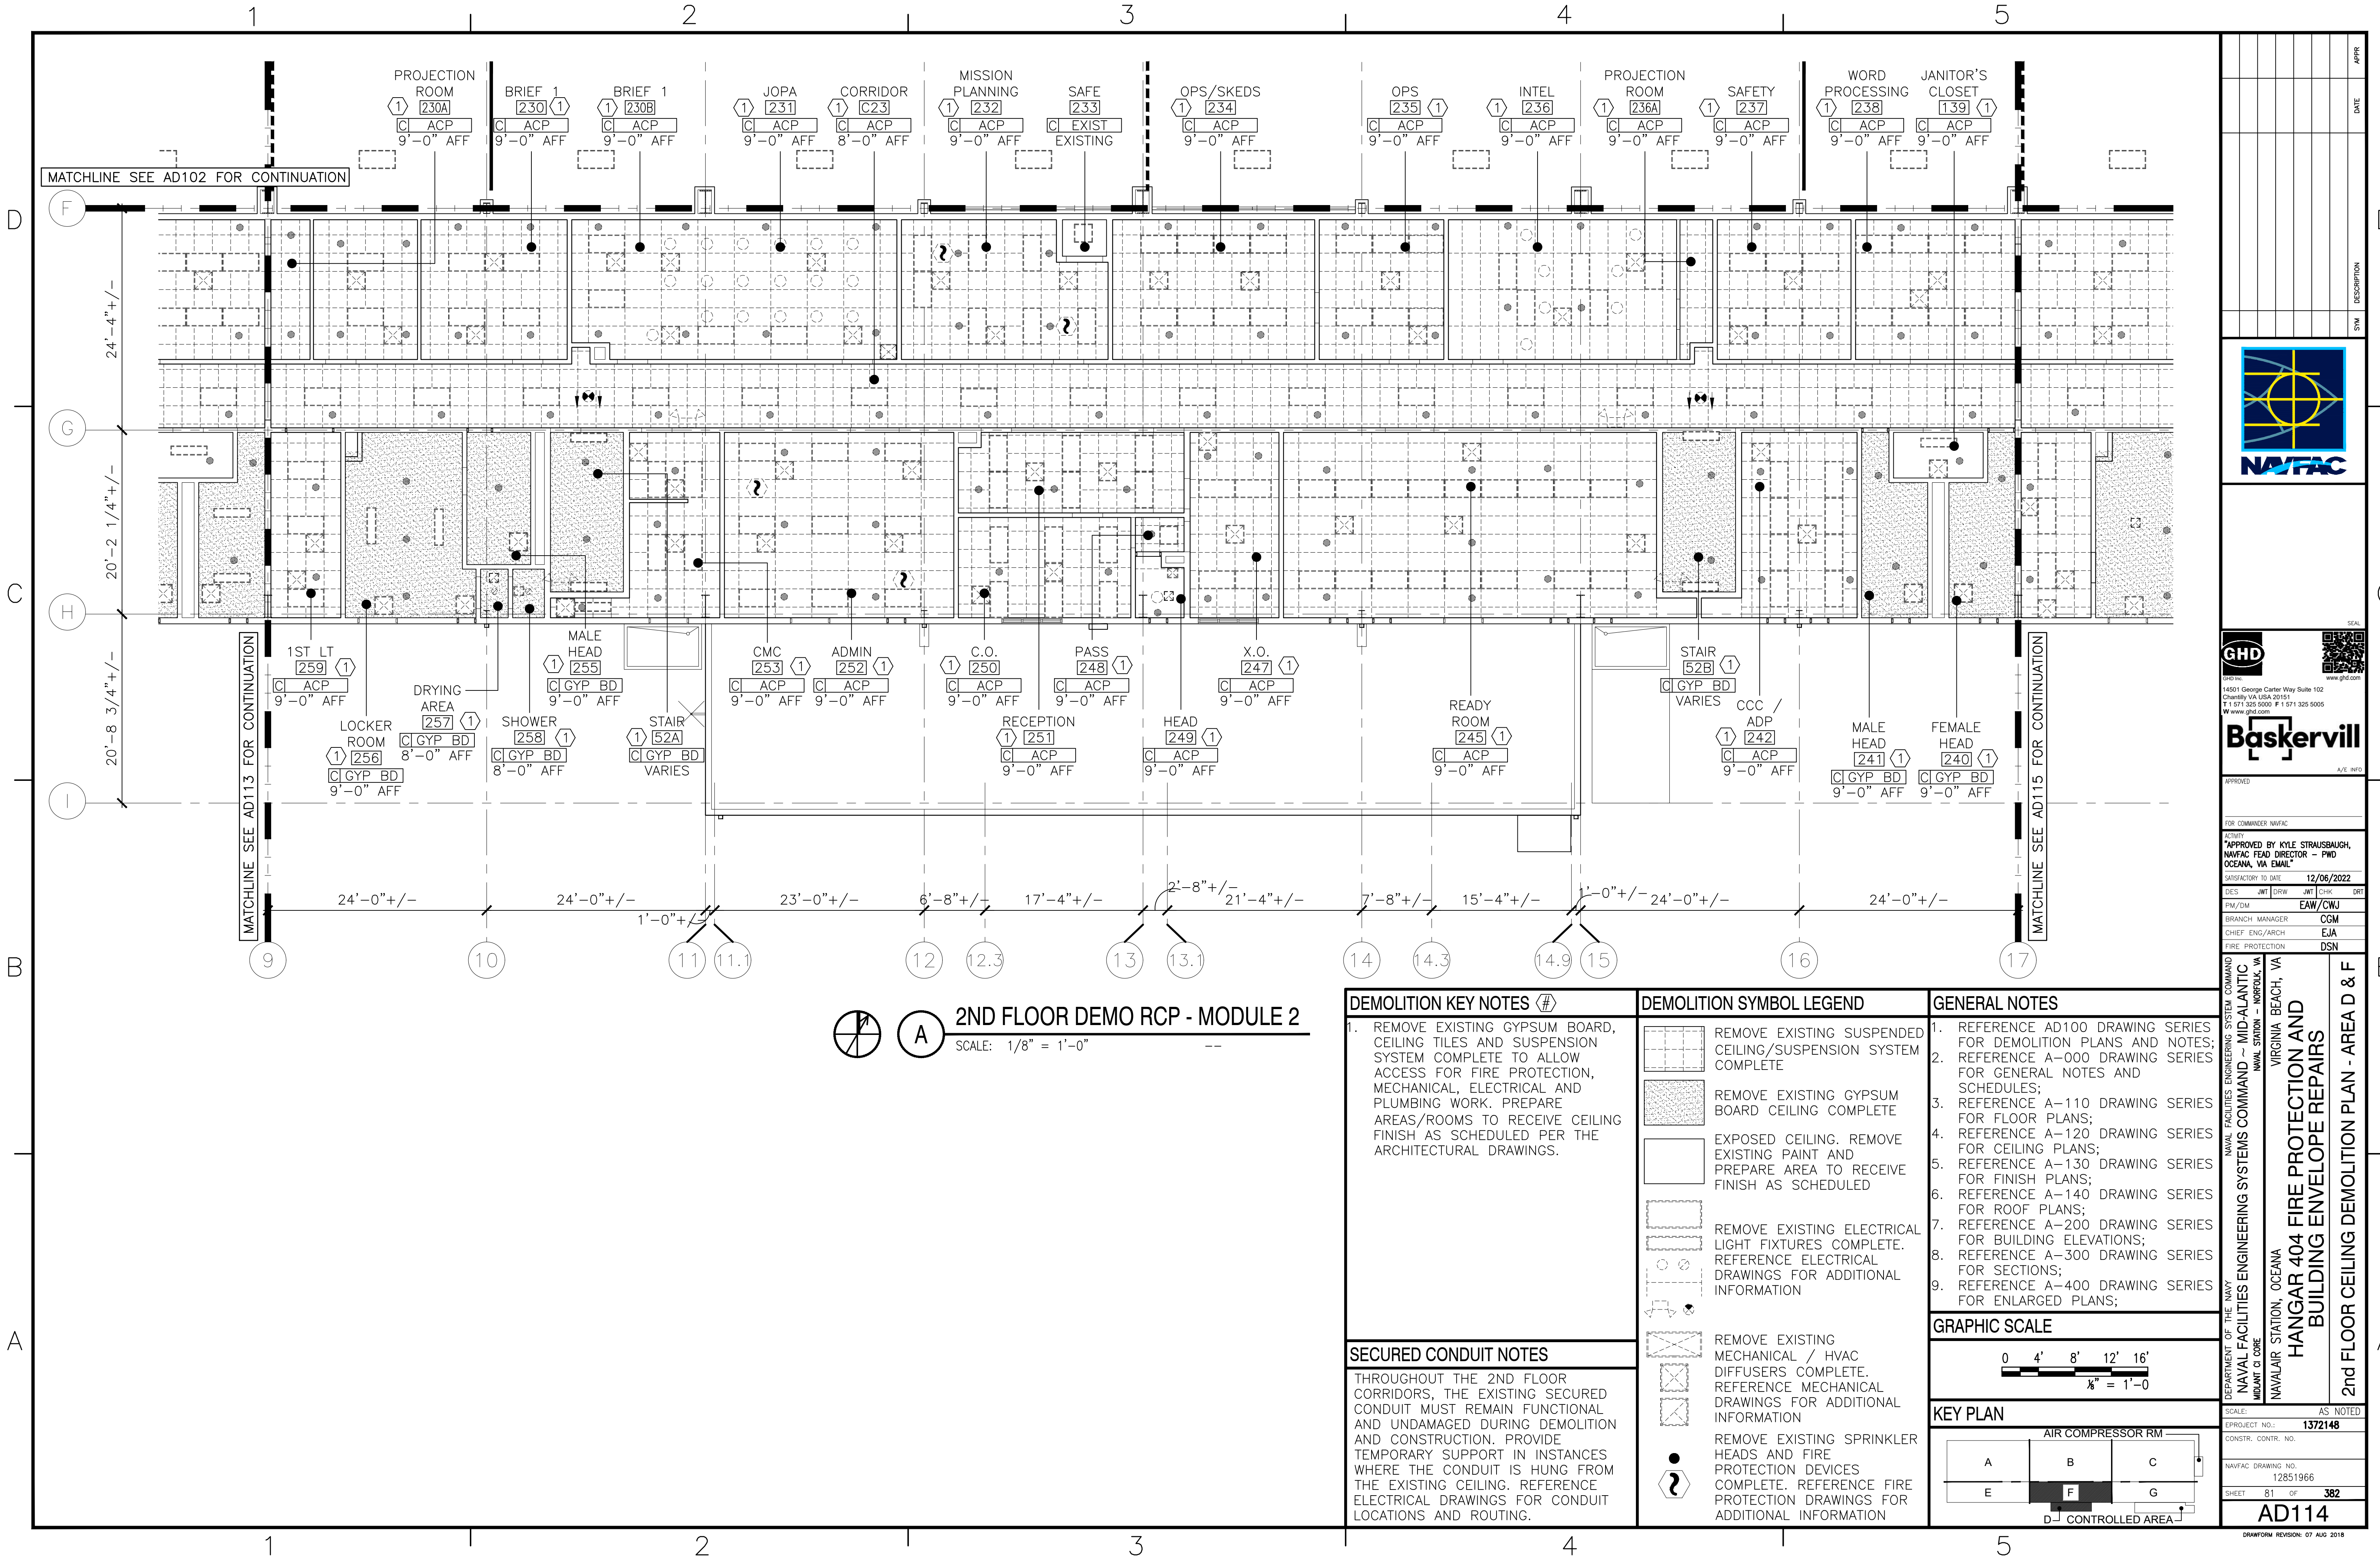

APPR	DATE
SYN	DESCRIPTION

NAVFAC

GHD

Baskervill

APPROVED

FOR COMMANDER NAVFAC

APPROVED BY KYLE STRAUSBAUGH,
NAVFAC HEAD DIRECTOR - PWD
OCEANA, VA EMAIL: [redacted]

SATISFACTORY TO DATE: 12/06/2022

DES	JMT	DRW	JWT	CHK	DRT
PM/DM					
BRANCH	MANAGER EAW/CWJ				
CHIEF	ENG/ARCH CGM				
FIRE PROTECTION	DSN				

DEPARTMENT OF THE NAVY
NAVAL FACILITIES ENGINEERING SYSTEMS COMMAND
NAVAL STATION - NORFOLK, VA
VIRGINIA BEACH, VA

HANGAR 404 FIRE PROTECTION AND
BUILDING ENVELOPE REPAIRS

2nd FLOOR CEILING DEMOLITION PLAN - AREA D & F

SCALE: AS NOTED

PROJECT NO.: 1372148

CONSTR. CONTR. NO.



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SHEET 81 OF 382

AD114

DRAWING REVISION: 07 AUG 2018

FILE NAME: C:\Users\rsash\Desktop\1372148-AD115.dwg PLOTTED: Tuesday, December 06, 2022 - 8:15am USER: rsash

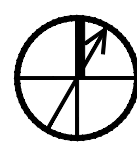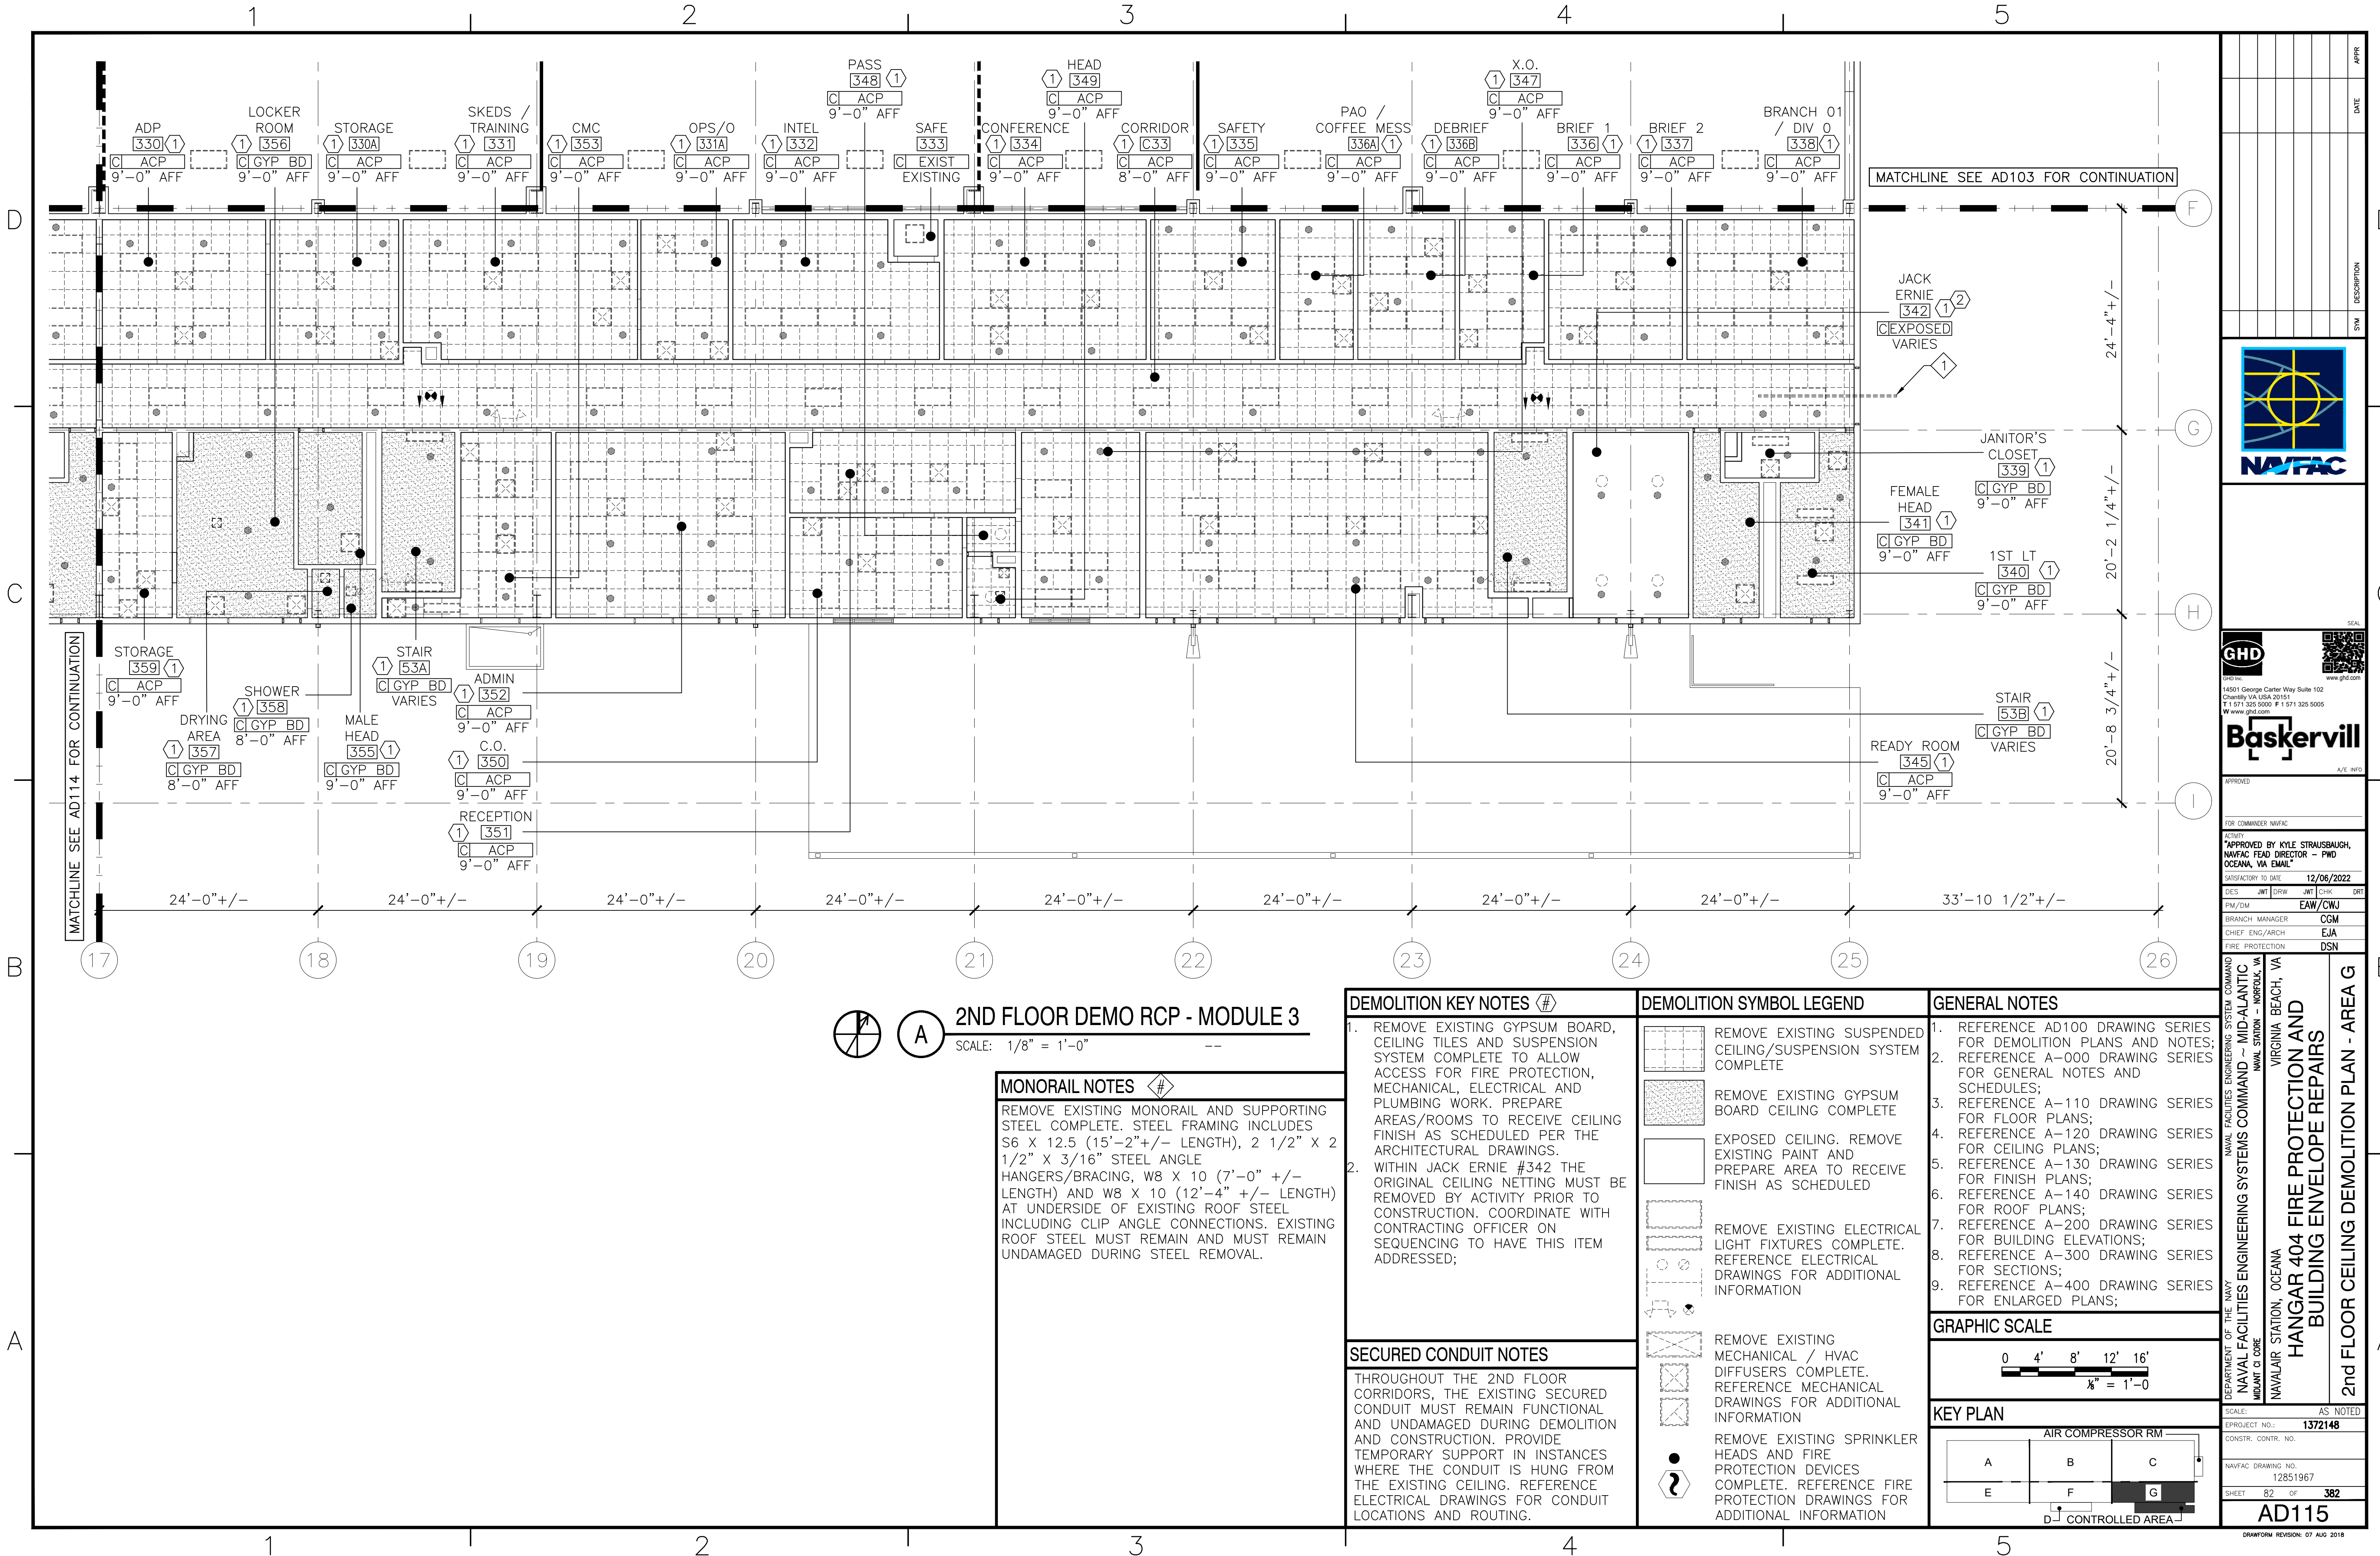

2ND FLOOR DEMO RCP - MODULE 3

SCALE: 1/8" = 1'-0"

MONORAIL NOTES

REMOVE EXISTING MONORAIL AND SUPPORTING STEEL COMPLETE. STEEL FRAMING INCLUDES S6 X 12.5 (15'-2" +/- LENGTH), 2 1/2" X 2 1/2" X 3/16" STEEL ANGLE HANGERS/BRACING, W8 X 10 (7'-0" +/- LENGTH) AND W8 X 10 (12'-4" +/- LENGTH) AT UNDERSIDE OF EXISTING ROOF STEEL INCLUDING CLIP ANGLE CONNECTIONS. EXISTING ROOF STEEL MUST REMAIN AND MUST REMAIN UNDAMAGED DURING STEEL REMOVAL.

SECURED CONDUIT NOTES

THROUGHOUT THE 2ND FLOOR CORRIDORS, THE EXISTING SECURED CONDUIT MUST REMAIN FUNCTIONAL AND UNDAMAGED DURING DEMOLITION AND CONSTRUCTION. PROVIDE TEMPORARY SUPPORT IN INSTANCES WHERE THE CONDUIT IS HUNG FROM THE EXISTING CEILING. REFERENCE ELECTRICAL DRAWINGS FOR CONDUIT LOCATIONS AND ROUTING.

DEMOLITION KEY NOTES

- REMOVE EXISTING GYPSUM BOARD, CEILING TILES AND SUSPENSION SYSTEM COMPLETE TO ALLOW ACCESS FOR FIRE PROTECTION, MECHANICAL, ELECTRICAL AND PLUMBING WORK. PREPARE AREAS/ROOMS TO RECEIVE CEILING FINISH AS SCHEDULED PER THE ARCHITECTURAL DRAWINGS.
- WITHIN JACK ERNIE #342 THE ORIGINAL CEILING NETTING MUST BE REMOVED BY ACTIVITY PRIOR TO CONSTRUCTION. COORDINATE WITH CONTRACTING OFFICER ON SEQUENCING TO HAVE THIS ITEM ADDRESSED;


DEMOLITION SYMBOL LEGEND

- REMOVE EXISTING SUSPENDED CEILING/SUSPENSION SYSTEM COMPLETE
- REMOVE EXISTING GYPSUM BOARD CEILING COMPLETE
- EXPOSED CEILING. REMOVE EXISTING PAINT AND PREPARE AREA TO RECEIVE FINISH AS SCHEDULED
- REMOVE EXISTING ELECTRICAL LIGHT FIXTURES COMPLETE. REFERENCE ELECTRICAL DRAWINGS FOR ADDITIONAL INFORMATION
- REMOVE EXISTING MECHANICAL / HVAC DIFFUSERS COMPLETE. REFERENCE MECHANICAL DRAWINGS FOR ADDITIONAL INFORMATION
- REMOVE EXISTING SPRINKLER HEADS AND FIRE PROTECTION DEVICES COMPLETE. REFERENCE FIRE PROTECTION DRAWINGS FOR ADDITIONAL INFORMATION


GENERAL NOTES

- REFERENCE AD100 DRAWING SERIES FOR DEMOLITION PLANS AND NOTES;
- REFERENCE A-000 DRAWING SERIES FOR GENERAL NOTES AND SCHEDULES;
- REFERENCE A-110 DRAWING SERIES FOR FLOOR PLANS;
- REFERENCE A-120 DRAWING SERIES FOR CEILING PLANS;
- REFERENCE A-130 DRAWING SERIES FOR FINISH PLANS;
- REFERENCE A-140 DRAWING SERIES FOR ROOF PLANS;
- REFERENCE A-200 DRAWING SERIES FOR BUILDING ELEVATIONS;
- REFERENCE A-300 DRAWING SERIES FOR SECTIONS;
- REFERENCE A-400 DRAWING SERIES FOR ENLARGED PLANS;

GRAPHIC SCALE

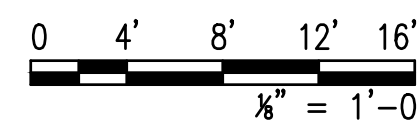


KEY PLAN

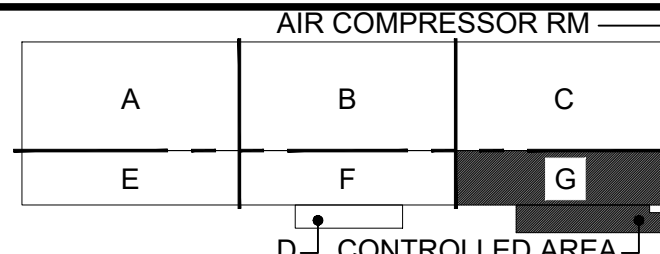

APPROVED	DATE	APPR
FOR COMMANDER NAVFAC		
APPROVED BY KYLE STRAUSBAUGH, NAVFAC HEAD DIRECTOR - PWD OCEANA, VA EMAIL		
SATISFACTORY TO DATE	12/06/2022	
DES	JMT	DRW
PM/DM	EAJ	CHK
BRANCH	MANAGER	CGM
CHIEF	ENG/ARCH	EJA
FIRE PROTECTION	DSN	
NAVAL FACILITIES ENGINEERING SYSTEMS COMMAND - MID-ATLANTIC NAVAL STATION - NORFOLK, VA		
VIRGINIA BEACH, VA		
HANGAR 404 FIRE PROTECTION AND BUILDING ENVELOPE REPAIRS		
2nd FLOOR CEILING DEMOLITION PLAN - AREA G		
SCALE: AS NOTED		
PROJECT NO.: 1372148		
CONSTR. CONTR. NO.		
NAVFAC DRAWING NO. 12851967		
SHEET 82 OF 382		
AD115		
DRAWING REVISION: 07 AUG 2018		

FILE NAME: \\gdrnet\gnd\US\Chantilly\Projects\585\1120348\Digital_Design\1 - CAD\3.1.2 - Sheet\05b - Architectural\2022 11 18 Final\137248-A-111.dwg LAYOUT NAME: Layout1 PLOTTED: Monday, December 05, 2022 - 1:40pm USER: ns0ah

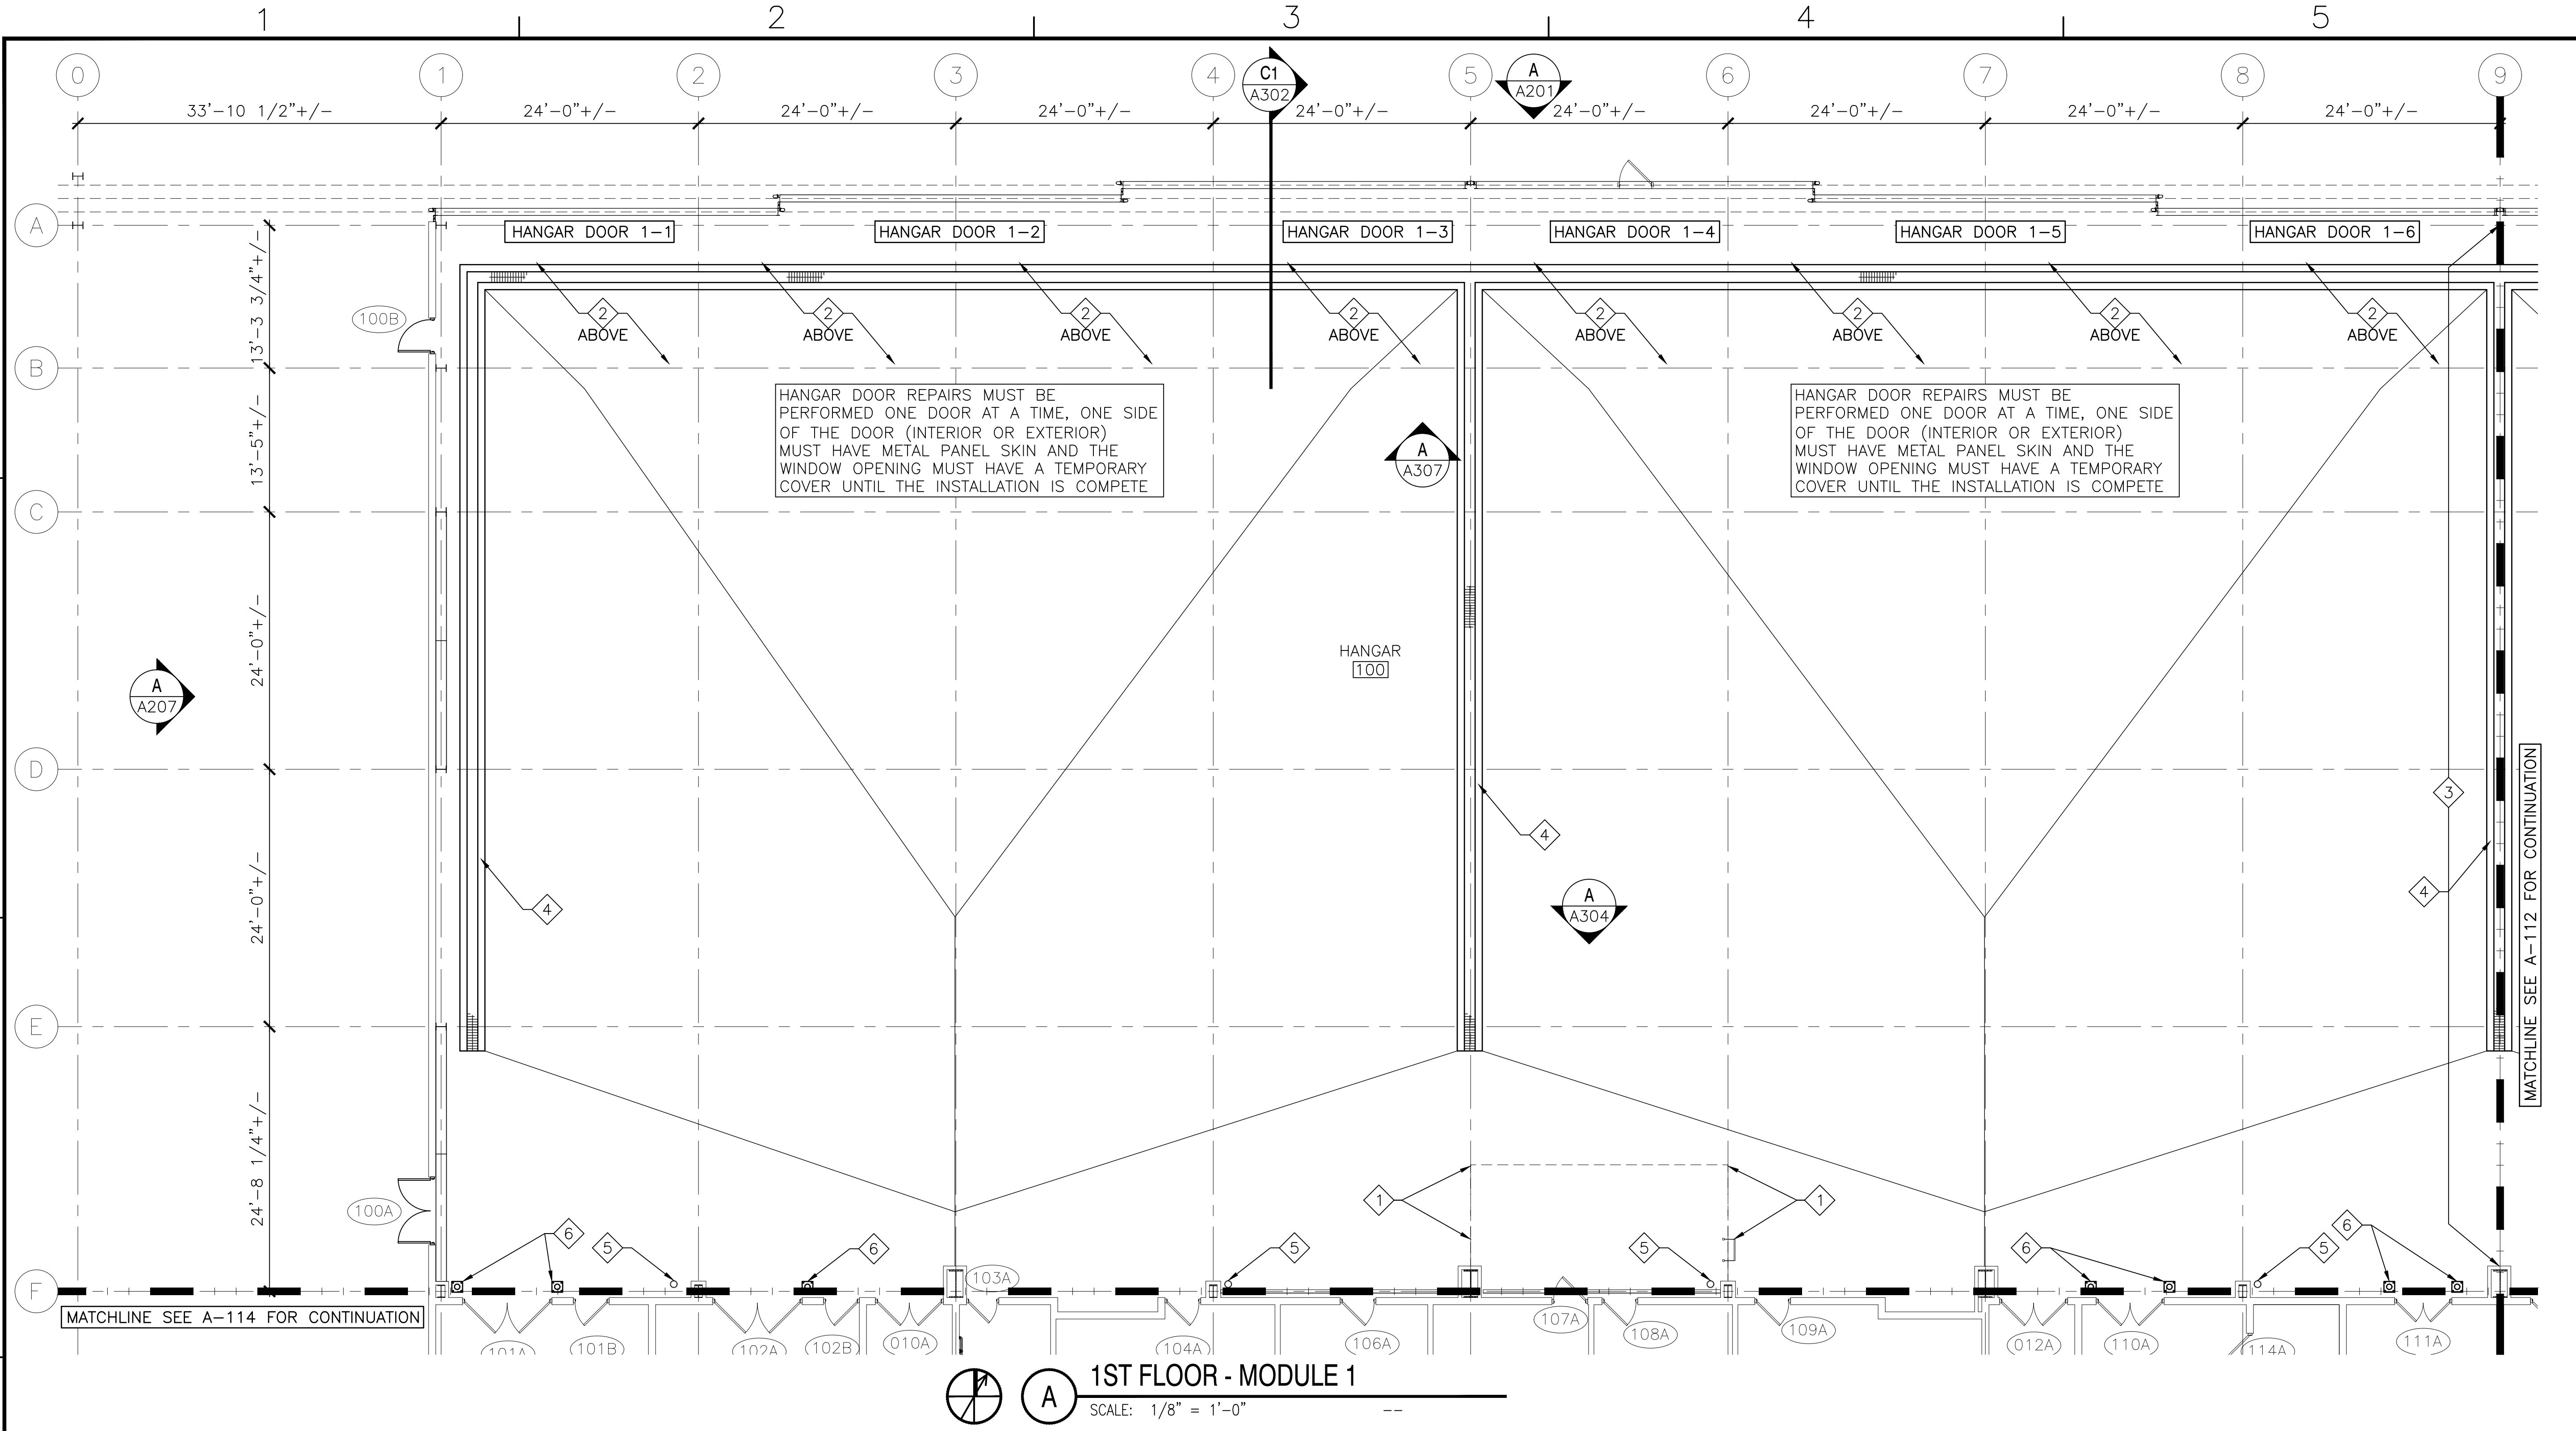

KEY NOTES	HANGAR DOOR REPAIR NOTES	DOOR REPLACEMENT NOTES	GENERAL NOTES	GRAPHIC SCALE
<div>1. EXISTING ELEVATED PLATFORM AND ACCESS LADDER MUST REMAIN. RE-ATTCH LADDER TO CONCRETE SLAB WITH TWO DRILLED ANCHOR BOLTS SET IN EPOXY.</div> <div>2. REPLACE EXISTING BATT INSULATION WITH 1-INCH INSULATED METAL LINER PANEL. LINER PANEL MUST EXTEND FROM COLUMN LINE 'B' TO EXTERIOR WALL BEYOND COLUMN LINE 'A' AND BETWEEN COLUMN LINE '1' TO COLUMN LINE '25'. REFERENCE DETAIL 'A3' ON SHEET A-311 FOR DETAILS, SIZE, COLOR AND PROFILE.</div> <div>3. PROVIDE TEMPORARY DUST AND SOUND PARTITION WALL AT THE ONSET OF EACH SEQUENCE OF CONSTRUCTION. REFERENCE SPECIFICATION - SUMMARY OF WORK FOR ADDITIONAL SEQUENCING INFORMATION. REFERENCE WALL SECTION 'A2' ON SHEET A-021 FOR WALL SECTION AND DETAILS.</div> <div>4. EXISTING FLOOR TRENCHING SYSTEM.</div> <div>5. REMOVE AND REPLACE CAST IRON RAIN LEADER. REFERENCE ROOF DRAWINGS FOR ADDITIONAL INFORMATION AND DETAILS. REFERENCE PLUMBING DRAWINGS FOR ADDITIONAL INFORMATION, CLEAN-OUTS AND CONNECTIONS.</div> <div>6. PIPE BOLLARD. REFERENCE DETAIL A2 ON DRAWING A-114.</div>	<div>1. EXISTING HANGAR DOOR MUST REMAIN IN PLACE WHILE WORK OCCURS. PAINT EXISTING STEEL DOOR FRAME STRUCTURE PER INTERIOR STEEL PAINT SPECIFICATION. ADD INSULATED TRANSLUCENT PANELS (8'-0" HIGH X 32'-0" WIDE) ONTO STEEL STRUCTURE. PROVIDE R-15 RIGID FOIL FACED MINERAL FIBER INSULATION WITHIN STEEL DOOR STRUCTURE FULL WIDTH AND FULL HEIGHT ABOVE AND BELOW INSULATED TRANSLUCENT PANELS. PROVIDE MOTOR AND CONTROLS; REFERENCE ELECTRICAL DRAWINGS FOR ADDITIONAL INFORMATION. PROVIDE ACCESS PANEL FOR MOTOR AND CONTROLS WITH HINGES, LOCK AND LEVER. PROVIDE INTERIOR AND EXTERIOR METAL PANELS WITH EXPOSED FASTENERS, ACCESSORIES, SEALANTS, TRIM AND FLASHING. EXISTING PERSONNEL DOOR MUST REMAIN IN PLACE AND UNDAMAGED FOR THE DURATION OF CONSTRUCTION. CLEAN HANGAR DOOR TRACKS AND REMOVE DEBRIS COMPLETE. PROVIDE DOOR SWEEPERS AND CLEANERS TO THE BOTTOM OF EACH HANGAR DOOR. REFERENCE ARCHITECTURAL DRAWING A-311 FOR ADDITIONAL HANGAR DOOR DETAILS.</div>	<div>1. REMOVE AND REPLACE EXISTING DOORS, FASTENERS, SEALANT AND DOOR HARDWARE COMPLETE AS SCHEDULED. CLEAN, PATCH AND PREPARE EXISTING DOOR FRAMES TO RECEIVE DOOR AND HARDWARE ASSEMBLY. REFERENCE ARCHITECTURAL FLOOR PLANS AND DOOR SCHEDULES FOR ADDITIONAL INFORMATION. REFERENCE ENVIRONMENTAL DOCUMENTS FOR ADDITIONAL INFORMATION.</div>	<div>1. REFERENCE AD100 DRAWING SERIES FOR DEMOLITION PLANS AND NOTES;</div> <div>2. REFERENCE A-000 DRAWING SERIES FOR GENERAL NOTES AND SCHEDULES;</div> <div>3. REFERENCE A-110 DRAWING SERIES FOR FLOOR PLANS;</div> <div>4. REFERENCE A-120 DRAWING SERIES FOR CEILING PLANS;</div> <div>5. REFERENCE A-130 DRAWING SERIES FOR FINISH PLANS;</div> <div>6. REFERENCE A-140 DRAWING SERIES FOR ROOF PLANS;</div> <div>7. REFERENCE A-200 DRAWING SERIES FOR BUILDING ELEVATIONS;</div> <div>8. REFERENCE A-300 DRAWING SERIES FOR SECTIONS;</div> <div>9. REFERENCE A-400 DRAWING SERIES FOR ENLARGED PLANS;</div>	<div>0 4' 8' 12' 16'</div> <div>$\frac{1}{8}" = 1'-0"$</div>
<div>KEY PLAN</div> <div><div>AIR COMPRESSOR RM</div><div>CONTROLLED AREA</div></div>				

APPR

DATE

DESCRIPTION

SYM

GHD

GHD Inc.

14501 George Carter Way Suite 102
Chantilly VA USA 20151
T 1 571 325 5000 F 1 571 325 5005
W www.ghd.com

Baskervill

A/E 1670

APPROVED

FOR COMMANDER NAVFAC

APPROVED BY KYLE STRAUSBAUGH,
NAVFAC FEAD DIRECTOR - PWD
OCEANA, VA EMAIL

SATISFACTORY TO DATE 12/06/2022

DES JMT DRW JMT CHK DRT

PM/DM EAW/CWJ

BRANCH MANAGER CGM

CHIEF ENG/ARCH EJA

FIRE PROTECTION DSN

NAVAL FACILITIES ENGINEERING SYSTEMS COMMAND
NAVFAC FACILITIES ENGINEERING SYSTEMS COMMAND - MID-ATLANTIC
NAVAL STATION - NORFOLK, VA

VIRGINIA BEACH, VA

NAVAL STATION, OCEANA

DEPARTMENT OF THE NAVY

NAVFAC

NAVFAC DRAWING NO. 12821684

SHEET 83 OF 382

A-111


AS NOTED

1372148

CONSTR. CONTR. NO.

12821684


07 AUG 2018

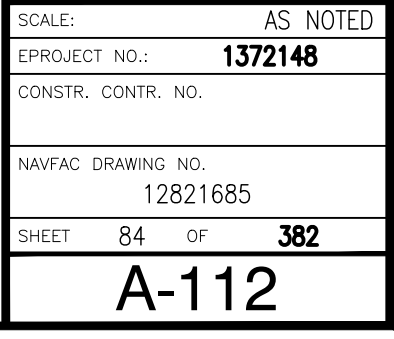

SCALE:	AS NOTED
EPROJECT NO.:	1372148
CONSTR. CONTR. NO.	
NAVFAC DRAWING NO.	12821685
SHEET	84 OF 382
A-112	



FILE NAME: \\gdn\gnd\US\Chantilly\Projects\585\1120348\Digital_Design\1 - CAD\3.1.2 - Sheet\05b - Architectural\2022 11 18 Final\1372 48-A-114.dwg LAYOUT NAME: Layout1 PLOTTED: Monday, December 05, 2022 - 1:41pm USER: msah

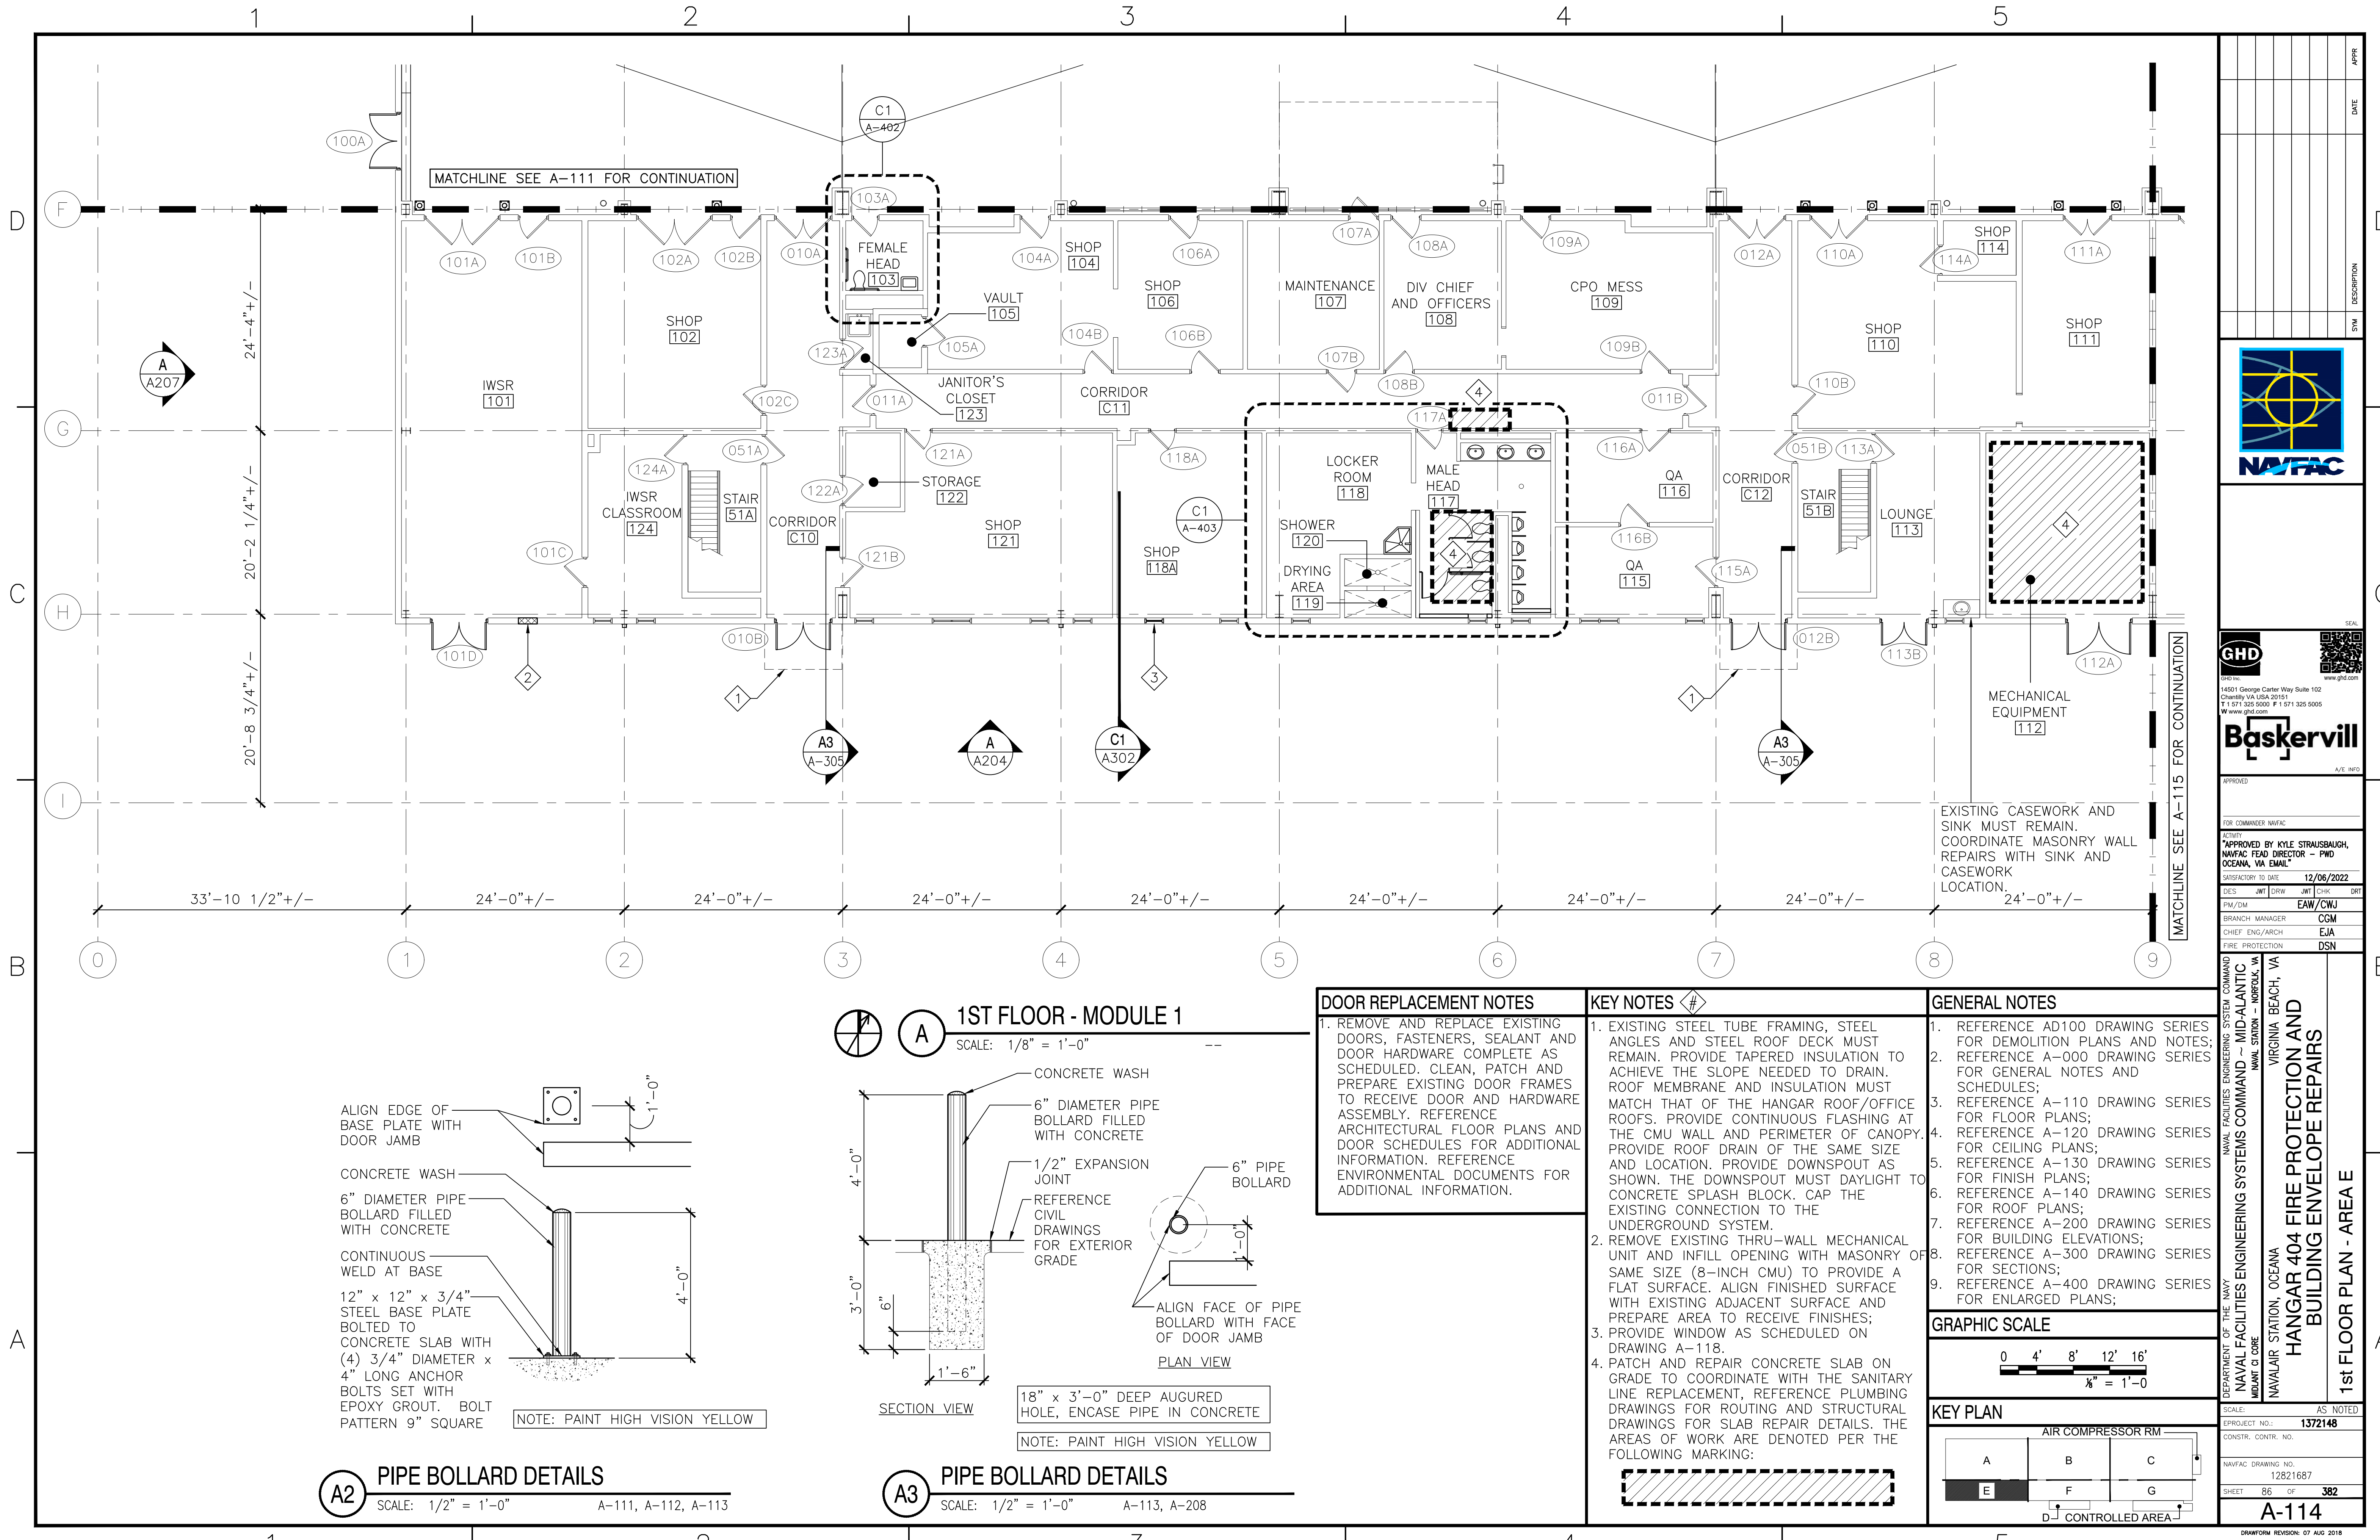

APPR	DATE
SYN	DESCRIPTION

NAVFAC

GHD

Baskervill

APPROVED

FOR COMMANDER NAVFAC

APPROVED BY KYLE STRAUSBAUGH,
NAVFAC HEAD DIRECTOR - PWD
OCEANA, VA EMAIL

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PM/DM				EAJ/CWJ	
BRANCH	MANAGER CGM				
CHIEF	ENG/ARCH EJA				
FIRE PROTECTION	DSN				

DEPARTMENT OF THE NAVY
NAVAL FACILITIES ENGINEERING SYSTEMS COMMAND
NAVAL STATION - NORFOLK, VA
VIRGINIA BEACH, VA

HANGAR 404 FIRE PROTECTION AND
BUILDING ENVELOPE REPAIRS

1st FLOOR PLAN - AREA E

SCALE: AS NOTED

PROJECT NO.: 1372148

CONSTR. CONTR. NO.


NAVFAC DRAWING NO. 12821687

SHEET 86 OF 382

A-114

DRAWING REVISION: 07 AUG 2018

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A

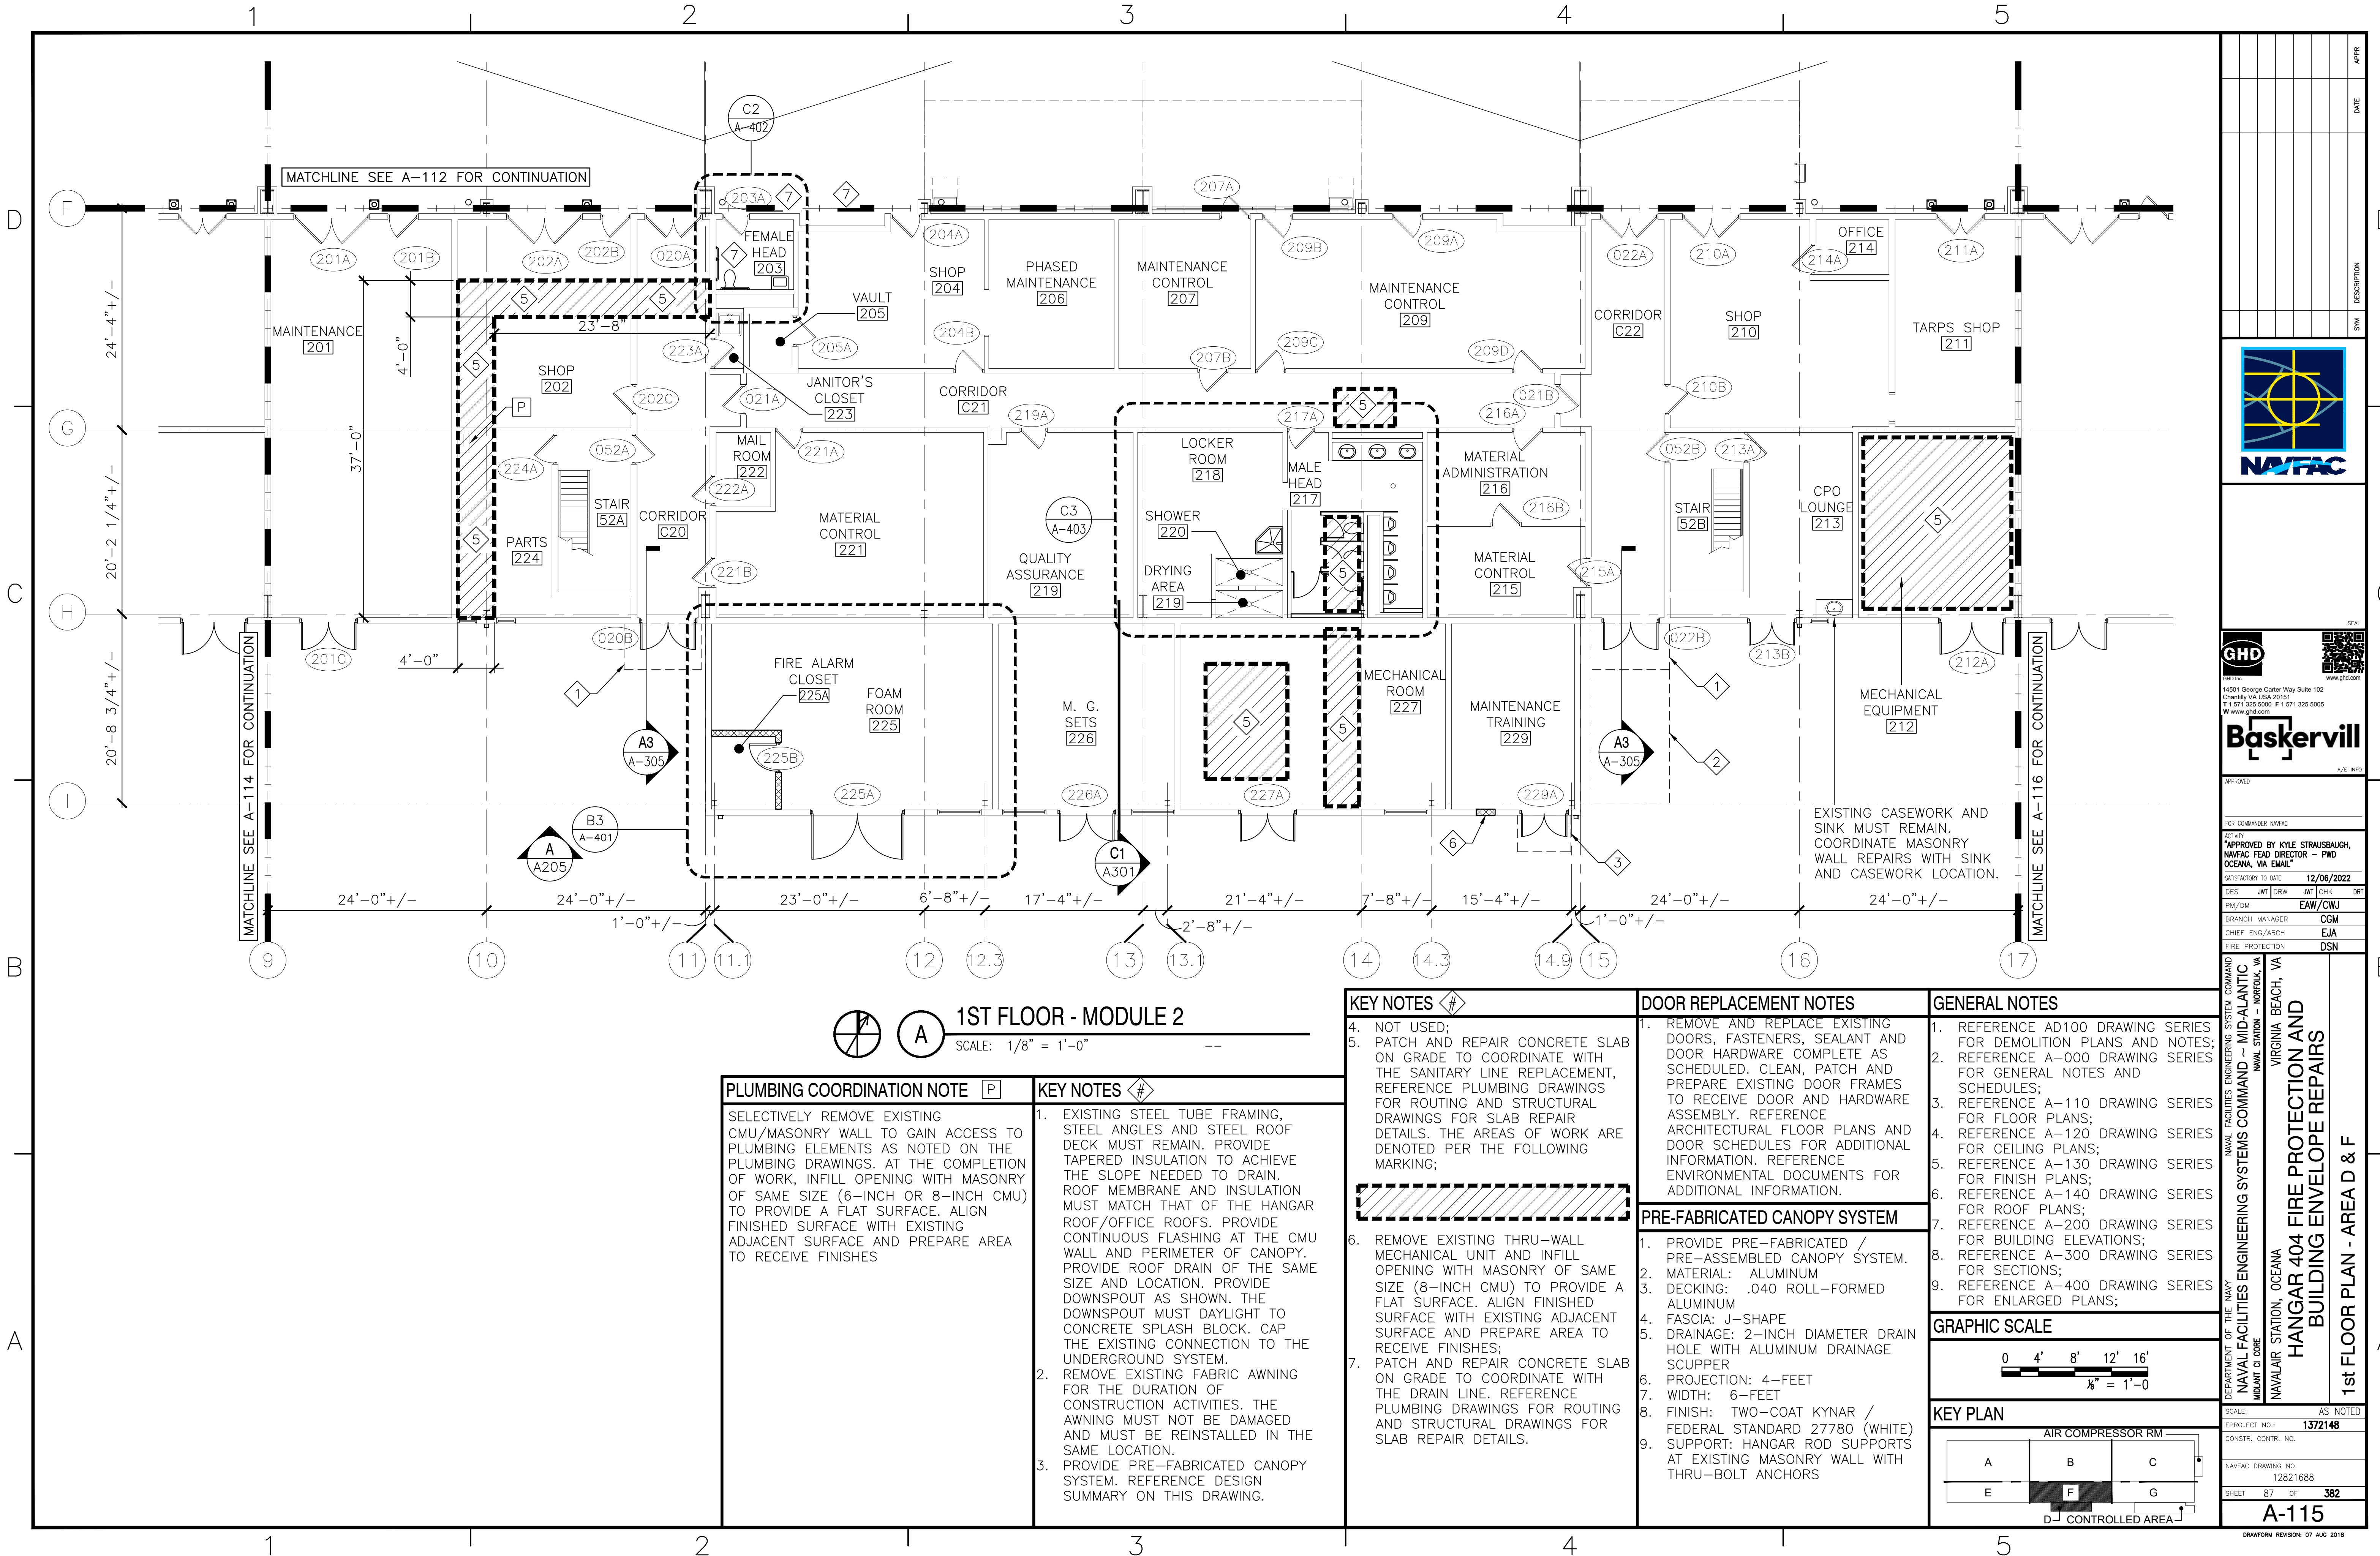1ST FLOOR - MODULE 2

SCALE: 1/8" = 1'-0"

PLUMBING COORDINATION NOTE [P]

SELECTIVELY REMOVE EXISTING CMU/MASONRY WALL TO GAIN ACCESS TO PLUMBING ELEMENTS AS NOTED ON THE PLUMBING DRAWINGS. AT THE COMPLETION OF WORK, INFILL OPENING WITH MASONRY OF SAME SIZE (6-INCH OR 8-INCH CMU) TO PROVIDE A FLAT SURFACE. ALIGN FINISHED SURFACE WITH EXISTING ADJACENT SURFACE AND PREPARE AREA TO RECEIVE FINISHES

KEY NOTES [N]

- EXISTING STEEL TUBE FRAMING, STEEL ANGLES AND STEEL ROOF DECK MUST REMAIN. PROVIDE TAPERED INSULATION TO ACHIEVE THE SLOPE NEEDED TO DRAIN. ROOF MEMBRANE AND INSULATION MUST MATCH THAT OF THE HANGAR ROOF/OFFICE ROOFS. PROVIDE CONTINUOUS FLASHING AT THE CMU WALL AND PERIMETER OF CANOPY. PROVIDE ROOF DRAIN OF THE SAME SIZE AND LOCATION. PROVIDE DOWNSPOUT AS SHOWN. THE DOWNSPOUT MUST DAYLIGHT TO CONCRETE SPLASH BLOCK. CAP THE EXISTING CONNECTION TO THE UNDERGROUND SYSTEM.
- REMOVE EXISTING FABRIC AWNING FOR THE DURATION OF CONSTRUCTION ACTIVITIES. THE AWNING MUST NOT BE DAMAGED AND MUST BE REINSTALLED IN THE SAME LOCATION.
- PROVIDE PRE-FABRICATED CANOPY SYSTEM. REFERENCE DESIGN SUMMARY ON THIS DRAWING.

KEY NOTES [N]

- NOT USED;
- PATCH AND REPAIR CONCRETE SLAB ON GRADE TO COORDINATE WITH THE SANITARY LINE REPLACEMENT, REFERENCE PLUMBING DRAWINGS FOR ROUTING AND STRUCTURAL DRAWINGS FOR SLAB REPAIR DETAILS. THE AREAS OF WORK ARE DENOTED PER THE FOLLOWING MARKING;
- REMOVE EXISTING THRU-WALL MECHANICAL UNIT AND INFILL OPENING WITH MASONRY OF SAME SIZE (8-INCH CMU) TO PROVIDE A FLAT SURFACE. ALIGN FINISHED SURFACE WITH EXISTING ADJACENT SURFACE AND PREPARE AREA TO RECEIVE FINISHES;
- PATCH AND REPAIR CONCRETE SLAB ON GRADE TO COORDINATE WITH THE DRAIN LINE. REFERENCE PLUMBING DRAWINGS FOR ROUTING AND STRUCTURAL DRAWINGS FOR SLAB REPAIR DETAILS.

DOOR REPLACEMENT NOTES

- REMOVE AND REPLACE EXISTING DOORS, FASTENERS, SEALANT AND DOOR HARDWARE COMPLETE AS SCHEDULED. CLEAN, PATCH AND PREPARE EXISTING DOOR FRAMES TO RECEIVE DOOR AND HARDWARE ASSEMBLY. REFERENCE ARCHITECTURAL FLOOR PLANS AND DOOR SCHEDULES FOR ADDITIONAL INFORMATION. REFERENCE ENVIRONMENTAL DOCUMENTS FOR ADDITIONAL INFORMATION.


PRE-FABRICATED CANOPY SYSTEM

- PROVIDE PRE-FABRICATED / PRE-ASSEMBLED CANOPY SYSTEM.
- MATERIAL: ALUMINUM
- DECKING: .040 ROLL-FORMED ALUMINUM
- FASCIA: J-SHAPE
- DRAINAGE: 2-INCH DIAMETER DRAIN HOLE WITH ALUMINUM DRAINAGE SCUPPER
- PROJECTION: 4- FEET
- WIDTH: 6- FEET
- FINISH: TWO-COAT KYNAR / FEDERAL STANDARD 27780 (WHITE)
- SUPPORT: HANGAR ROD SUPPORTS AT EXISTING MASONRY WALL WITH THRU-BOLT ANCHORS


GENERAL NOTES

- REFERENCE AD100 DRAWING SERIES FOR DEMOLITION PLANS AND NOTES;
- REFERENCE A-000 DRAWING SERIES FOR GENERAL NOTES AND SCHEDULES;
- REFERENCE A-110 DRAWING SERIES FOR FLOOR PLANS;
- REFERENCE A-120 DRAWING SERIES FOR CEILING PLANS;
- REFERENCE A-130 DRAWING SERIES FOR FINISH PLANS;
- REFERENCE A-140 DRAWING SERIES FOR ROOF PLANS;
- REFERENCE A-200 DRAWING SERIES FOR BUILDING ELEVATIONS;
- REFERENCE A-300 DRAWING SERIES FOR SECTIONS;
- REFERENCE A-400 DRAWING SERIES FOR ENLARGED PLANS;

GRAPHIC SCALE

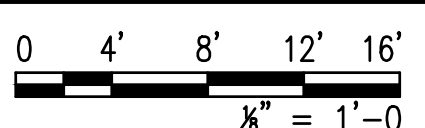


KEY PLAN

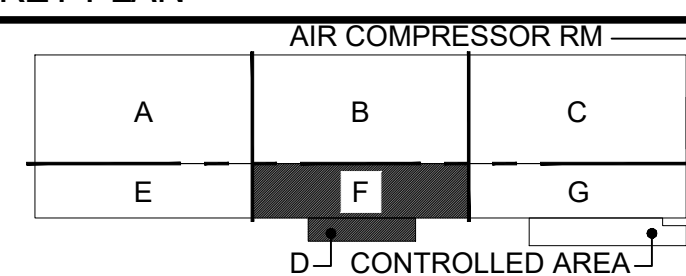


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FOR COMMANDER NAVFAC			
APPROVED BY KYLE STRAUSBAUGH, NAVFAC HEAD DIRECTOR - PWD OCEANA, VA EMAIL			
SATISFACTORY TO DATE: 12/06/2022			
DES	JMT	DRW	JMT
PM/DM			EA/CWJ
BRANCH: MANAGER			CGM
CHIEF: ENG/ARCH			EJA
FIRE PROTECTION			DSN
NAVAL FACILITIES ENGINEERING SYSTEMS COMMAND - MID-ATLANTIC NAVAL STATION - NORFOLK, VA		VIRGINIA BEACH, VA	
DEPARTMENT OF THE NAVY		NAVAL FACILITIES ENGINEERING SYSTEMS COMMAND - MID-ATLANTIC NAVAL STATION - NORFOLK, VA	
HANGAR 404 FIRE PROTECTION AND BUILDING ENVELOPE REPAIRS		1st FLOOR PLAN - AREA D & F	
SCALE: AS NOTED		EPROJECT NO.: 1372148	
CONSTR. CONTR. NO.			
NAVFAC DRAWING NO. 12821688			
SHEET 87 OF 382			
A-115			
DRAWING REVISION: 07 AUG 2018			

FILE NAME: \\gdnr\gnd\US\Chantilly\Projects\585\11203487\Digital_Design\1 - CAD\3.1.2 - Sheet\05b - Architectural\2022 11 18 Final\1372148-A-116.dwg LAYOUT NAME: Layout1 PLOTTED: Monday, December 05, 2022 - 1:41pm USER: msash

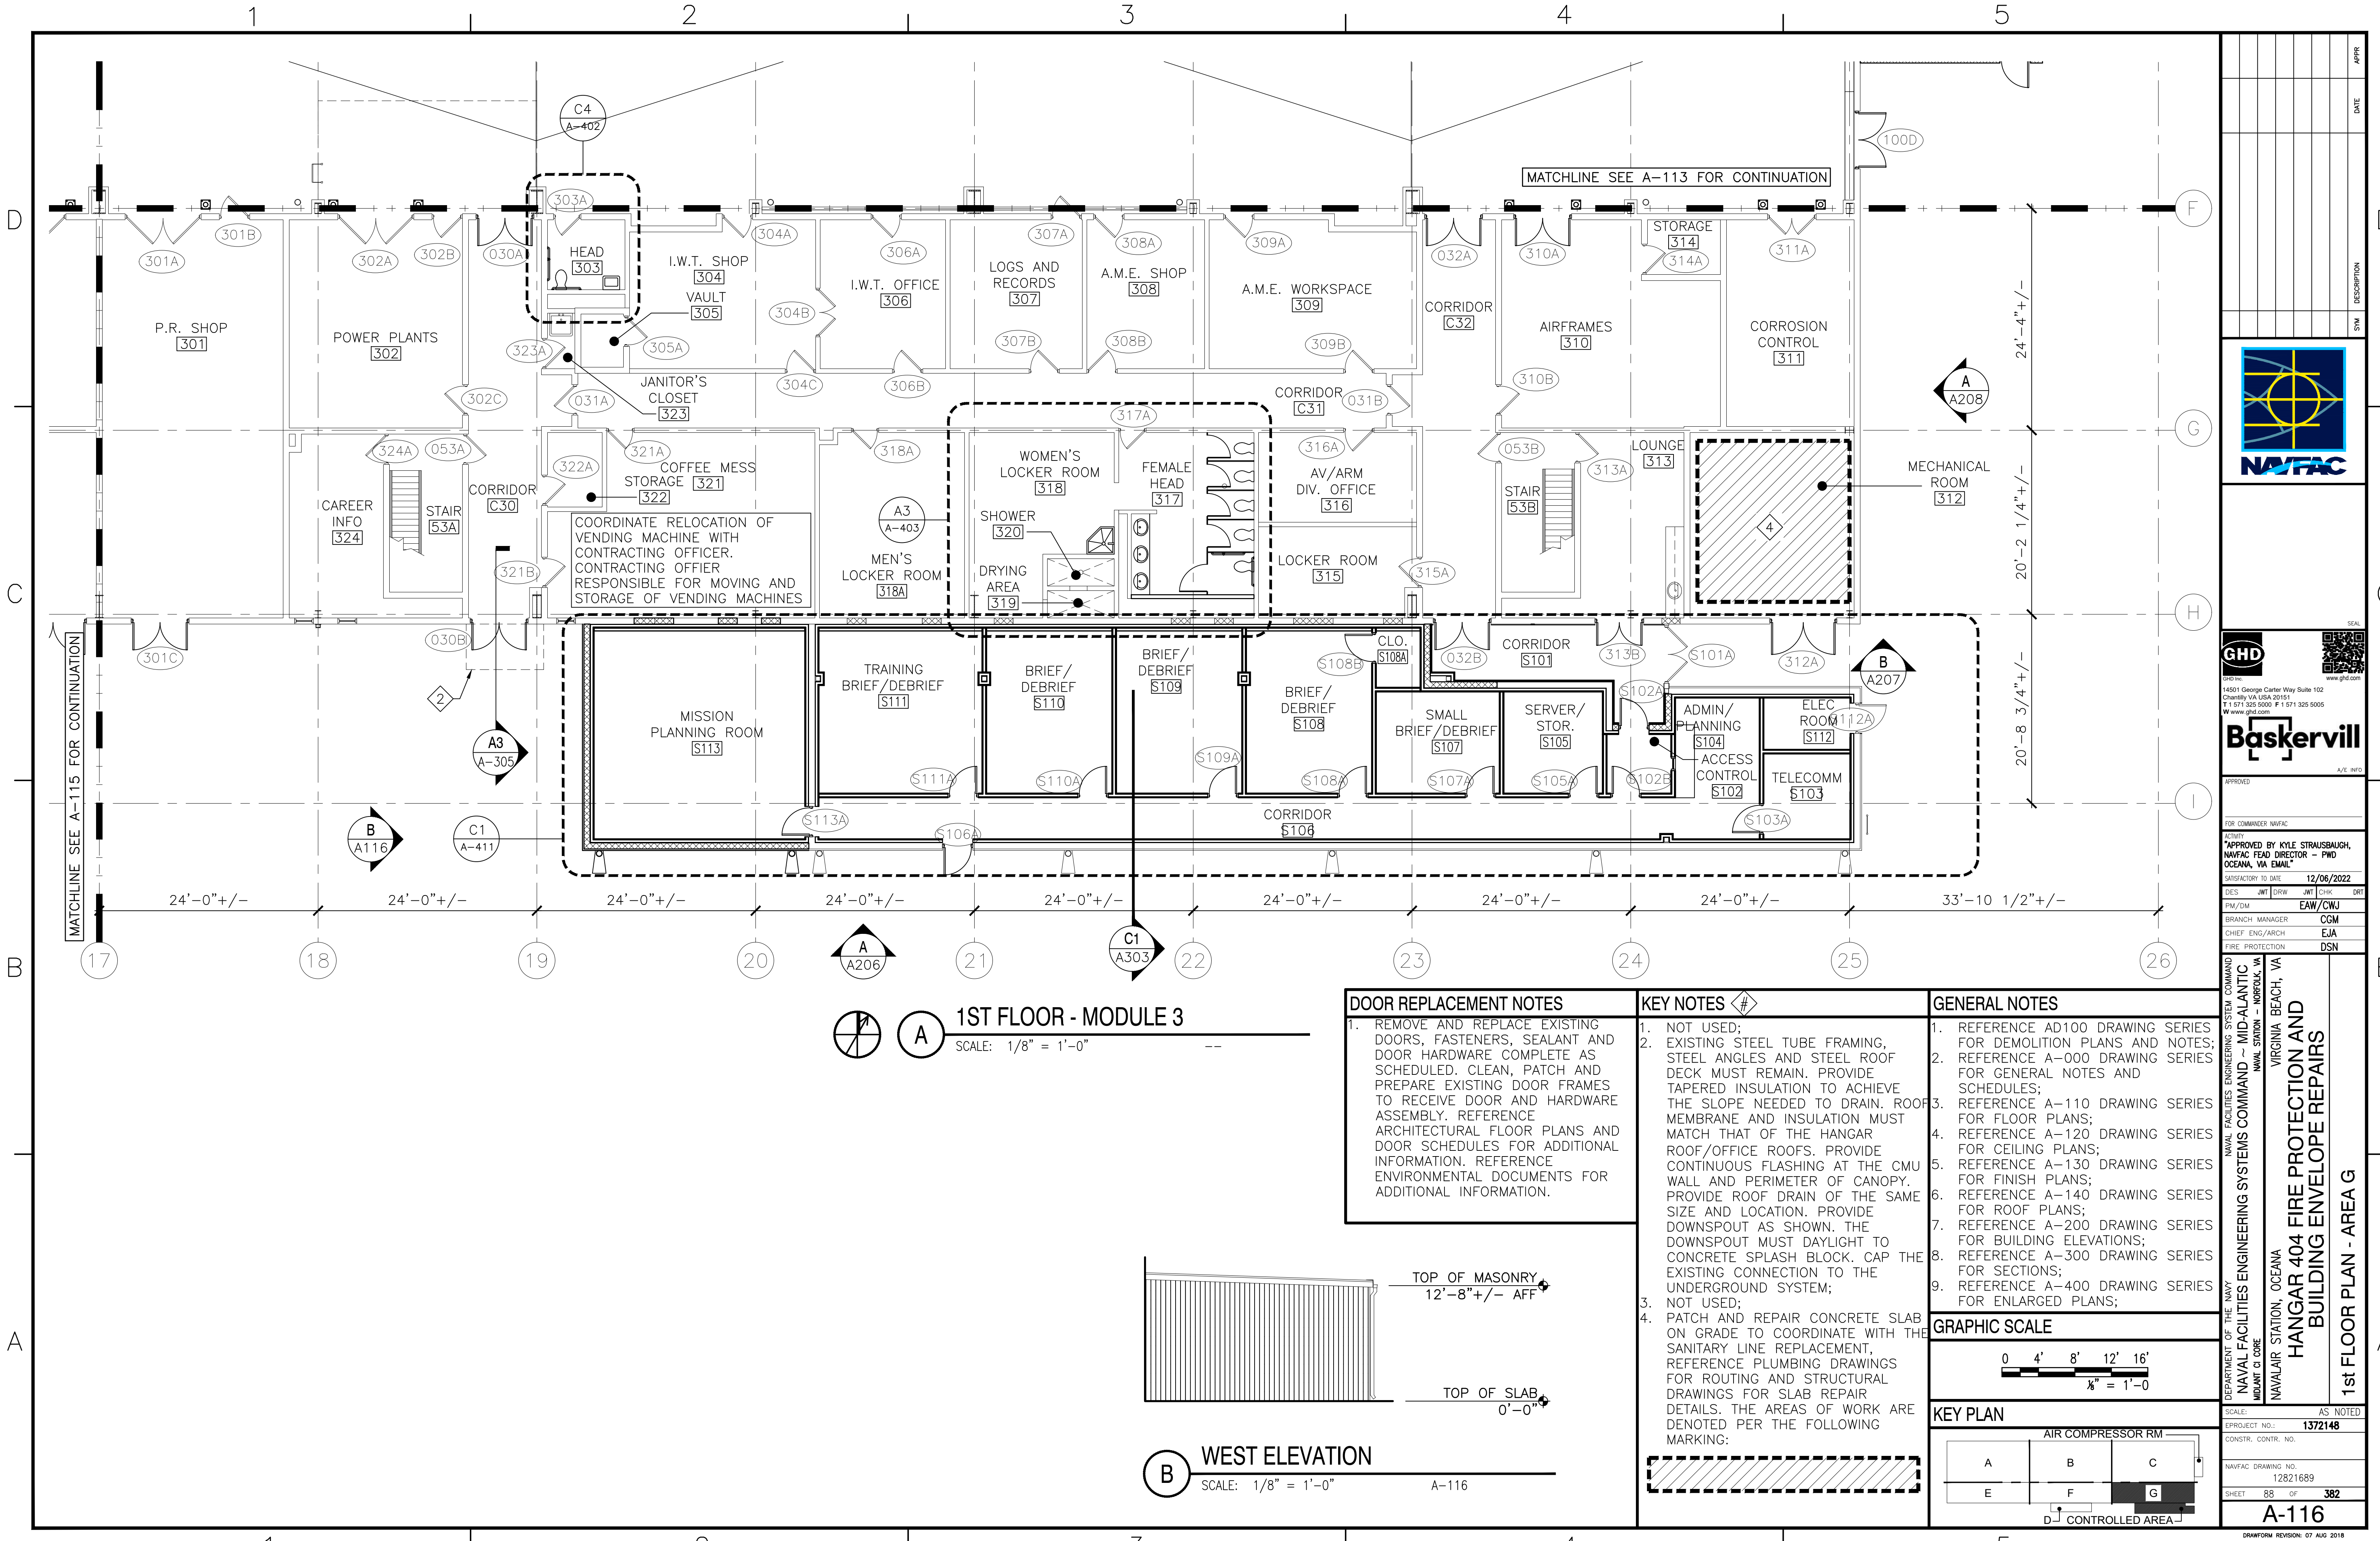


APPR	DATE	DESCRIPTION	SYN
APPROVED			
FOR COMMANDER NAVFAC			
APPROVED BY KYLE STRAUSSBAUGH, NAVFAC HEAD DIRECTOR - PWD OCEANA, VA EMAIL			
SATISFACTORY TO DATE: 12/06/2022			
DES	JMT	DRW	JMT
PM/DM			EAU/CWJ
BRANCH MANAGER		CGM	
CHIEF ENG/ARCH		EJA	
FIRE PROTECTION		DSN	
DEPARTMENT OF THE NAVY NAVAL FACILITIES ENGINEERING SYSTEMS COMMAND NAVAL STATION - NORFOLK, VA VIRGINIA BEACH, VA			
HANGAR 404 FIRE PROTECTION AND BUILDING ENVELOPE REPAIRS			
1st FLOOR PLAN - AREA G			
SCALE: AS NOTED			
PROJECT NO.: 1372148			
CONSTR. CONTR. NO.			
NAVFAC DRAWING NO. 12821689			
SHEET 88 OF 382			
A-116			
DRAWING REVISION: 07 AUG 2018			

FILE NAME: \\gdrnet\gnd\US\Chantilly\Projects\585\1120348\Digital_Design\1 - CAD\3.1.2 - Sheet\05b - Architectural\2022 11 18 Final\137248-A-117.dwg LAYOUT NAME: Layout1 PLOTTED: Monday, December 05, 2022 - 1:41pm USER: msob

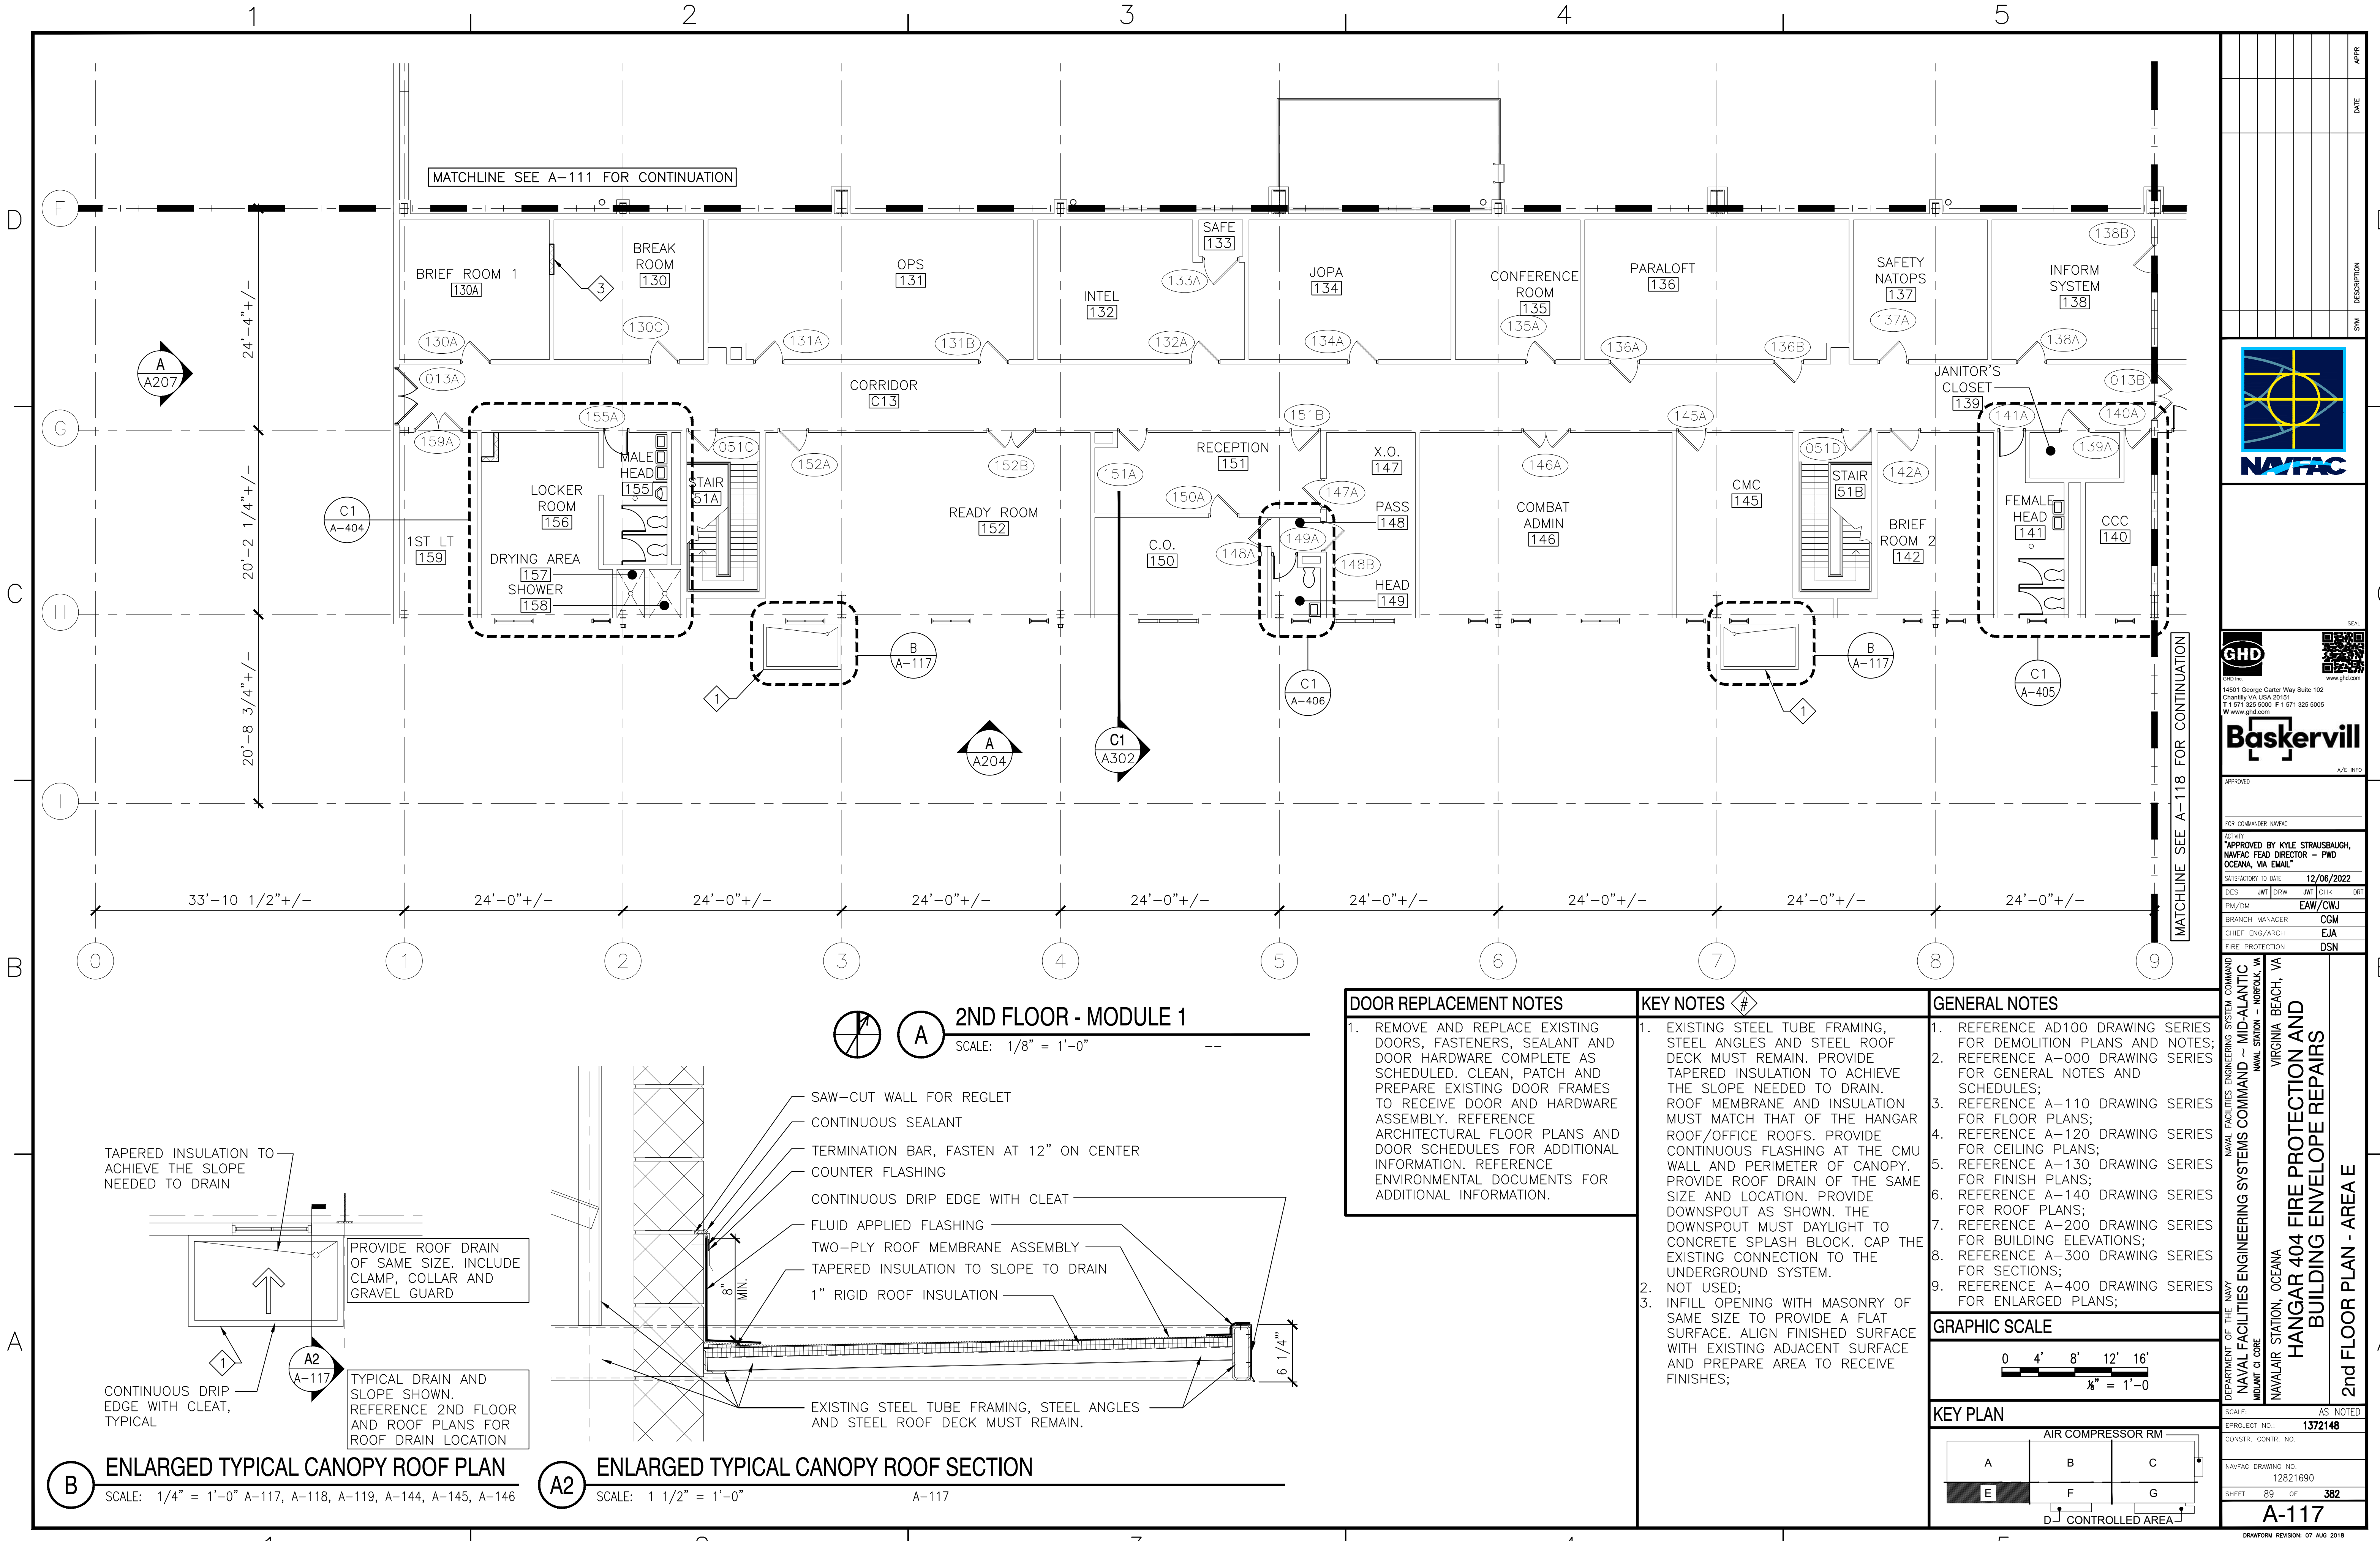


2ND FLOOR - MODULE 1

SCALE: 1/8" = 1'-0"

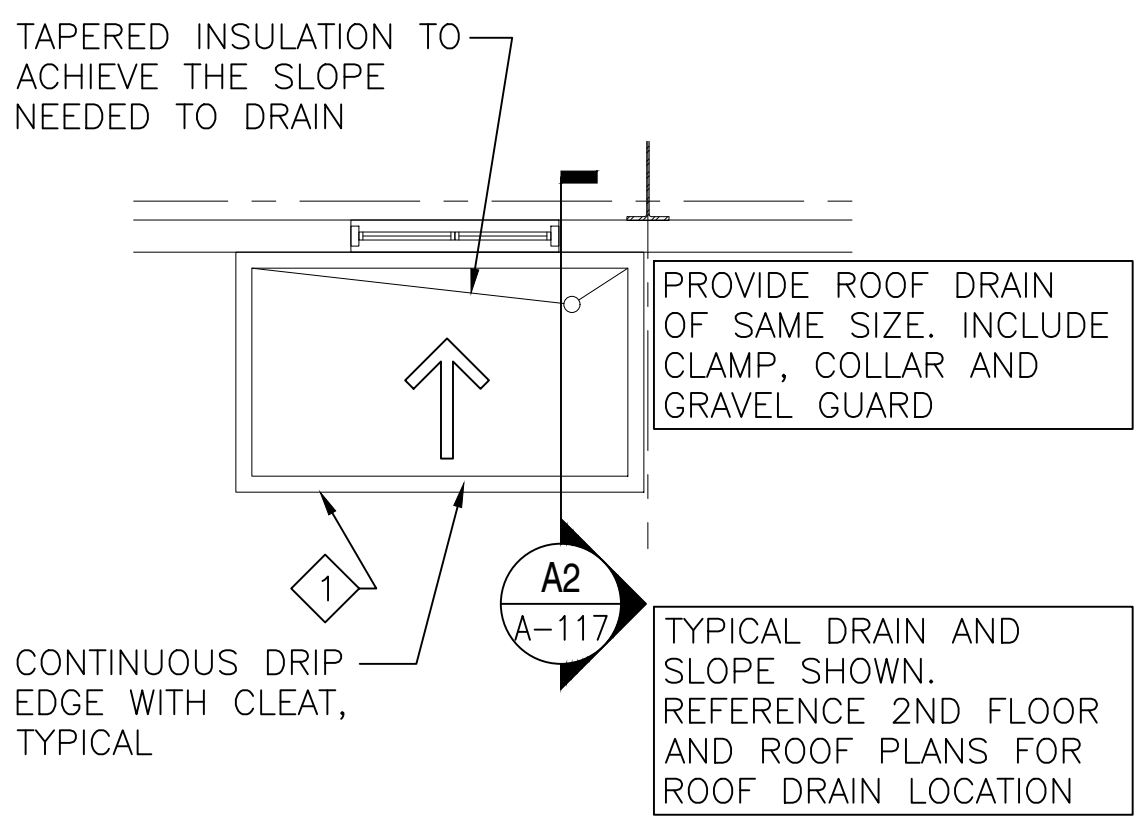

B ENLARGED TYPICAL CANOPY ROOF PLAN
SCALE: 1/4" = 1'-0" A-117, A-118, A-119, A-144, A-145, A-146

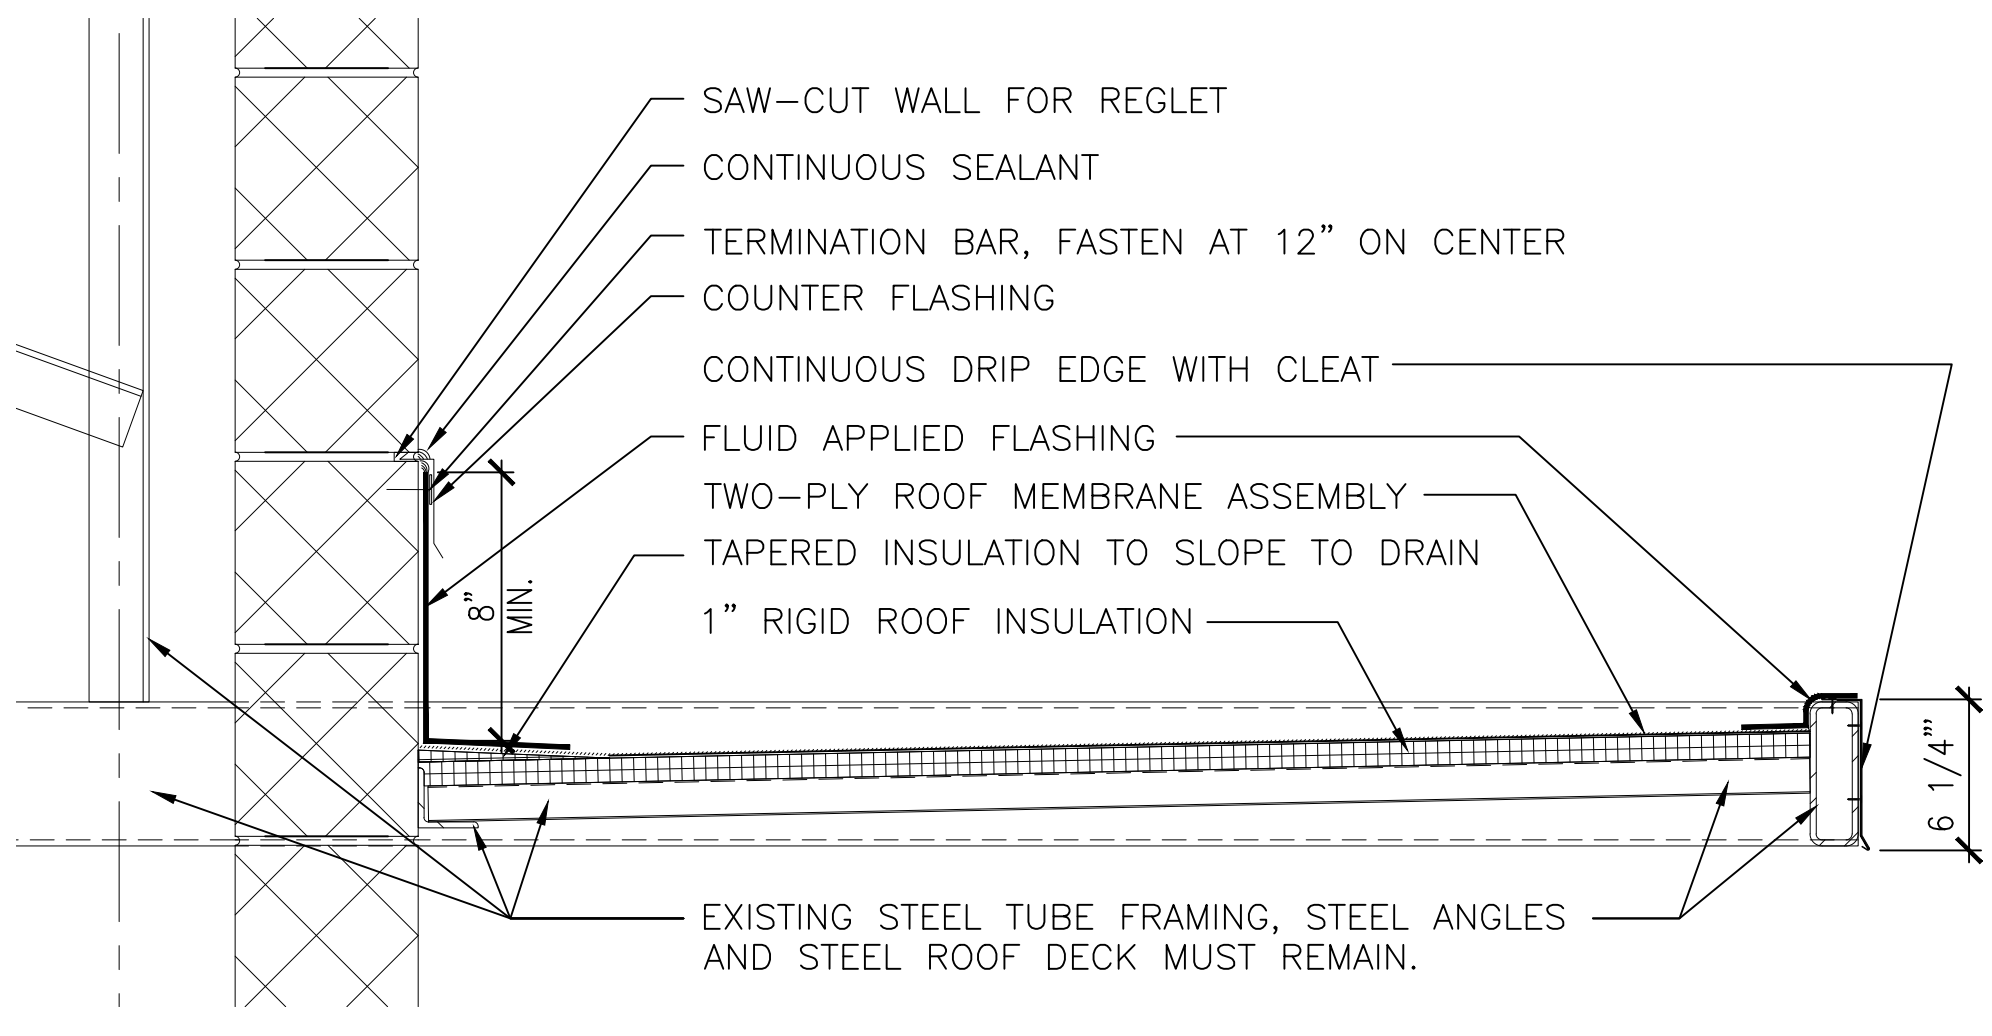

A2 ENLARGED TYPICAL CANOPY ROOF SECTION
SCALE: 1 1/2" = 1'-0" A-117

DOOR REPLACEMENT NOTES

1. REMOVE AND REPLACE EXISTING DOORS, FASTENERS, SEALANT AND DOOR HARDWARE COMPLETE AS SCHEDULED. CLEAN, PATCH AND PREPARE EXISTING DOOR FRAMES TO RECEIVE DOOR AND HARDWARE ASSEMBLY. REFERENCE ARCHITECTURAL FLOOR PLANS AND DOOR SCHEDULES FOR ADDITIONAL INFORMATION. REFERENCE ENVIRONMENTAL DOCUMENTS FOR ADDITIONAL INFORMATION.


KEY NOTES

1. EXISTING STEEL TUBE FRAMING, STEEL ANGLES AND STEEL ROOF DECK MUST REMAIN. PROVIDE TAPERED INSULATION TO ACHIEVE THE SLOPE NEEDED TO DRAIN. ROOF MEMBRANE AND INSULATION MUST MATCH THAT OF THE HANGAR ROOF/OFFICE ROOFS. PROVIDE CONTINUOUS FLASHING AT THE CMU WALL AND PERIMETER OF CANOPY. PROVIDE ROOF DRAIN OF THE SAME SIZE AND LOCATION. PROVIDE DOWNSPOUT AS SHOWN. THE DOWNSPOUT MUST DAYLIGHT TO CONCRETE SPLASH BLOCK. CAP THE EXISTING CONNECTION TO THE UNDERGROUND SYSTEM.
2. NOT USED;
3. INFILL OPENING WITH MASONRY OF SAME SIZE TO PROVIDE A FLAT SURFACE. ALIGN FINISHED SURFACE WITH EXISTING ADJACENT SURFACE AND PREPARE AREA TO RECEIVE FINISHES;



GENERAL NOTES

1. REFERENCE AD100 DRAWING SERIES FOR DEMOLITION PLANS AND NOTES;
2. REFERENCE A-000 DRAWING SERIES FOR GENERAL NOTES AND SCHEDULES;
3. REFERENCE A-110 DRAWING SERIES FOR FLOOR PLANS;
4. REFERENCE A-120 DRAWING SERIES FOR CEILING PLANS;
5. REFERENCE A-130 DRAWING SERIES FOR FINISH PLANS;
6. REFERENCE A-140 DRAWING SERIES FOR ROOF PLANS;
7. REFERENCE A-200 DRAWING SERIES FOR BUILDING ELEVATIONS;
8. REFERENCE A-300 DRAWING SERIES FOR SECTIONS;
9. REFERENCE A-400 DRAWING SERIES FOR ENLARGED PLANS;

GRAPHIC SCALE

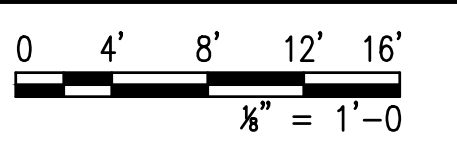


KEY PLAN

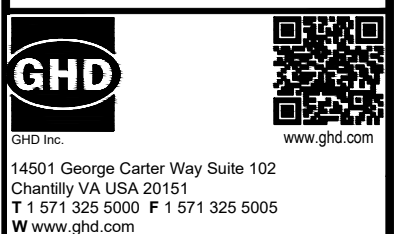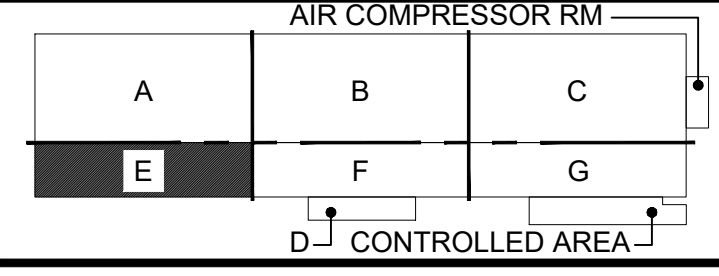


APPROVED
FOR COMMANDER NAVFAC
APPROVED BY KYLE STRAUSBAUGH, NAVFAC HEAD DIRECTOR - PWD OCEANA, VA EMAIL
SATISFACTORY TO DATE 12/06/2022
DES JMT DRW JMT CHK DRT
PM/DM EAW/CWJ
BRANCH MANAGER CGM
CHIEF ENG/ARCH EJA
FIRE PROTECTION DSN

DEPARTMENT OF THE NAVY NAVAL FACILITIES ENGINEERING SYSTEMS COMMAND NAVAL STATION - NORFOLK, VA VIRGINIA BEACH, VA	NAVFAC DRAWING NO. 12821690
PROJECT NO. 1372148	SHEET 89 OF 382
CONSTR. CONTR. NO.	A-117
AS NOTED	DRWFORM REVISION: 07 AUG 2018

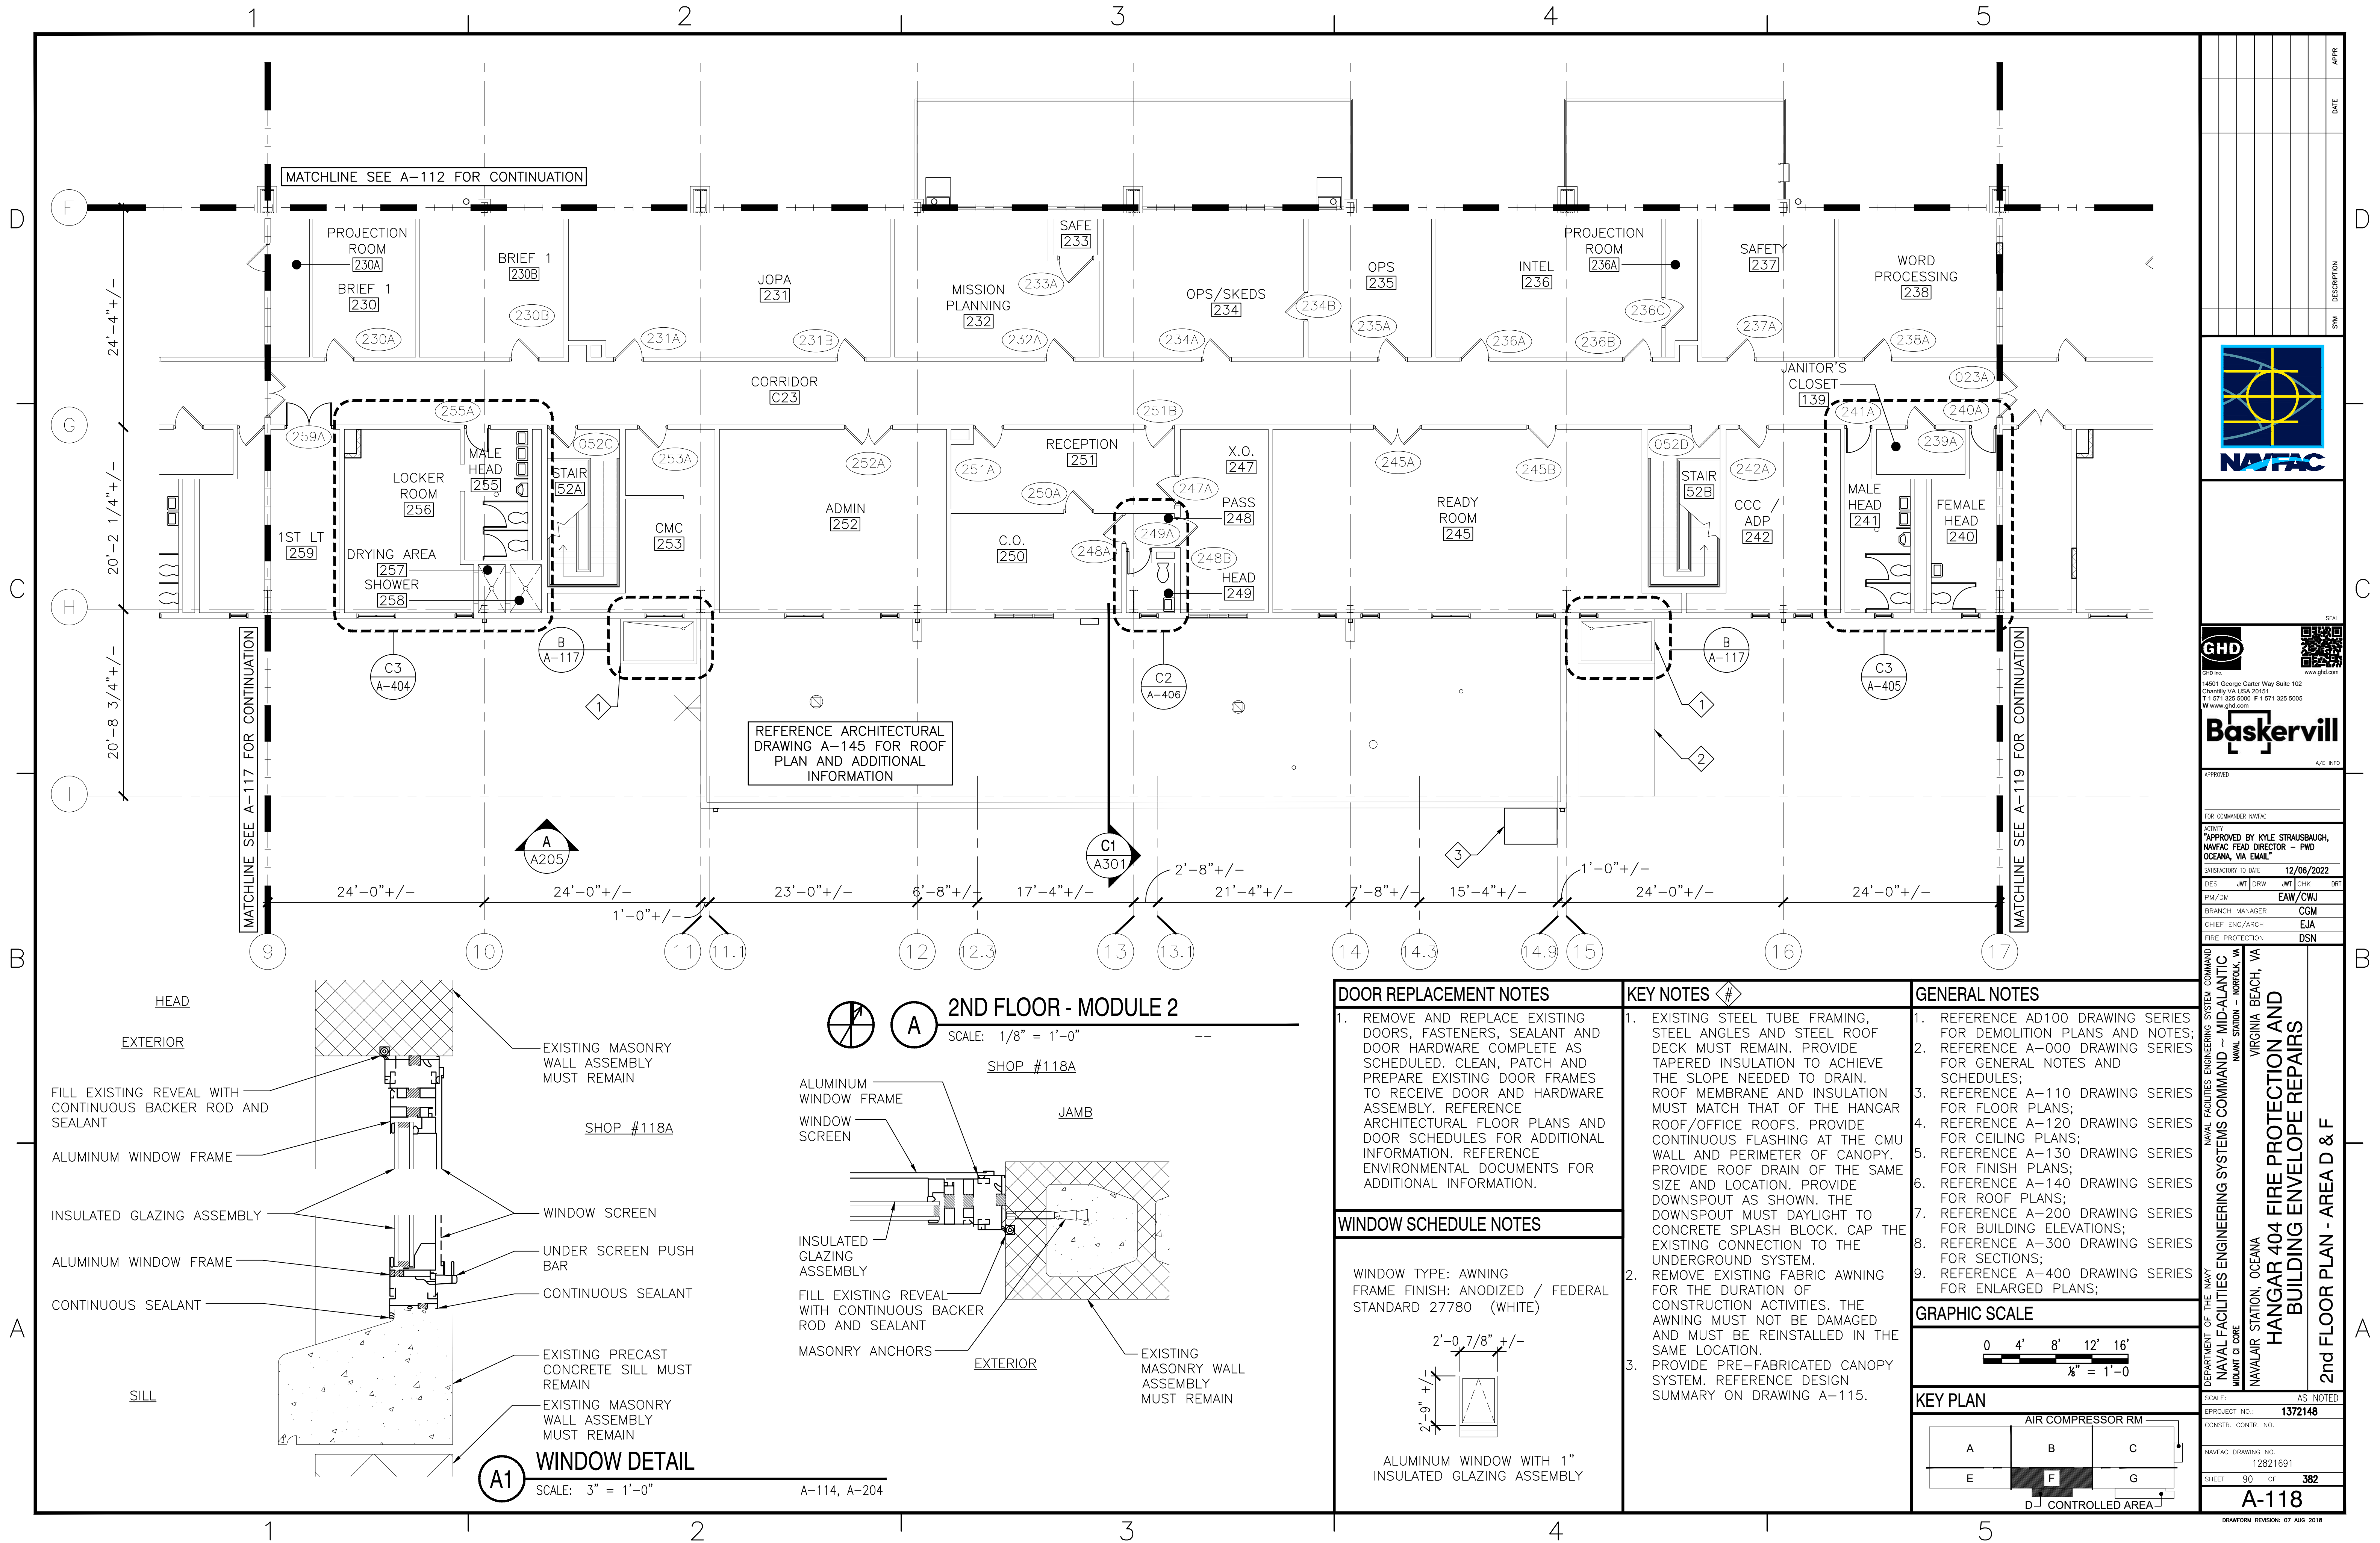

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APPR.	DATE
SYN	DESCRIPTION

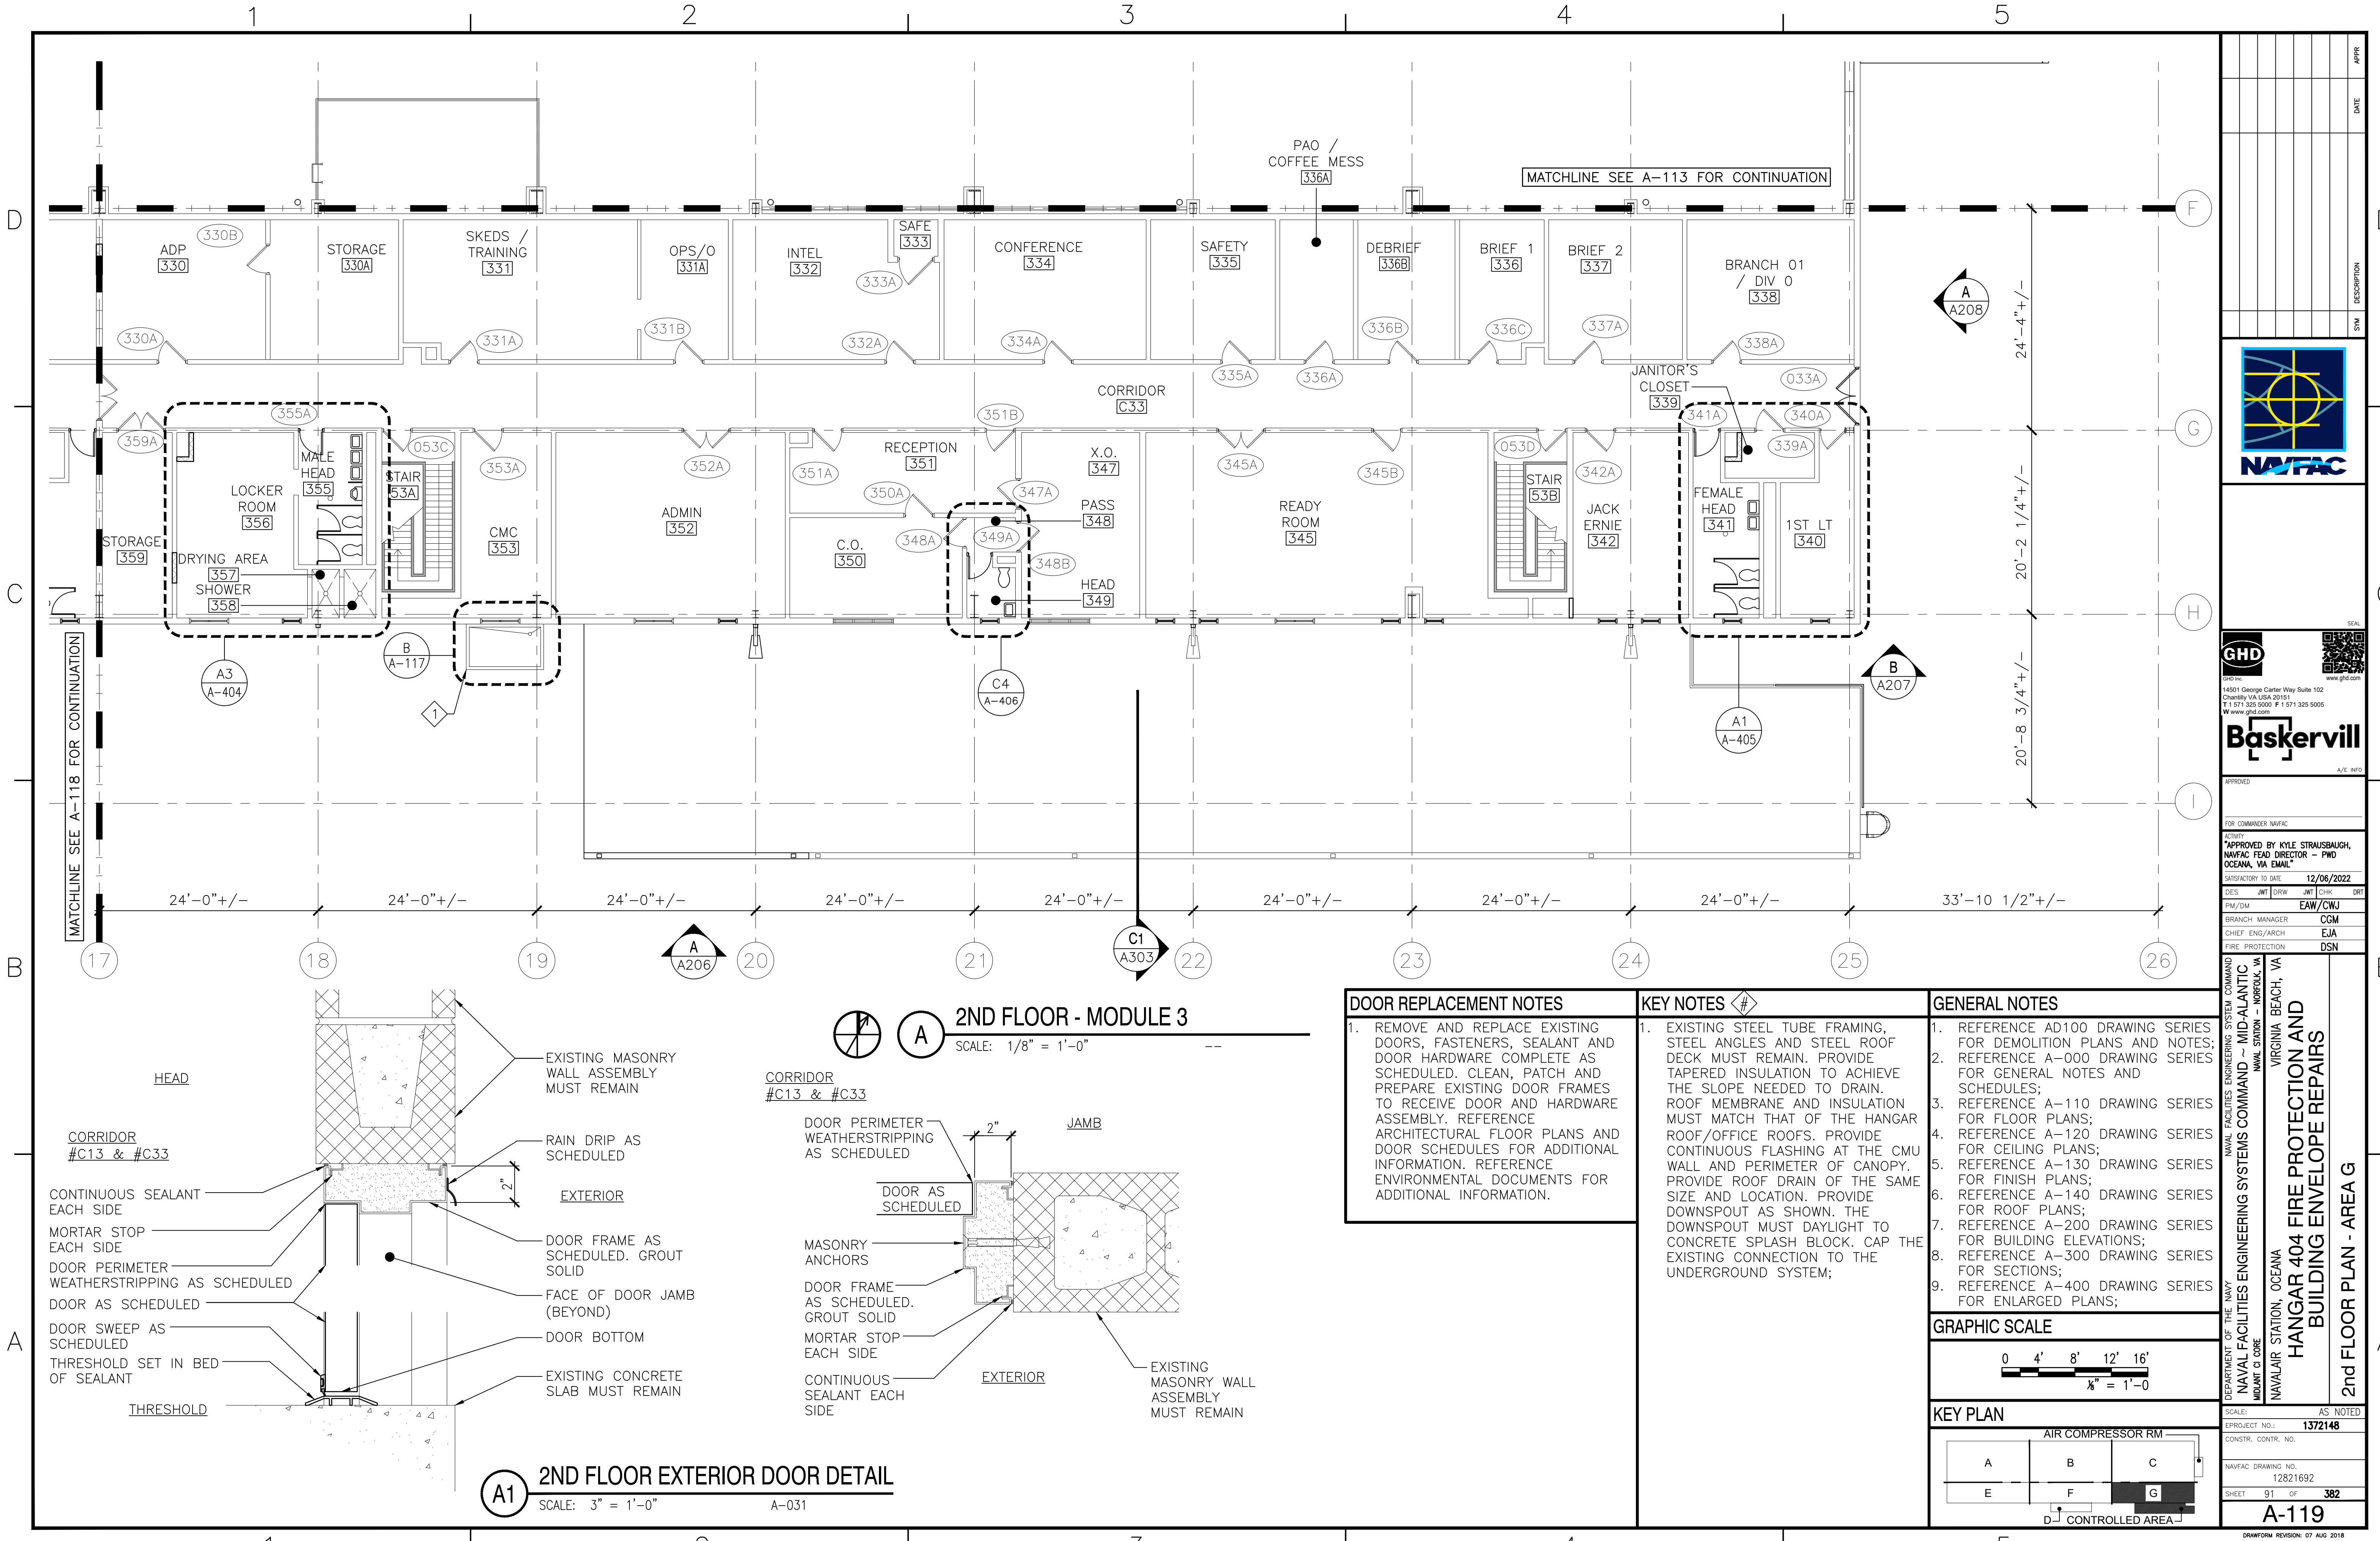14501 George Carter Way Suite 102
Chantilly VA USA 20151
T 1 571 335 5000 F 1 571 325 5005
W www.ghd.com

A/E 1670


APPROVED	FOR COMMANDER NAVFAC				
APPROVED BY KYLE STRAUSBAUGH, NAVFAC HEAD DIRECTOR - PWD OCEANA, VA EMAIL					
SATISFACTORY TO DATE	12/06/2022				
DES	JMT	DRW	JMT	CHK	DRT
PM/DM	EAW/CWJ				
BRANCH MANAGER	CGM				
CHIEF ENG/ARCH	EJA				
FIRE PROTECTION	DSN				

DEPARTMENT OF THE NAVY NAVAL FACILITIES ENGINEERING SYSTEMS COMMAND MID-ATLANTIC NAVAL STATION - NORFOLK, VA	VIRGINIA BEACH, VA
HANGAR 404 FIRE PROTECTION AND BUILDING ENVELOPE REPAIRS	
2nd FLOOR PLAN - AREA G	

SCALE:	AS NOTED
PROJECT NO.:	1372148
CONSTR. CONTR. NO.	
NAVFAC DRAWING NO.	12821692
SHEET	91 OF 382
A-119	

DRAWING REVISION: 07 AUG 2018

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KEY NOTES	DRAFT CURTAIN NOTES	SYMBOL LEGEND	GENERAL CEILING NOTES	GENERAL NOTES	GRAPHIC SCALE
<div>1. EXISTING STEEL FRAMING TO REMAIN;</div> <div>2. EXISTING RADIANT HEATING SYSTEM MUST REMAIN. PROTECT RADIANT HEATING SYSTEM FROM DAMAGE DURING CONSTRUCTION ACTIVITIES. PROVIDE A WRITTEN REPORT PRIOR TO THE COMMENCEMENT OF CONSTRUCTION ACTIVITIES STATING THAT THE RADIANT SYSTEM IS IN GOOD CONDITION AND FUNCTIONS. AT THE COMPLETION OF CEILING WORK, PROVIDE A WRITTEN INSPECTION REPORT STATING THAT THE RADIANT HEATING SYSTEM IS STILL IN GOOD CONDITION AND FUNCTIONS. FOR DAMAGES CAUSED DURING CONSTRUCTION, REPAIR THE RADIANT HEATING SYSTEM AT NO ADDITIONAL COST TO THE CONTRACTING OFFICER.</div> <div>3. REMOVE EXISTING DRAFT CURTAIN COMPLETE. REFERENCE ENVIRONMENTAL DOCUMENTS FOR ADDITIONAL INFORMATION AND DRAFT CURTAIN RECYCLING PROCEDURES. CLEAN, PATCH AND REPAIR ROOF STEEL FOR DRAFT CURTAIN. REFERENCE DRAFT CURTAIN NOTES ON THIS DRAWING.</div> <div>4. DRAFT CURTAIN. REFERENCE NOTES ON THIS DRAWING.</div>	<div>1. PROVIDE DRAFT CURTAIN ON ONE (1) SIDE OF EXISTING ROOF FRAMING FROM COLUMN LINE 'F' TO EXTERIOR WALL BEYOND COLUMN LINE 'A' (105'-0" LONG X 10'-0" HIGH). REFERENCE DETAIL A1 ON SHEET A-021 FOR MATERIAL, GAGE, FINISH, PROFILE AND ATTACHMENT.</div>	<div><div><div></div></div>EXISTING SUSPENDED CEILING SYSTEM</div> <div><div></div>EXISTING GYPSUM BOARD CEILING</div> <div><div></div>HANGAR BAY ELECTRICAL LIGHT FIXTURE</div> <div><div></div>EXISTING MECHANICAL SUPPLY DIFFUSER</div> <div><div></div>EXISTING MECHANICAL RETURN DIFFUSER</div>	<div>1. REFERENCE ELECTRICAL AND MECHANICAL DRAWINGS FOR ADDITIONAL INFORMATION;</div> <div>2. CEILING HEIGHTS ARE LOCATED ON THE REFLECTED CEILING PLANS;</div> <div>HANGAR CEILING PAINT NOTE</div> <div>1. HANGAR ROOF AREA MUST BE PAINTED AS SCHEDULED. PAINT THE STRUCTURAL MEMBERS, ROOF DECK, BRACING, AND DRAFT CURTAINS.</div>	<div>1. REFERENCE AD100 DRAWING SERIES FOR DEMOLITION PLANS AND NOTES;</div> <div>2. REFERENCE A-000 DRAWING SERIES FOR GENERAL NOTES AND SCHEDULES;</div> <div>3. REFERENCE A-110 DRAWING SERIES FOR FLOOR PLANS;</div> <div>4. REFERENCE A-120 DRAWING SERIES FOR CEILING PLANS;</div> <div>5. REFERENCE A-130 DRAWING SERIES FOR FINISH PLANS;</div> <div>6. REFERENCE A-140 DRAWING SERIES FOR ROOF PLANS;</div> <div>7. REFERENCE A-200 DRAWING SERIES FOR BUILDING ELEVATIONS;</div> <div>8. REFERENCE A-300 DRAWING SERIES FOR SECTIONS;</div> <div>9. REFERENCE A-400 DRAWING SERIES FOR ENLARGED PLANS;</div>	<div>0 4' 8' 12' 16'</div> <div>$\frac{1}{8}" = 1'-0"$</div> <div>KEY PLAN</div> <div><div>AIR COMPRESSOR RM</div><div>A B C</div><div>E F G</div><div>D CONTROLLED AREA</div></div>

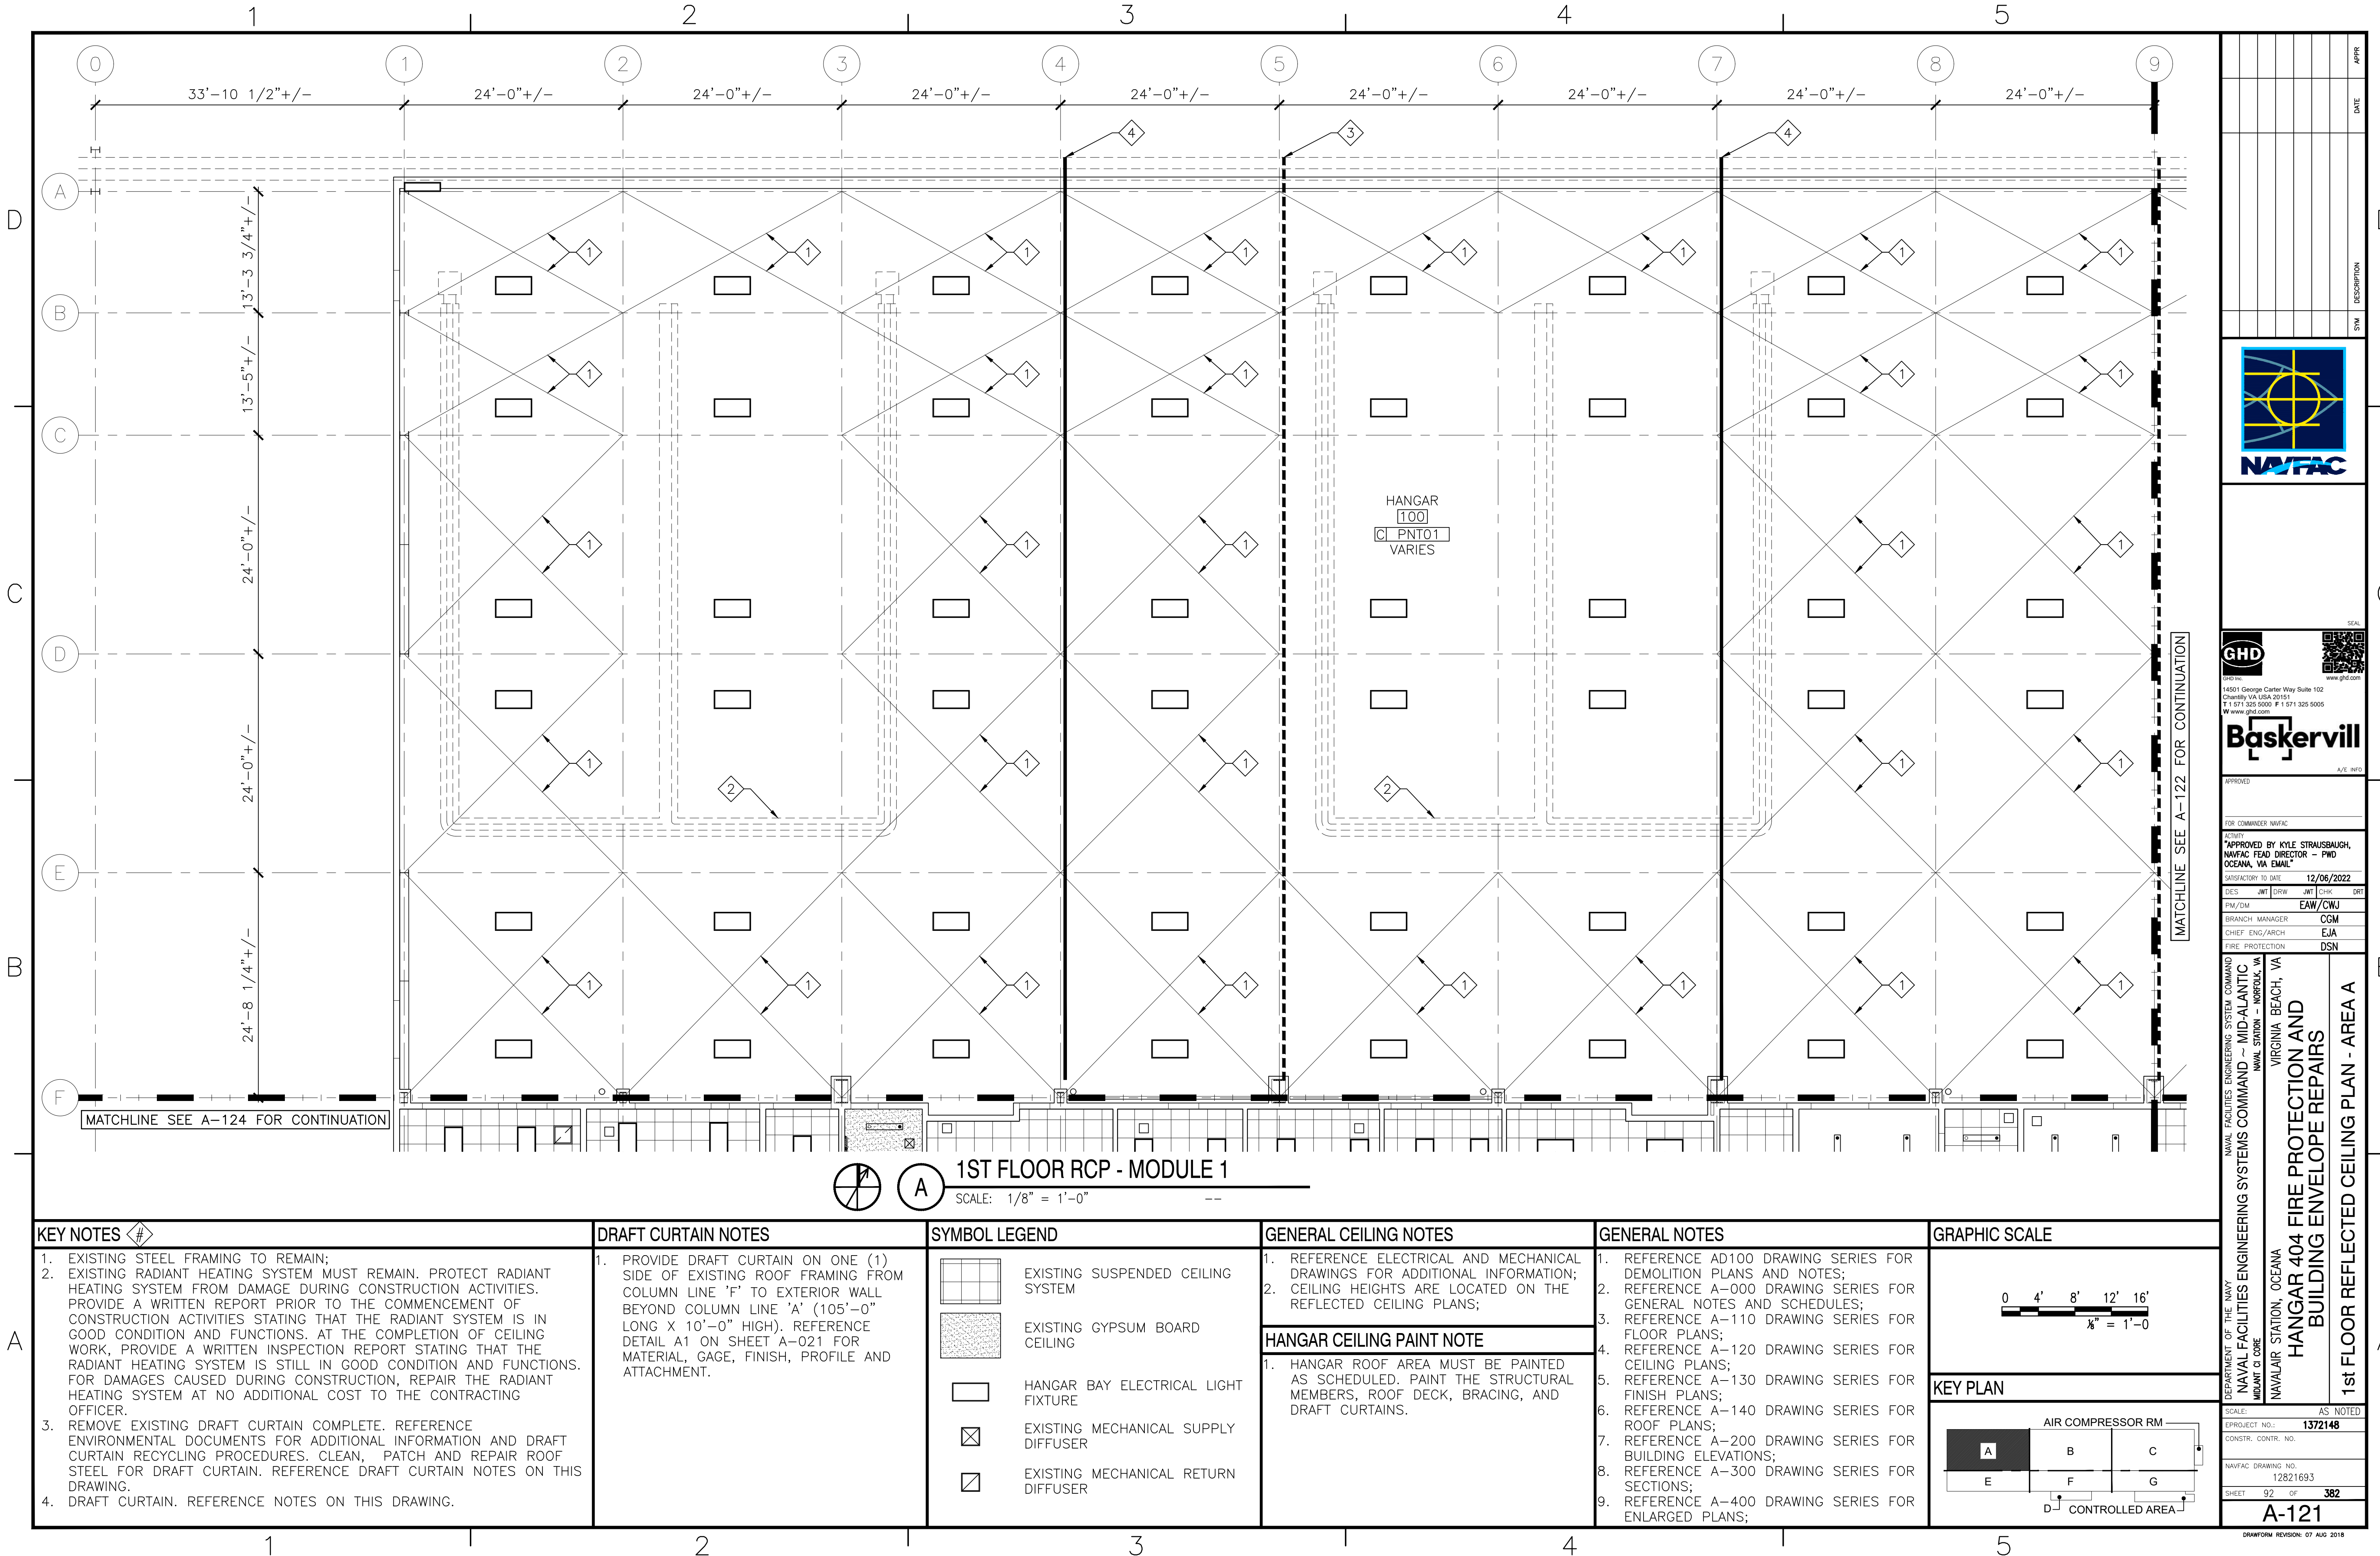APPR

DATE

DESCRIPTION

SYM

GHD Inc.
14501 George Carter Way Suite 102
Chantilly VA USA 20151
T 1 571 325 5000 F 1 571 325 5005
W www.ghd.com

A/E WPD

APPROVED

FOR COMMANDER NAVFAC

APPROVED BY KYLE STRAUSBAUGH,
NAVFAC HEAD DIRECTOR - PWD
OCEANA, VA EMAIL

SATISFACTORY TO DATE 12/06/2022

DES	JMT	DRW	JMT	CHK	DRT
PM/DM			EAJ/CWJ		
BRANCH	MANAGER				CGM
CHIEF	ENG/ARCH				EJA
FIRE PROTECTION					DSN

DEPARTMENT OF THE NAVY
NAVAL FACILITIES ENGINEERING SYSTEMS COMMAND
NAVAL STATION - NORFOLK, VA
NAVAL STATION - OCEANA
NAVAL STATION - VIRGINIA BEACH, VA

**HANGAR 404 FIRE PROTECTION AND
BUILDING ENVELOPE REPAIRS**

1st FLOOR REFLECTED CEILING PLAN - AREA A

SCALE: AS NOTED

PROJECT NO.: 1372148

CONSTR. CONTR. NO.


NAVFAC DRAWING NO.
12821693

SHEET 92 OF 382

A-121

DRAWING REVISION: 07 AUG 2018

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APPR	DATE
SYN	DESCRIPTION

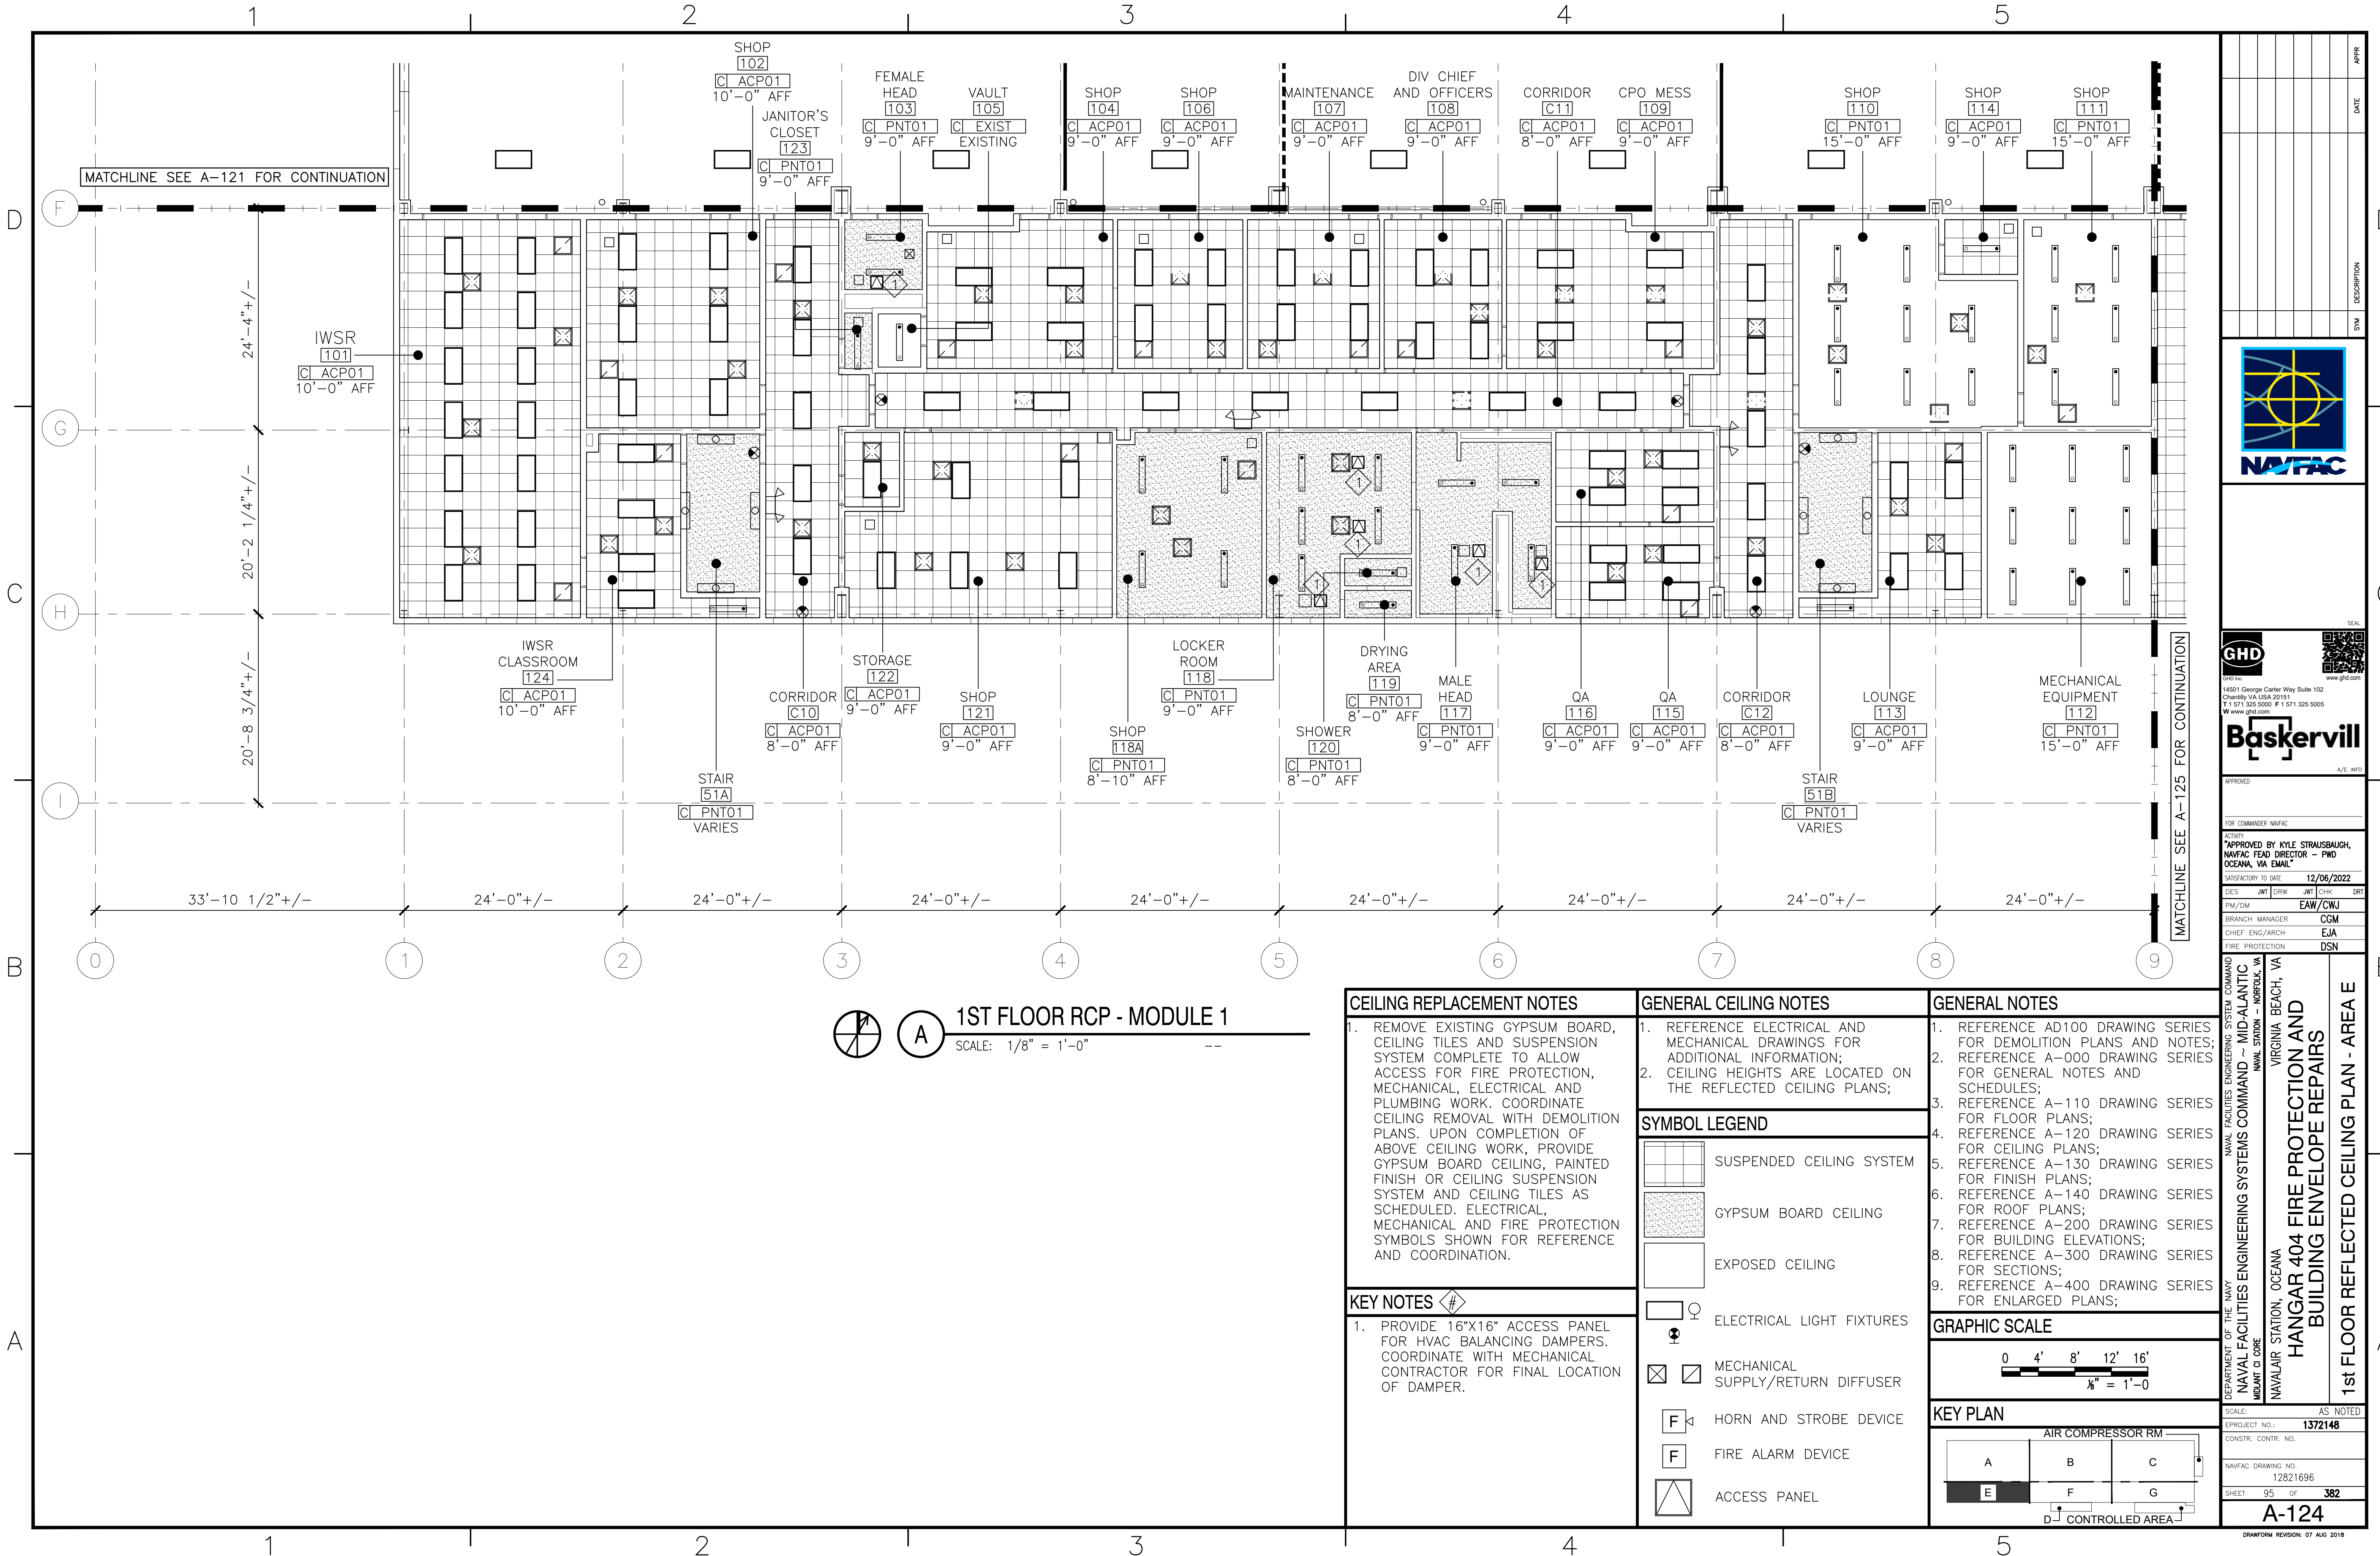APPROVED			
FOR COMMANDER NAVFAC			
APPROVED BY KYLE STRAUSBAUGH, NAVFAC HEAD DIRECTOR - PWD OCEANA, VA EMAIL			
SATISFACTORY TO DATE		12/06/2022	
DES	JMT	DRW	JWT
PM/DM	EAW/CWJ		
BRANCH	MANAGER		
CHIEF	ENG/ARCH		
FIRE PROTECTION	DSN		


DEPARTMENT OF THE NAVY
NAVAL FACILITIES ENGINEERING SYSTEMS COMMAND
NAVAL STATION - NORFOLK, VA

NAVAL AIR STATION, OCEANA
HANGAR 404 FIRE PROTECTION AND
BUILDING ENVELOPE REPAIRS

1st FLOOR REFLECTED CEILING PLAN - AREA E

SCALE:	AS NOTED
PROJECT NO.:	1372148
CONSTR. CONTR. NO.	
NAVFAC DRAWING NO.	12821696
SHEET	95 OF 382
A-124	
DRAWING REVISION: 07 AUG 2018	

FILE NAME: \\gdnr\gnd\US\Chantilly\Projects\585\1120348\Digital_Design\1 - CAD\3.1.2 - Sheet\05b - Architectural\2022 11 18 Final\1372148-A-125.dwg LAYOUT NAME: Layout1 PLOTTED: Monday, December 05, 2022 - 1:41pm USER: ns0h

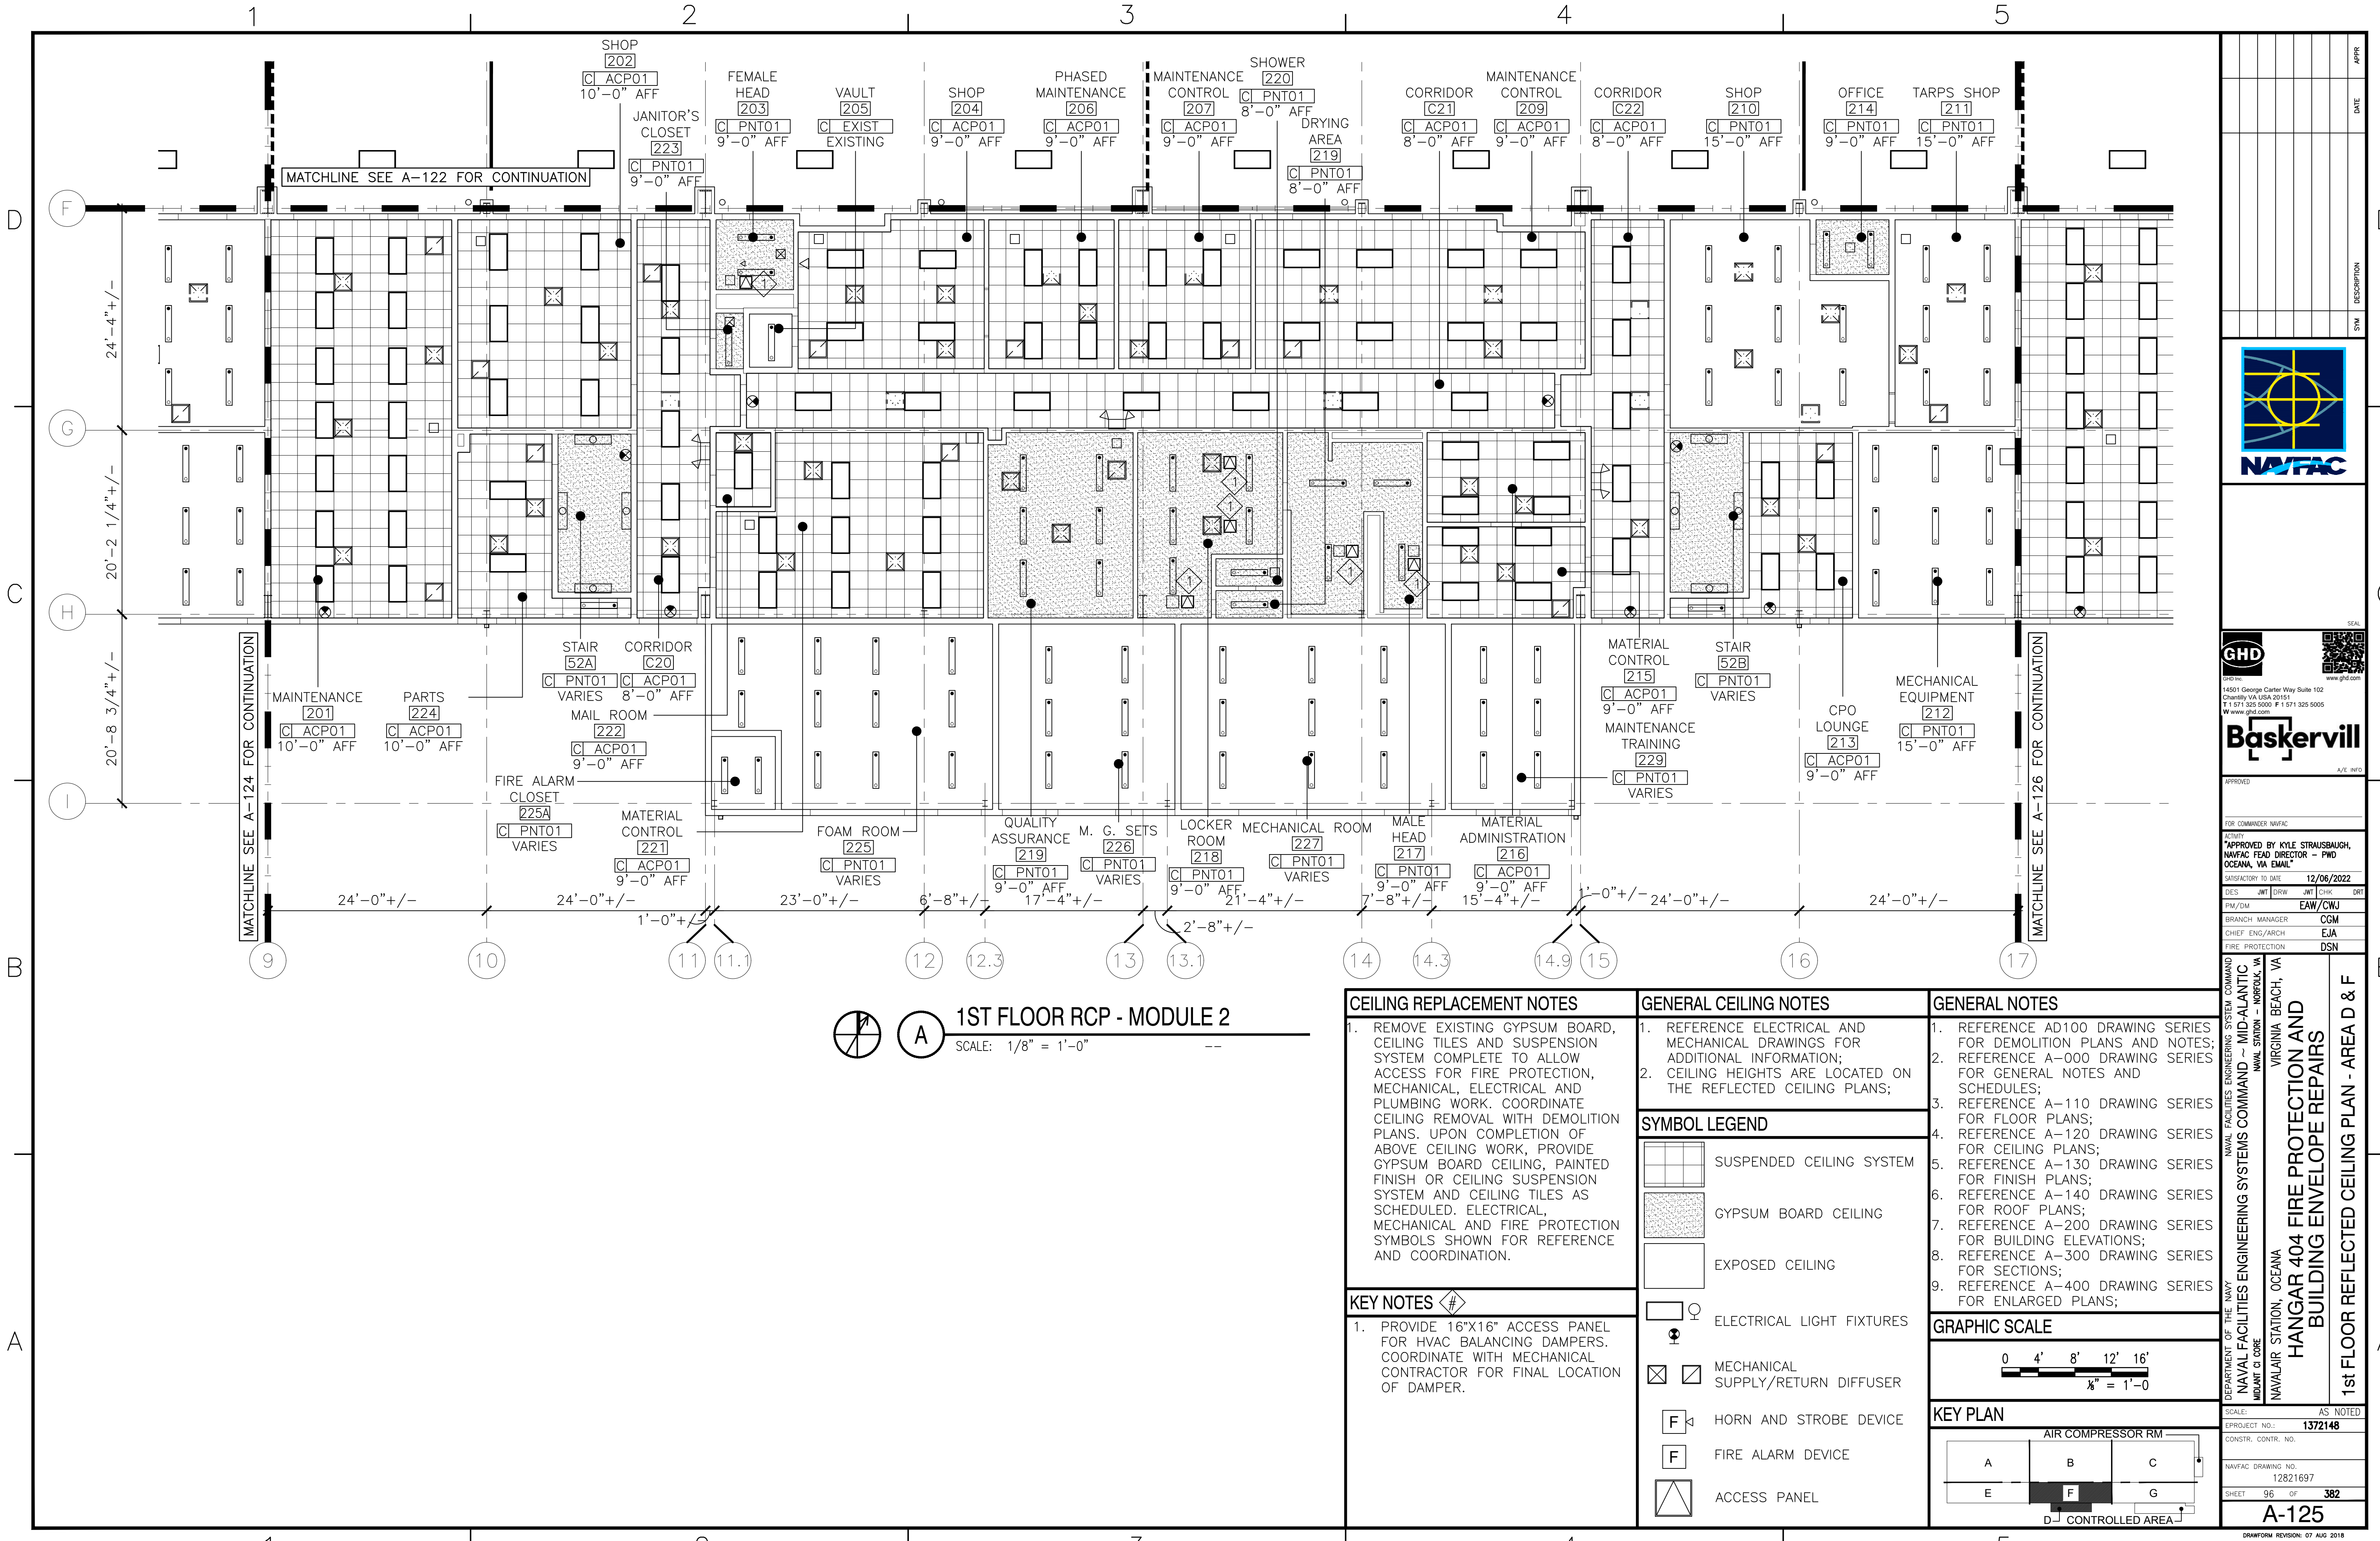

A

1ST FLOOR RCP - MODULE 2

SCALE: 1/8" = 1'-0"

CEILING REPLACEMENT NOTES

1. REMOVE EXISTING GYPSUM BOARD, CEILING TILES AND SUSPENSION SYSTEM COMPLETE TO ALLOW ACCESS FOR FIRE PROTECTION, MECHANICAL, ELECTRICAL AND PLUMBING WORK. COORDINATE CEILING REMOVAL WITH DEMOLITION PLANS. UPON COMPLETION OF ABOVE CEILING WORK, PROVIDE GYPSUM BOARD CEILING, PAINTED FINISH OR CEILING SUSPENSION SYSTEM AND CEILING TILES AS SCHEDULED. ELECTRICAL, MECHANICAL AND FIRE PROTECTION SYMBOLS SHOWN FOR REFERENCE AND COORDINATION.

KEY NOTES

1. PROVIDE 16"x16" ACCESS PANEL FOR HVAC BALANCING DAMPERS. COORDINATE WITH MECHANICAL CONTRACTOR FOR FINAL LOCATION OF DAMPER.

GENERAL CEILING NOTES

1. REFERENCE ELECTRICAL AND MECHANICAL DRAWINGS FOR ADDITIONAL INFORMATION;
2. CEILING HEIGHTS ARE LOCATED ON THE REFLECTED CEILING PLANS;


SYMBOL LEGEND

- SUSPENDED CEILING SYSTEM
- GYPSUM BOARD CEILING
- EXPOSED CEILING
- ELECTRICAL LIGHT FIXTURES
- MECHANICAL SUPPLY/RETURN DIFFUSER
- HORN AND STROBE DEVICE
- FIRE ALARM DEVICE
- ACCESS PANEL


GENERAL NOTES

1. REFERENCE AD100 DRAWING SERIES FOR DEMOLITION PLANS AND NOTES;
2. REFERENCE A-000 DRAWING SERIES FOR GENERAL NOTES AND SCHEDULES;
3. REFERENCE A-110 DRAWING SERIES FOR FLOOR PLANS;
4. REFERENCE A-120 DRAWING SERIES FOR CEILING PLANS;
5. REFERENCE A-130 DRAWING SERIES FOR FINISH PLANS;
6. REFERENCE A-140 DRAWING SERIES FOR ROOF PLANS;
7. REFERENCE A-200 DRAWING SERIES FOR BUILDING ELEVATIONS;
8. REFERENCE A-300 DRAWING SERIES FOR SECTIONS;
9. REFERENCE A-400 DRAWING SERIES FOR ENLARGED PLANS;

GRAPHIC SCALE

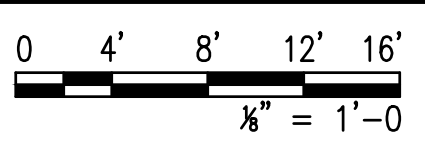


KEY PLAN

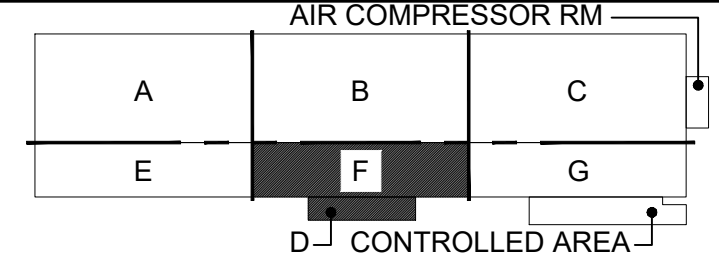

APPROVED		DATE	APPR
FOR COMMANDER NAVFAC			
APPROVED BY KYLE STRAUSBAUGH, NAVFAC HEAD DIRECTOR - PWD OCEANA, VA EMAIL			
SATISFACTORY TO DATE		12/06/2022	
DES	JMT	DRW	JMT
PM/DM			EAJ/CWJ
BRANCH MANAGER		CGM	
CHIEF ENG/ARCH		EJA	
FIRE PROTECTION		DSN	
NAVAL FACILITIES ENGINEERING SYSTEMS COMMAND		VIRGINIA BEACH, VA	
NAVAL STATION - NORFOLK, VA		NAVAL STATION - NORFOLK, VA	
HANGAR 404 FIRE PROTECTION AND BUILDING ENVELOPE REPAIRS		1st FLOOR REFLECTED CEILING PLAN - AREA D & F	
SCALE: AS NOTED		PROJECT NO.: 1372148	
CONSTR. CONTR. NO.			
NAVFAC DRAWING NO. 12821697		SHEET 96 OF 382	
A-125		DRAWING REVISION: 07 AUG 2018	

FILE NAME: \\gdrna\gnd\US\Chantilly\Projects\585\1120348\Digital_Design\1 - CAD\3.1.2 - Sheet\05b - Architectural\2022 11 18 Final\1372148-A-126.dwg LAYOUT NAME: Layout1 PLOTTER: Monday, December 05, 2022 - 1:42pm USER: nsch

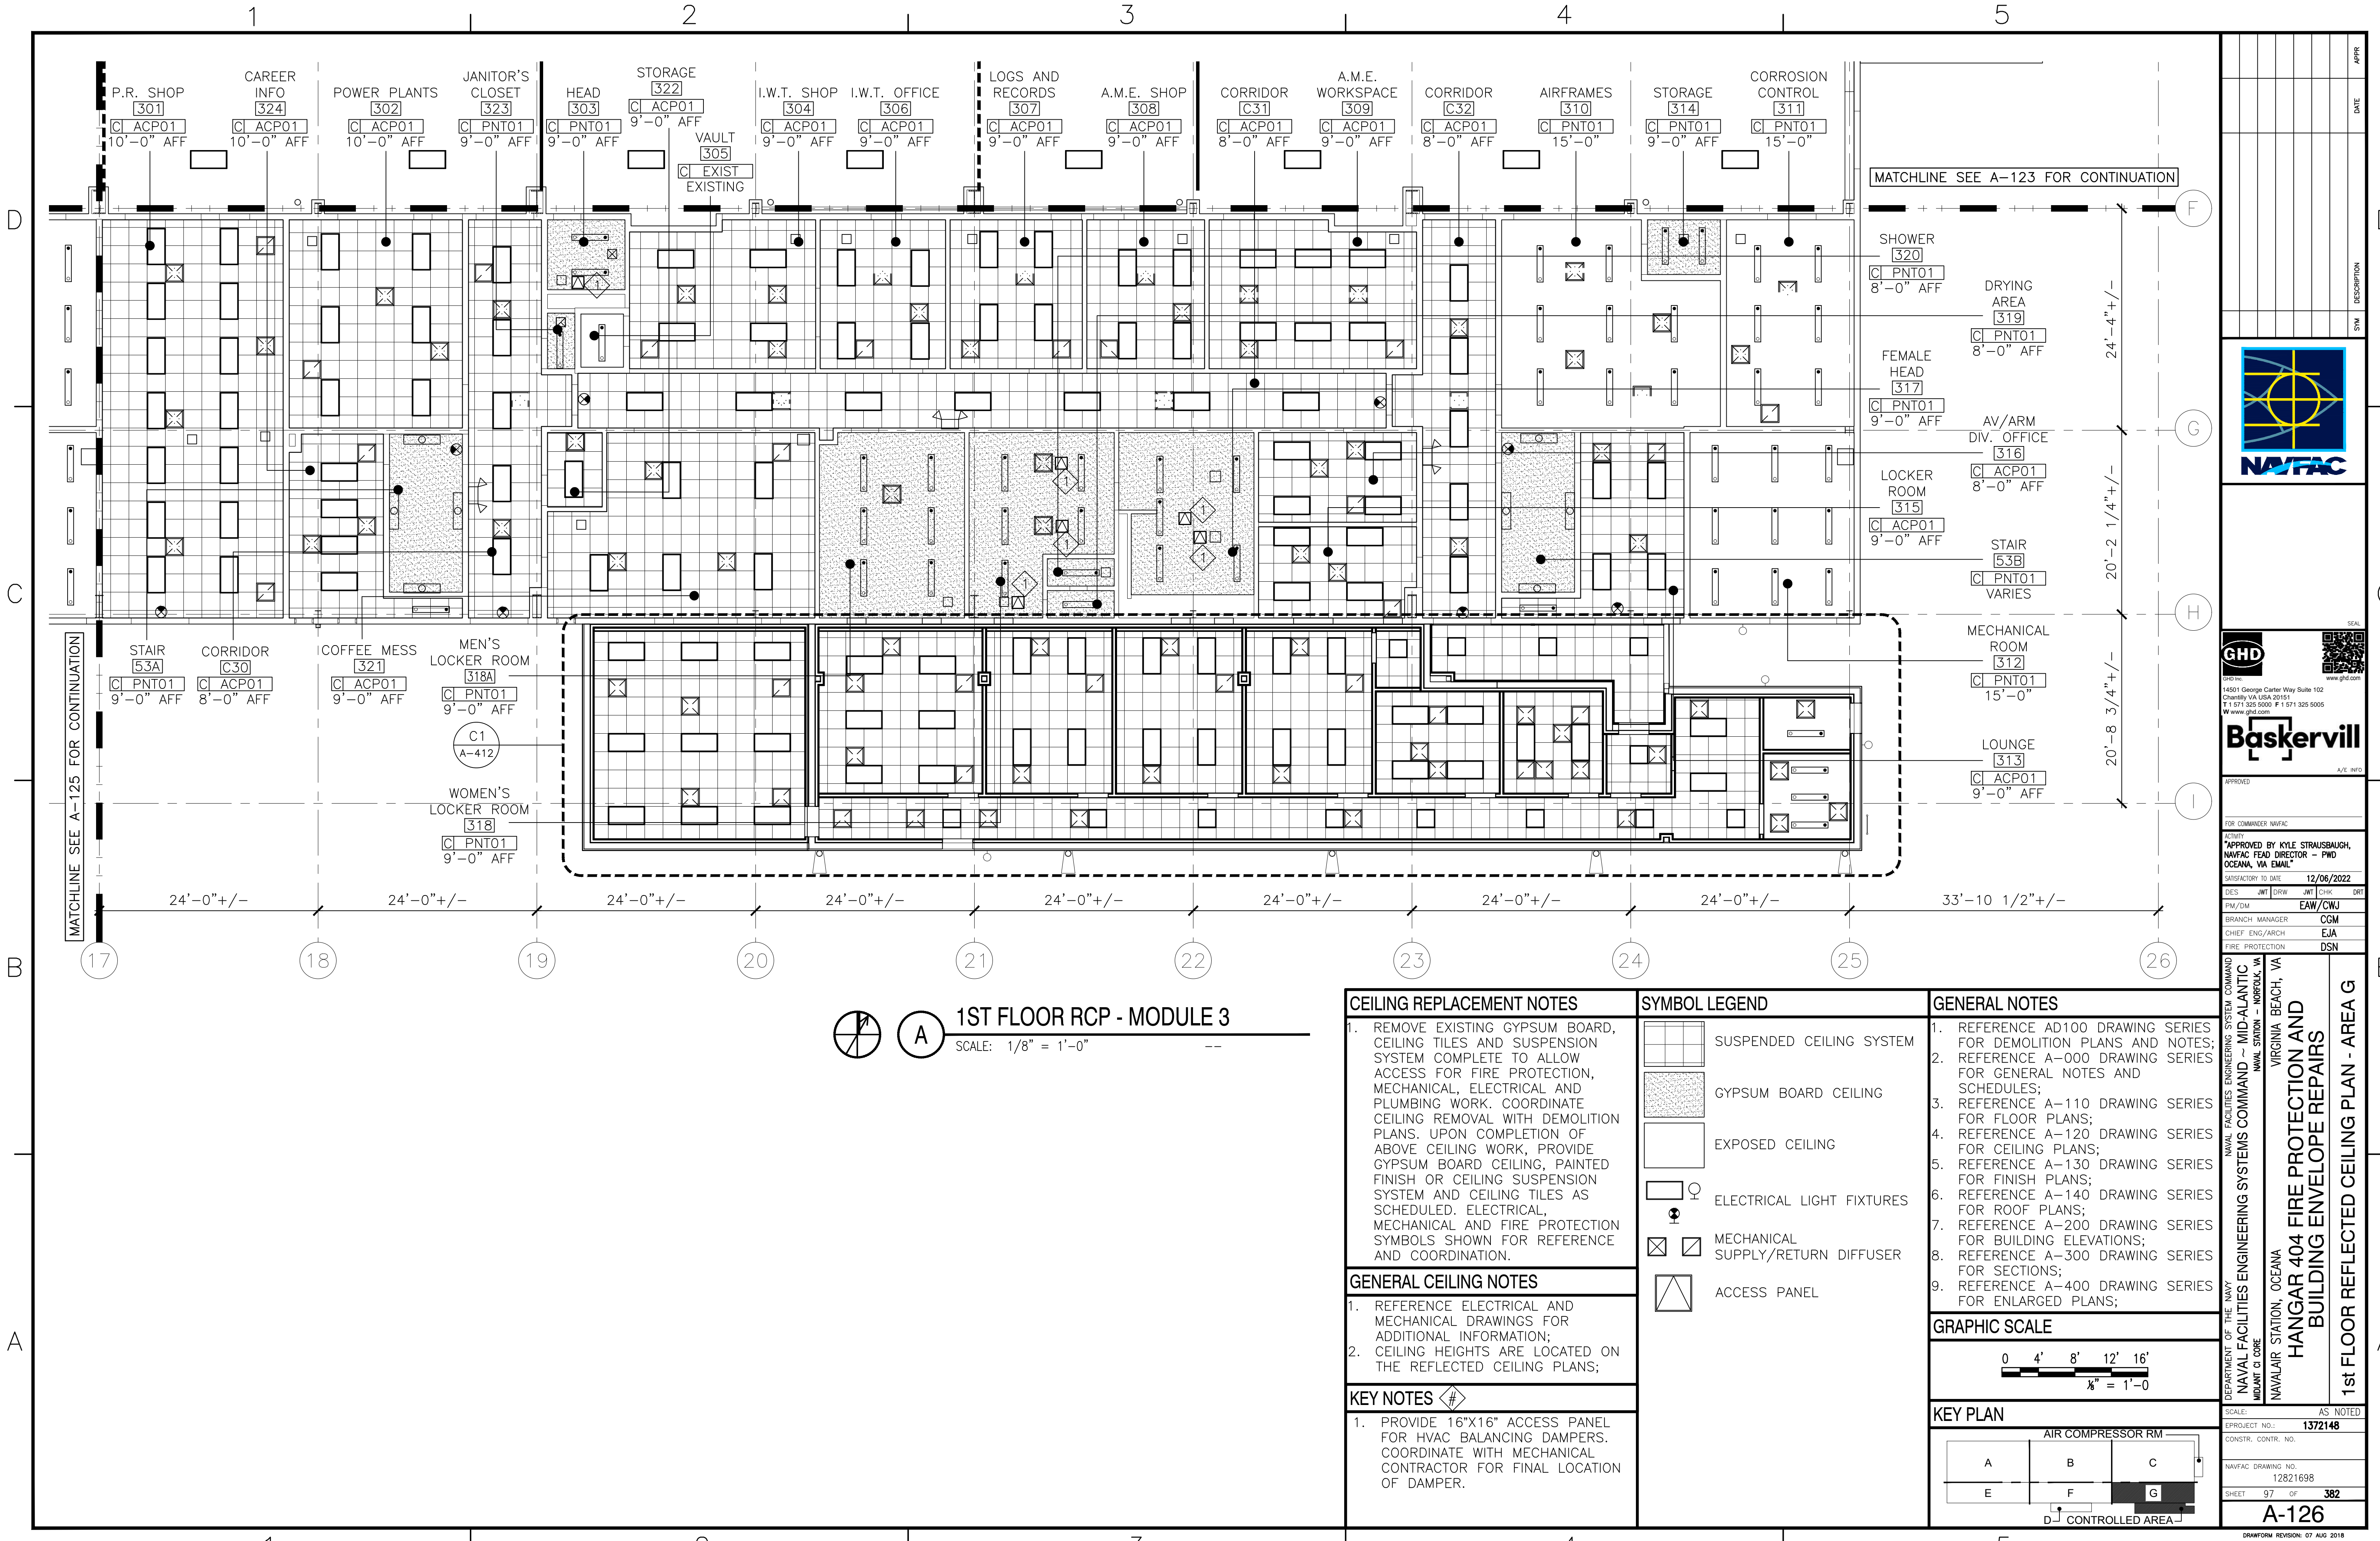

A

1ST FLOOR RCP - MODULE 3

SCALE: 1/8" = 1'-0"

CEILING REPLACEMENT NOTES

1. REMOVE EXISTING GYPSUM BOARD, CEILING TILES AND SUSPENSION SYSTEM COMPLETE TO ALLOW ACCESS FOR FIRE PROTECTION, MECHANICAL, ELECTRICAL AND PLUMBING WORK. COORDINATE CEILING REMOVAL WITH DEMOLITION PLANS. UPON COMPLETION OF ABOVE CEILING WORK, PROVIDE GYPSUM BOARD CEILING, PAINTED FINISH OR CEILING SUSPENSION SYSTEM AND CEILING TILES AS SCHEDULED. ELECTRICAL, MECHANICAL AND FIRE PROTECTION SYMBOLS SHOWN FOR REFERENCE AND COORDINATION.

GENERAL CEILING NOTES

1. REFERENCE ELECTRICAL AND MECHANICAL DRAWINGS FOR ADDITIONAL INFORMATION;
2. CEILING HEIGHTS ARE LOCATED ON THE REFLECTED CEILING PLANS;

KEY NOTES

1. PROVIDE 16"x16" ACCESS PANEL FOR HVAC BALANCING DAMPERS. COORDINATE WITH MECHANICAL CONTRACTOR FOR FINAL LOCATION OF DAMPER.


SYMBOL LEGEND

- SUSPENDED CEILING SYSTEM
- GYPSUM BOARD CEILING
- EXPOSED CEILING
- ELECTRICAL LIGHT FIXTURES
- MECHANICAL SUPPLY/RETURN DIFFUSER
- ACCESS PANEL


GENERAL NOTES

1. REFERENCE AD100 DRAWING SERIES FOR DEMOLITION PLANS AND NOTES;
2. REFERENCE A-000 DRAWING SERIES FOR GENERAL NOTES AND SCHEDULES;
3. REFERENCE A-110 DRAWING SERIES FOR FLOOR PLANS;
4. REFERENCE A-120 DRAWING SERIES FOR CEILING PLANS;
5. REFERENCE A-130 DRAWING SERIES FOR FINISH PLANS;
6. REFERENCE A-140 DRAWING SERIES FOR ROOF PLANS;
7. REFERENCE A-200 DRAWING SERIES FOR BUILDING ELEVATIONS;
8. REFERENCE A-300 DRAWING SERIES FOR SECTIONS;
9. REFERENCE A-400 DRAWING SERIES FOR ENLARGED PLANS;

GRAPHIC SCALE

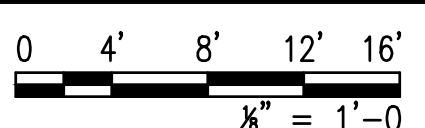

KEY PLAN

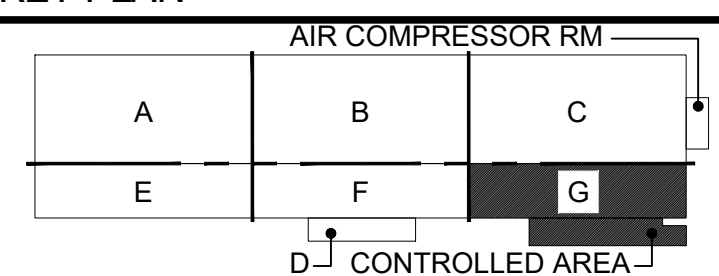

APPROVED		DATE	APPR
FOR COMMANDER NAVFAC			
"APPROVED BY KYLE STRAUSBAUGH, NAVFAC HEAD DIRECTOR - PWD OCEANA, VA EMAIL"			
SATISFACTORY TO DATE		12/06/2022	
DES	JMT	DRW	JMT
PM/DM			EAJ/CWJ
BRANCH MANAGER		CGM	
CHIEF ENG/ARCH		EJA	
FIRE PROTECTION		DSN	
NAVFAC DRAWING NO. 12821698			
SHEET 97 OF 382			
A-126			
DRAWING REVISION: 07 AUG 2018			

NAVFAC

GHD

Baskervill


14501 George Carter Way Suite 102
Chantilly VA USA 20151
T 1 571 335 5000 F 1 571 325 5005
W www.gnd.com

DEPARTMENT OF THE NAVY
NAVAL FACILITIES ENGINEERING SYSTEMS COMMAND
NAVAL STATION - NORFOLK, VA
VIRGINIA BEACH, VA

HANGAR 404 FIRE PROTECTION AND
BUILDING ENVELOPE REPAIRS

1st FLOOR REFLECTED CEILING PLAN - AREA G

FILE NAME: C:\od\temp\wPublish_24440\1372148-A-127.dwg LAYOUT NAME: Layout1 PLOTTED: Tuesday, December 06, 2022 - 8:15am USER: nsach

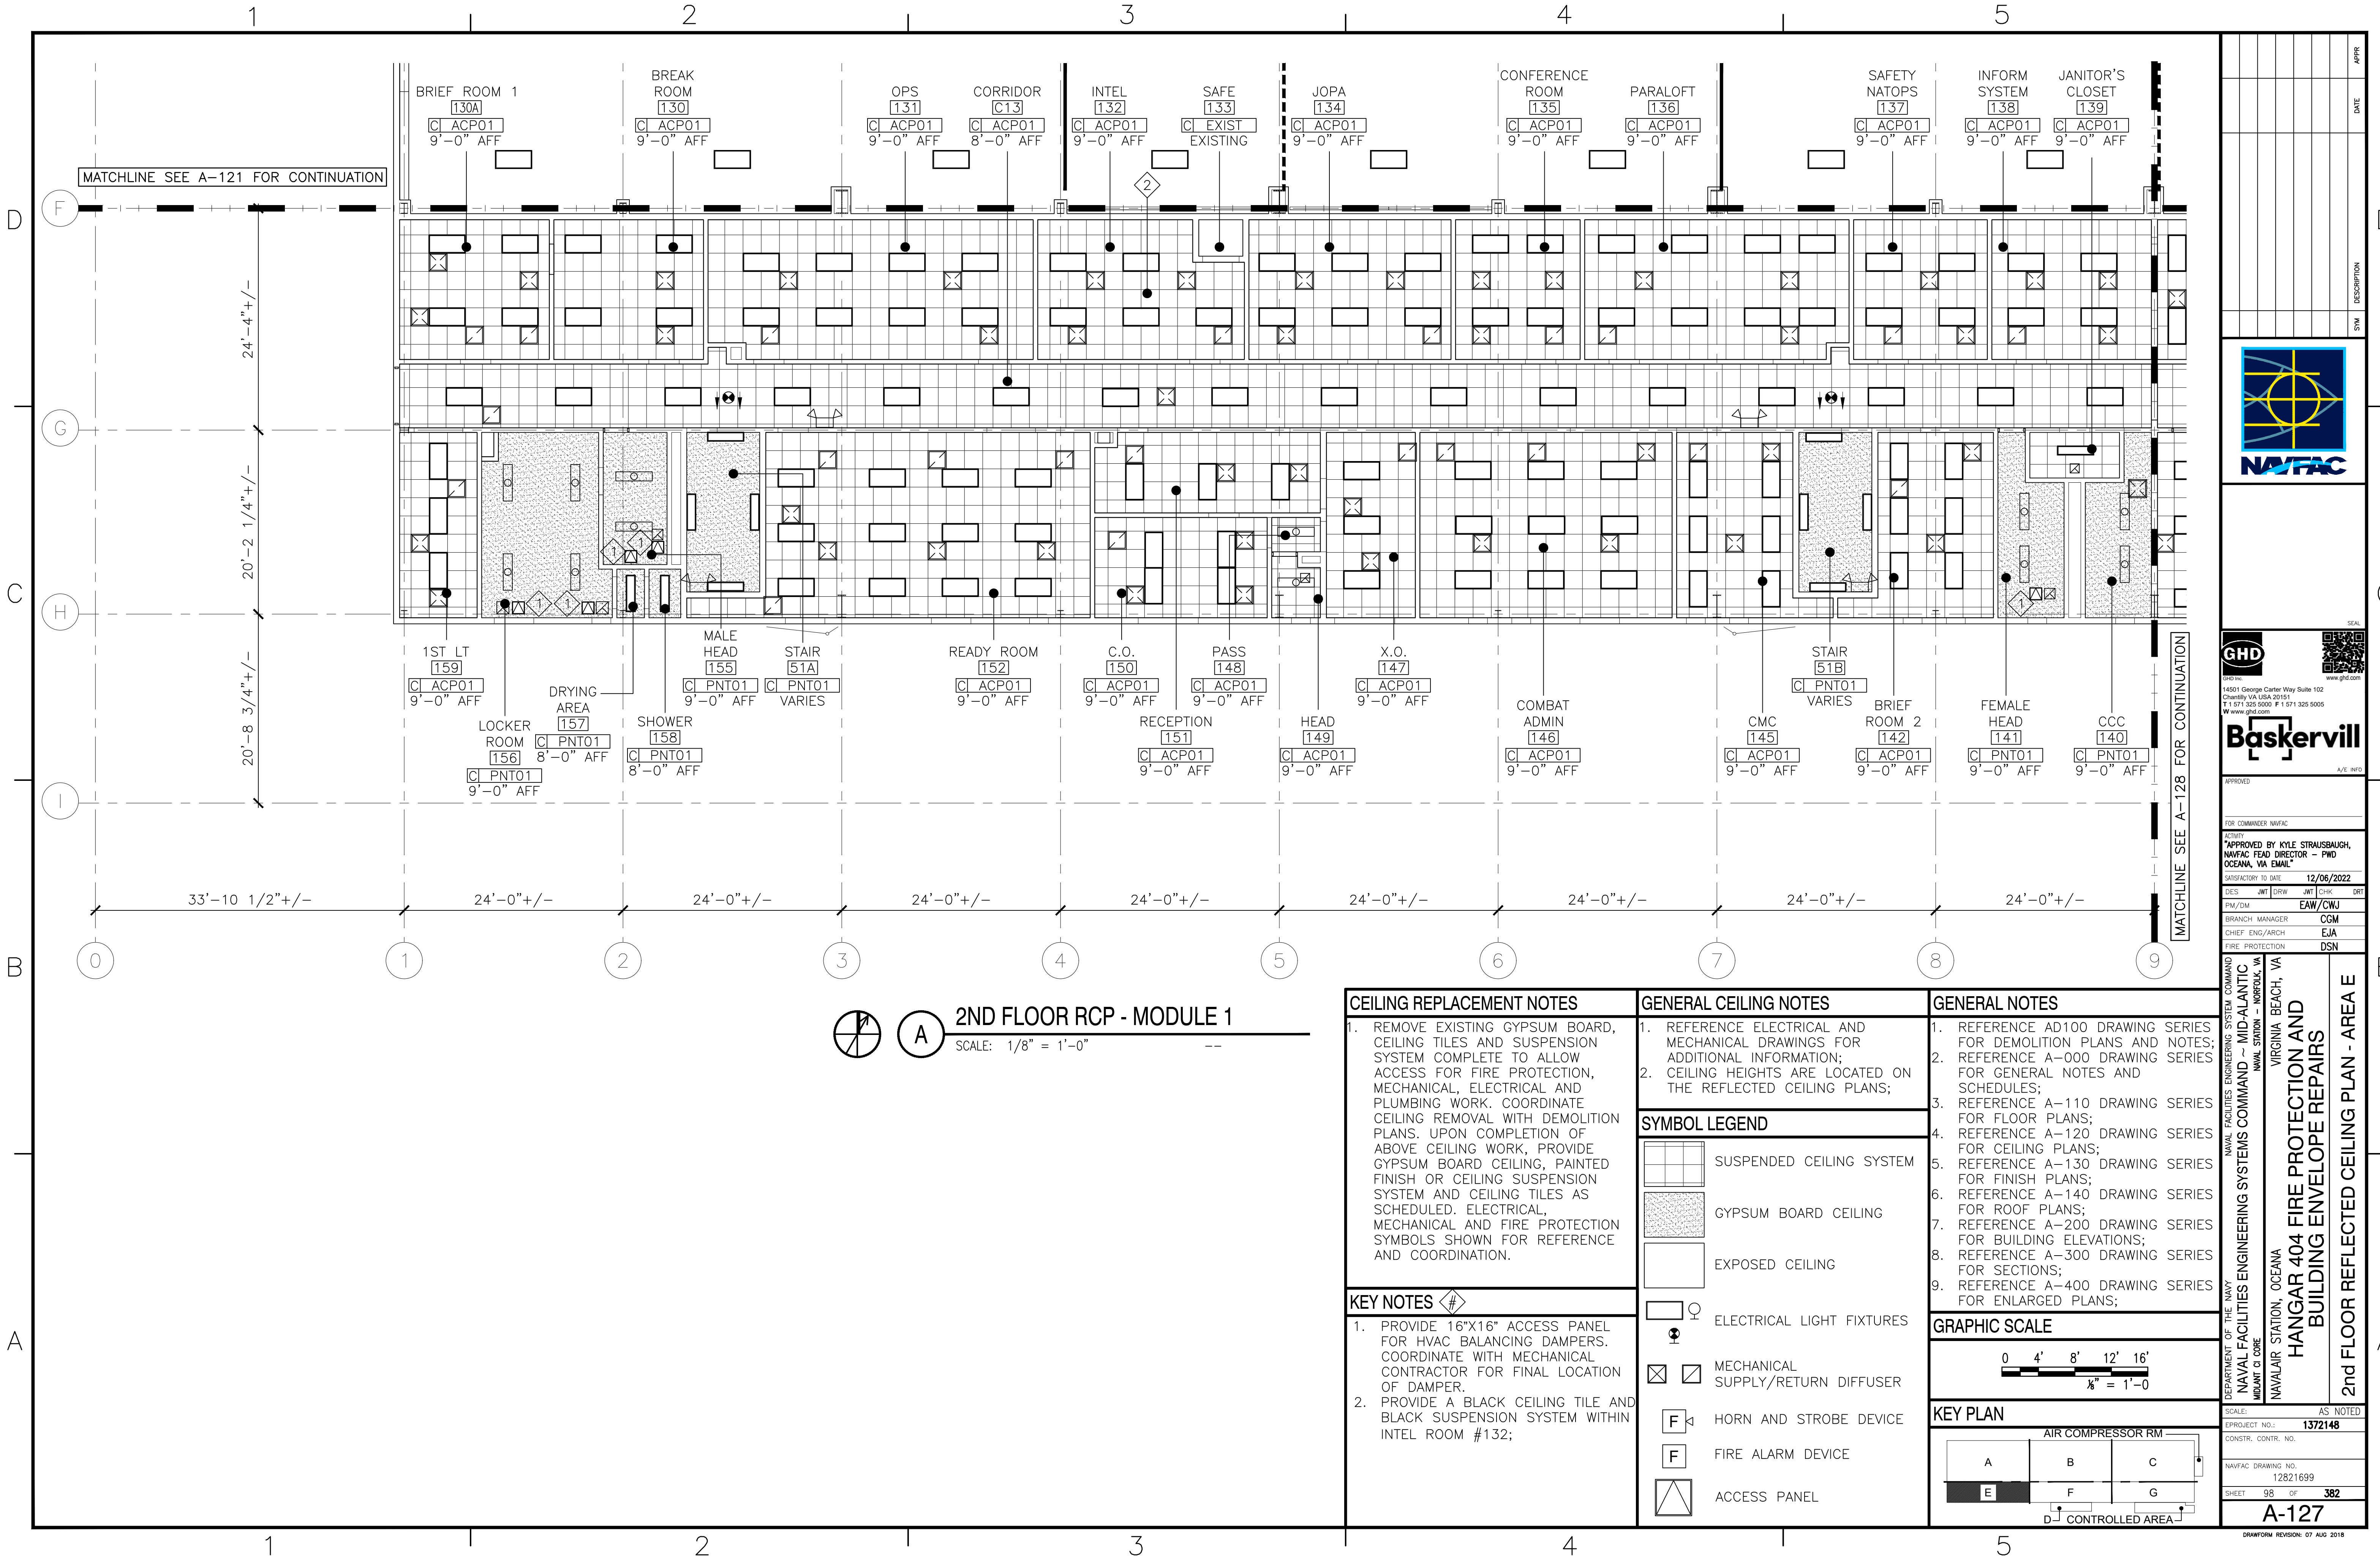


A 2ND FLOOR RCP - MODULE 1
SCALE: 1/8" = 1'-0" --

CEILING REPLACEMENT NOTES 1. REMOVE EXISTING GYPSUM BOARD, CEILING TILES AND SUSPENSION SYSTEM COMPLETE TO ALLOW ACCESS FOR FIRE PROTECTION, MECHANICAL, ELECTRICAL AND PLUMBING WORK. COORDINATE CEILING REMOVAL WITH DEMOLITION PLANS. UPON COMPLETION OF ABOVE CEILING WORK, PROVIDE GYPSUM BOARD CEILING, PAINTED FINISH OR CEILING SUSPENSION SYSTEM AND CEILING TILES AS SCHEDULED. ELECTRICAL, MECHANICAL AND FIRE PROTECTION SYMBOLS SHOWN FOR REFERENCE AND COORDINATION.	GENERAL CEILING NOTES 1. REFERENCE ELECTRICAL AND MECHANICAL DRAWINGS FOR ADDITIONAL INFORMATION; 2. CEILING HEIGHTS ARE LOCATED ON THE REFLECTED CEILING PLANS; SYMBOL LEGEND <table><tr><td></td><td>SUSPENDED CEILING SYSTEM</td></tr><tr><td></td><td>GYPSUM BOARD CEILING</td></tr><tr><td></td><td>EXPOSED CEILING</td></tr><tr><td></td><td>ELECTRICAL LIGHT FIXTURES</td></tr><tr><td></td><td>MECHANICAL SUPPLY/RETURN DIFFUSER</td></tr><tr><td></td><td>HORN AND STROBE DEVICE</td></tr><tr><td></td><td>FIRE ALARM DEVICE</td></tr><tr><td></td><td>ACCESS PANEL</td></tr></table>		SUSPENDED CEILING SYSTEM		GYPSUM BOARD CEILING		EXPOSED CEILING		ELECTRICAL LIGHT FIXTURES		MECHANICAL SUPPLY/RETURN DIFFUSER		HORN AND STROBE DEVICE		FIRE ALARM DEVICE		ACCESS PANEL	GENERAL NOTES 1. REFERENCE AD100 DRAWING SERIES FOR DEMOLITION PLANS AND NOTES; 2. REFERENCE A-000 DRAWING SERIES FOR GENERAL NOTES AND SCHEDULES; 3. REFERENCE A-110 DRAWING SERIES FOR FLOOR PLANS; 4. REFERENCE A-120 DRAWING SERIES FOR CEILING PLANS; 5. REFERENCE A-130 DRAWING SERIES FOR FINISH PLANS; 6. REFERENCE A-140 DRAWING SERIES FOR ROOF PLANS; 7. REFERENCE A-200 DRAWING SERIES FOR BUILDING ELEVATIONS; 8. REFERENCE A-300 DRAWING SERIES FOR SECTIONS; 9. REFERENCE A-400 DRAWING SERIES FOR ENLARGED PLANS; GRAPHIC SCALE 0 4' 8' 12' 16' 1/8" = 1'-0" KEY PLAN <table><tr><td colspan="3">AIR COMPRESSOR RM</td></tr><tr><td>A</td><td>B</td><td>C</td></tr><tr><td>E</td><td>F</td><td>G</td></tr></table> D CONTROLLED AREA	AIR COMPRESSOR RM			A	B	C	E	F	G
	SUSPENDED CEILING SYSTEM																										
	GYPSUM BOARD CEILING																										
	EXPOSED CEILING																										
	ELECTRICAL LIGHT FIXTURES																										
	MECHANICAL SUPPLY/RETURN DIFFUSER																										
	HORN AND STROBE DEVICE																										
	FIRE ALARM DEVICE																										
	ACCESS PANEL																										
AIR COMPRESSOR RM																											
A	B	C																									
E	F	G																									

APPROVED		DATE	APPR
FOR COMMANDER NAVFAC			
APPROVED BY KYLE STRAUSBAUGH, NAVFAC HEAD DIRECTOR - PWD OCEANA, VA EMAIL			
SATISFACTORY TO DATE		12/06/2022	
DES	JMT	DRW	JMT
PM/DM	EAW/CWJ		CHK
BRANCH MANAGER		CGM	
CHIEF ENG/ARCH		EJA	
FIRE PROTECTION		DSN	
DEPARTMENT OF THE NAVY NAVAL FACILITIES ENGINEERING SYSTEMS COMMAND NAVAL STATION - NORFOLK, VA NAVAL STATION - OCEANA, VIRGINIA BEACH, VA			
HANGAR 404 FIRE PROTECTION AND BUILDING ENVELOPE REPAIRS			
2nd FLOOR REFLECTED CEILING PLAN - AREA E			
SCALE: AS NOTED		PROJECT NO. 1372148	
CONSTR. CONTR. NO.			
NAVFAC DRAWING NO. 12821699			
SHEET 98 OF 382			
A-127			
DRAWING REVISION: 07 AUG 2018			

FILE NAME: C:\Users\rsnash\Desktop\1372148-A-128.dwg LAYOUT NAME: Layout1 PLOTTED: Tuesday, December 06, 2022 - 8:15am USER: rsnash

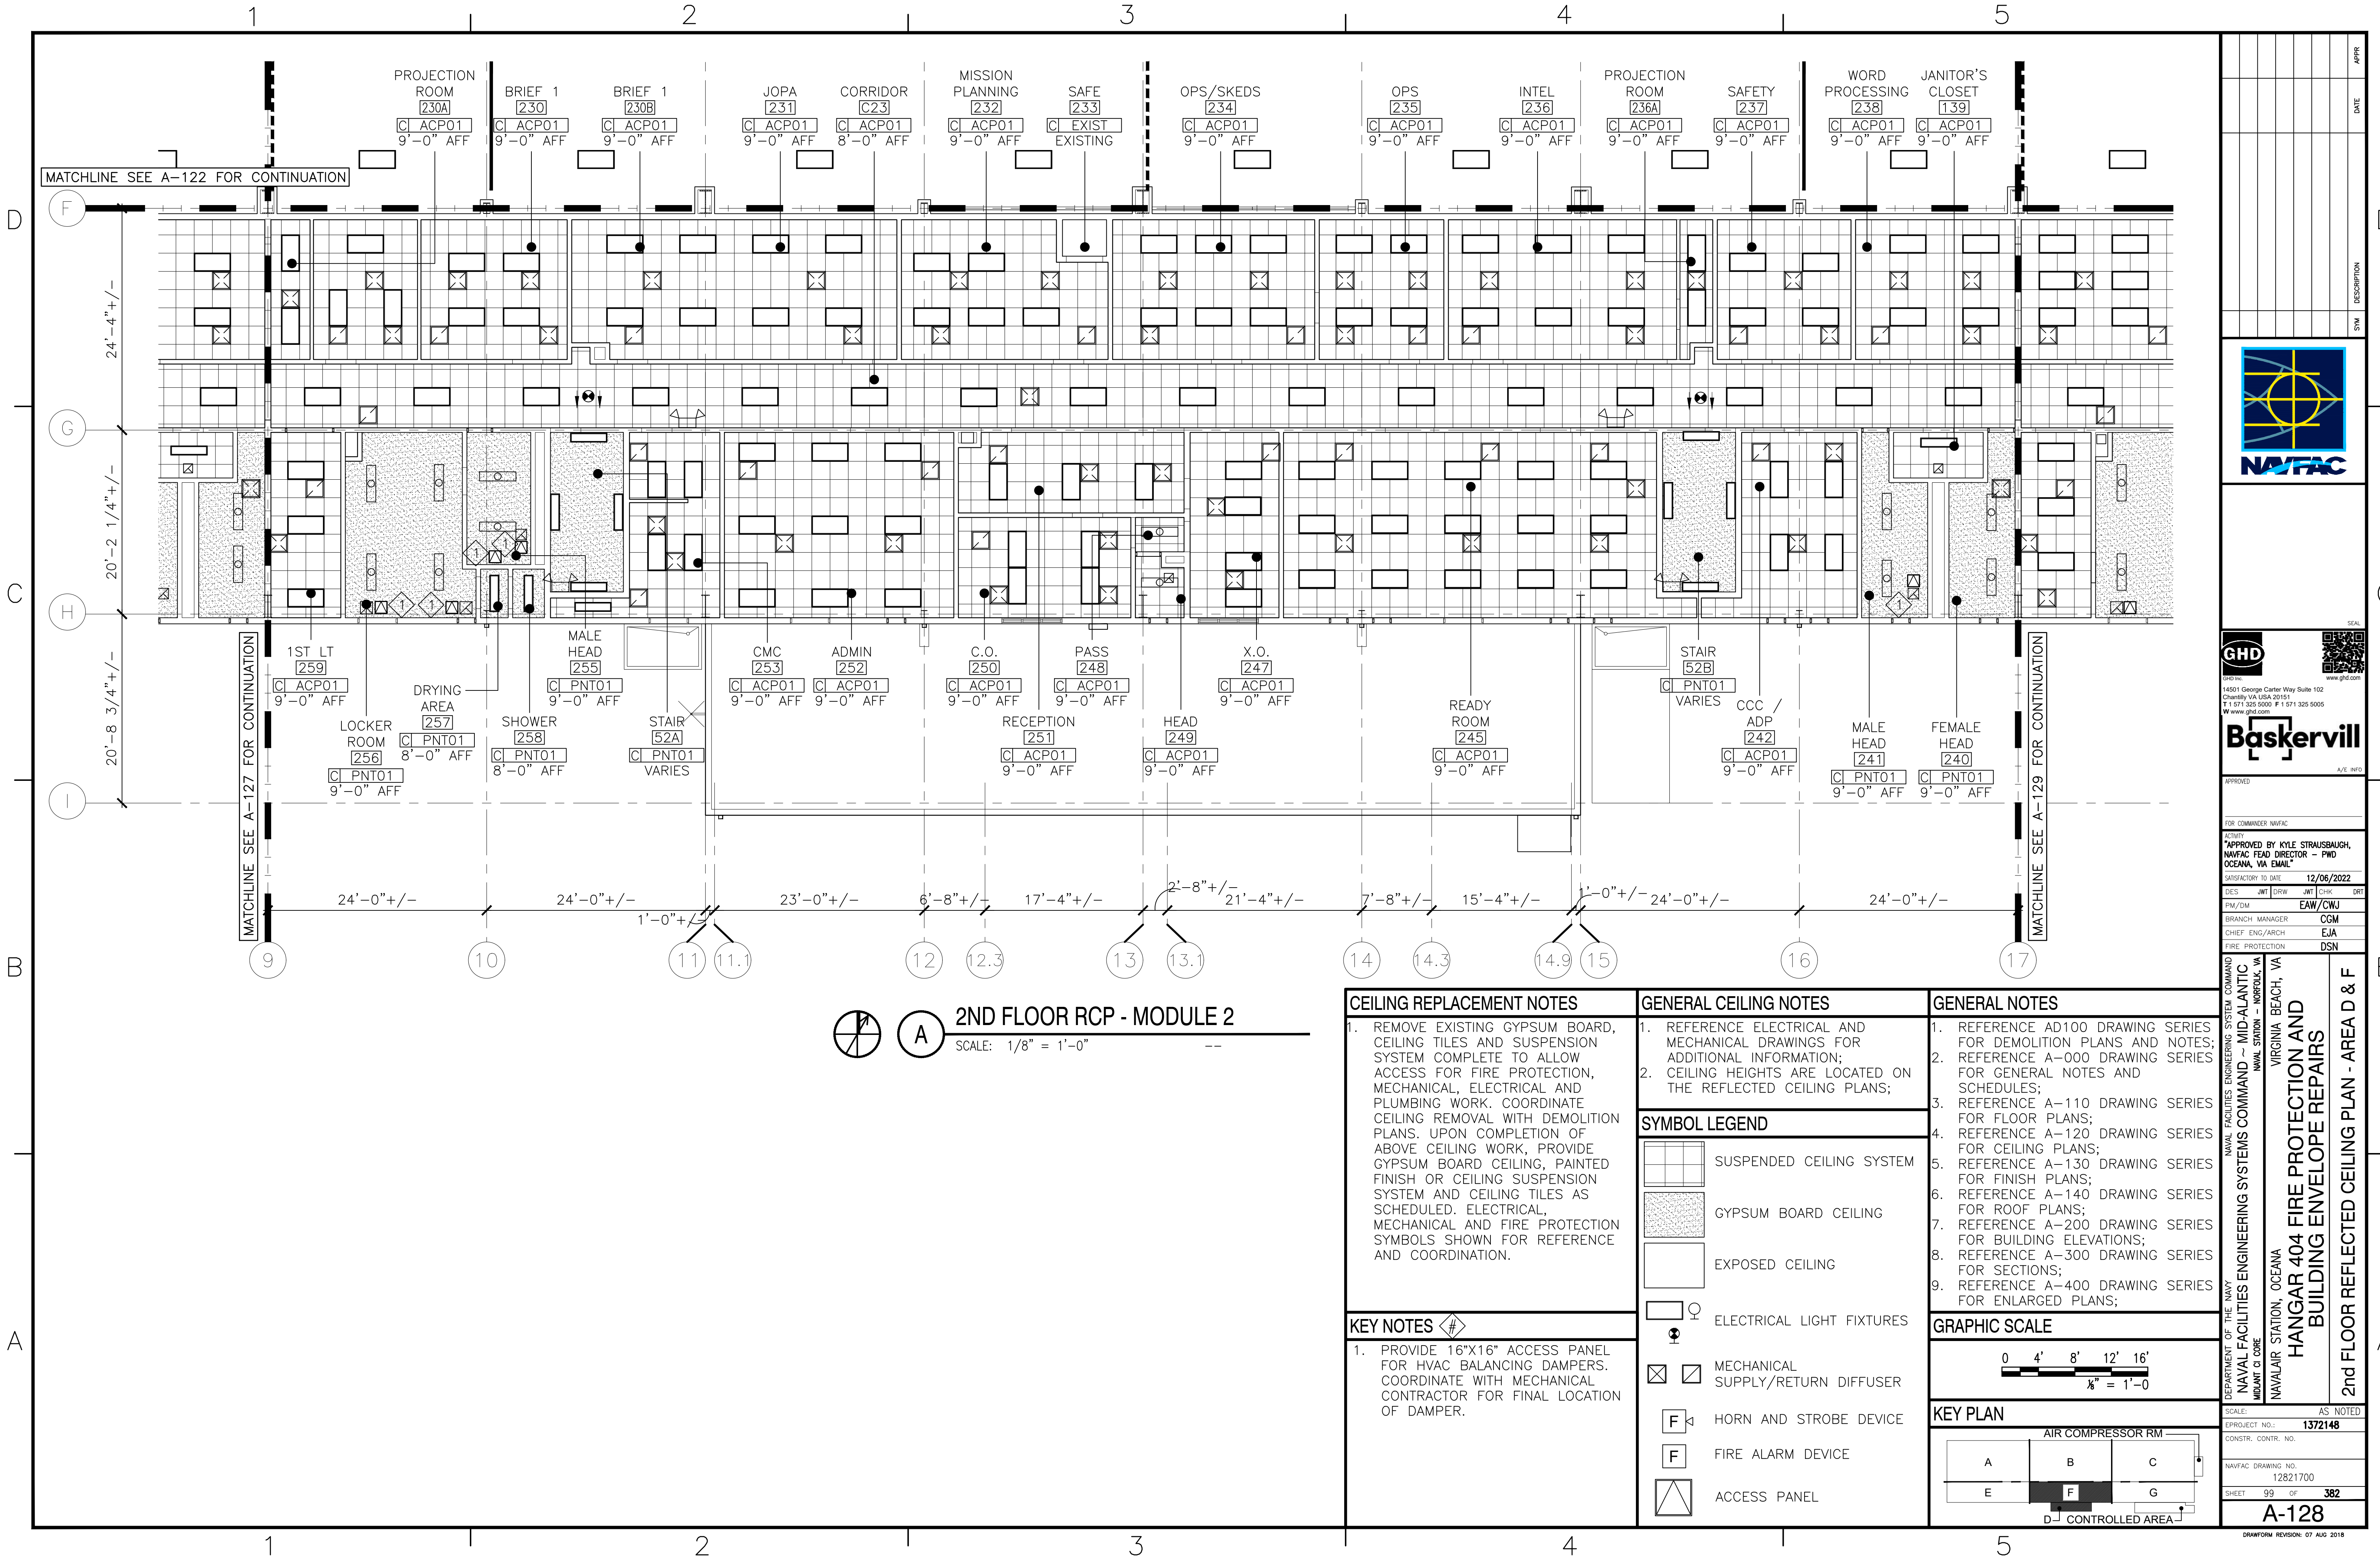

2ND FLOOR RCP - MODULE 2
SCALE: 1/8" = 1'-0"

CEILING REPLACEMENT NOTES

1. REMOVE EXISTING GYPSUM BOARD, CEILING TILES AND SUSPENSION SYSTEM COMPLETE TO ALLOW ACCESS FOR FIRE PROTECTION, MECHANICAL, ELECTRICAL AND PLUMBING WORK. COORDINATE CEILING REMOVAL WITH DEMOLITION PLANS. UPON COMPLETION OF ABOVE CEILING WORK, PROVIDE GYPSUM BOARD CEILING, PAINTED FINISH OR CEILING SUSPENSION SYSTEM AND CEILING TILES AS SCHEDULED. ELECTRICAL, MECHANICAL AND FIRE PROTECTION SYMBOLS SHOWN FOR REFERENCE AND COORDINATION.

KEY NOTES

1. PROVIDE 16"x16" ACCESS PANEL FOR HVAC BALANCING DAMPERS. COORDINATE WITH MECHANICAL CONTRACTOR FOR FINAL LOCATION OF DAMPER.

GENERAL CEILING NOTES

1. REFERENCE ELECTRICAL AND MECHANICAL DRAWINGS FOR ADDITIONAL INFORMATION;
2. CEILING HEIGHTS ARE LOCATED ON THE REFLECTED CEILING PLANS;


SYMBOL LEGEND

- SUSPENDED CEILING SYSTEM
- GYPSUM BOARD CEILING
- EXPOSED CEILING
- ELECTRICAL LIGHT FIXTURES
- MECHANICAL SUPPLY/RETURN DIFFUSER
- HORN AND STROBE DEVICE
- FIRE ALARM DEVICE
- ACCESS PANEL


GENERAL NOTES

1. REFERENCE AD100 DRAWING SERIES FOR DEMOLITION PLANS AND NOTES;
2. REFERENCE A-000 DRAWING SERIES FOR GENERAL NOTES AND SCHEDULES;
3. REFERENCE A-110 DRAWING SERIES FOR FLOOR PLANS;
4. REFERENCE A-120 DRAWING SERIES FOR CEILING PLANS;
5. REFERENCE A-130 DRAWING SERIES FOR FINISH PLANS;
6. REFERENCE A-140 DRAWING SERIES FOR ROOF PLANS;
7. REFERENCE A-200 DRAWING SERIES FOR BUILDING ELEVATIONS;
8. REFERENCE A-300 DRAWING SERIES FOR SECTIONS;
9. REFERENCE A-400 DRAWING SERIES FOR ENLARGED PLANS;

GRAPHIC SCALE

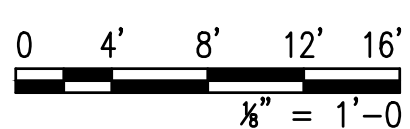


KEY PLAN

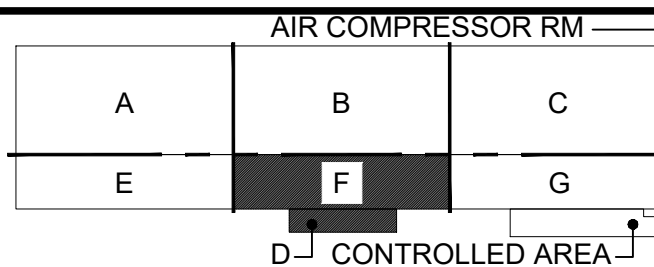





APPROVED		DATE	APPR
FOR COMMANDER NAVFAC			
APPROVED BY KYLE STRAUSBAUGH, NAVFAC HEAD DIRECTOR - PWD OCEANA, VA EMAIL: kyle.strausbaugh@navfac.navy.mil			
SATISFACTORY TO DATE: 12/06/2022			
DES	JMT	DRW	JMT
PM/DM			EAJ/CWJ
BRANCH MANAGER			CGM
CHIEF ENG/ARCH			EJA
FIRE PROTECTION			DSN
NAVAL FACILITIES ENGINEERING SYSTEM COMMAND NAVFAC FACILITIES ENGINEERING SYSTEMS COMMAND - MID-ATLANTIC NAVAL STATION - NORFOLK, VA		VIRGINIA BEACH, VA	
HANGAR 404 FIRE PROTECTION AND BUILDING ENVELOPE REPAIRS		2nd FLOOR REFLECTED CEILING PLAN - AREA D & F	
SCALE: AS NOTED		PROJECT NO.: 1372148	
CONSTR. CONTR. NO.		NAVFAC DRAWING NO.: 12821700	
SHEET 99 OF 382		A-128	
DRAWING REVISION: 07 AUG 2018			






 <h1>Baskerville</h1>										A/E INFO	
APPROVED											
FOR COMMANDER NAVFAC											
ACTIVITY *APPROVED BY KYLE STRAUSBAUGH, NAVFAC FEAD DIRECTOR - PWD OCEANA, VIA EMAIL*											
SATISFACTORY TO DATE								12/06/2022			
DES	JNT	DRW	JNT	CHK				DRT			
FM/DM								EAW/CWJ			
BRANCH MANAGER								CGM			
CHIEF ENG/ARCH								EJA			
FIRE PROTECTION								DSN			

DRAWFORM REVISION: 07 AUG 2018

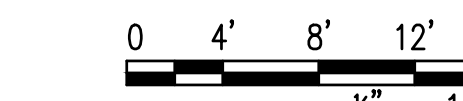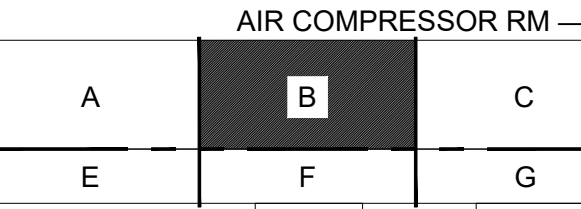KEY FINISH NOTES 	FLOOR STRIPING NOTES 	HANGAR FLOOR FINISH NOTES	GENERAL FINISH NOTES	GENERAL NOTES	GRAPHIC SCALE
1. PAINT EXTERIOR WALL, METAL PANEL ROOF SYSTEM, HANGAR DOORS AND TRACK FEDERAL STANDARD 27778 (WHITE) FULL HEIGHT. 2. PAINT INTERIOR WALL, STEEL BUILDING COLUMNS, STEEL BRACING AND DOOR ASSEMBLIES FEDERAL STANDARD 27778 (WHITE) FULL HEIGHT. 3. HANGAR EXISTING FLOOR TRENCH SYSTEM. 4. PAINT A 12-INCH WIDE STRIPE FROM HANGAR FLOOR TO UNDERSIDE OF ROOF DECK TO SEPARATE FIRE PROTECTION ZONES. PAINT STRIPE FEDERAL STANDARD 21105 – RED.	1. SAFETY LANE; 5–FEET WIDE STRIPE. COLOR – SAFETY YELLOW. FLOOR STRIPING MUST BE PREPARED AND PROVIDED PER ILDFA SPECIFICATION. 2. SAFETY LANE; 5–FEET WITH 6-INCH BOUNDARIES AND 6-INCH DIAGONAL STRIPES AT LOCATIONS WHERE THERE IS RISK OF BEING HIT BY VEHICLES; HANGAR DOORS. FLOOR STRIPING MUST BE PREPARED AND PROVIDED PER ILDFA SPECIFICATION. COLOR – YELLOW; 3. 6-INCH WIDE SOLID WHITE AIRCRAFT SAFETY PERIMETER LINE. FLOOR STRIPING MUST BE PREPARED AND PROVIDED PER ILDFA SPECIFICATION.	1. THE HANGAR FLOOR CONCRETE SLAB THAT MUST BE REPLACED AND IS COVERED BY THE ILDFA SYSTEM MUST RECEIVE CONCRETE SEALER FLOOR FINISH AS SCHEDULED (REFERENCE STRUCTURAL DRAWINGS FOR CONCRETE SLAB REPLACEMENT AREAS). THE HANGAR FLOOR TRENCH SYSTEM IS EXCLUDED FROM THIS SCOPE AND MUST NOT RECEIVE CONCRETE SEALER FLOOR FINISH. 2. THE REMAINDER OF THE HANGAR FLOOR CONCRETE SLAB THAT IS EXPOSED MUST RECEIVE 3–COAT EPOXY FLOOR SYSTEM. AREA OF COVERAGE IS FROM COLUMN LINE 1 TO 25 AND 14–FEET FROM FACE OF WALL ALONG COLUMN LINE F.	1. EXTERIOR APPEARANCE MUST FOLLOW THE NAVAL AIR STATION OCEANA INSTALLATION APPEARANCE PLAN FOR AIRFIELD DISTRICTS; 2. REFERENCE A–010 SERIES OF DRAWINGS FOR FINISH LEGEND, FINISH SCHEDULE, EXTERIOR MASONRY WALL PREP AND PAINT NOTES AND ADDITIONAL FINISH INFORMATION; 3. PATCH AND REPAIR EXISTING WALL SURFACES FOR HOLES, CRACKS AND DISTURBANCES CAUSED FROM REMOVED WALL HANGERS, SUPPORTS, PIPE, EQUIPMENT, MECHANICAL AND ELECTRICAL DEVICES AND OUTLETS, ATTACHMENTS, FURNISHINGS, ETC.	1. REFERENCE AD100 DRAWING SERIES FOR DEMOLITION PLANS AND NOTES; 2. REFERENCE A–000 DRAWING SERIES FOR GENERAL NOTES AND SCHEDULES; 3. REFERENCE A–110 DRAWING SERIES FOR FLOOR PLANS; 4. REFERENCE A–120 DRAWING SERIES FOR CEILING PLANS; 5. REFERENCE A–130 DRAWING SERIES FOR FINISH PLANS; 6. REFERENCE A–140 DRAWING SERIES FOR ROOF PLANS; 7. REFERENCE A–200 DRAWING SERIES FOR BUILDING ELEVATIONS; 8. REFERENCE A–300 DRAWING SERIES FOR SECTIONS; 9. REFERENCE A–400 DRAWING SERIES FOR ENLARGED PLANS;	
ILDFA NOTES ILDFA = IGNITABLE LIQUID DRAINAGE FLOOR ASSEMBLY					KEY PLAN 

FILE NAME: \\gdrna\gnd\US\Chantilly\Projects\585\11203487\Digital_Design\1 - CAD\3.1.2 - Sheet\05b - Architectural\2022 11 18 Final\1372 48-A-134.dwg LAYOUT NAME: Layout1 PLOTED: Monday, December 05, 2022 - 1:42pm USER: nsah

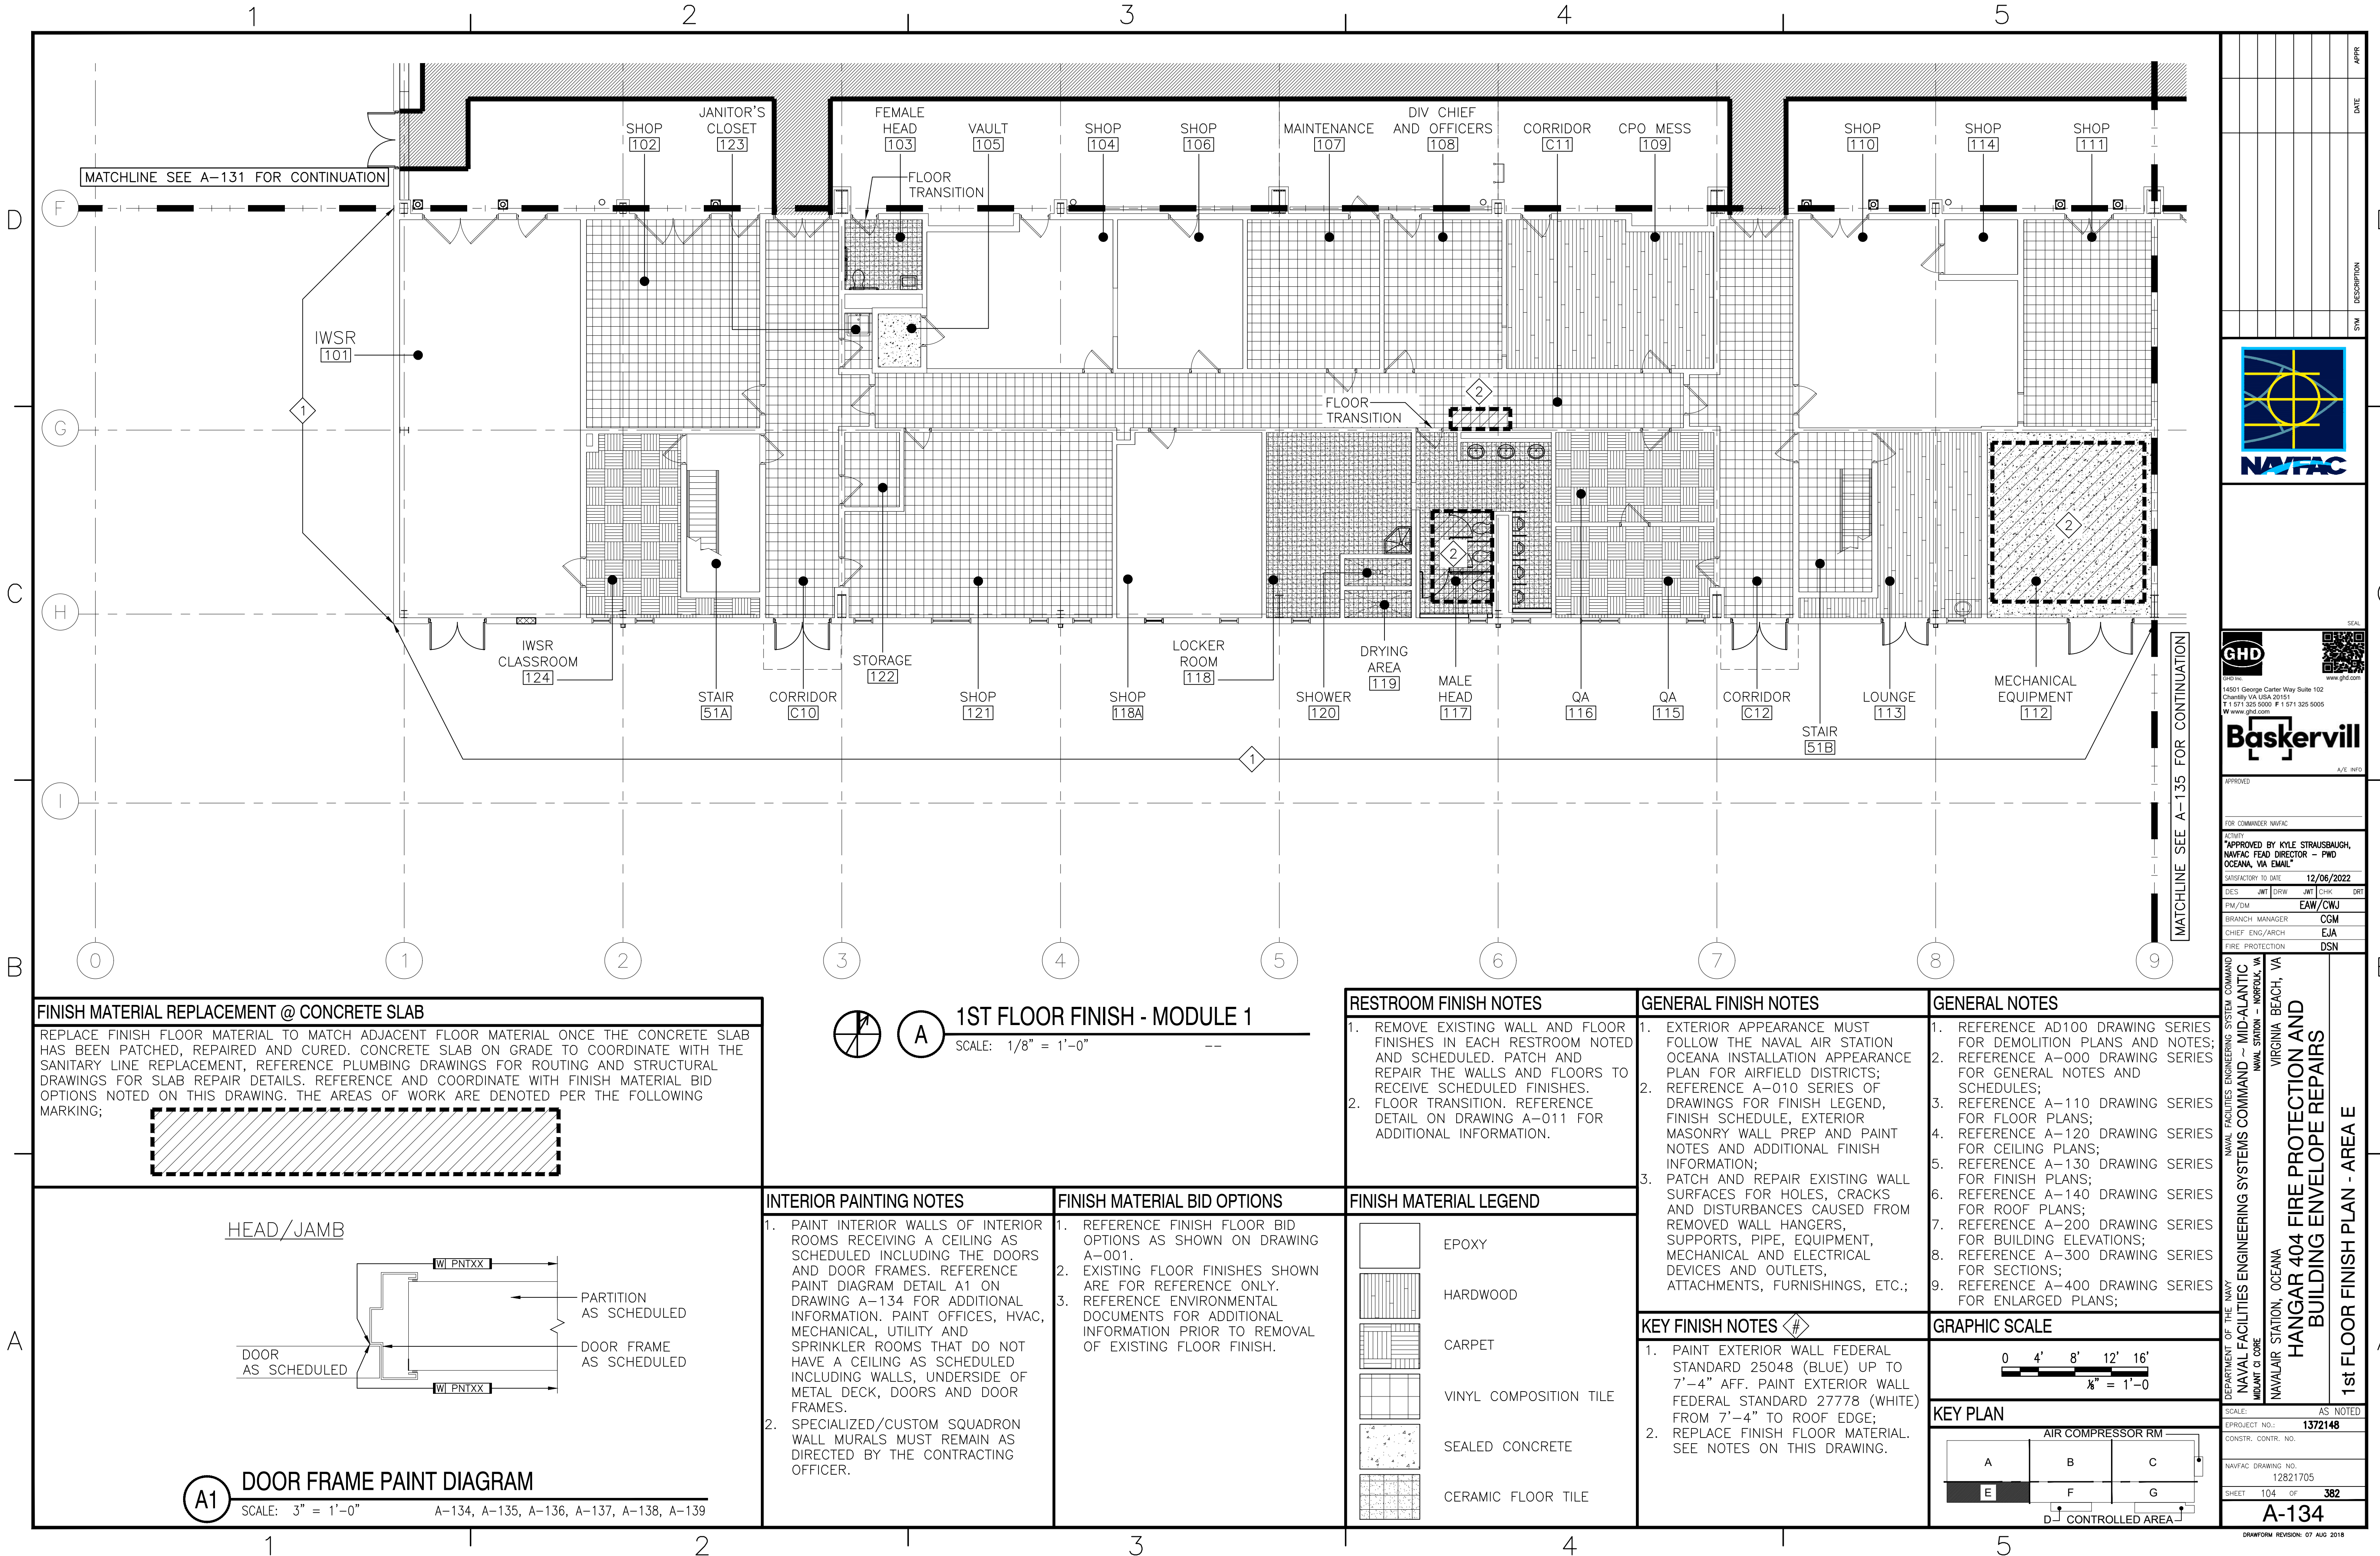

FINISH MATERIAL REPLACEMENT @ CONCRETE SLAB

REPLACE FINISH FLOOR MATERIAL TO MATCH ADJACENT FLOOR MATERIAL ONCE THE CONCRETE SLAB HAS BEEN PATCHED, REPAIRED AND CURED. CONCRETE SLAB ON GRADE TO COORDINATE WITH THE SANITARY LINE REPLACEMENT, REFERENCE PLUMBING DRAWINGS FOR ROUTING AND STRUCTURAL DRAWINGS FOR SLAB REPAIR DETAILS. REFERENCE AND COORDINATE WITH FINISH MATERIAL BID OPTIONS NOTED ON THIS DRAWING. THE AREAS OF WORK ARE DENOTED PER THE FOLLOWING MARKING;

HEAD/JAMB

PARTITION AS SCHEDULED

DOOR AS SCHEDULED

DOOR FRAME AS SCHEDULED

A1

DOOR FRAME PAINT DIAGRAM

SCALE: 3" = 1'-0" A-134, A-135, A-136, A-137, A-138, A-139

A

1ST FLOOR FINISH - MODULE 1

SCALE: 1/8" = 1'-0" --

INTERIOR PAINTING NOTES

1. PAINT INTERIOR WALLS OF INTERIOR ROOMS RECEIVING A CEILING AS SCHEDULED INCLUDING THE DOORS AND DOOR FRAMES. REFERENCE PAINT DIAGRAM DETAIL A1 ON DRAWING A-134 FOR ADDITIONAL INFORMATION. PAINT OFFICES, HVAC, MECHANICAL, UTILITY AND SPRINKLER ROOMS THAT DO NOT HAVE A CEILING AS SCHEDULED INCLUDING WALLS, UNDERSIDE OF METAL DECK, DOORS AND DOOR FRAMES.

2. SPECIALIZED/CUSTOM SQUADRON WALL MURALS MUST REMAIN AS DIRECTED BY THE CONTRACTING OFFICER.

FINISH MATERIAL BID OPTIONS

1. REFERENCE FINISH FLOOR BID OPTIONS AS SHOWN ON DRAWING A-001.

2. EXISTING FLOOR FINISHES SHOWN ARE FOR REFERENCE ONLY.

3. REFERENCE ENVIRONMENTAL DOCUMENTS FOR ADDITIONAL INFORMATION PRIOR TO REMOVAL OF EXISTING FLOOR FINISH.

RESTROOM FINISH NOTES

1. REMOVE EXISTING WALL AND FLOOR FINISHES IN EACH RESTROOM NOTED AND SCHEDULED. PATCH AND REPAIR THE WALLS AND FLOORS TO RECEIVE SCHEDULED FINISHES.

2. FLOOR TRANSITION. REFERENCE DETAIL ON DRAWING A-011 FOR ADDITIONAL INFORMATION.

FINISH MATERIAL LEGEND

EPOXY

HARDWOOD

CARPET

VINYL COMPOSITION TILE

SEALED CONCRETE

CERAMIC FLOOR TILE

GENERAL FINISH NOTES

1. EXTERIOR APPEARANCE MUST FOLLOW THE NAVAL AIR STATION OCEANA INSTALLATION APPEARANCE PLAN FOR AIRFIELD DISTRICTS;

2. REFERENCE A-010 SERIES OF DRAWINGS FOR FINISH LEGEND, FINISH SCHEDULE, EXTERIOR MASONRY WALL PREP AND PAINT NOTES AND ADDITIONAL FINISH INFORMATION;

3. PATCH AND REPAIR EXISTING WALL SURFACES FOR HOLES, CRACKS AND DISTURBANCES CAUSED FROM REMOVED WALL HANGERS, SUPPORTS, PIPE, EQUIPMENT, MECHANICAL AND ELECTRICAL DEVICES AND OUTLETS, ATTACHMENTS, FURNISHINGS, ETC.;

KEY FINISH NOTES

1. PAINT EXTERIOR WALL FEDERAL STANDARD 25048 (BLUE) UP TO 7'-4" AFF. PAINT EXTERIOR WALL FEDERAL STANDARD 27778 (WHITE) FROM 7'-4" TO ROOF EDGE;

2. REPLACE FINISH FLOOR MATERIAL. SEE NOTES ON THIS DRAWING.

GENERAL NOTES

1. REFERENCE AD100 DRAWING SERIES FOR DEMOLITION PLANS AND NOTES;

2. REFERENCE A-000 DRAWING SERIES FOR GENERAL NOTES AND SCHEDULES;

3. REFERENCE A-110 DRAWING SERIES FOR FLOOR PLANS;

4. REFERENCE A-120 DRAWING SERIES FOR CEILING PLANS;

5. REFERENCE A-130 DRAWING SERIES FOR FINISH PLANS;

6. REFERENCE A-140 DRAWING SERIES FOR ROOF PLANS;

7. REFERENCE A-200 DRAWING SERIES FOR BUILDING ELEVATIONS;

8. REFERENCE A-300 DRAWING SERIES FOR SECTIONS;

9. REFERENCE A-400 DRAWING SERIES FOR ENLARGED PLANS;

GRAPHIC SCALE

0 4' 8' 12' 16'

1/8" = 1'-0"

KEY PLAN

AIR COMPRESSOR RM

A B C

E F G

D CONTROLLED AREA

APPROVED

FOR COMMANDER NAVFAC

APPROVED BY KYLE STRAUSSBAUGH, NAVFAC HEAD DIRECTOR - PWD OCEANA, VA EMAIL

SATISFACTORY TO DATE: 12/06/2022

DES: JMT JMT CHK: JMT DRT: JMT

PM/DM: EAW/CWJ

BRANCH MANAGER: CGM

CHIEF ENG/ARCH: EJA

FIRE PROTECTION: DSN

NAVAL FACILITIES ENGINEERING SYSTEMS COMMAND - MID-ATLANTIC NAVAL STATION - NORFOLK, VA VIRGINIA BEACH, VA

NAVAL AIR STATION, OCEANA HANGAR 404 FIRE PROTECTION AND BUILDING ENVELOPE REPAIRS

1st FLOOR FINISH PLAN - AREA E

SCALE: AS NOTED

PROJECT NO.: 1372148

CONSTR. CONTR. NO.


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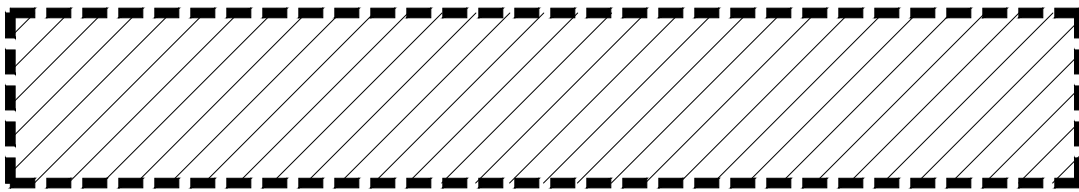
SHEET 104 OF 382








A-134

DRAWING REVISION: 07 AUG 2018

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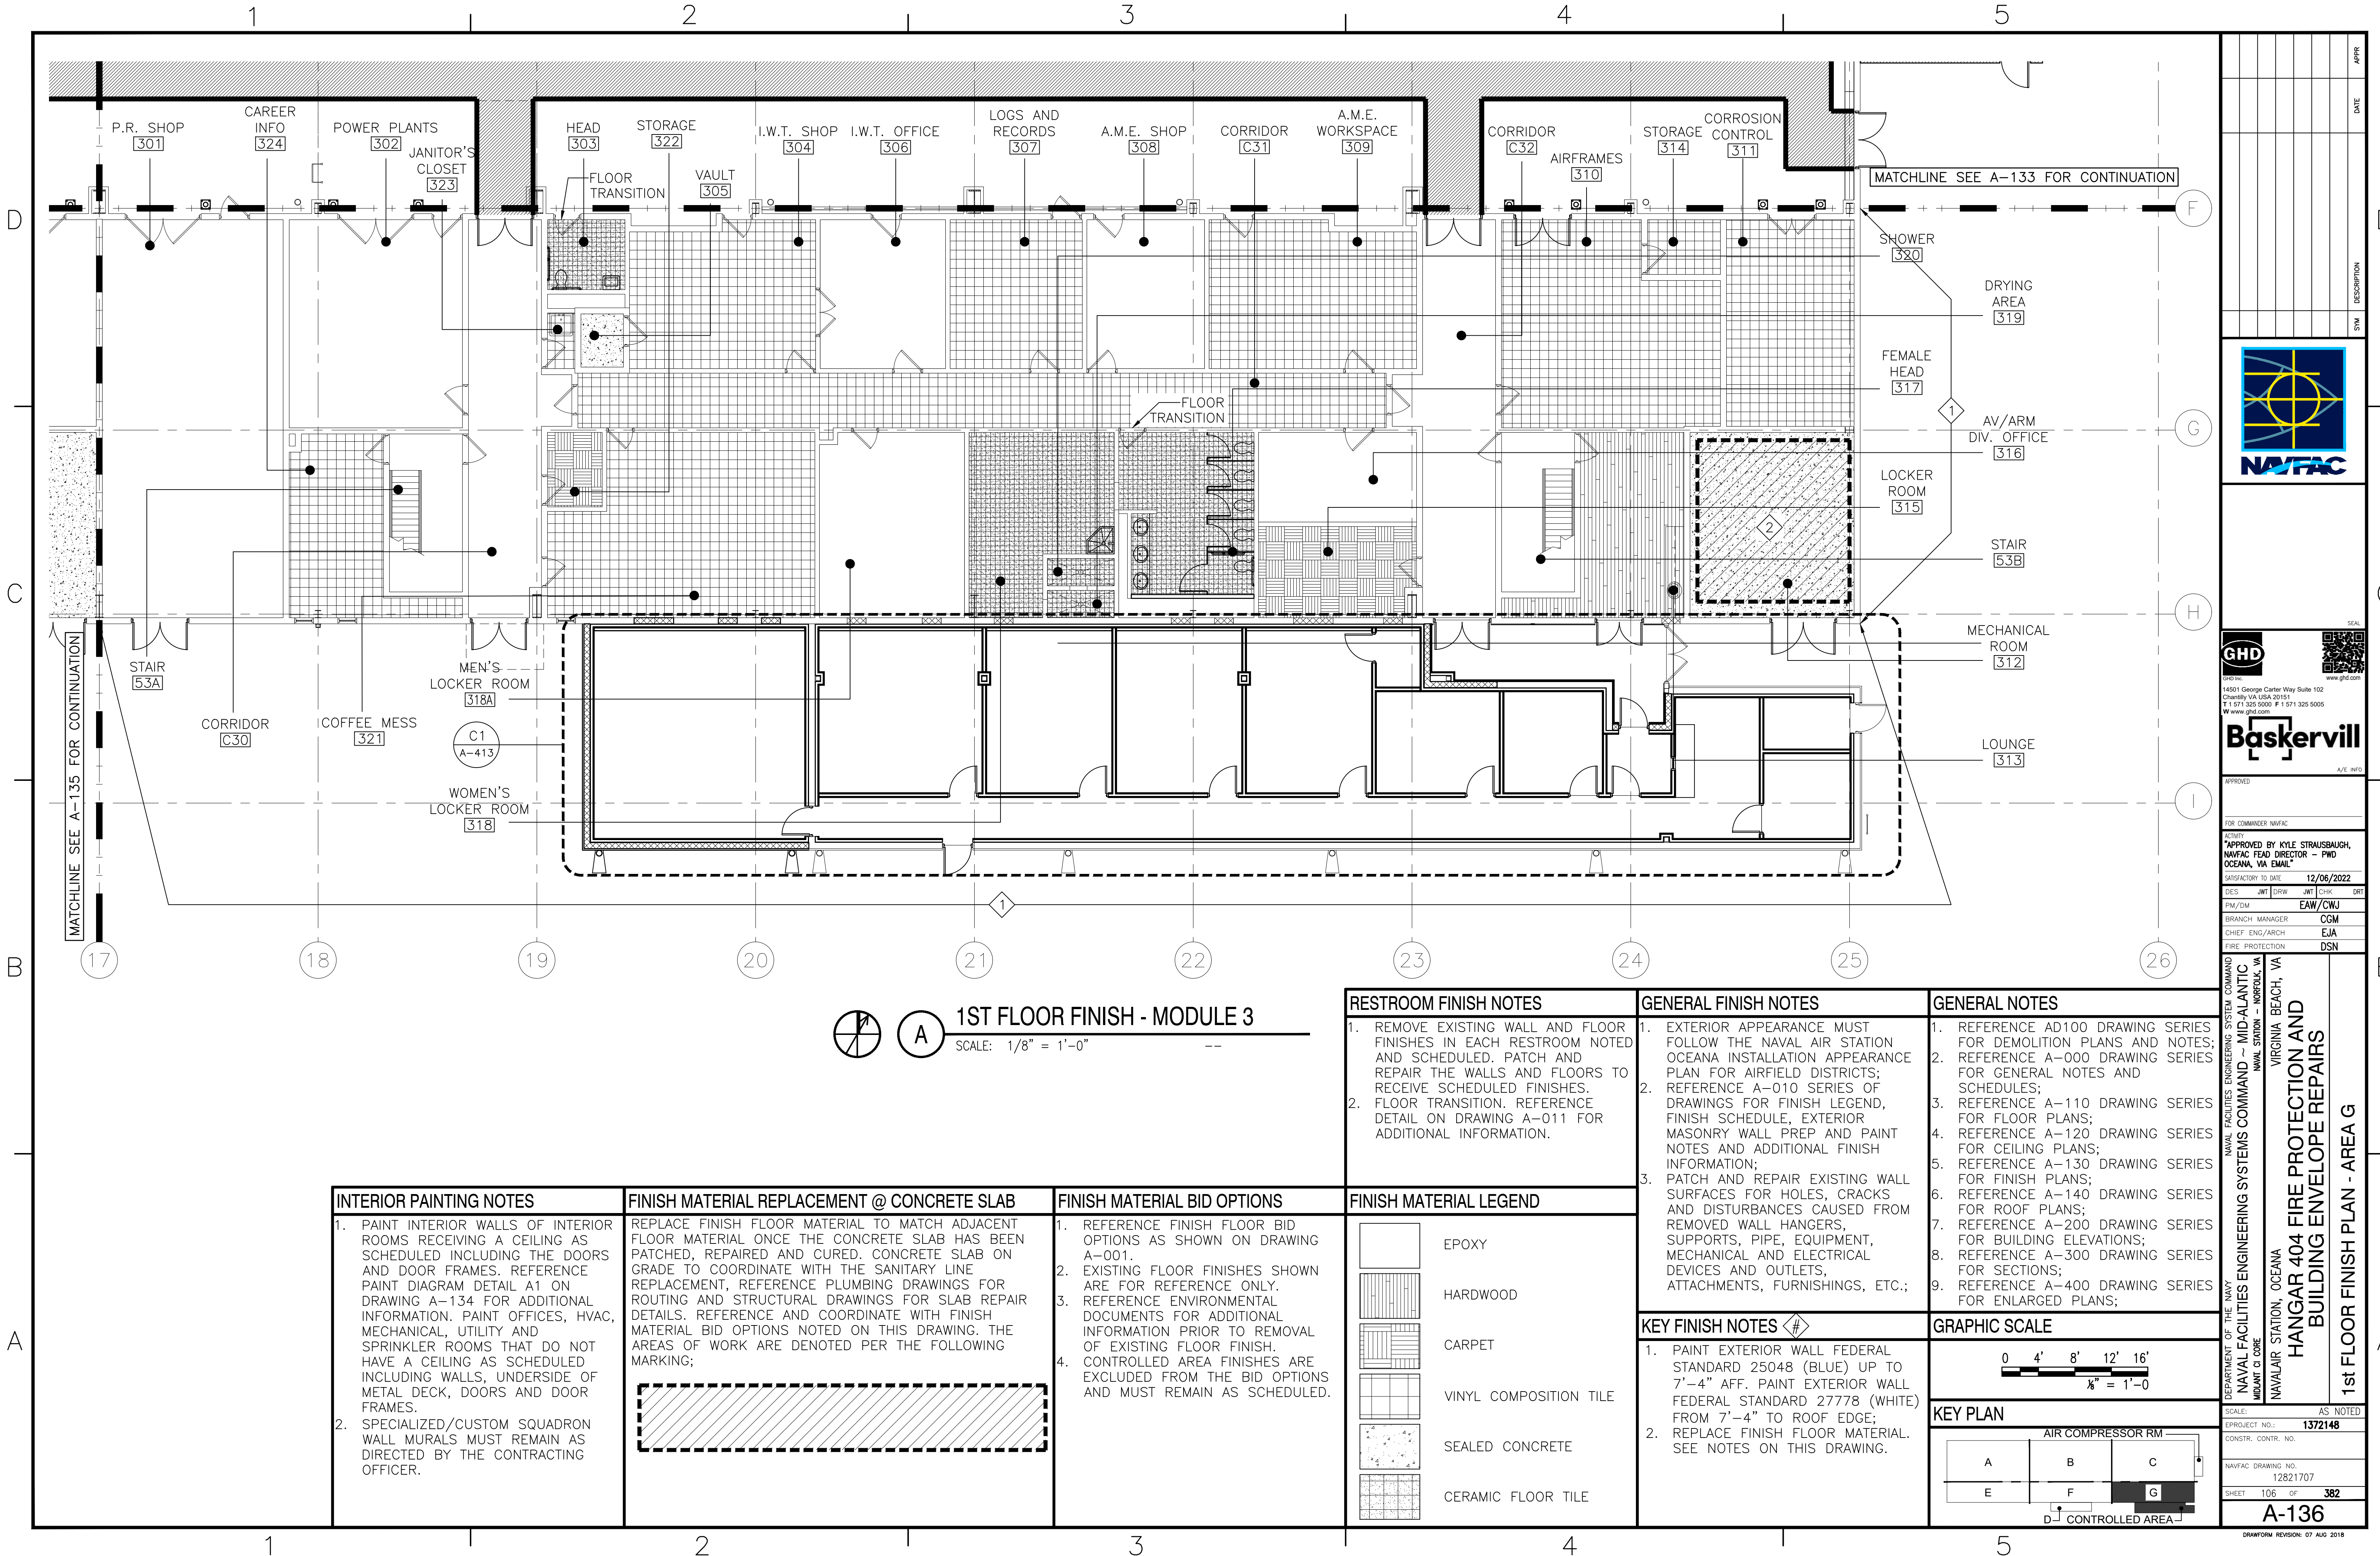


INTERIOR PAINTING NOTES	FINISH MATERIAL REPLACEMENT @ CONCRETE SLAB	FINISH MATERIAL BID OPTIONS
1. PAINT INTERIOR WALLS OF INTERIOR ROOMS RECEIVING A CEILING AS SCHEDULED INCLUDING THE DOORS AND DOOR FRAMES. REFERENCE PAINT DIAGRAM DETAIL A1 ON DRAWING A-134 FOR ADDITIONAL INFORMATION. PAINT OFFICES, HVAC, MECHANICAL, UTILITY AND SPRINKLER ROOMS THAT DO NOT HAVE A CEILING AS SCHEDULED INCLUDING WALLS, UNDERSIDE OF METAL DECK, DOORS AND DOOR FRAMES. 2. SPECIALIZED/CUSTOM SQUADRON WALL MURALS MUST REMAIN AS DIRECTED BY THE CONTRACTING OFFICER.	REPLACE FINISH FLOOR MATERIAL TO MATCH ADJACENT FLOOR MATERIAL ONCE THE CONCRETE SLAB HAS BEEN PATCHED, REPAIRED AND CURED. CONCRETE SLAB ON GRADE TO COORDINATE WITH THE SANITARY LINE REPLACEMENT, REFERENCE PLUMBING DRAWINGS FOR ROUTING AND STRUCTURAL DRAWINGS FOR SLAB REPAIR DETAILS. REFERENCE AND COORDINATE WITH FINISH MATERIAL BID OPTIONS NOTED ON THIS DRAWING. THE AREAS OF WORK ARE DENOTED PER THE FOLLOWING MARKING; 	1. REFERENCE FINISH FLOOR BID OPTIONS AS SHOWN ON DRAWING A-001. 2. EXISTING FLOOR FINISHES SHOWN ARE FOR REFERENCE ONLY. 3. REFERENCE ENVIRONMENTAL DOCUMENTS FOR ADDITIONAL INFORMATION PRIOR TO REMOVAL OF EXISTING FLOOR FINISH. FOAM ROOM / FIRE ALARM CLOSET FLOOR FINISH NOTES 1. THE FOAM ROOM AND FIRE ALARM CLOSET FLOOR CONCRETE SLAB MUST RECEIVE EPOXY FLOOR FINISH (650 SQUARE FEET). FLOOR SLAB DISTURBED PER RAMP AND CURB INSTALLATION AND OTHER MISCELLANEOUS FLOOR DISTURBANCES MUST RECEIVE EPOXY FLOOR COATING. REFERENCE STRUCTURAL AND AND FIRE PROTECTION DRAWINGS FOR ADDITIONAL INFORMATION.

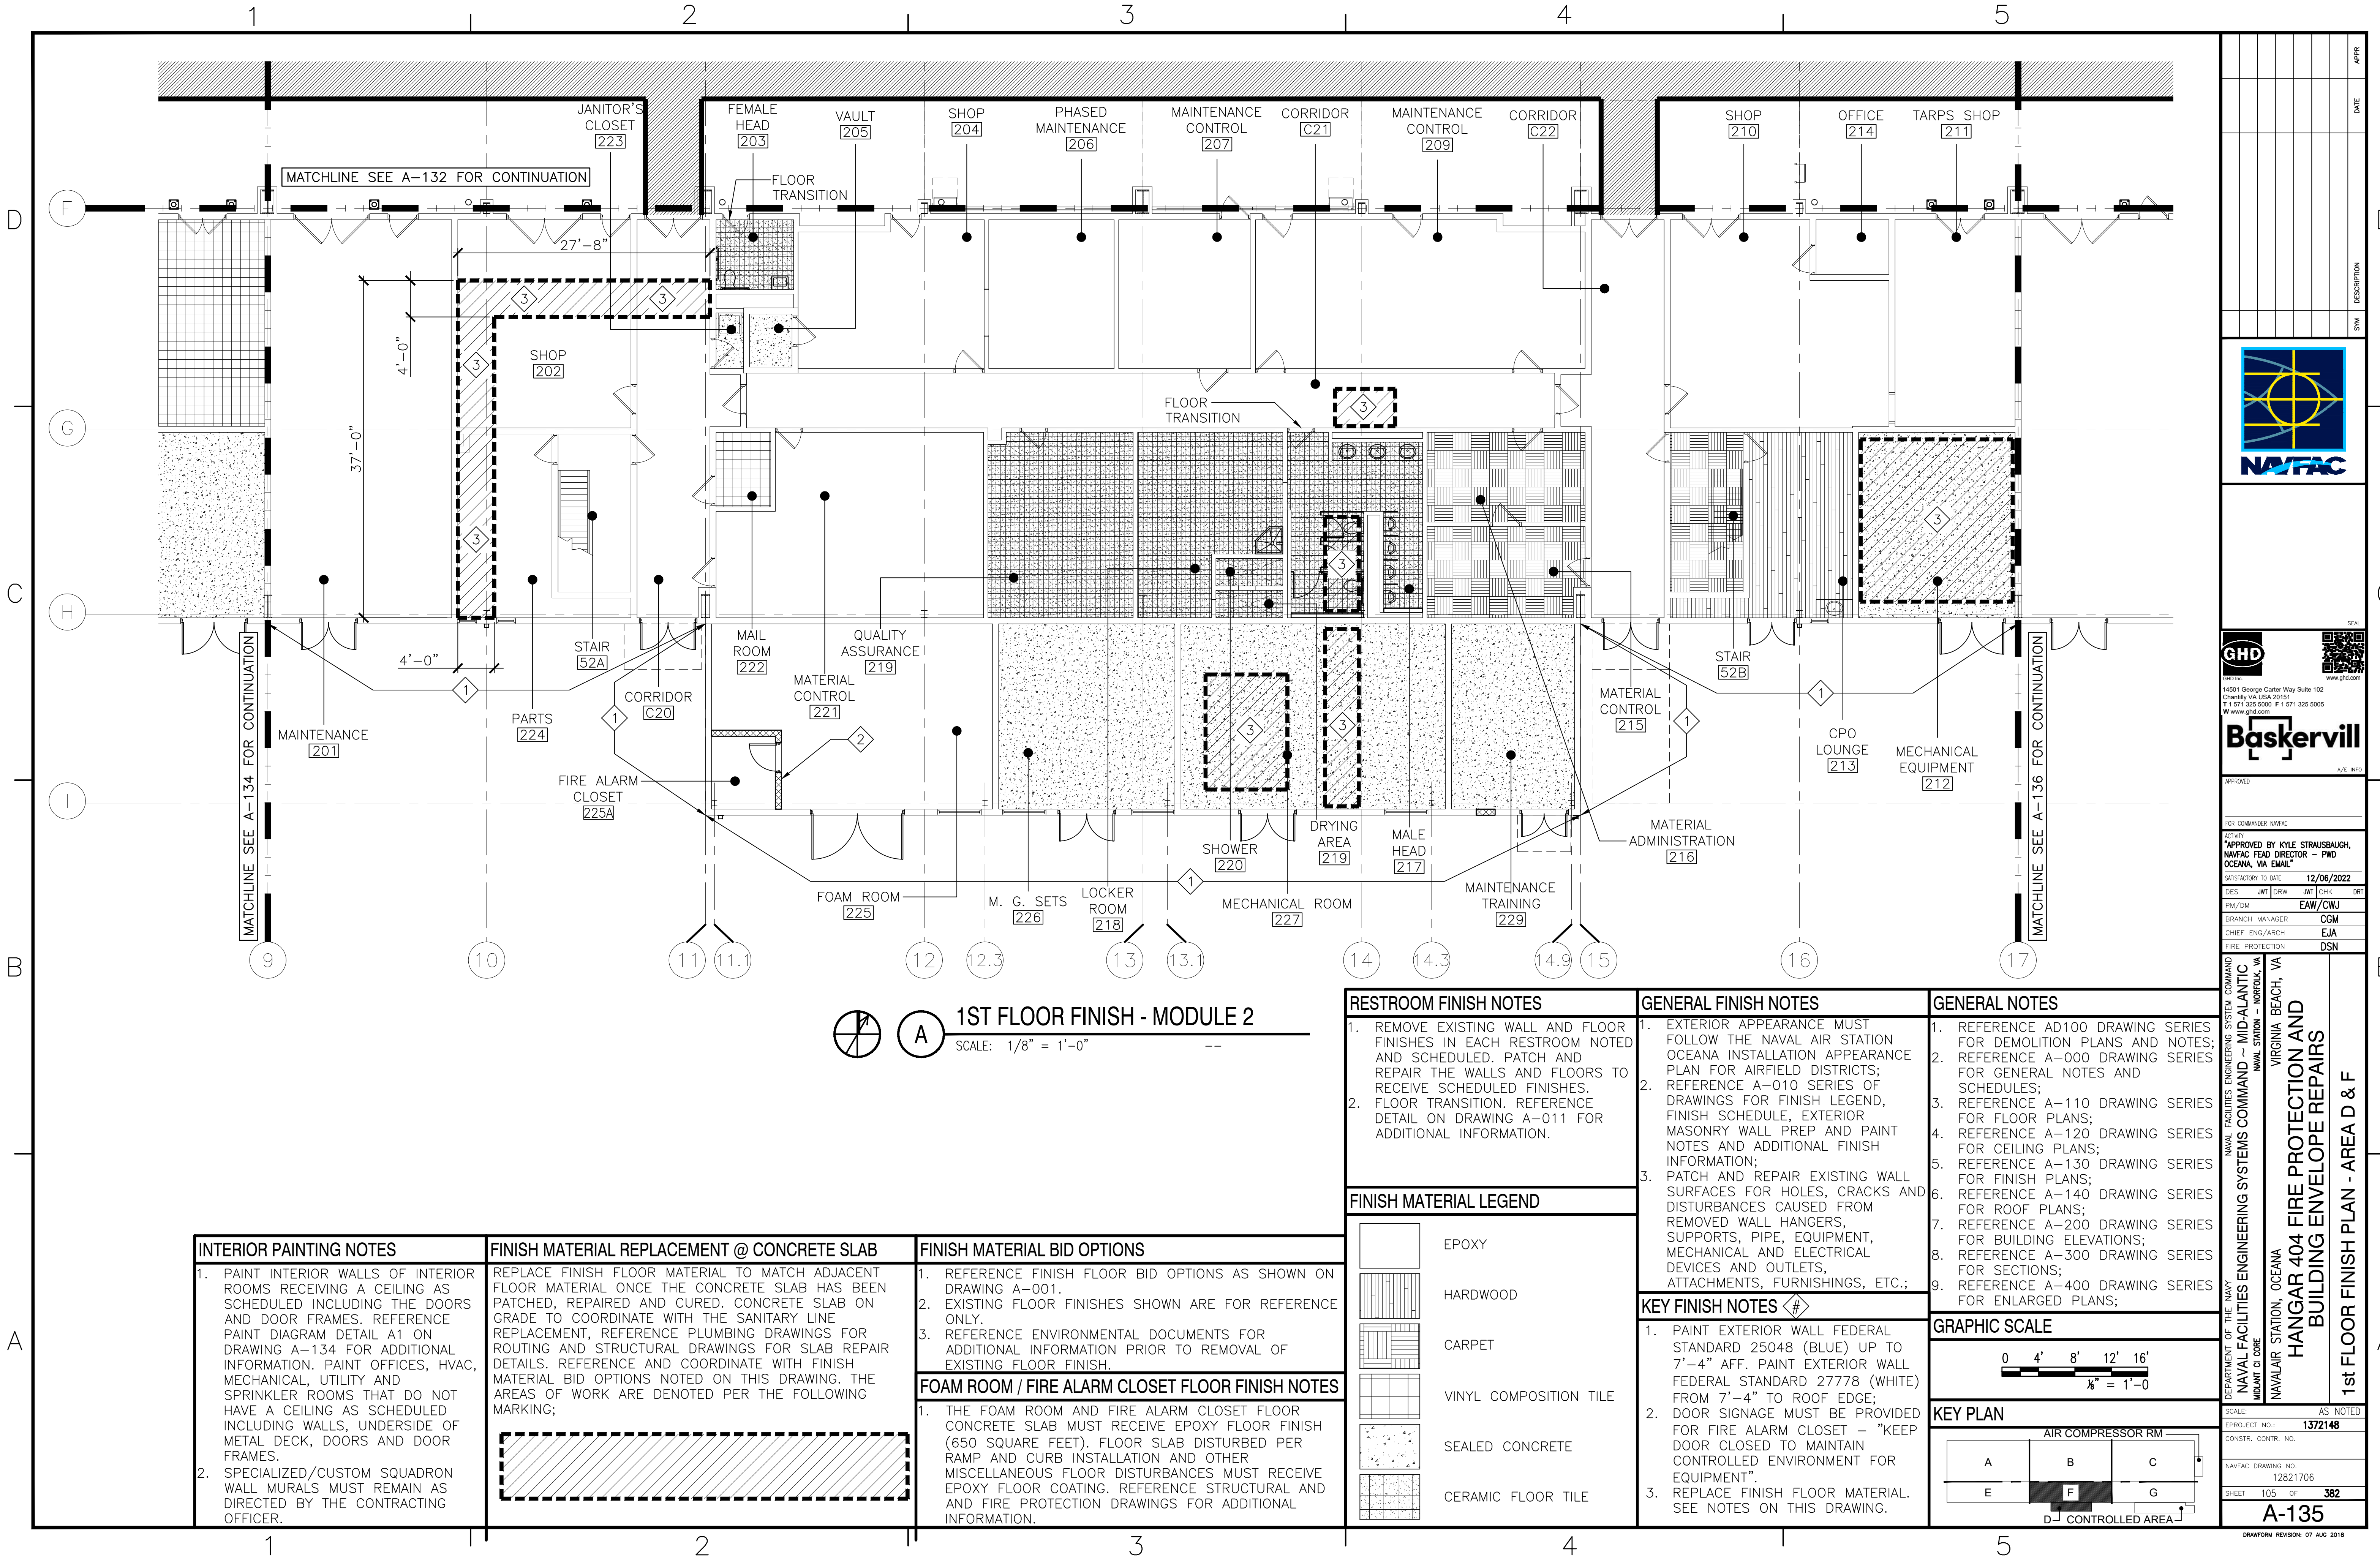RESTROOM FINISH NOTES	GENERAL FINISH NOTES	GENERAL NOTES
1. REMOVE EXISTING WALL AND FLOOR FINISHES IN EACH RESTROOM NOTED AND SCHEDULED. PATCH AND REPAIR THE WALLS AND FLOORS TO RECEIVE SCHEDULED FINISHES. 2. FLOOR TRANSITION. REFERENCE DETAIL ON DRAWING A-011 FOR ADDITIONAL INFORMATION.	1. EXTERIOR APPEARANCE MUST FOLLOW THE NAVAL AIR STATION OCEANA INSTALLATION APPEARANCE PLAN FOR AIRFIELD DISTRICTS; 2. REFERENCE A-010 SERIES OF DRAWINGS FOR FINISH LEGEND, FINISH SCHEDULE, EXTERIOR MASONRY WALL PREP AND PAINT NOTES AND ADDITIONAL FINISH INFORMATION; 3. PATCH AND REPAIR EXISTING WALL SURFACES FOR HOLES, CRACKS AND DISTURBANCES CAUSED FROM REMOVED WALL HANGERS, SUPPORTS, PIPE, EQUIPMENT, MECHANICAL AND ELECTRICAL DEVICES AND OUTLETS, ATTACHMENTS, FURNISHINGS, ETC.;	1. REFERENCE AD100 DRAWING SERIES FOR DEMOLITION PLANS AND NOTES; 2. REFERENCE A-000 DRAWING SERIES FOR GENERAL NOTES AND SCHEDULES; 3. REFERENCE A-110 DRAWING SERIES FOR FLOOR PLANS; 4. REFERENCE A-120 DRAWING SERIES FOR CEILING PLANS; 5. REFERENCE A-130 DRAWING SERIES FOR FINISH PLANS; 6. REFERENCE A-140 DRAWING SERIES FOR ROOF PLANS; 7. REFERENCE A-200 DRAWING SERIES FOR BUILDING ELEVATIONS; 8. REFERENCE A-300 DRAWING SERIES FOR SECTIONS; 9. REFERENCE A-400 DRAWING SERIES FOR ENLARGED PLANS;
FINISH MATERIAL LEGEND	KEY FINISH NOTES	GRAPHIC SCALE
 EPOXY  HARDWOOD  CARPET  VINYL COMPOSITION TILE  SEALED CONCRETE  CERAMIC FLOOR TILE	1. PAINT EXTERIOR WALL FEDERAL STANDARD 25048 (BLUE) UP TO 7'-4" AFF. PAINT EXTERIOR WALL FEDERAL STANDARD 27778 (WHITE) FROM 7'-4" TO ROOF EDGE; 2. DOOR SIGNAGE MUST BE PROVIDED FOR FIRE ALARM CLOSET - "KEEP DOOR CLOSED TO MAINTAIN CONTROLLED ENVIRONMENT FOR EQUIPMENT". 3. REPLACE FINISH FLOOR MATERIAL. SEE NOTES ON THIS DRAWING.	0 4' 8' 12' 16' 1/8" = 1'-0"
		KEY PLAN
		 AIR COMPRESSOR RM D= CONTROLLED AREA

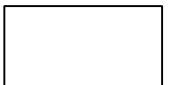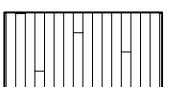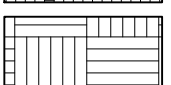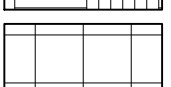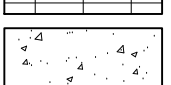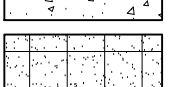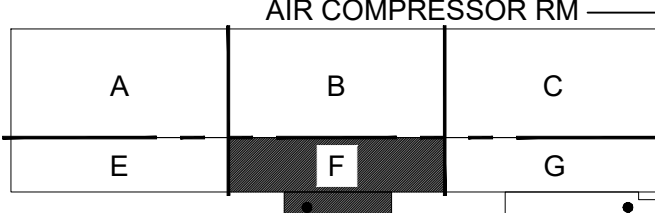APPROVED		DATE		APPR	
FOR COMMANDER NAVFAC					
APPROVED BY KYLE STRAUSBAUGH, NAVFAC HEAD DIRECTOR - PWD OCEANA, VA EMAIL					
SATISFACTORY TO DATE		12/06/2022			
DES	JMT	DRW	JMT	CHK	DRT
PM/DM			EAJ/CWJ		
BRANCH MANAGER			CGM		
CHIEF ENG/ARCH			EJA		
FIRE PROTECTION			DSN		
NAVAL FACILITIES ENGINEERING SYSTEMS COMMAND - MID-ATLANTIC NAVAL STATION - NORFOLK, VA					
NAVAL AIR STATION, OCEANA VIRGINIA BEACH, VA					
HANGAR 404 FIRE PROTECTION AND BUILDING ENVELOPE REPAIRS					
1st FLOOR FINISH PLAN - AREA D & F					
SCALE: AS NOTED					
PROJECT NO.: 1372148					
CONSTR. CONTR. NO.					
NAVFAC DRAWING NO. 12821706					
SHEET 105 OF 382					
A-135					
DRAWING REVISION: 07 AUG 2018					

FILE NAME: \\gndna\gnd\US\Chantilly\Projects\585\11203487\Digital_Design\1 - CAD\3.1.2 - Sheet\05b - Architectural\2022 11 18 Final\1372148-A-136.dwg LAYOUT NAME: Layout1 PLOTTED: Monday, December 05, 2022 - 1:42pm USER: nsosh



A

1ST FLOOR FINISH - MODULE 3


SCALE: 1/8" = 1'-0"

INTERIOR PAINTING NOTES

1. PAINT INTERIOR WALLS OF INTERIOR ROOMS RECEIVING A CEILING AS SCHEDULED INCLUDING THE DOORS AND DOOR FRAMES. REFERENCE PAINT DIAGRAM DETAIL A1 ON DRAWING A-134 FOR ADDITIONAL INFORMATION. PAINT OFFICES, HVAC, MECHANICAL, UTILITY AND SPRINKLER ROOMS THAT DO NOT HAVE A CEILING AS SCHEDULED INCLUDING WALLS, UNDERSIDE OF METAL DECK, DOORS AND DOOR FRAMES.
2. SPECIALIZED/CUSTOM SQUADRON WALL MURALS MUST REMAIN AS DIRECTED BY THE CONTRACTING OFFICER.

FINISH MATERIAL REPLACEMENT @ CONCRETE SLAB

REPLACE FINISH FLOOR MATERIAL TO MATCH ADJACENT FLOOR MATERIAL ONCE THE CONCRETE SLAB HAS BEEN PATCHED, REPAIRED AND CURED. CONCRETE SLAB ON GRADE TO COORDINATE WITH THE SANITARY LINE REPLACEMENT, REFERENCE PLUMBING DRAWINGS FOR ROUTING AND STRUCTURAL DRAWINGS FOR SLAB REPAIR DETAILS. REFERENCE AND COORDINATE WITH FINISH MATERIAL BID OPTIONS NOTED ON THIS DRAWING. THE AREAS OF WORK ARE DENOTED PER THE FOLLOWING MARKING;

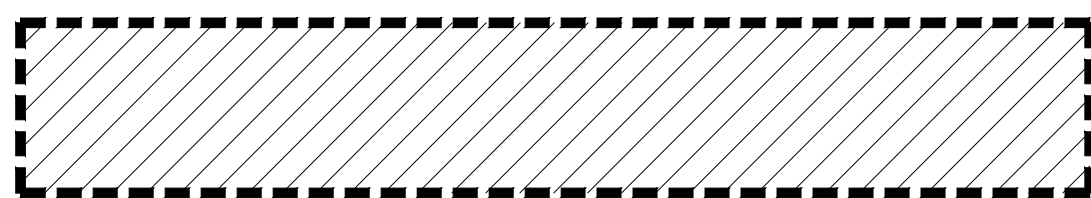

FINISH MATERIAL BID OPTIONS

1. REFERENCE FINISH FLOOR BID OPTIONS AS SHOWN ON DRAWING A-001.
2. EXISTING FLOOR FINISHES SHOWN ARE FOR REFERENCE ONLY.
3. REFERENCE ENVIRONMENTAL DOCUMENTS FOR ADDITIONAL INFORMATION PRIOR TO REMOVAL OF EXISTING FLOOR FINISH.
4. CONTROLLED AREA FINISHES ARE EXCLUDED FROM THE BID OPTIONS AND MUST REMAIN AS SCHEDULED.

RESTROOM FINISH NOTES

1. REMOVE EXISTING WALL AND FLOOR FINISHES IN EACH RESTROOM NOTED AND SCHEDULED. PATCH AND REPAIR THE WALLS AND FLOORS TO RECEIVE SCHEDULED FINISHES.
2. FLOOR TRANSITION. REFERENCE DETAIL ON DRAWING A-011 FOR ADDITIONAL INFORMATION.

GENERAL FINISH NOTES

1. EXTERIOR APPEARANCE MUST FOLLOW THE NAVAL AIR STATION OCEANA INSTALLATION APPEARANCE PLAN FOR AIRFIELD DISTRICTS;
2. REFERENCE A-010 SERIES OF DRAWINGS FOR FINISH LEGEND, FINISH SCHEDULE, EXTERIOR MASONRY WALL PREP AND PAINT NOTES AND ADDITIONAL FINISH INFORMATION;
3. PATCH AND REPAIR EXISTING WALL SURFACES FOR HOLES, CRACKS AND DISTURBANCES CAUSED FROM REMOVED WALL HANGERS, SUPPORTS, PIPE, EQUIPMENT, MECHANICAL AND ELECTRICAL DEVICES AND OUTLETS, ATTACHMENTS, FURNISHINGS, ETC.;

GENERAL NOTES

1. REFERENCE AD100 DRAWING SERIES FOR DEMOLITION PLANS AND NOTES;
2. REFERENCE A-000 DRAWING SERIES FOR GENERAL NOTES AND SCHEDULES;
3. REFERENCE A-110 DRAWING SERIES FOR FLOOR PLANS;
4. REFERENCE A-120 DRAWING SERIES FOR CEILING PLANS;
5. REFERENCE A-130 DRAWING SERIES FOR FINISH PLANS;
6. REFERENCE A-140 DRAWING SERIES FOR ROOF PLANS;
7. REFERENCE A-200 DRAWING SERIES FOR BUILDING ELEVATIONS;
8. REFERENCE A-300 DRAWING SERIES FOR SECTIONS;
9. REFERENCE A-400 DRAWING SERIES FOR ENLARGED PLANS;


FINISH MATERIAL LEGEND

	EPOXY
	HARDWOOD
	CARPET
	VINYL COMPOSITION TILE
	SEALED CONCRETE
	CERAMIC FLOOR TILE


KEY FINISH NOTES

1. PAINT EXTERIOR WALL FEDERAL STANDARD 25048 (BLUE) UP TO 7'-4" AFF. PAINT EXTERIOR WALL FEDERAL STANDARD 27778 (WHITE) FROM 7'-4" TO ROOF EDGE;
2. REPLACE FINISH FLOOR MATERIAL. SEE NOTES ON THIS DRAWING.

GRAPHIC SCALE

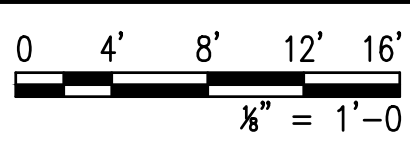

KEY PLAN

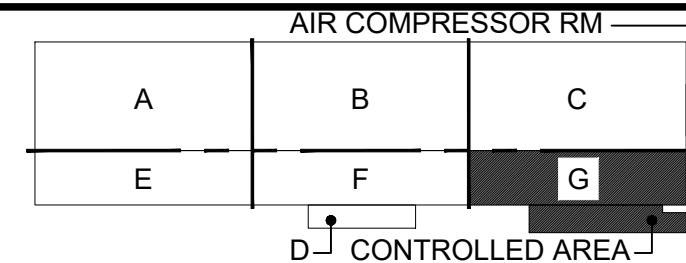

APPR.	DATE
SYN	DESCRIPTION

NAVFAC

GHD

Baskervill


APPROVED	FOR COMMANDER NAVFAC				
APPROVED BY KYLE STRAUSBAUGH, NAVFAC HEAD DIRECTOR - PWD OCEANA, VA EMAIL					
SATISFACTORY TO DATE	12/06/2022				
DES	JMT	DRW	JMT	CHK	DRT
PM/DM	EAW/CWJ				
BRANCH MANAGER	CGM				
CHIEF ENG/ARCH	EJA				
FIRE PROTECTION	DSN				

DEPARTMENT OF THE NAVY
NAVAL FACILITIES ENGINEERING SYSTEMS COMMAND
NAVAL STATION - NORFOLK, VA
VIRGINIA BEACH, VA
NAVAL AIR STATION, OCEANA
HANGAR 404 FIRE PROTECTION AND
BUILDING ENVELOPE REPAIRS
1st FLOOR FINISH PLAN - AREA G

SCALE:	AS NOTED
PROJECT NO.:	1372148
CONSTR. CONTR. NO.	
NAVFAC DRAWING NO.	12821707
SHEET	106 OF 382
A-136	

DRAWING REVISION: 07 AUG 2018

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A 2ND FLOOR FINISH - MODULE 1
SCALE: 1/8" = 1'-0"

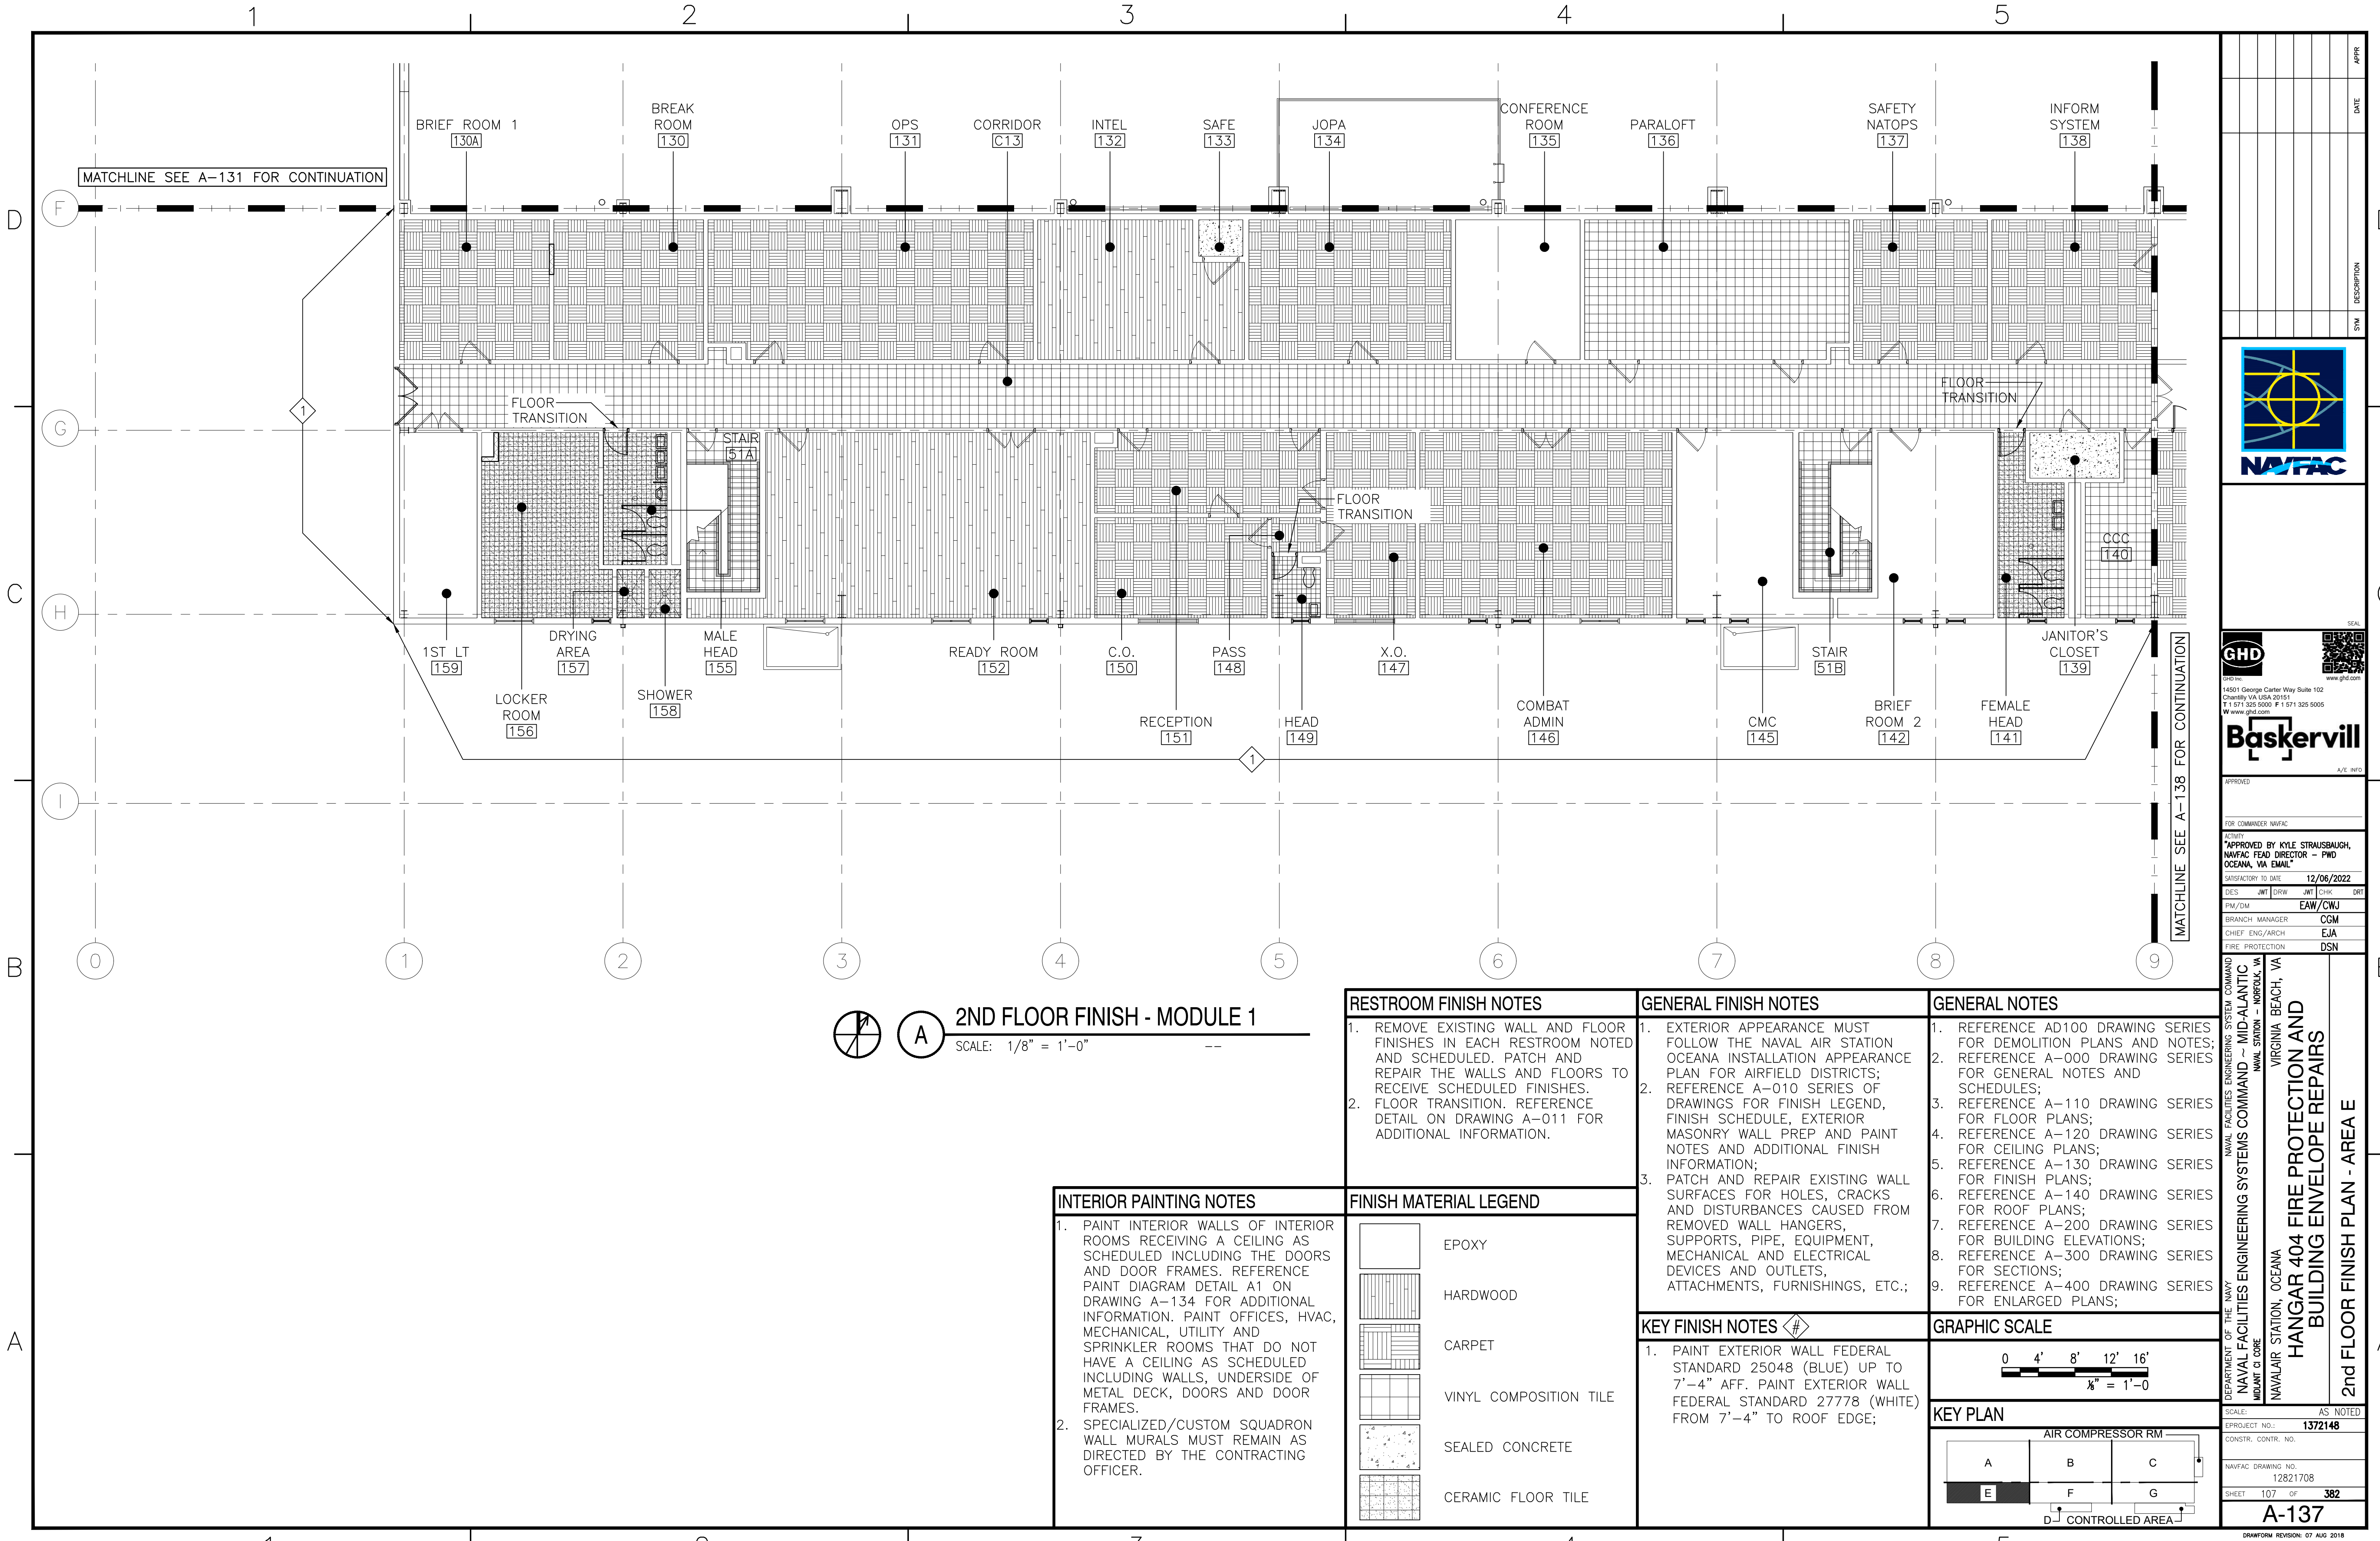- INTERIOR PAINTING NOTES**
- PAINT INTERIOR WALLS OF INTERIOR ROOMS RECEIVING A CEILING AS SCHEDULED INCLUDING THE DOORS AND DOOR FRAMES. REFERENCE PAINT DIAGRAM DETAIL A1 ON DRAWING A-134 FOR ADDITIONAL INFORMATION. PAINT OFFICES, HVAC, MECHANICAL, UTILITY AND SPRINKLER ROOMS THAT DO NOT HAVE A CEILING AS SCHEDULED INCLUDING WALLS, UNDERSIDE OF METAL DECK, DOORS AND DOOR FRAMES.
 - SPECIALIZED/CUSTOM SQUADRON WALL MURALS MUST REMAIN AS DIRECTED BY THE CONTRACTING OFFICER.


FINISH MATERIAL LEGEND	
	EPOXY
	HARDWOOD
	CARPET
	VINYL COMPOSITION TILE
	SEALED CONCRETE
	CERAMIC FLOOR TILE

- RESTROOM FINISH NOTES**
- REMOVE EXISTING WALL AND FLOOR FINISHES IN EACH RESTROOM NOTED AND SCHEDULED. PATCH AND REPAIR THE WALLS AND FLOORS TO RECEIVE SCHEDULED FINISHES.
 - FLOOR TRANSITION. REFERENCE DETAIL ON DRAWING A-011 FOR ADDITIONAL INFORMATION.

- GENERAL FINISH NOTES**
- EXTERIOR APPEARANCE MUST FOLLOW THE NAVAL AIR STATION OCEANA INSTALLATION APPEARANCE PLAN FOR AIRFIELD DISTRICTS;
 - REFERENCE A-010 SERIES OF DRAWINGS FOR FINISH LEGEND, FINISH SCHEDULE, EXTERIOR MASONRY WALL PREP AND PAINT NOTES AND ADDITIONAL FINISH INFORMATION;
 - PATCH AND REPAIR EXISTING WALL SURFACES FOR HOLES, CRACKS AND DISTURBANCES CAUSED FROM REMOVED WALL HANGERS, SUPPORTS, PIPE, EQUIPMENT, MECHANICAL AND ELECTRICAL DEVICES AND OUTLETS, ATTACHMENTS, FURNISHINGS, ETC.;


- KEY FINISH NOTES**
- PAINT EXTERIOR WALL FEDERAL STANDARD 25048 (BLUE) UP TO 7'-4" AFF. PAINT EXTERIOR WALL FEDERAL STANDARD 27778 (WHITE) FROM 7'-4" TO ROOF EDGE;

- GENERAL NOTES**
- REFERENCE AD100 DRAWING SERIES FOR DEMOLITION PLANS AND NOTES;
 - REFERENCE A-000 DRAWING SERIES FOR GENERAL NOTES AND SCHEDULES;
 - REFERENCE A-110 DRAWING SERIES FOR FLOOR PLANS;
 - REFERENCE A-120 DRAWING SERIES FOR CEILING PLANS;
 - REFERENCE A-130 DRAWING SERIES FOR FINISH PLANS;
 - REFERENCE A-140 DRAWING SERIES FOR ROOF PLANS;
 - REFERENCE A-200 DRAWING SERIES FOR BUILDING ELEVATIONS;
 - REFERENCE A-300 DRAWING SERIES FOR SECTIONS;
 - REFERENCE A-400 DRAWING SERIES FOR ENLARGED PLANS;

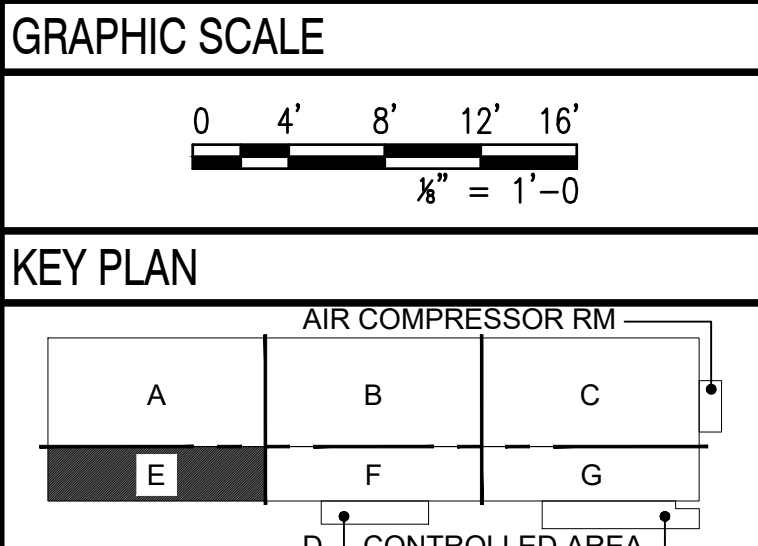

APPROVED		DATE	APPR
FOR COMMANDER WAFAC			
APPROVED BY KYLE STRAUSBAUGH, NAVFAC HEAD DIRECTOR - PWD OCEANA, VA EMAIL			
SATISFACTORY TO DATE		12/06/2022	
DES	JMT	DRW	JMT
PM/DM			EAW/CWJ
BRANCH	MANAGER		CGM
CHIEF	ENG/ARCH		EJA
FIRE PROTECTION			DSN
NAVAL FACILITIES ENGINEERING SYSTEMS COMMAND		VIRGINIA BEACH, VA	
NAVAL FACILITIES ENGINEERING SYSTEMS COMMAND - MID-ATLANTIC		NAVAL STATION - NORFOLK, VA	
NAVAL AIR STATION, OCEANA		HANGAR 404 FIRE PROTECTION AND BUILDING ENVELOPE REPAIRS	
2nd FLOOR FINISH PLAN - AREA E			
SCALE: AS NOTED		PROJECT NO.: 1372148	
CONSTR. CONTR. NO.			
NAVFAC DRAWING NO. 12821708		SHEET 107 OF 382	
A-137		DRAWING REVISION: 07 AUG 2018	

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A 2ND FLOOR FINISH - MODULE 2
SCALE: 1/8" = 1'-0"

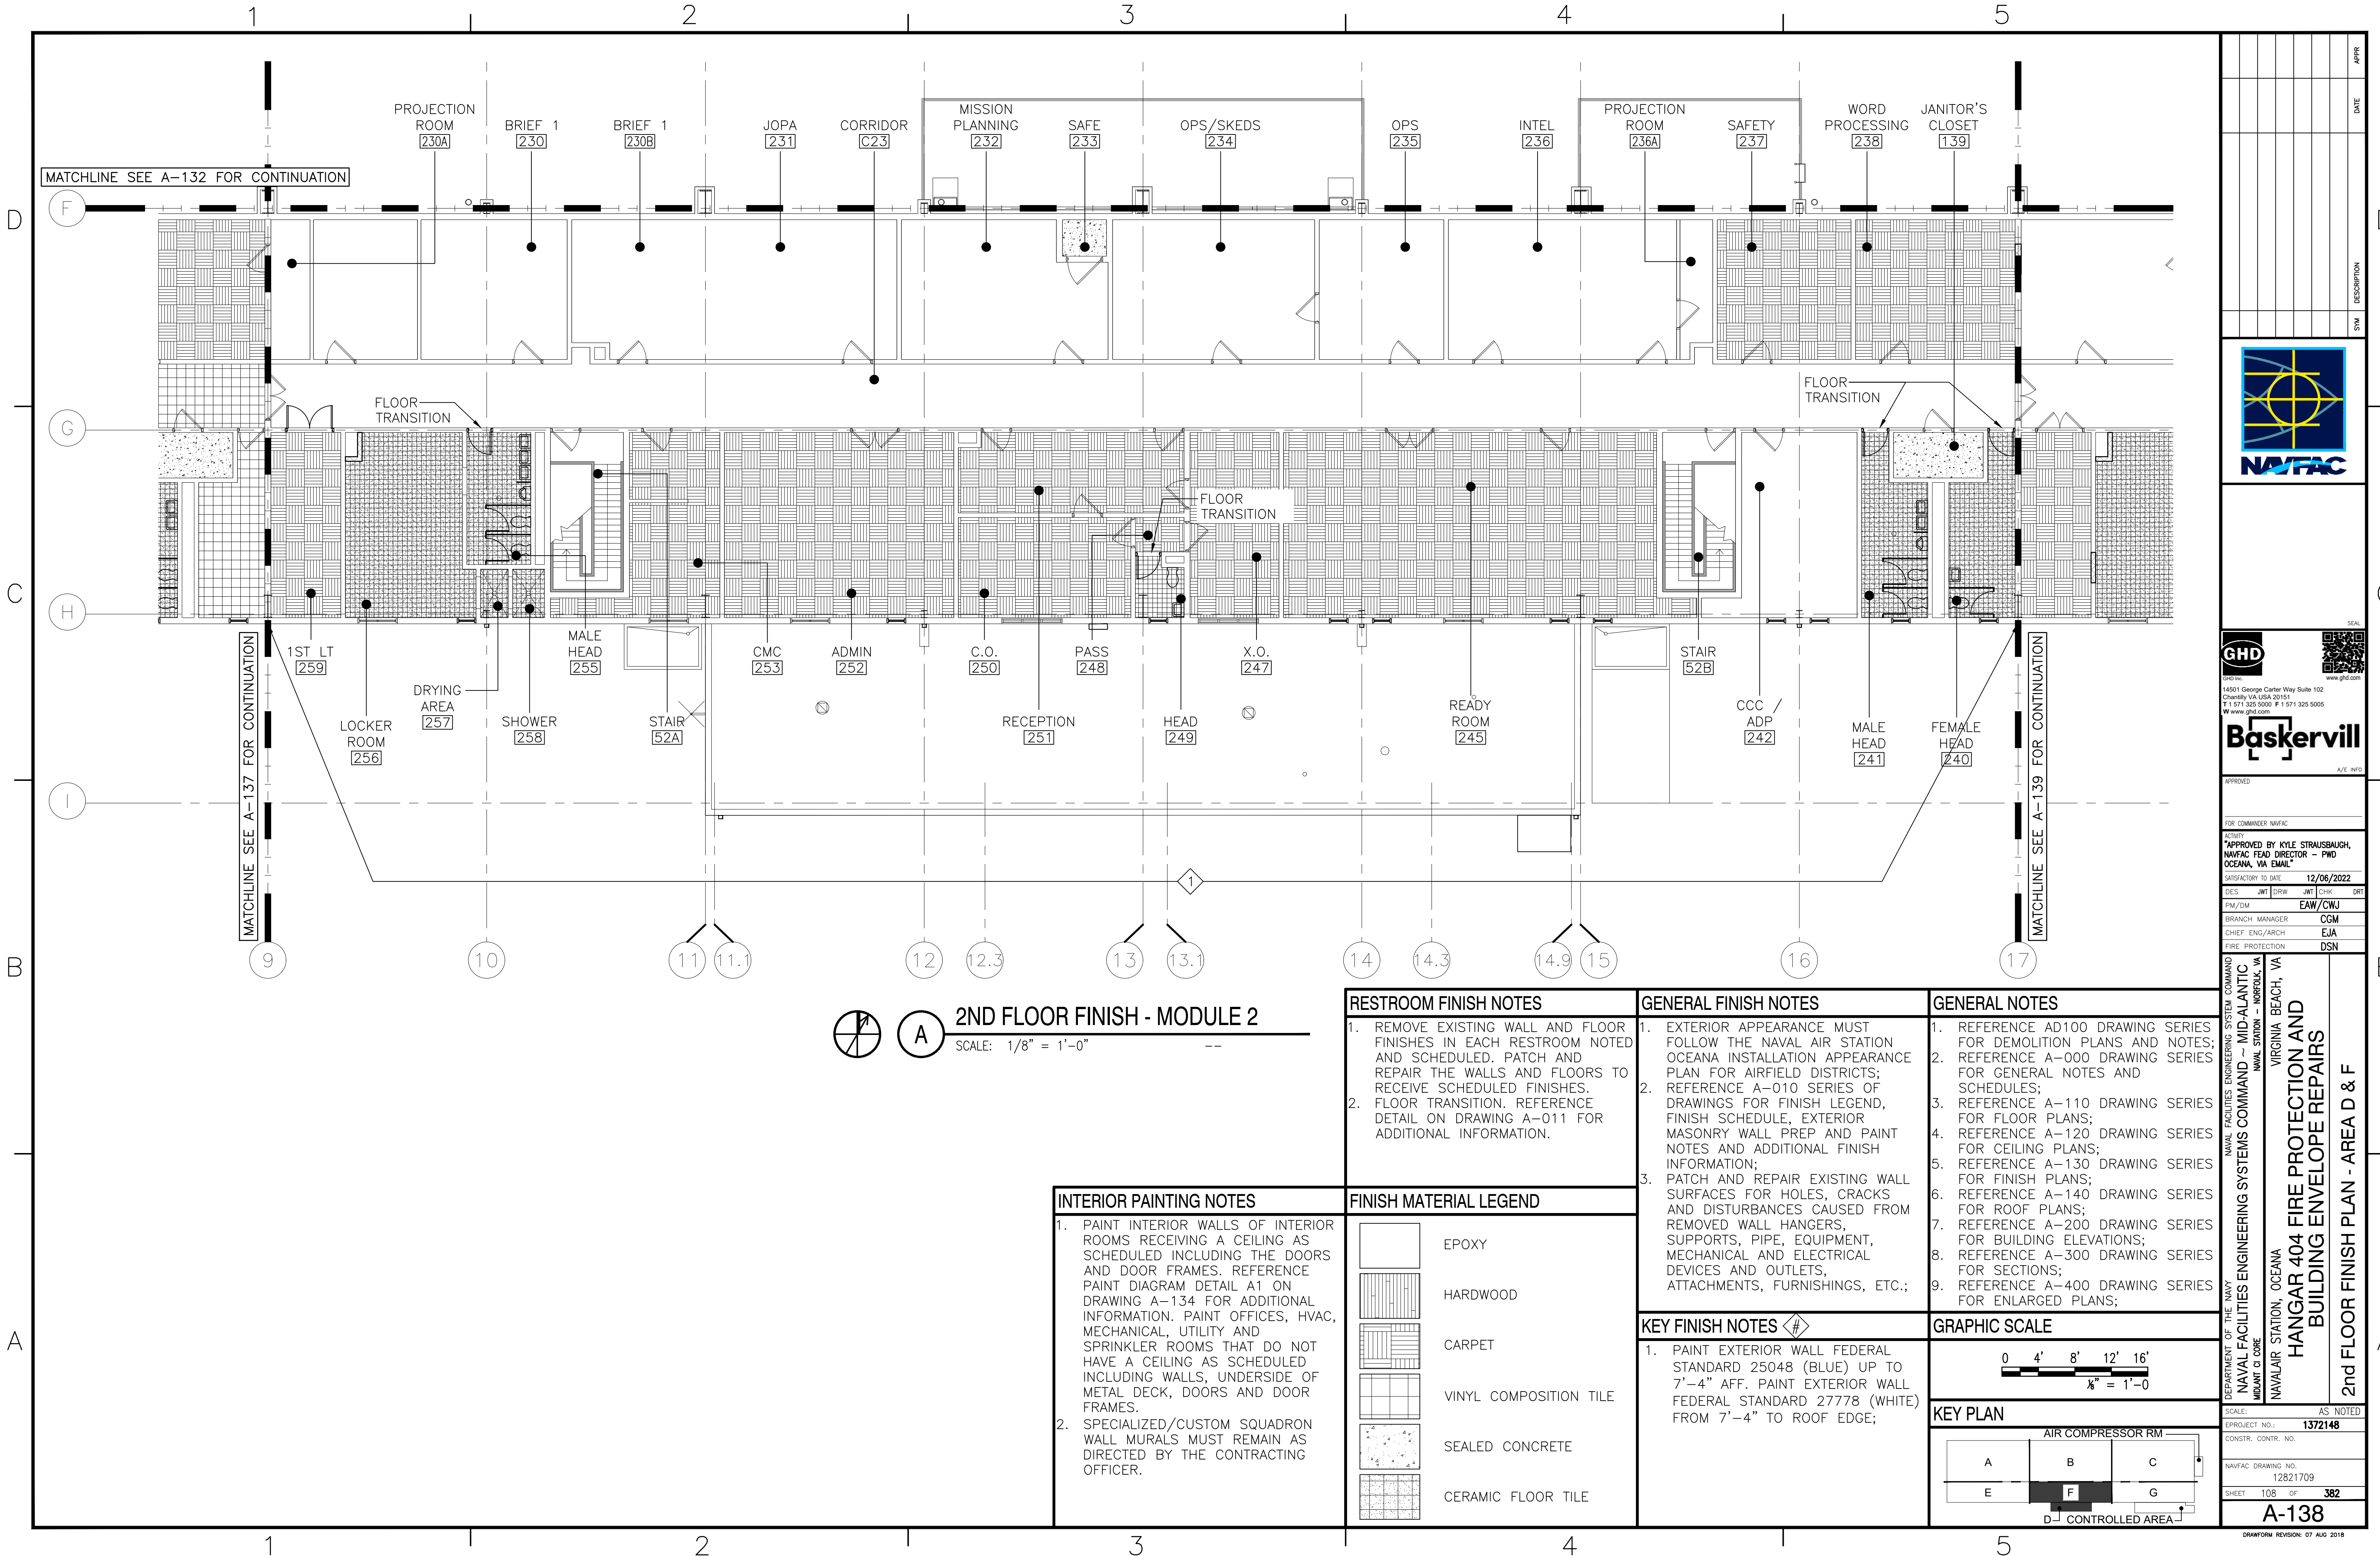- INTERIOR PAINTING NOTES**
- PAINT INTERIOR WALLS OF INTERIOR ROOMS RECEIVING A CEILING AS SCHEDULED INCLUDING THE DOORS AND DOOR FRAMES. REFERENCE PAINT DIAGRAM DETAIL A1 ON DRAWING A-134 FOR ADDITIONAL INFORMATION. PAINT OFFICES, HVAC, MECHANICAL, UTILITY AND SPRINKLER ROOMS THAT DO NOT HAVE A CEILING AS SCHEDULED INCLUDING WALLS, UNDERSIDE OF METAL DECK, DOORS AND DOOR FRAMES.
 - SPECIALIZED/CUSTOM SQUADRON WALL MURALS MUST REMAIN AS DIRECTED BY THE CONTRACTING OFFICER.


FINISH MATERIAL LEGEND	
	EPOXY
	HARDWOOD
	CARPET
	VINYL COMPOSITION TILE
	SEALED CONCRETE
	CERAMIC FLOOR TILE

- RESTROOM FINISH NOTES**
- REMOVE EXISTING WALL AND FLOOR FINISHES IN EACH RESTROOM NOTED AND SCHEDULED. PATCH AND REPAIR THE WALLS AND FLOORS TO RECEIVE SCHEDULED FINISHES.
 - FLOOR TRANSITION. REFERENCE DETAIL ON DRAWING A-011 FOR ADDITIONAL INFORMATION.

- GENERAL FINISH NOTES**
- EXTERIOR APPEARANCE MUST FOLLOW THE NAVAL AIR STATION OCEANA INSTALLATION APPEARANCE PLAN FOR AIRFIELD DISTRICTS;
 - REFERENCE A-010 SERIES OF DRAWINGS FOR FINISH LEGEND, FINISH SCHEDULE, EXTERIOR MASONRY WALL PREP AND PAINT NOTES AND ADDITIONAL FINISH INFORMATION;
 - PATCH AND REPAIR EXISTING WALL SURFACES FOR HOLES, CRACKS AND DISTURBANCES CAUSED FROM REMOVED WALL HANGERS, SUPPORTS, PIPE, EQUIPMENT, MECHANICAL AND ELECTRICAL DEVICES AND OUTLETS, ATTACHMENTS, FURNISHINGS, ETC.;


- KEY FINISH NOTES**
- PAINT EXTERIOR WALL FEDERAL STANDARD 25048 (BLUE) UP TO 7'-4" AFF. PAINT EXTERIOR WALL FEDERAL STANDARD 27778 (WHITE) FROM 7'-4" TO ROOF EDGE;

- GENERAL NOTES**
- REFERENCE AD100 DRAWING SERIES FOR DEMOLITION PLANS AND NOTES;
 - REFERENCE A-000 DRAWING SERIES FOR GENERAL NOTES AND SCHEDULES;
 - REFERENCE A-110 DRAWING SERIES FOR FLOOR PLANS;
 - REFERENCE A-120 DRAWING SERIES FOR CEILING PLANS;
 - REFERENCE A-130 DRAWING SERIES FOR FINISH PLANS;
 - REFERENCE A-140 DRAWING SERIES FOR ROOF PLANS;
 - REFERENCE A-200 DRAWING SERIES FOR BUILDING ELEVATIONS;
 - REFERENCE A-300 DRAWING SERIES FOR SECTIONS;
 - REFERENCE A-400 DRAWING SERIES FOR ENLARGED PLANS;

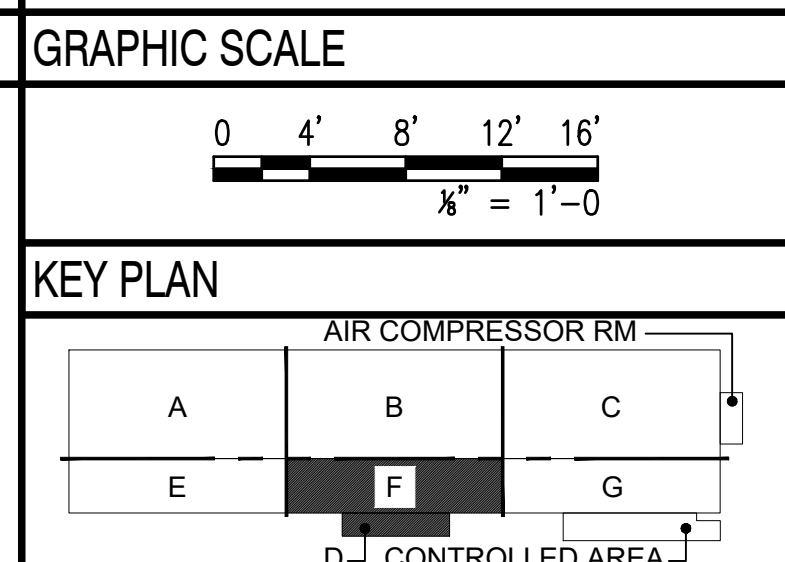

APPROVED		DATE	APPR
FOR COMMANDER NAVFAC			
APPROVED BY KYLE STRAUSBAUGH, NAVFAC HEAD DIRECTOR - PWD OCEANA, VA EMAIL			
SATISFACTORY TO DATE: 12/06/2022			
DES	JMT	DRW	JMT
PM/DM			EAU/CWJ
BRANCH			CGM
CHIEF	ENG/ARCH		EJA
FIRE	PROTECTION		DSN
NAVAL FACILITIES ENGINEERING SYSTEMS COMMAND		VIRGINIA BEACH, VA	
NAVAL STATION - NORFOLK, VA		OCEANA	
NAVAL AIR STATION, OCEANA		HANGAR 404 FIRE PROTECTION AND BUILDING ENVELOPE REPAIRS	
2nd FLOOR FINISH PLAN - AREA D & F		A-138	
SCALE: AS NOTED		PROJECT NO.: 1372148	
CONSTR. CONTR. NO.		NAVFAC DRAWING NO. 12821709	
SHEET 108 OF 382		DRAWING REVISION: 07 AUG 2018	

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INTERIOR PAINTING NOTES

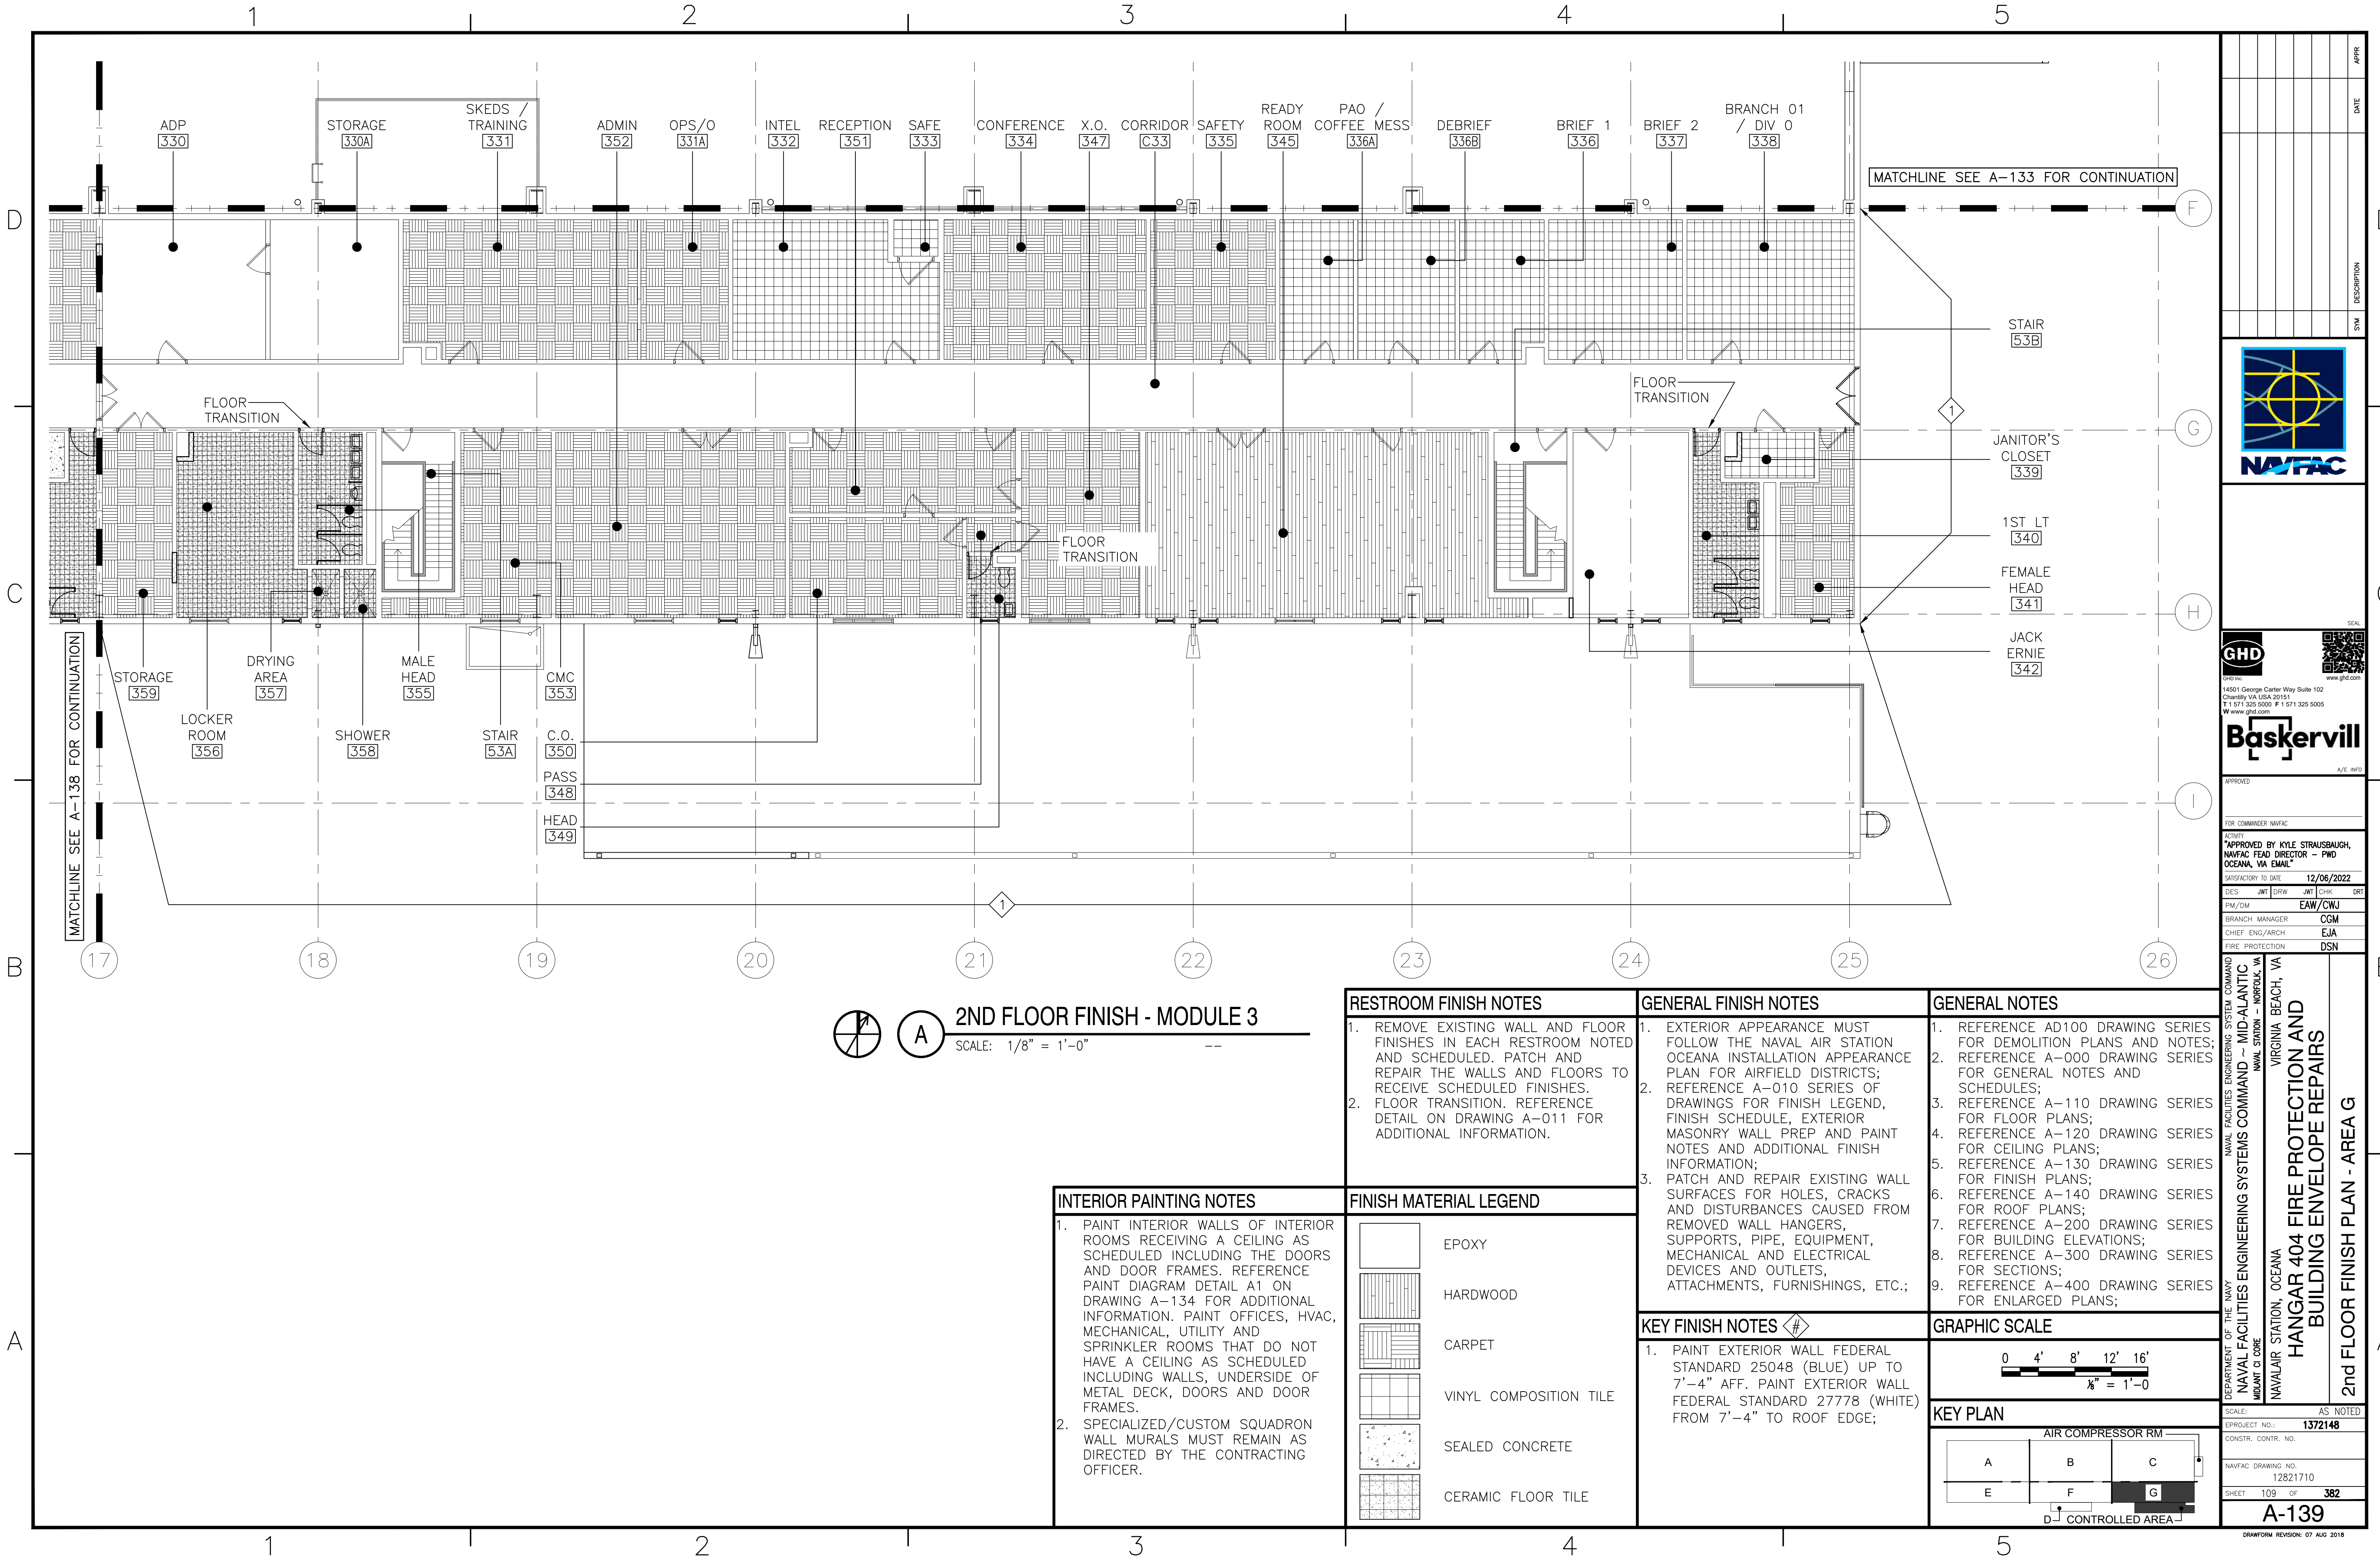- PAINT INTERIOR WALLS OF INTERIOR ROOMS RECEIVING A CEILING AS SCHEDULED INCLUDING THE DOORS AND DOOR FRAMES. REFERENCE PAINT DIAGRAM DETAIL A1 ON DRAWING A-134 FOR ADDITIONAL INFORMATION. PAINT OFFICES, HVAC, MECHANICAL, UTILITY AND SPRINKLER ROOMS THAT DO NOT HAVE A CEILING AS SCHEDULED INCLUDING WALLS, UNDERSIDE OF METAL DECK, DOORS AND DOOR FRAMES.
- SPECIALIZED/CUSTOM SQUADRON WALL MURALS MUST REMAIN AS DIRECTED BY THE CONTRACTING OFFICER.

FINISH MATERIAL LEGEND	
	EPOXY
	HARDWOOD
	CARPET
	VINYL COMPOSITION TILE
	SEALED CONCRETE
	CERAMIC FLOOR TILE

RESTROOM FINISH NOTES

- REMOVE EXISTING WALL AND FLOOR FINISHES IN EACH RESTROOM NOTED AND SCHEDULED. PATCH AND REPAIR THE WALLS AND FLOORS TO RECEIVE SCHEDULED FINISHES.
- FLOOR TRANSITION. REFERENCE DETAIL ON DRAWING A-011 FOR ADDITIONAL INFORMATION.

GENERAL FINISH NOTES


- EXTERIOR APPEARANCE MUST FOLLOW THE NAVAL AIR STATION OCEANA INSTALLATION APPEARANCE PLAN FOR AIRFIELD DISTRICTS;
- REFERENCE A-010 SERIES OF DRAWINGS FOR FINISH LEGEND, FINISH SCHEDULE, EXTERIOR MASONRY WALL PREP AND PAINT NOTES AND ADDITIONAL FINISH INFORMATION;
- PATCH AND REPAIR EXISTING WALL SURFACES FOR HOLES, CRACKS AND DISTURBANCES CAUSED FROM REMOVED WALL HANGERS, SUPPORTS, PIPE, EQUIPMENT, MECHANICAL AND ELECTRICAL DEVICES AND OUTLETS, ATTACHMENTS, FURNISHINGS, ETC.;

KEY FINISH NOTES

- PAINT EXTERIOR WALL FEDERAL STANDARD 25048 (BLUE) UP TO 7'-4" AFF. PAINT EXTERIOR WALL FEDERAL STANDARD 27778 (WHITE) FROM 7'-4" TO ROOF EDGE;

GENERAL NOTES

- REFERENCE AD100 DRAWING SERIES FOR DEMOLITION PLANS AND NOTES;
- REFERENCE A-000 DRAWING SERIES FOR GENERAL NOTES AND SCHEDULES;
- REFERENCE A-110 DRAWING SERIES FOR FLOOR PLANS;
- REFERENCE A-120 DRAWING SERIES FOR CEILING PLANS;
- REFERENCE A-130 DRAWING SERIES FOR FINISH PLANS;
- REFERENCE A-140 DRAWING SERIES FOR ROOF PLANS;
- REFERENCE A-200 DRAWING SERIES FOR BUILDING ELEVATIONS;
- REFERENCE A-300 DRAWING SERIES FOR SECTIONS;
- REFERENCE A-400 DRAWING SERIES FOR ENLARGED PLANS;

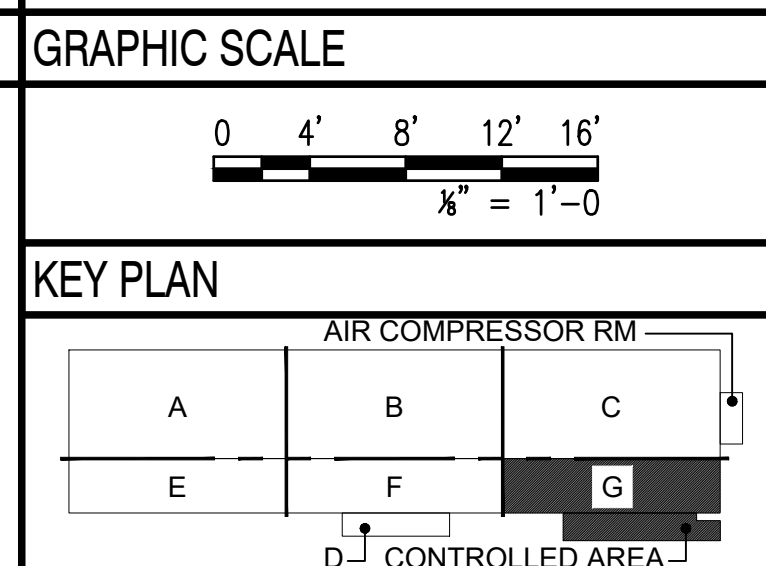

APPR	DATE
SYN	DESCRIPTION

14501 George Carter Way Suite 102
Chantilly VA USA 20151
T 1 571 325 5000 F 1 571 325 5005
W www.gnd.com

Baskervill
A/E 1870

APPROVED

FOR COMMANDER NAVFAC

*APPROVED BY KYLE STRAUSBAUGH,
NAVFAC HEAD DIRECTOR - PWD
OCEANA, VA EMAIL*

SATISFACTORY TO DATE: 12/06/2022

DES	JMT	DRW	JMT	CHK	DRT
PM/DM				EAU/CWJ	
BRANCH				CGM	
CHIEF				EJA	
FIRE PROTECTION				DSN	

DEPARTMENT OF THE NAVY
NAVAL FACILITIES ENGINEERING SYSTEMS COMMAND
NAVAL STATION - NORFOLK, VA
VIRGINIA BEACH, VA

HANGAR 404 FIRE PROTECTION AND
BUILDING ENVELOPE REPAIRS

2nd FLOOR FINISH PLAN - AREA G

SCALE: AS NOTED

PROJECT NO.: 1372148

CONSTR. CONTR. NO.

NAVFAC DRAWING NO.
12821710

SHEET 109 OF 382

A-139

DRAWING REVISION: 07 AUG 2018