



# MCCALL SMOKEJUMPER BASE

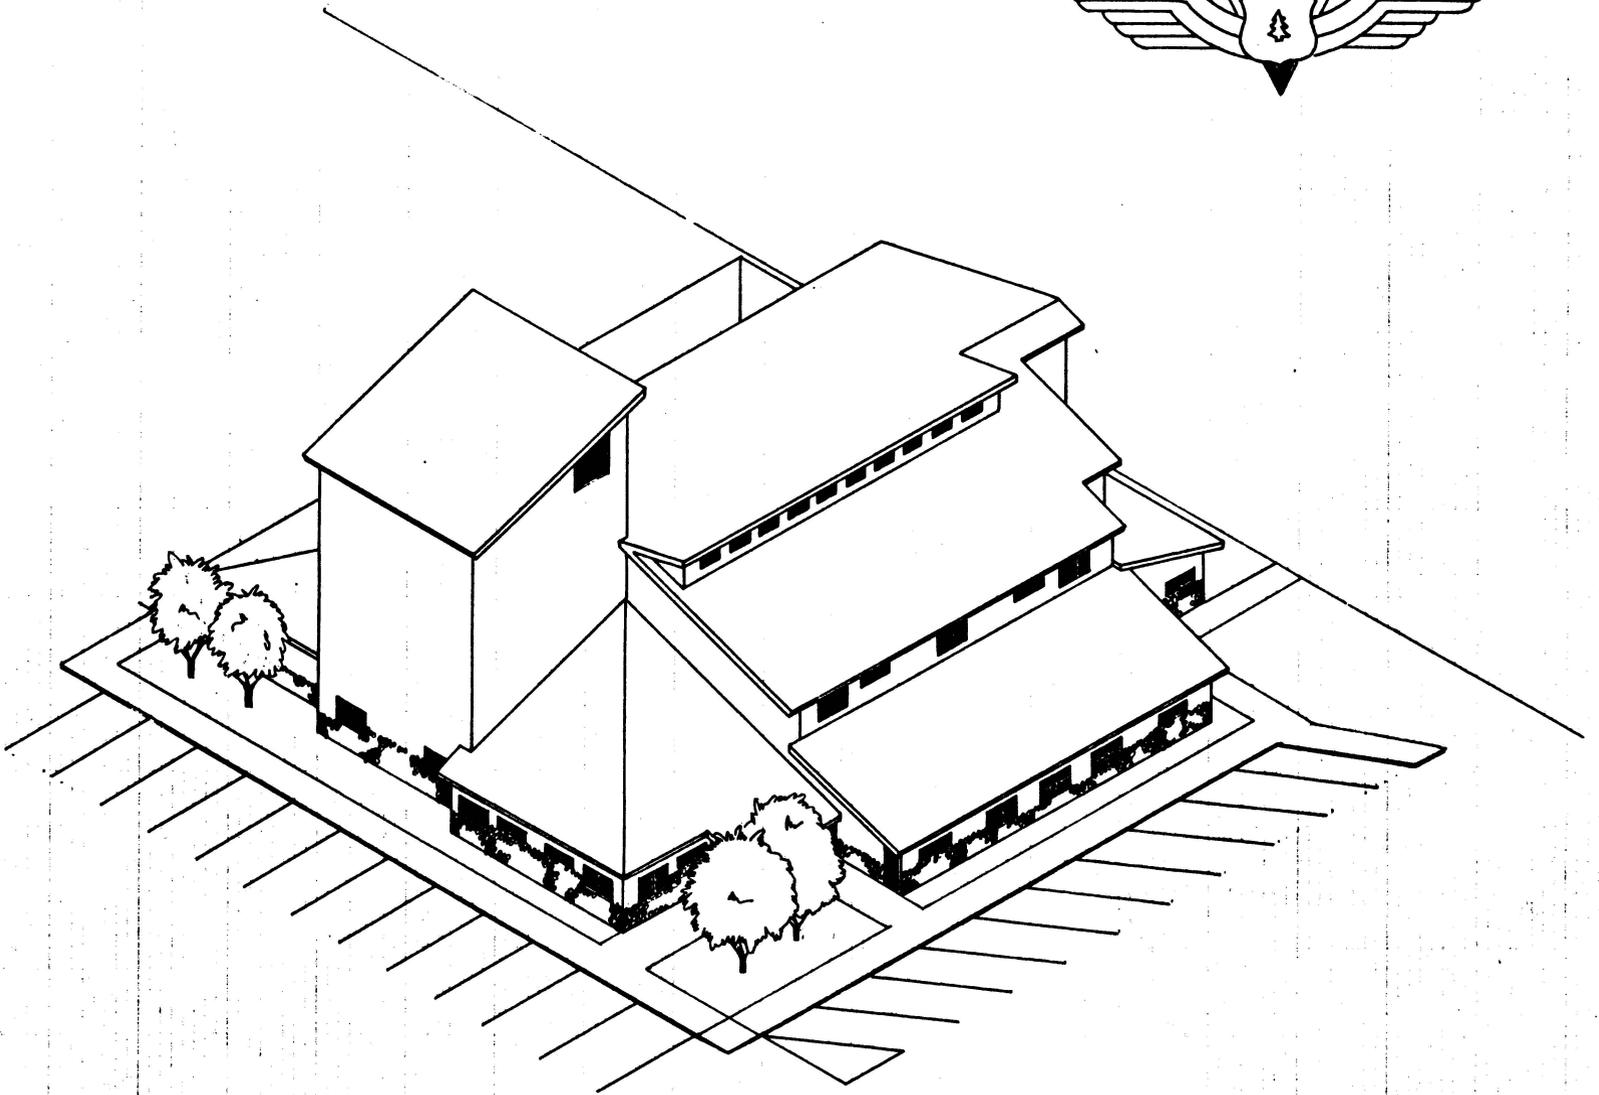

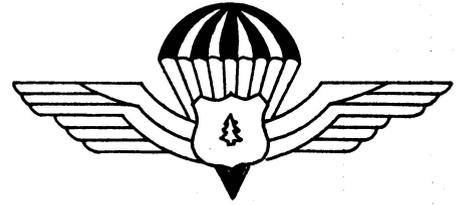

Administrative building and tower

Pilot Offices/Showers

McCall  
Smokejumper Base


Bike Storage

Motor Sheds

Weight Rm


Google

Imagery ©2018 Google, Map data ©2018 Google United States Terms Send feedback 50 ft

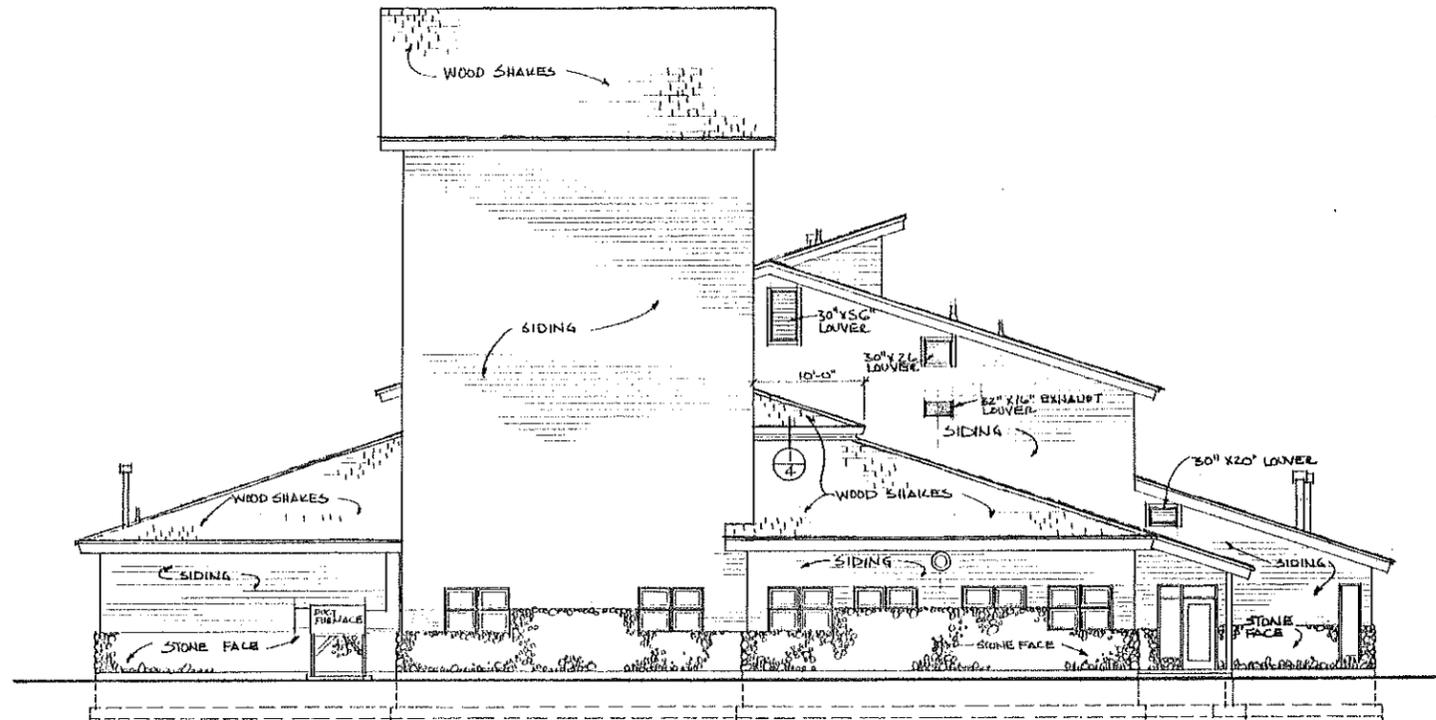


**WEST ELEVATION**

SCALE 1/8" = 1'-0"

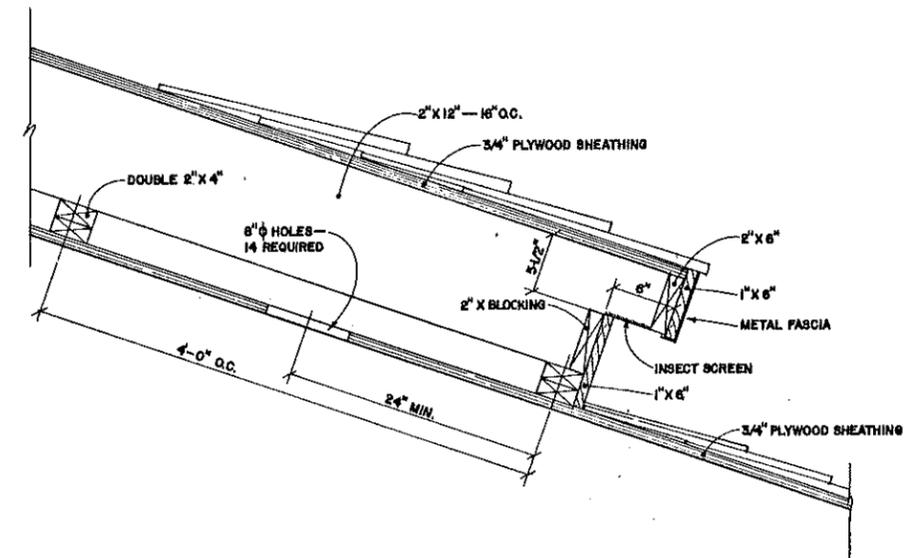

**VENTING DETAIL**


1-1/2" = 1'-0"

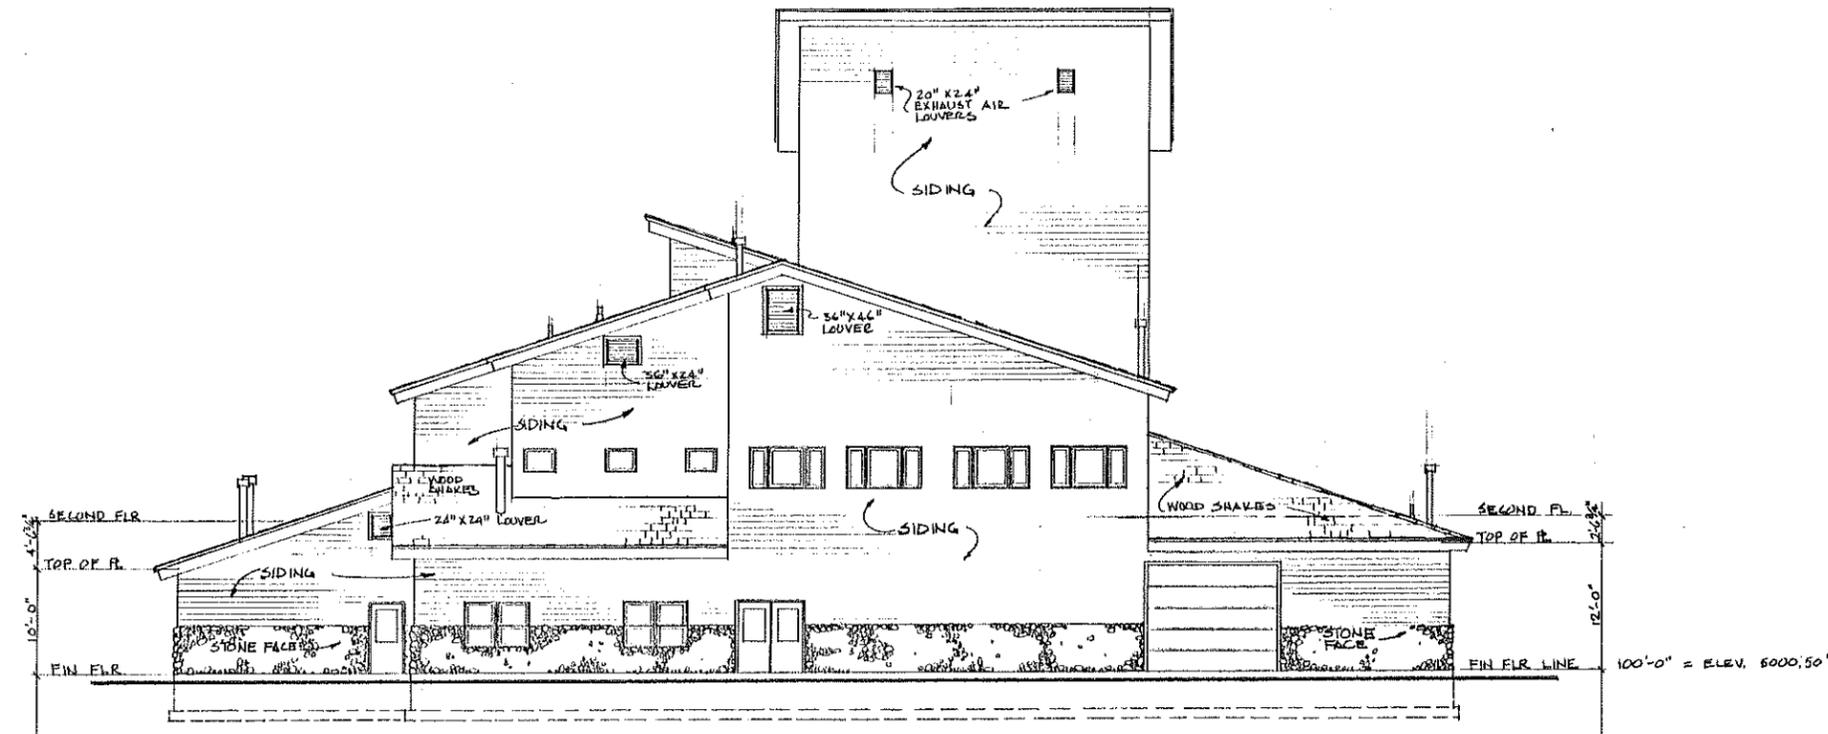


**EAST ELEVATION**

SCALE 1/8" = 1'-0"

U.S. Department of Agriculture FOREST SERVICE		<b>McCALL SMOKEJUMPER BASE</b>	
Region 4	Engineering	PAYETTE NATIONAL FOREST McCALL, IDAHO	
DESIGN	BY B. CROCKETT CHECK W. MOFFETT	<b>PARALOFT BUILDING ELEVATIONS</b>	
DRAWN	BY B. CROCKETT CHECK W. MOFFETT		
APPROVED	<i>[Signature]</i>	DRAWING NO. 270	4 of 31
TITLE <i>[Signature]</i>		DATE 6/1986	

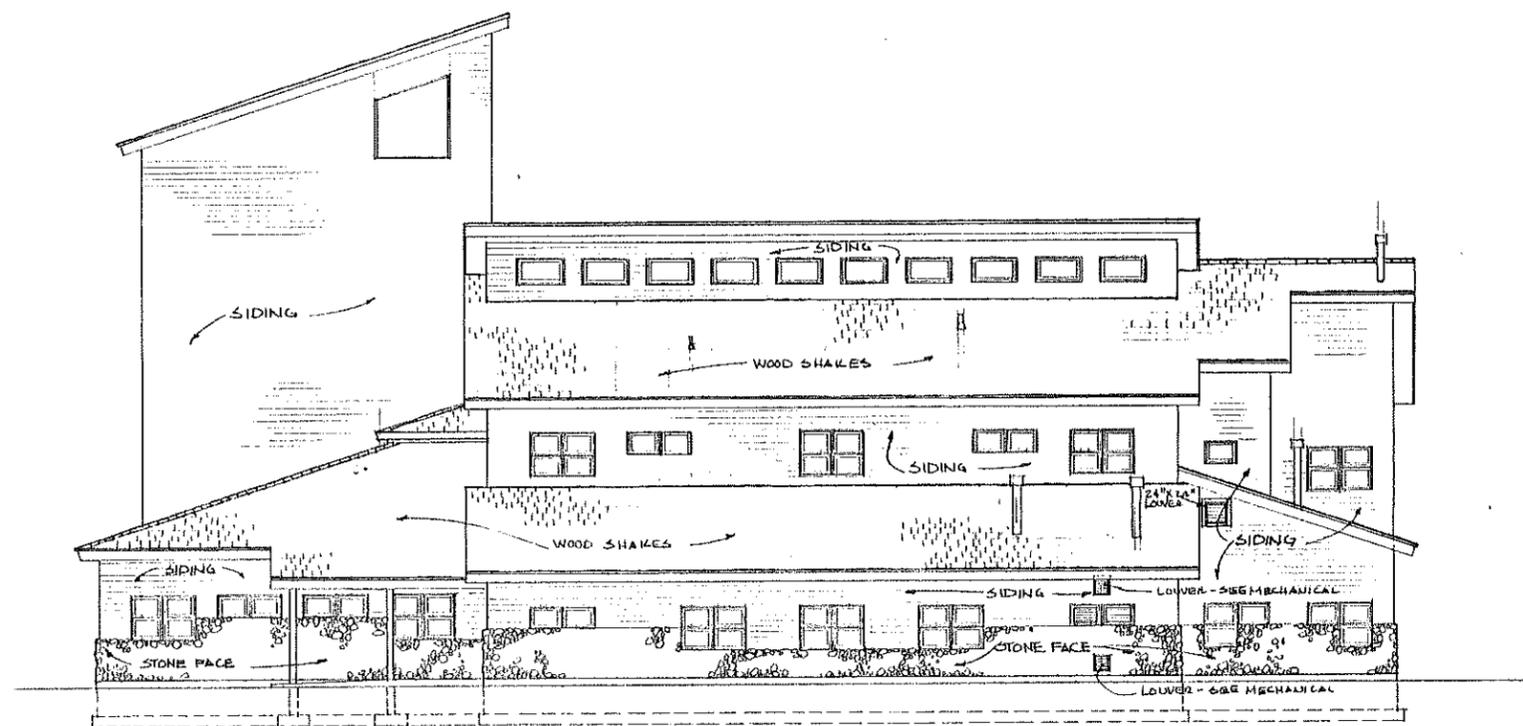


**SOUTH ELEVATION**  
SCALE 1/8" = 1'-0"

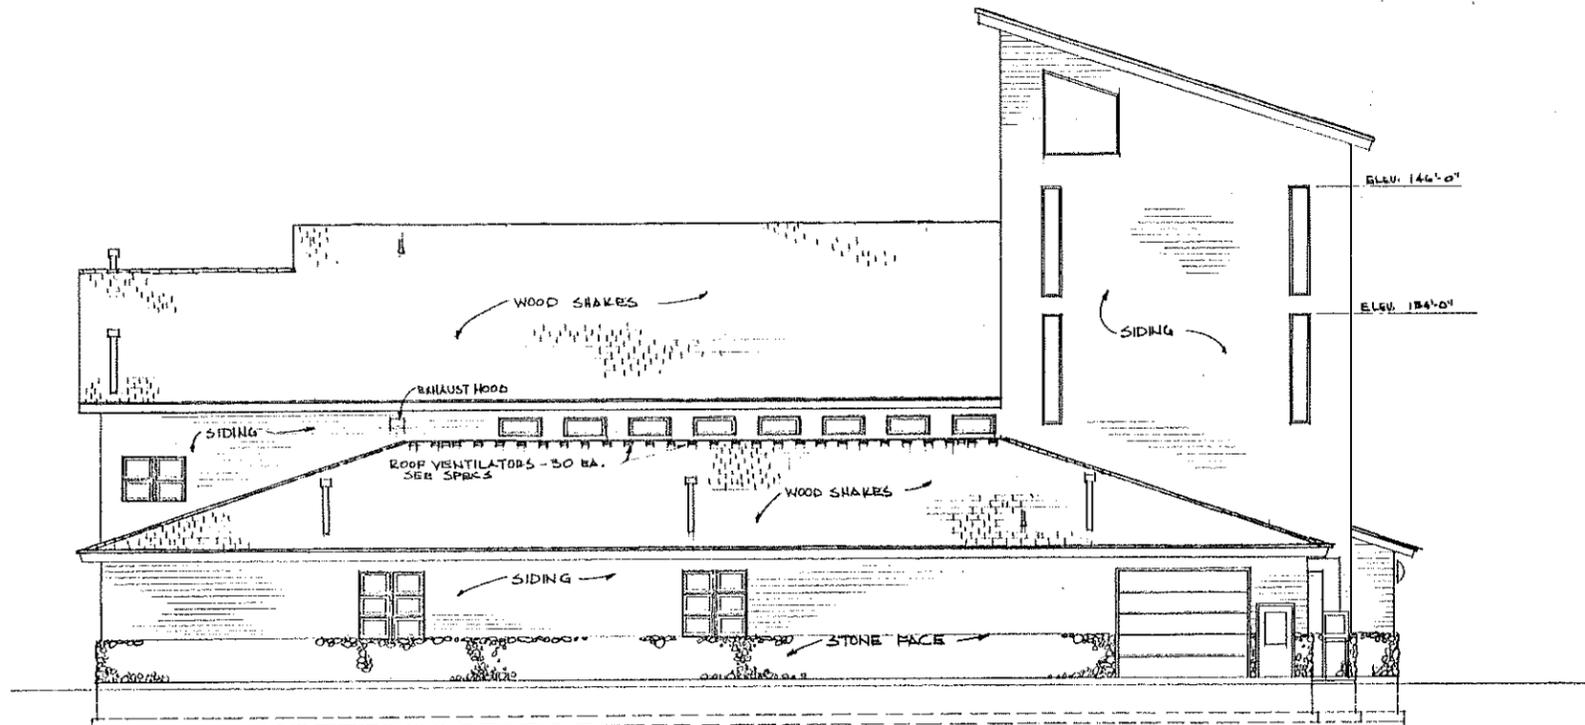

**NORTH ELEVATION**  
SCALE 1/8" = 1'-0"  
11' 0" 5' 10"

U.S. Department of Agriculture FOREST SERVICE		<b>McCALL SMOKEJUMPER BASE</b>	
Region 4	Engineering	PAYETTE NATIONAL FOREST	McCALL, IDAHO
DESIGN	BY B. CROCKETT CHECK W. MOFFETT	<b>PARALOFT BUILDING ELEVATIONS</b>	
DRAWN	BY B. CROCKETT CHECK W. MOFFETT		
APPROVED	<i>[Signature]</i>	DRAWING NO. 270	5
TITLE	Act. Dir. Edge	DATE 6/18/86	31

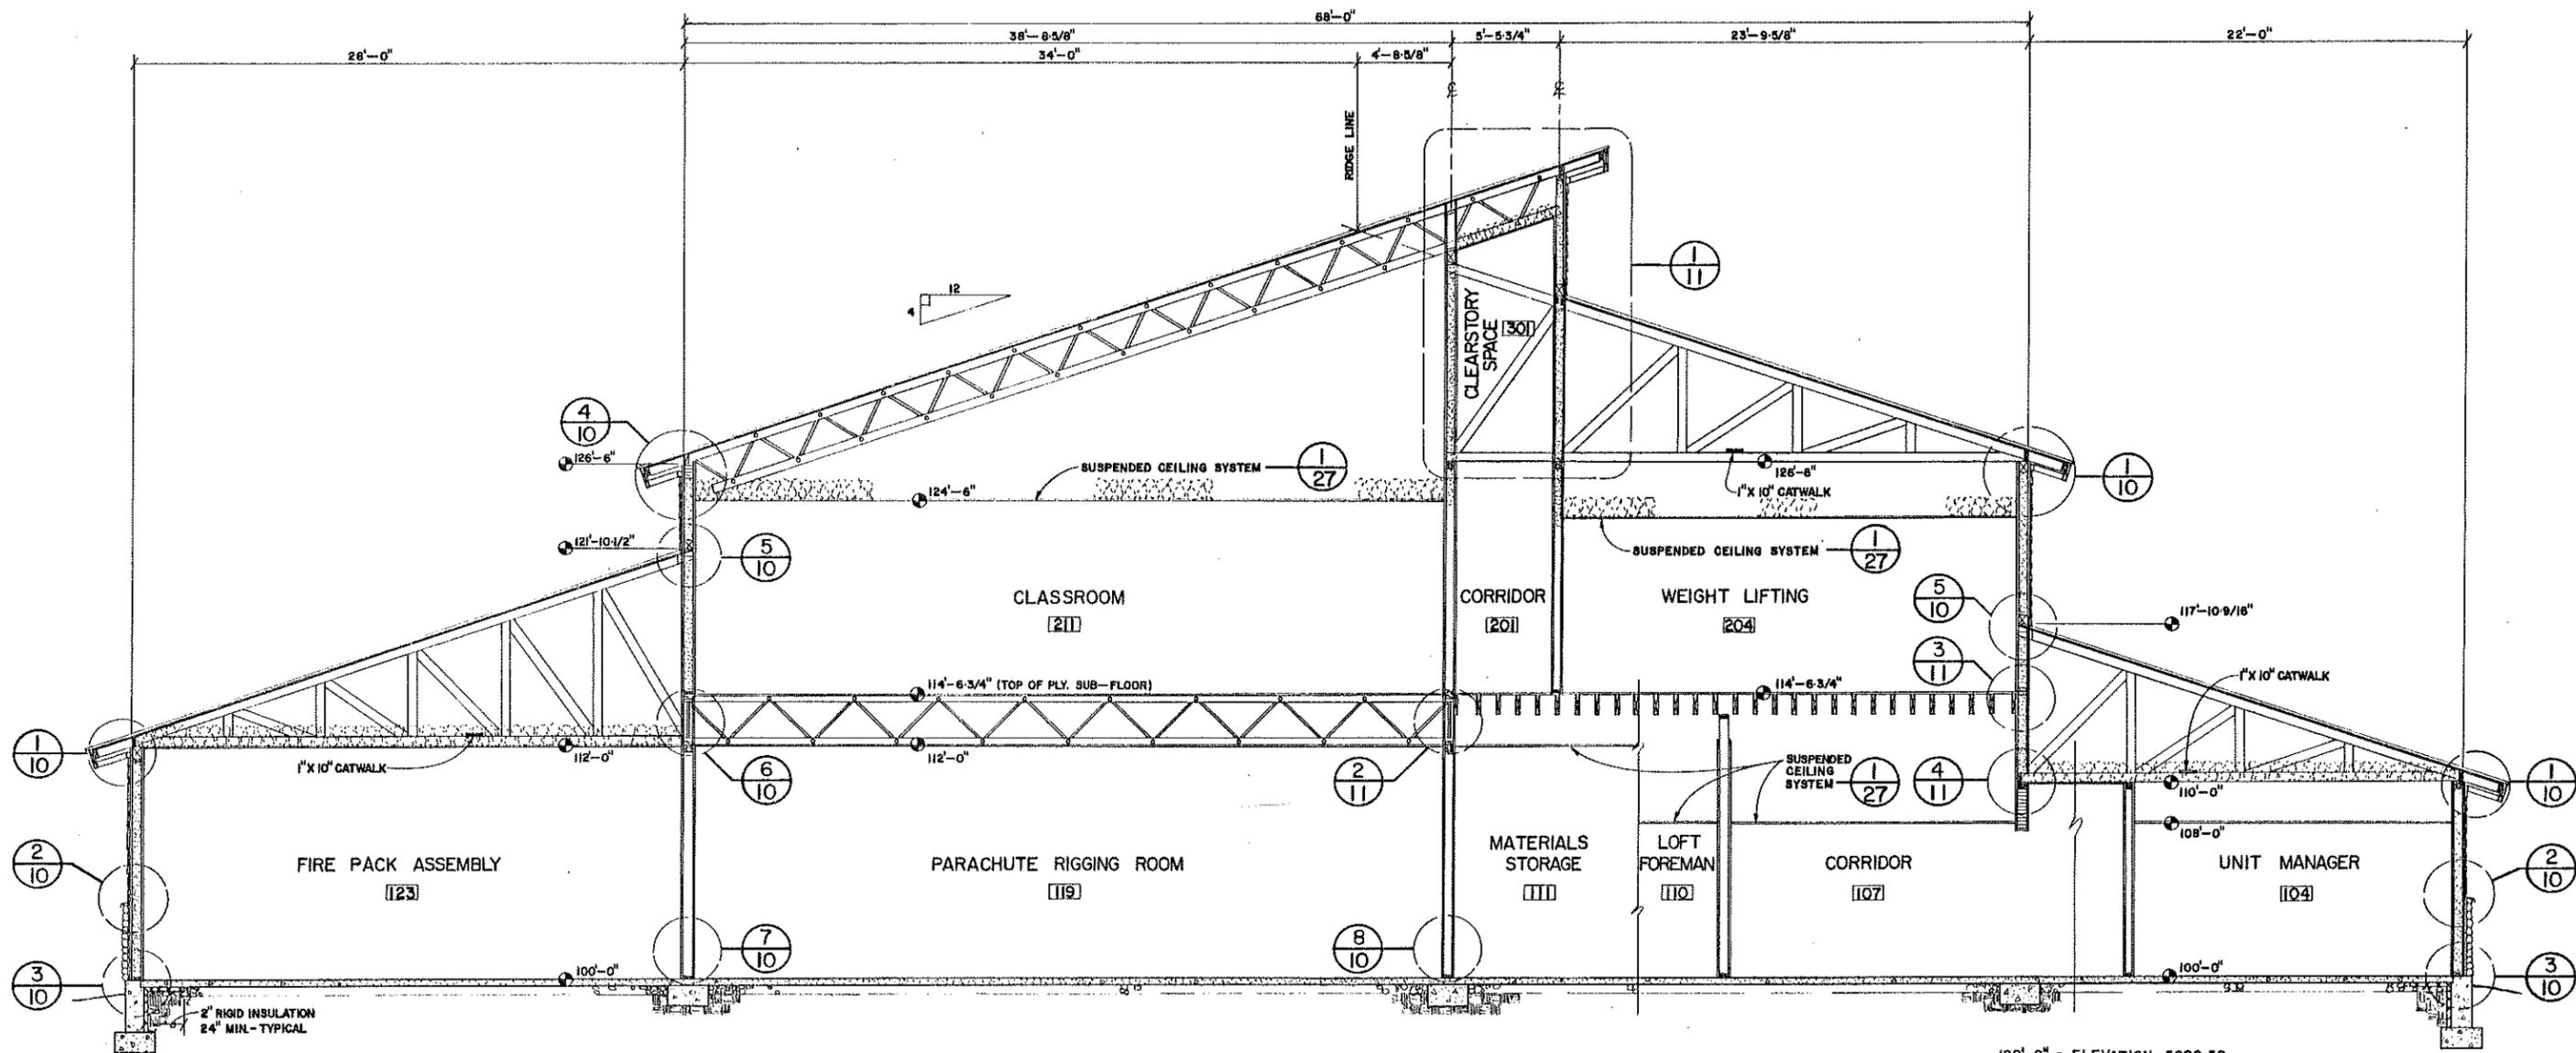


NOTE: SEE STRUCTURAL DRAWINGS FOR TRUSS & FRAMING MEMBER SIZE, SPACING, CONNECTIONS ETC.

NOTE: INSULATION =  
WALLS - R-19  
CEILINGS - R-19  
UNDER FLOOR - SEE SPEC.

100'-0" ELEVATION 5000.50


**BUILDING SECTION**  
1/4" = 1'-0"  
1/6

U.S. Department of Agriculture FOREST SERVICE		<b>McCALL SMOKEJUMPER BASE</b>	
Region 4	Engineering	PAYETTE NATIONAL FOREST McCALL, IDAHO	
DESIGN	BY B. BROCKERT / W. MOFFETT CHECK W. MOFFETT	<b>PARALOFT BUILDING BUILDING SECTION</b>	
DRAWN	BY G.W. GIBBONS CHECK W. MOFFETT		
APPROVED	<i>[Signature]</i>	DRAWING NO.	270
TITLE	Act. Dir. <i>[Signature]</i> DATE 6/1/82		6 31

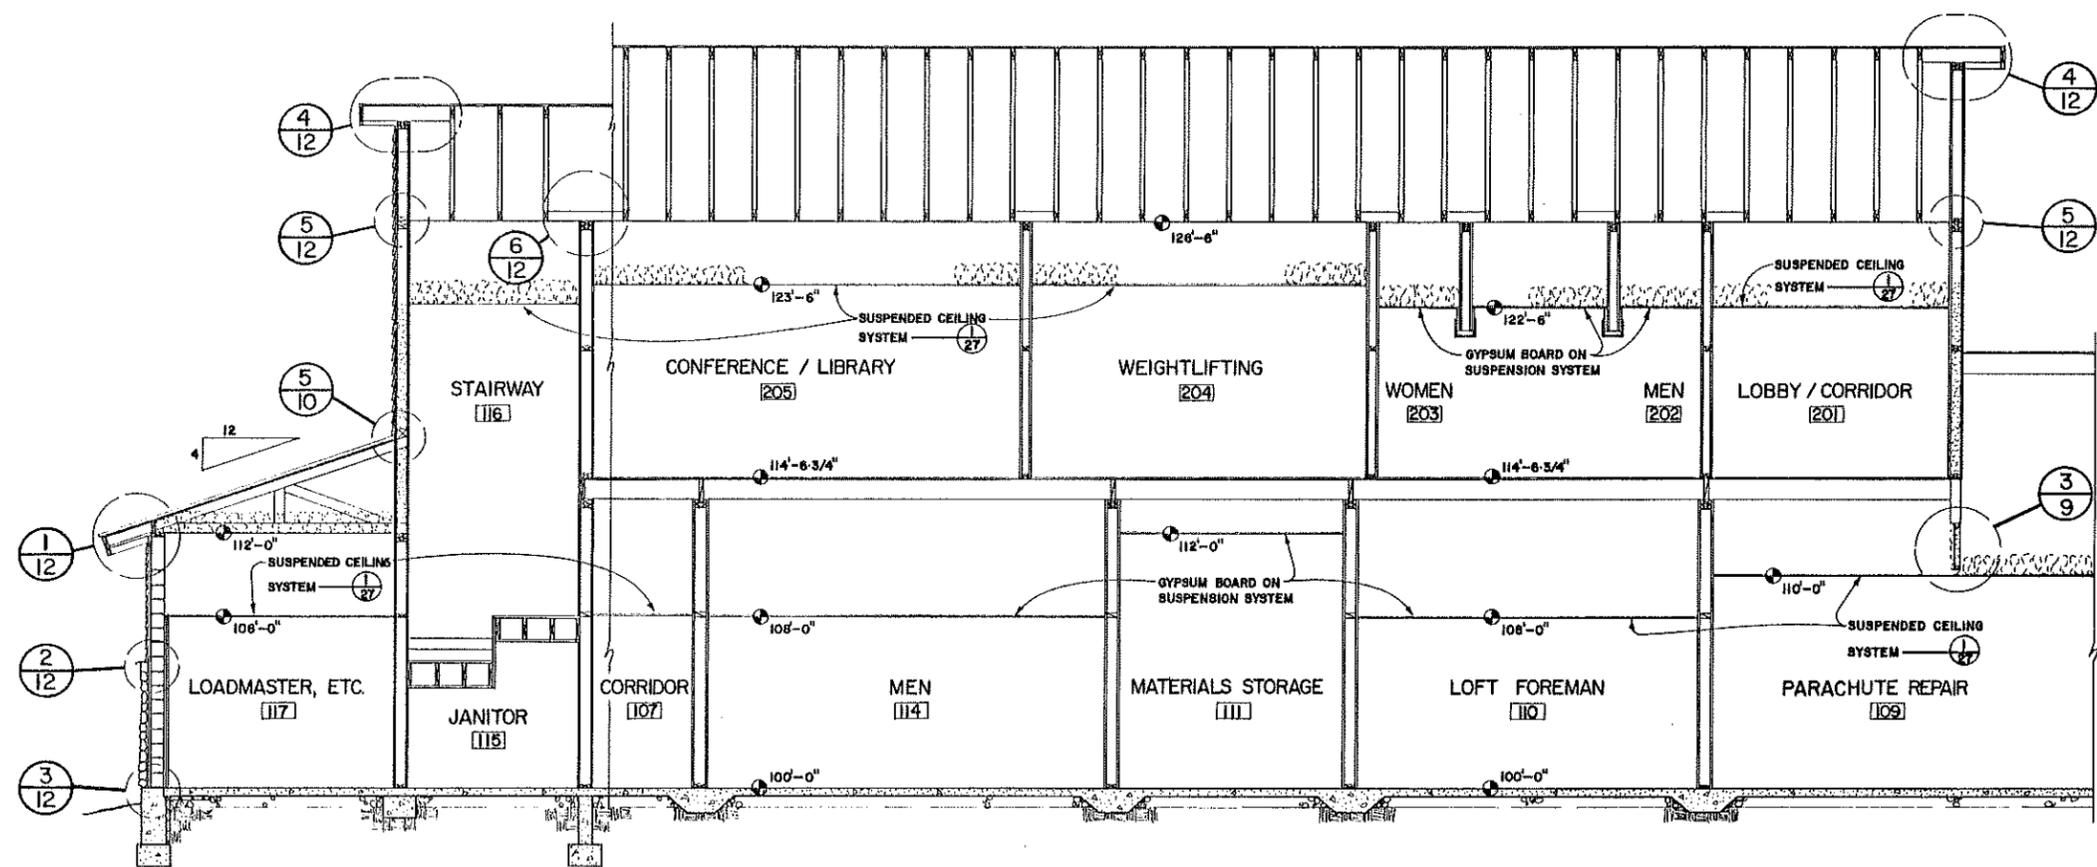

NOTE: SEE STRUCTURAL DRAWINGS FOR TRUSS & FRAMING MEMBER SIZE, SPACING, CONNECTIONS ETC.

NOTE: INSULATION = WALLS - R-19  
CEILINGS - R-19  
UNDER FLOOR - SEE SPEC.

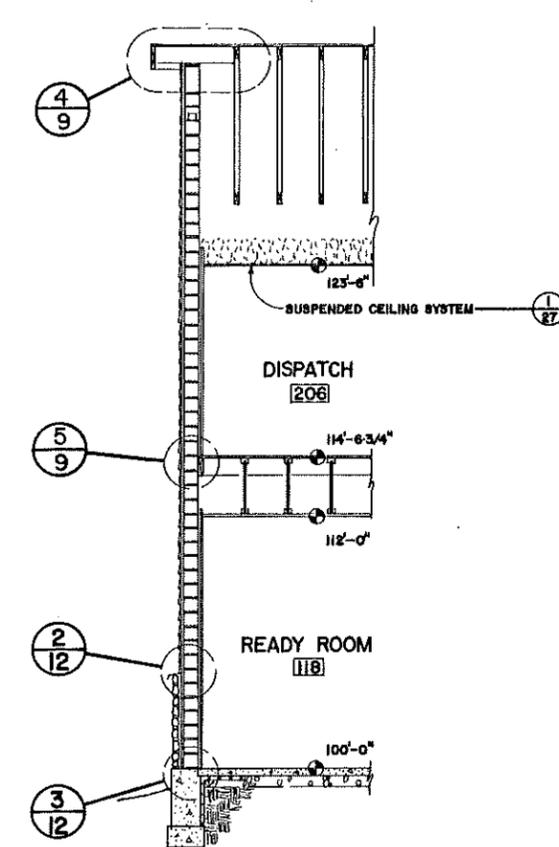

WALL SECTION  
1/4" = 1'-0"

**BUILDING SECTION**

1/4" = 1'-0"




1  
7

2  
7

U.S. Department of Agriculture FOREST SERVICE		<b>McCALL SMOKEJUMPER BASE</b>	
Region 4	Engineering	PAYETTE NATIONAL FOREST McCALL, IDAHO	
DESIGN	BY E. COCKETT / W. MOFFETT CHECK W. MOFFETT	<b>PARALOFT BUILDING BUILDING SECTION</b>	
DRAWN	BY GW GIBBONS CHECK W. MOFFETT		
APPROVED	<i>[Signature]</i>	DRAWING NO. 270	7
TITLE	Arch. Div. Engr.	DATE 6/19/86	31






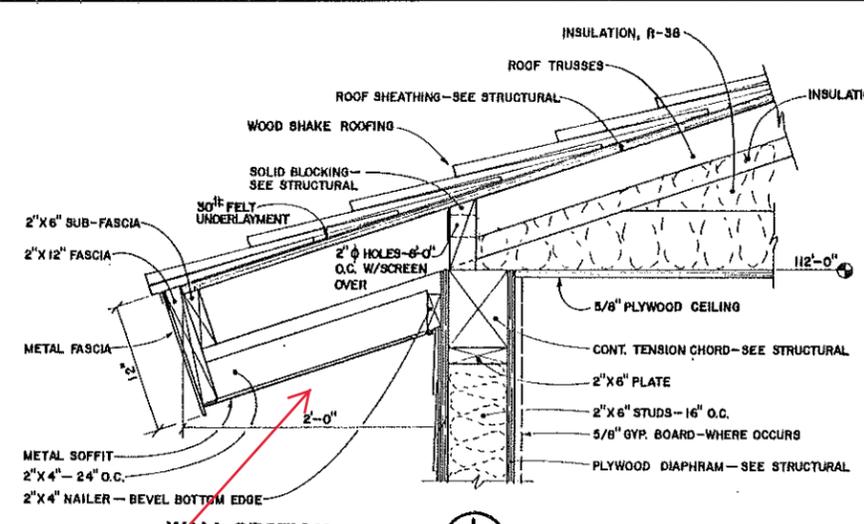


Replace w/ fiber cement soffit

WALL SECTION 1  
1-1/2" = 1'-0"

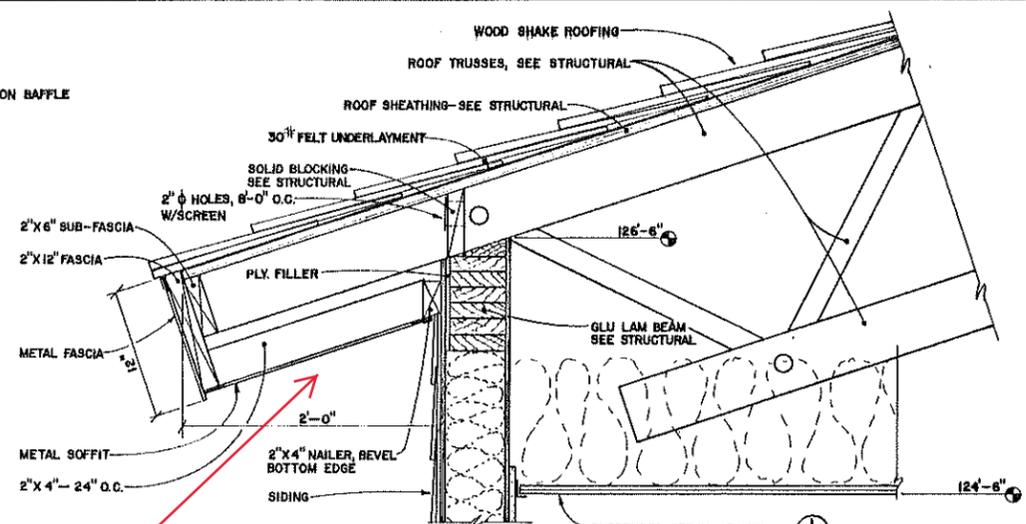


Replace w/ fiber cement soffit


WALL SECTION 4  
1-1/2" = 1'-0"

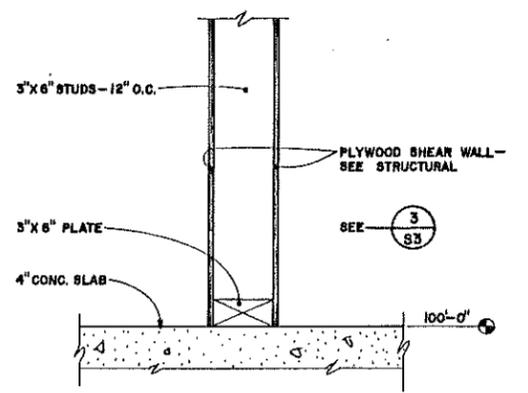


WALL SECTION 7  
1-1/2" = 1'-0"

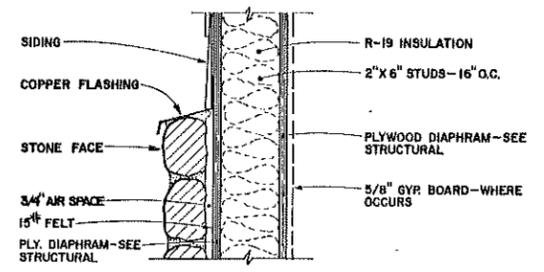


WALL SECTION 2  
1-1/2" = 1'-0"

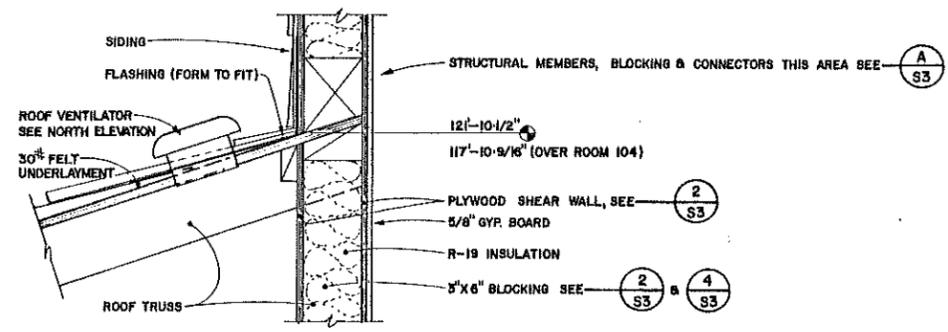


WALL SECTION 5  
1-1/2" = 1'-0"

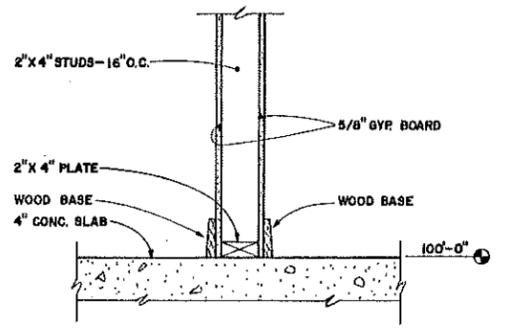

WALL SECTION 8  
1-1/2" = 1'-0"

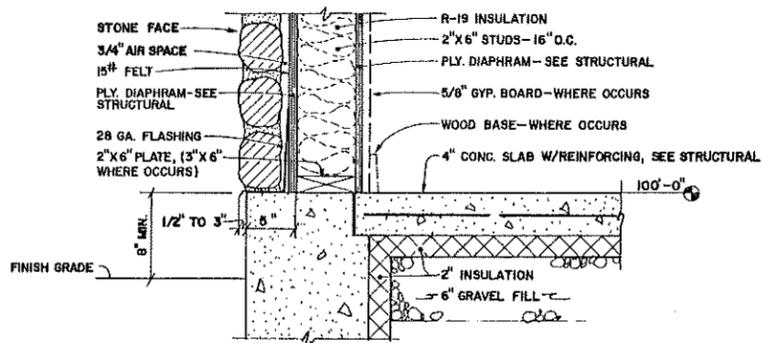


WALL SECTION 3  
1-1/2" = 1'-0"

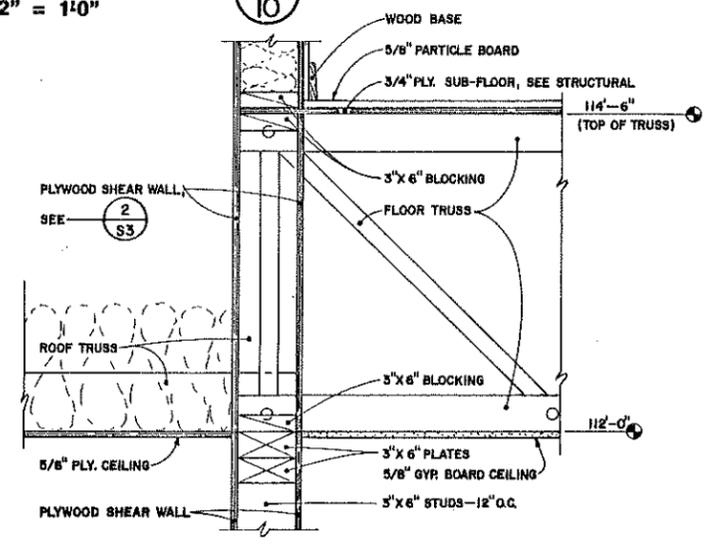


WALL SECTION 6  
1-1/2" = 1'-0"




U.S. Department of Agriculture FOREST SERVICE		<b>McCALL SMOKEJUMPER BASE</b>	
Region 4	Engineering	PAYETTE NATIONAL FOREST	McCALL, IDAHO
DESIGN	BY W. MOFFETT CHECK E. CROCKETT	<b>PARALOFT BUILDING WALL SECTIONS &amp; DETAILS</b>	
DRAWN	BY G.W. GIBBONS CHECK W. MOFFETT		
APPROVED	<i>[Signature]</i>	DRAWING NO.	270
TITLE	<i>[Signature]</i>	DATE	10 31

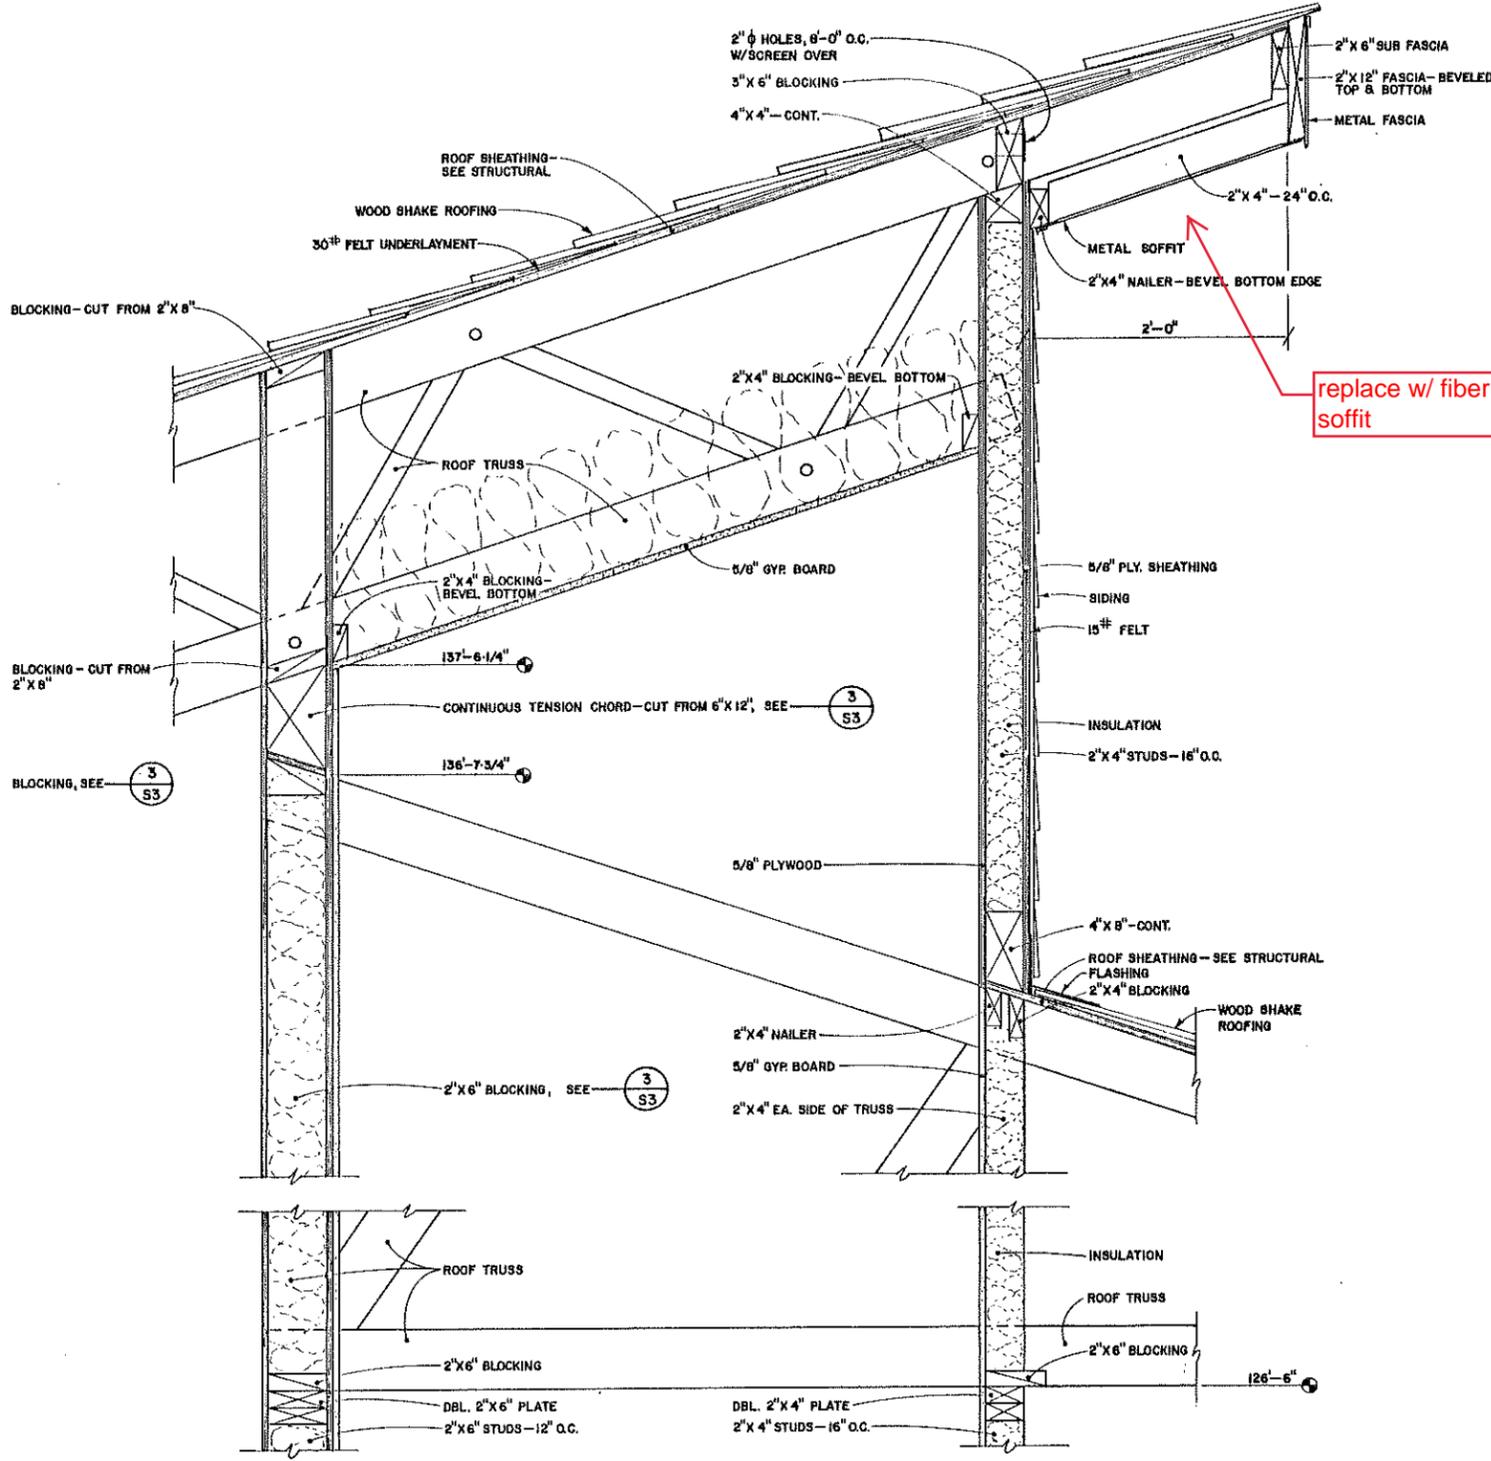


**WALL SECTION 1**  
 1-1/2" = 1'-0"

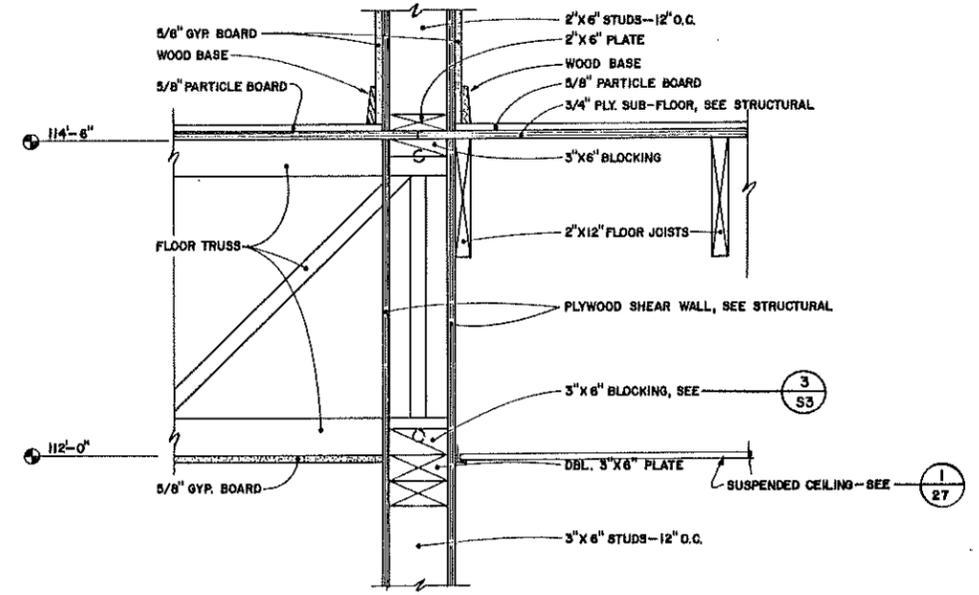

**WALL SECTION 2**  
 1-1/2" = 1'-0"

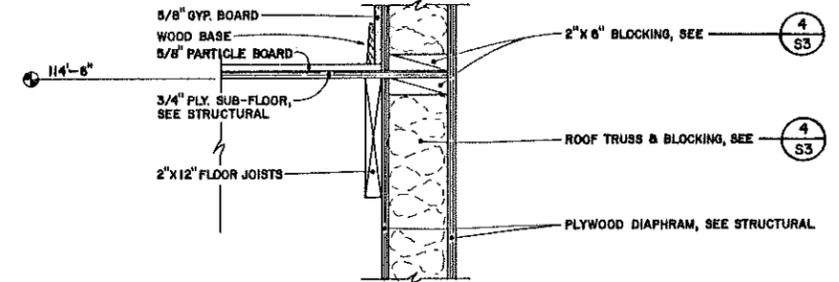


**WALL SECTION 3**  
 1-1/2" = 1'-0"

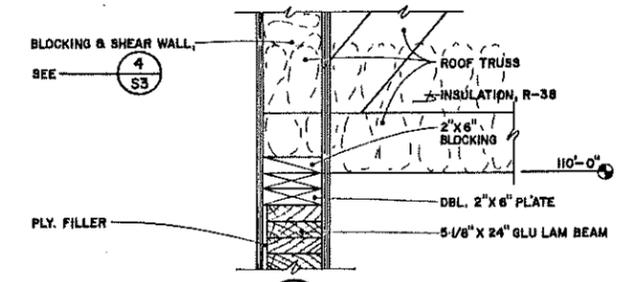


**WALL SECTION 4**  
 1-1/2" = 1'-0"


U.S. Department of Agriculture FOREST SERVICE		<b>McCALL SMOKEJUMPER BASE</b>	
Region 4	Engineering	PAYETTE NATIONAL FOREST McCALL, IDAHO	
DESIGN	BY: W. MOFFETT CHECK: B. CROCKETT	<b>PARALOFT BUILDING WALL SECTIONS &amp; DETAILS</b>	
DRAWN	BY: G.W. GIBBONS CHECK: W. MOFFETT		
APPROVED	<i>[Signature]</i> TITLE: Act. Dir. Engr. DATE: 6/1/86	DRAWING NO. 270	11 31

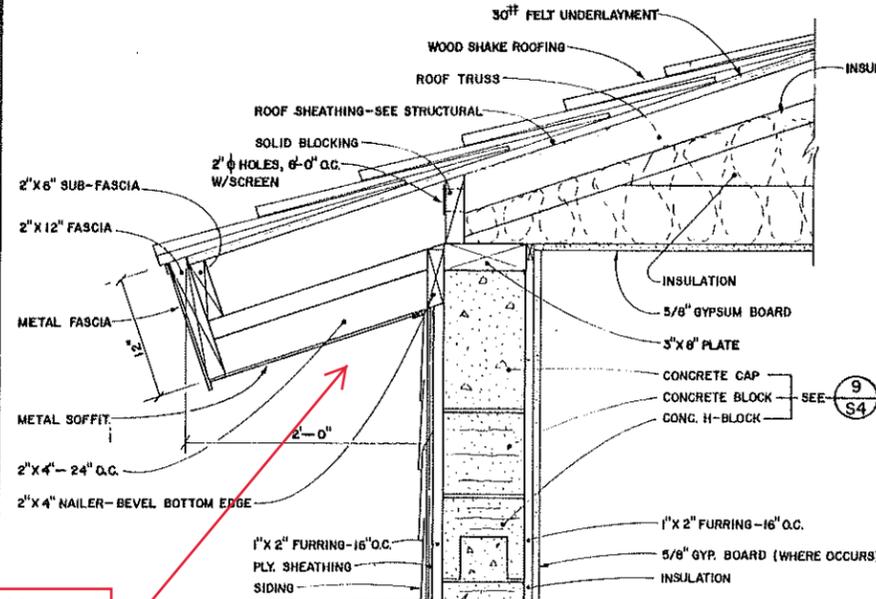


**WALL SECTION**  
1 1/2" = 1'-0" (1/12)

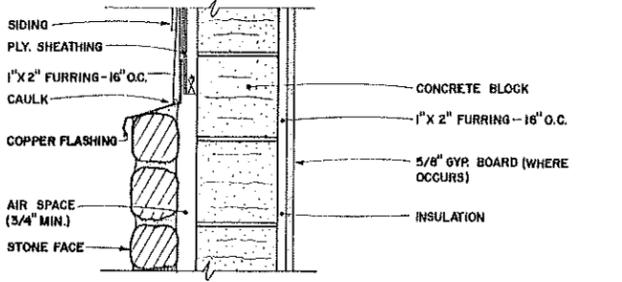


**WALL SECTION**  
1 1/2" = 1'-0" (2/12)

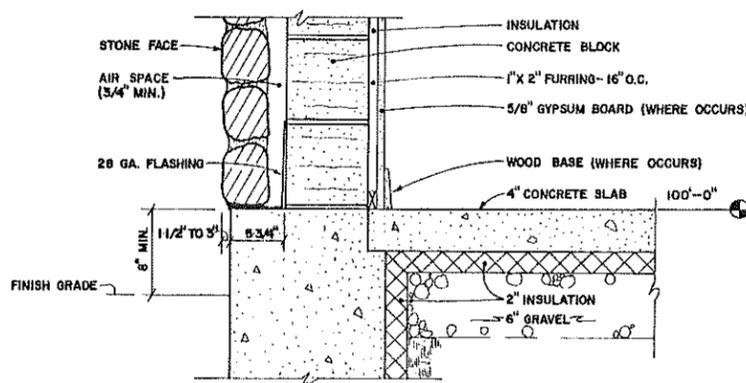


**WALL SECTION**  
1 1/2" = 1'-0" (3/12)

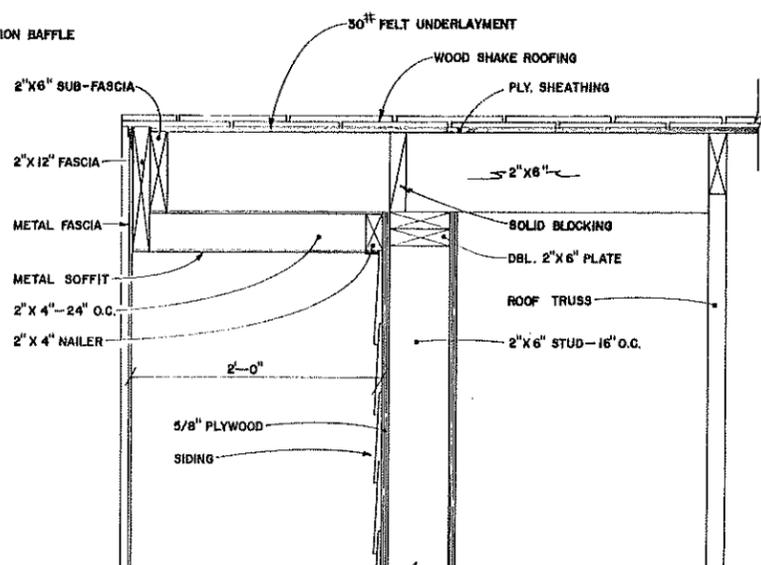


**WALL SECTION**  
1 1/2" = 1'-0" (4/12)

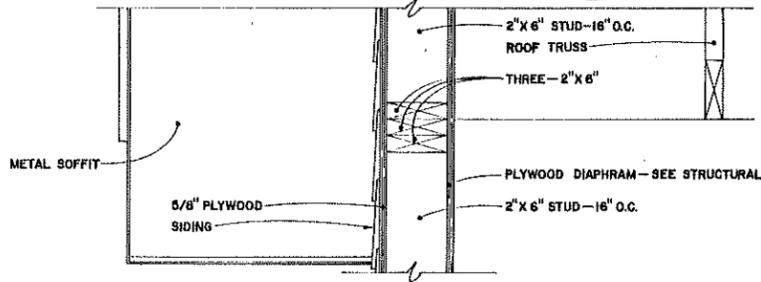


**WALL SECTION**  
1 1/2" = 1'-0" (5/12)

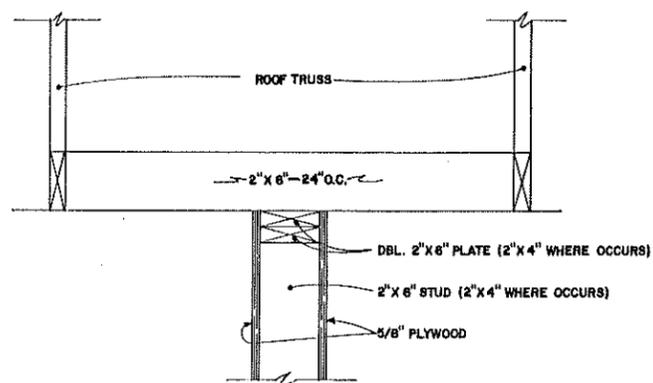


**WALL SECTION**  
1 1/2" = 1'-0" (6/12)

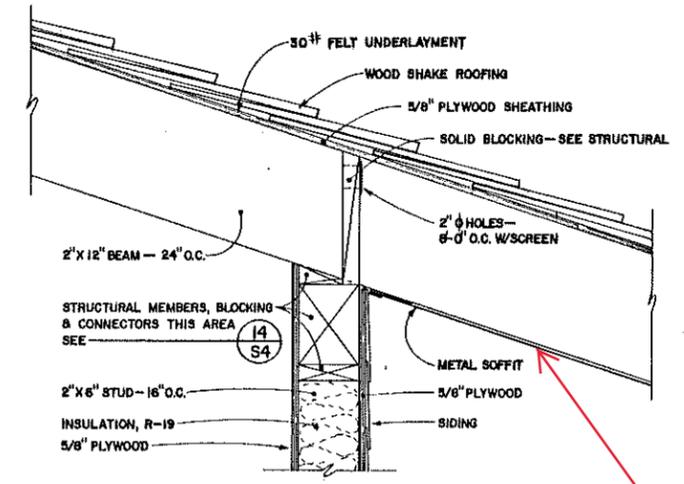

**WALL SECTION**  
1 1/2" = 1'-0" (7/12)

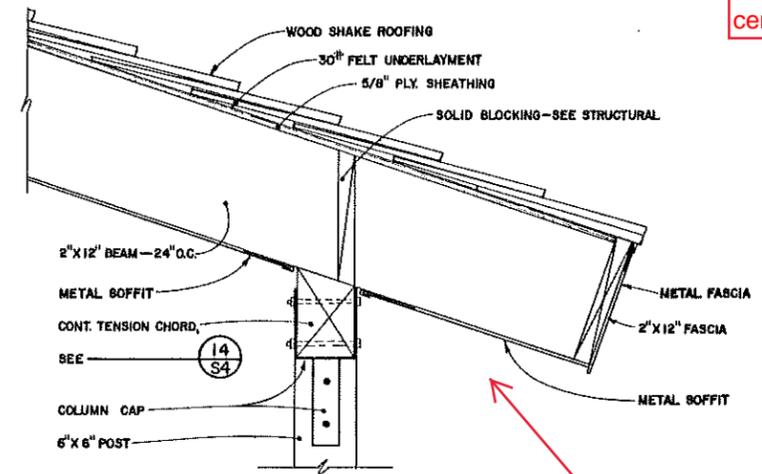

**WALL SECTION**  
1 1/2" = 1'-0" (8/12)

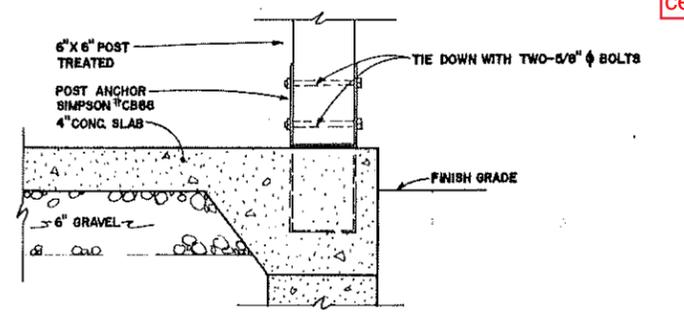


**WALL SECTION**  
1 1/2" = 1'-0" (9/12)

Replace w/ fiber cement soffit

Replace w/ fiber cement soffit


Replace w/ fiber cement soffit

U.S. Department of Agriculture FOREST SERVICE		<b>McCALL SMOKEJUMPER BASE</b>	
Region 4	Engineering	PAYETTE NATIONAL FOREST McCALL, IDAHO	
DESIGN	BY W. MOFFETT CHECK B.C. ROCKWELL	<b>PARALOFT BUILDING</b>	
DRAWN	BY G.W. GIBBONS CHECK W.M. OFFETT	<b>WALL SECTIONS &amp; DETAILS</b>	
APPROVED	<i>[Signature]</i>	DRAWING NO.	270
TITLE	Act. Dir. Engr.	DATE	6/10/66
			12 31

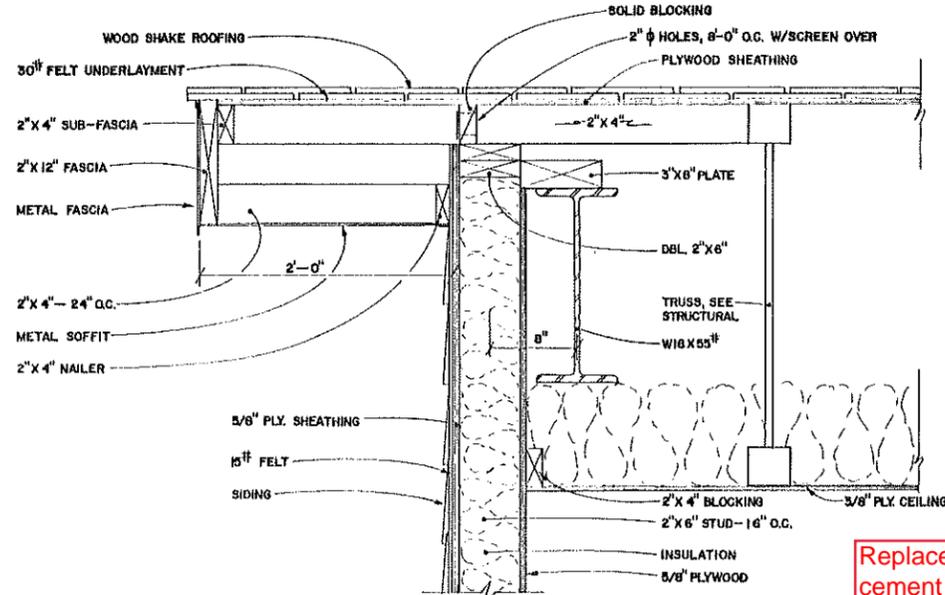


**WALL SECTION 1**  
1-1/2" = 1'-0" (1/13)

Replace w/ fiber cement siding

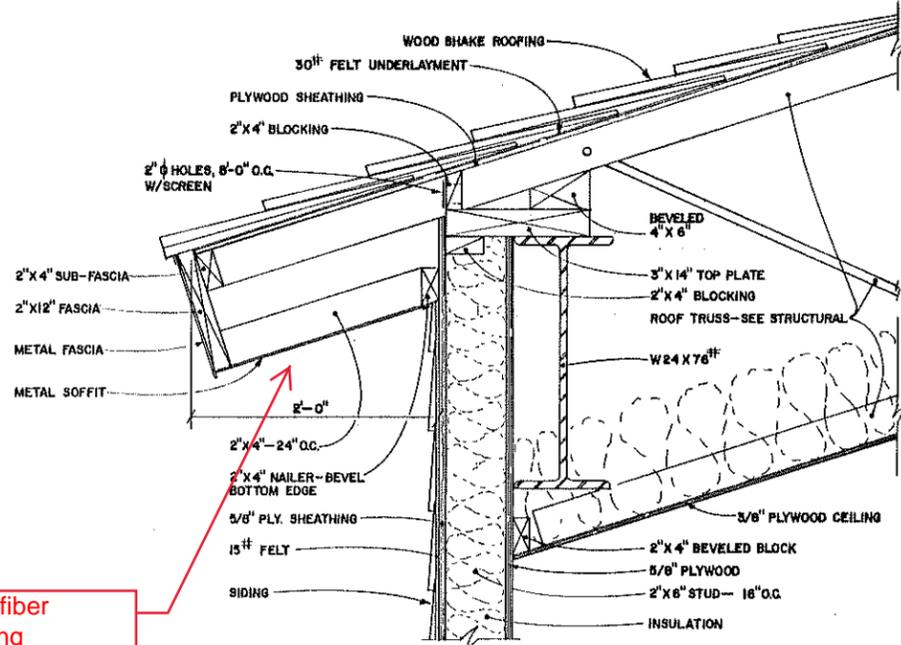


**WALL SECTION 4**  
1-1/2" = 1'-0" (4/13)

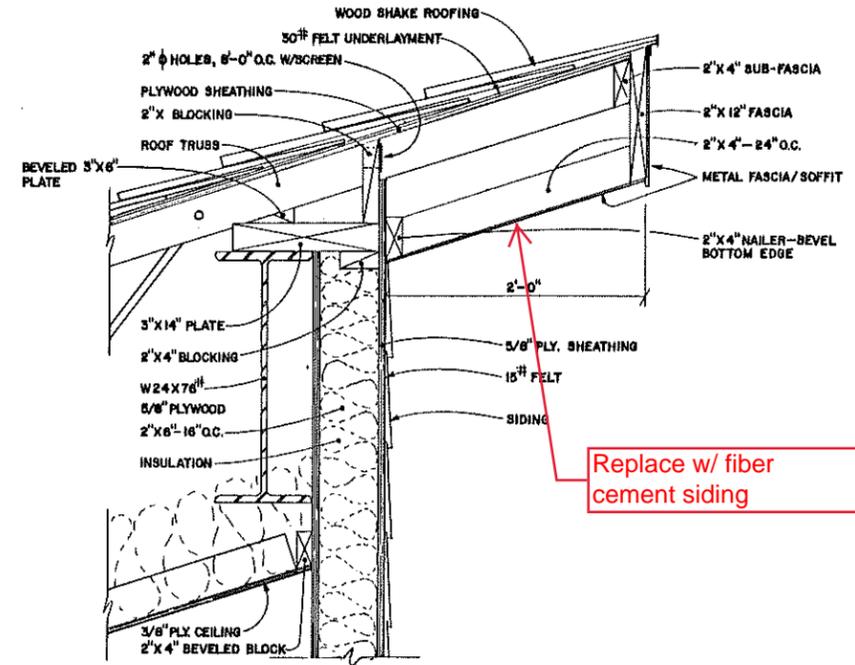


**WALL SECTION 7**  
1-1/2" = 1'-0" (7/13)


Replace w/ fiber cement siding

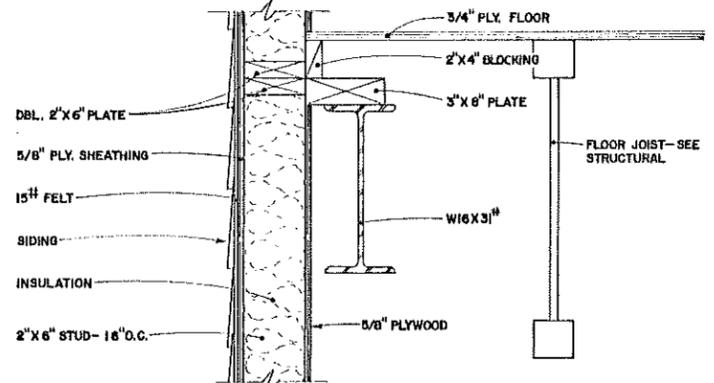


**WALL SECTION 2**  
1-1/2" = 1'-0" (2/13)

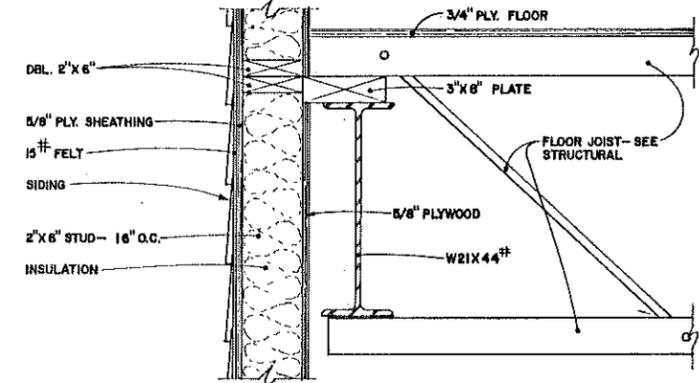

**WALL SECTION 5**  
1-1/2" = 1'-0" (5/13)

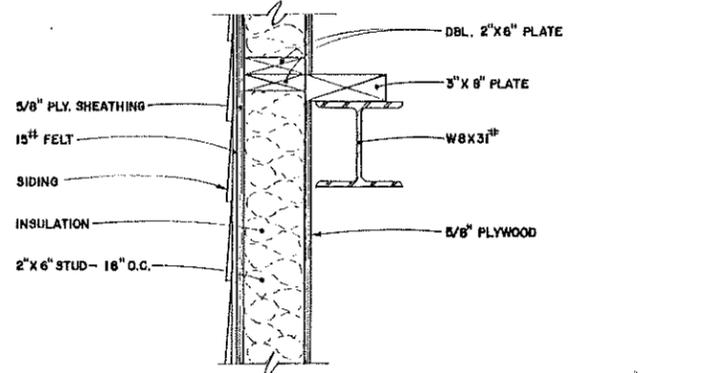

**WALL SECTION 3**  
1-1/2" = 1'-0" (3/13)

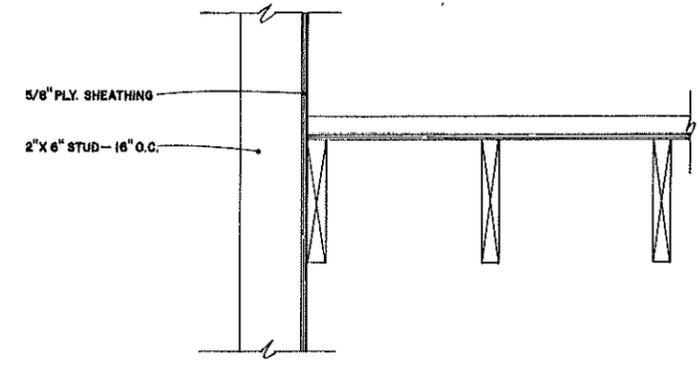



**WALL SECTION 6**  
1-1/2" = 1'-0" (6/13)



U.S. Department of Agriculture FOREST SERVICE		<b>McCALL SMOKEJUMPER BASE</b>	
Region 4	Engineering	PAYETTE NATIONAL FOREST	McCALL, IDAHO
DESIGN	BY W. MOFFETT	<b>PARALOFT BUILDING WALL SECTIONS</b>	
CHECK	B. CROCKETT		
DRAWN	BY G.W. GIBBONS	DRAWING NO.	270
CHECK	W. MOFFETT	13	31
APPROVED	<i>[Signature]</i>	DATE	6/18/86
TITLE	Act. Div. Engr.		


**PARALOFT BUILDING  
WINDOW SCHEDULE**

MARK	NO. REQD.	TYPE	ROUGH OPENING	HEAD	JAMB	SILL	MULLION	TRANSOM	NOTES
A	14	SEE WINDOW DIAGRAM	5'-10 7/8" X 4'-2 3/4"	1/15	2/15	3/15	16/15	14/15	PELLA CLAD AWNING WINDOW #3020 CA 22 W/ 3/8" MULLION REINFORCEMENT
B	7		5'-10 1/2" X 2'-1 3/4"	1/15	2/15	3/15	15/15		PELLA CLAD AWNING WINDOW #3020 CA 21
C	1		5'-10 1/2" X 4'-2 3/4"	1/15	2/15	3/15	15/15	14/15	PELLA CLAD AWNING WINDOW #3020 CA 21 PLUS #3020 CA 11 BELOW - SEE DIAGRAM
D	1		5'-10 1/2" X 4'-2 3/4"	1/15	2/15	3/15	15/15	14/15	PELLA CLAD AWNING WINDOW #3020 CA 21 PLUS #3020 CA 11 BELOW - SEE DIAGRAM
E	2		5'-10 7/8" X 4'-2 3/4"	7/15	8/15	9/15	16/15	14/15	PELLA CLAD AWNING WINDOW #3020 CA 22 W/ 3/8" MULLION REINFORCEMENT
F	2		5'-11 1/4" X 6'-3 3/4"	1/15	2/15	3/15	16/15	14/15	PELLA CLAD AWNING WINDOW #3020 CA 23 W/ 3/8" MULLION REINFORCEMENT
G	4		2'-11 1/2" X 2'-1 3/4"	1/15	2/15	3/15			PELLA CLAD AWNING WINDOW #3020 CA 11 WINDOW AT END OF HALL VENTED
H	8		3'-11 1/2" X 1'-9 3/4"	1/15	2/15	3/15			PELLA CLAD AWNING WINDOW #4216 CA 11 ALL UNITS W/REMOTE OPERATORS SEE (24)
I	4		6'-11 1/2" X 3'-11 3/4"	10/15	11/15	12/15	13/15		PELLA CLAD CASEMENT WINDOW #1642 CC-3642 CC-1642 CC
J	10		4'-5 1/2" X 2'-5 3/4"	4/15	5/15	6/15			PELLA CLAD AWNING WINDOW #4824 CA 11 6-UNITS W/REMOTE OPERATORS SEE (24)
K	4		1'-9" X 8'-0 3/4"	17/15	18/15	19/15			PELLA CLAD FRAME GLAZED W/ 1/4" LEXAN. SAND BLAST GLAZING TO FROSTED FINISH
L	1		2'-3" X 7'-0 3/4"	17/15	18/15	19/15			PELLA CLAD FRAME GLAZED W/ DOUBLE GLAZED CLEAR GLASS
M	1		5'-10 1/2" X 2'-1 3/4"	20/15	21/15	22/15			PELLA CLAD FRAME - LOUVER L-3 MOUNTED IN FRAME - SEE SHEET M-4
N	3		4'-2" X 3'-10"	23/15	24/15	25/15			SINGLE GLAZING SET IN OAK FRAME
O	1		7'-2" X 7'-2 1/4"	23/15	24/15	25/15			REAR SCREEN PROJECTION GLAZING - SEE SPEC.
P	2		7'-0 1/2" X VARIES (SEE WINDOW DIAGRAM)	17/15	18/15	19/15			PELLA CLAD FRAME GLAZED W/ 1/4" LEXAN. SAND BLAST GLAZING TO A FROSTED FINISH

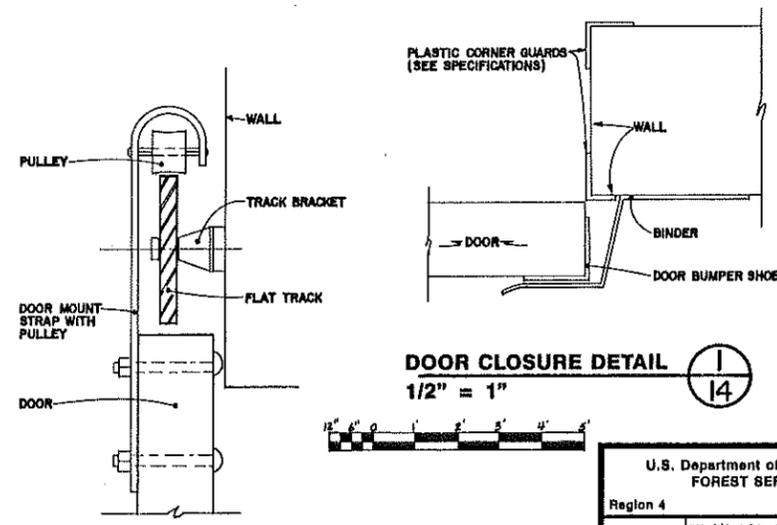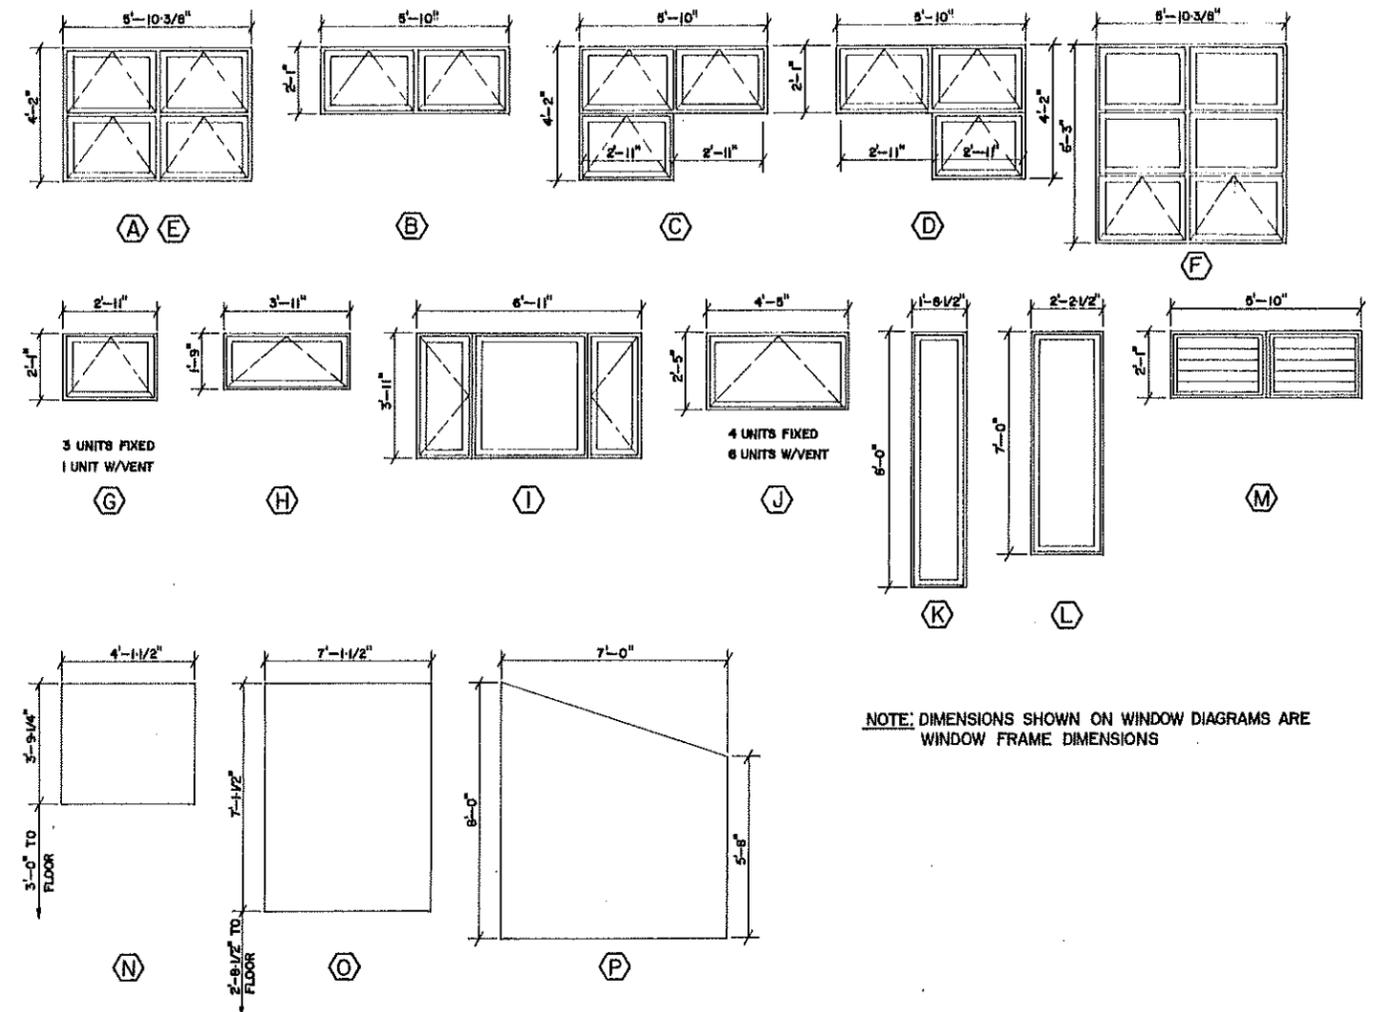


**DOOR TRACK DETAIL** (2/14)  
1/2" = 1"

U.S. Department of Agriculture FOREST SERVICE		<b>McCALL SMOKEJUMPER BASE</b>	
Region 4	Engineering	PAYETTE NATIONAL FOREST McCALL, IDAHO	
DESIGN	BY W. MOFFETT CHECK B. CROCKETT	<b>PARALOFT BUILDING WINDOW DETAILS</b>	
DRAWN	BY G.W. GIBBONS CHECK W. MOFFETT	DRAWING NO.	270
APPROVED	W. MOFFETT	14	31
TITLE	Act. Dir. Engr.	DATE	6/18/86

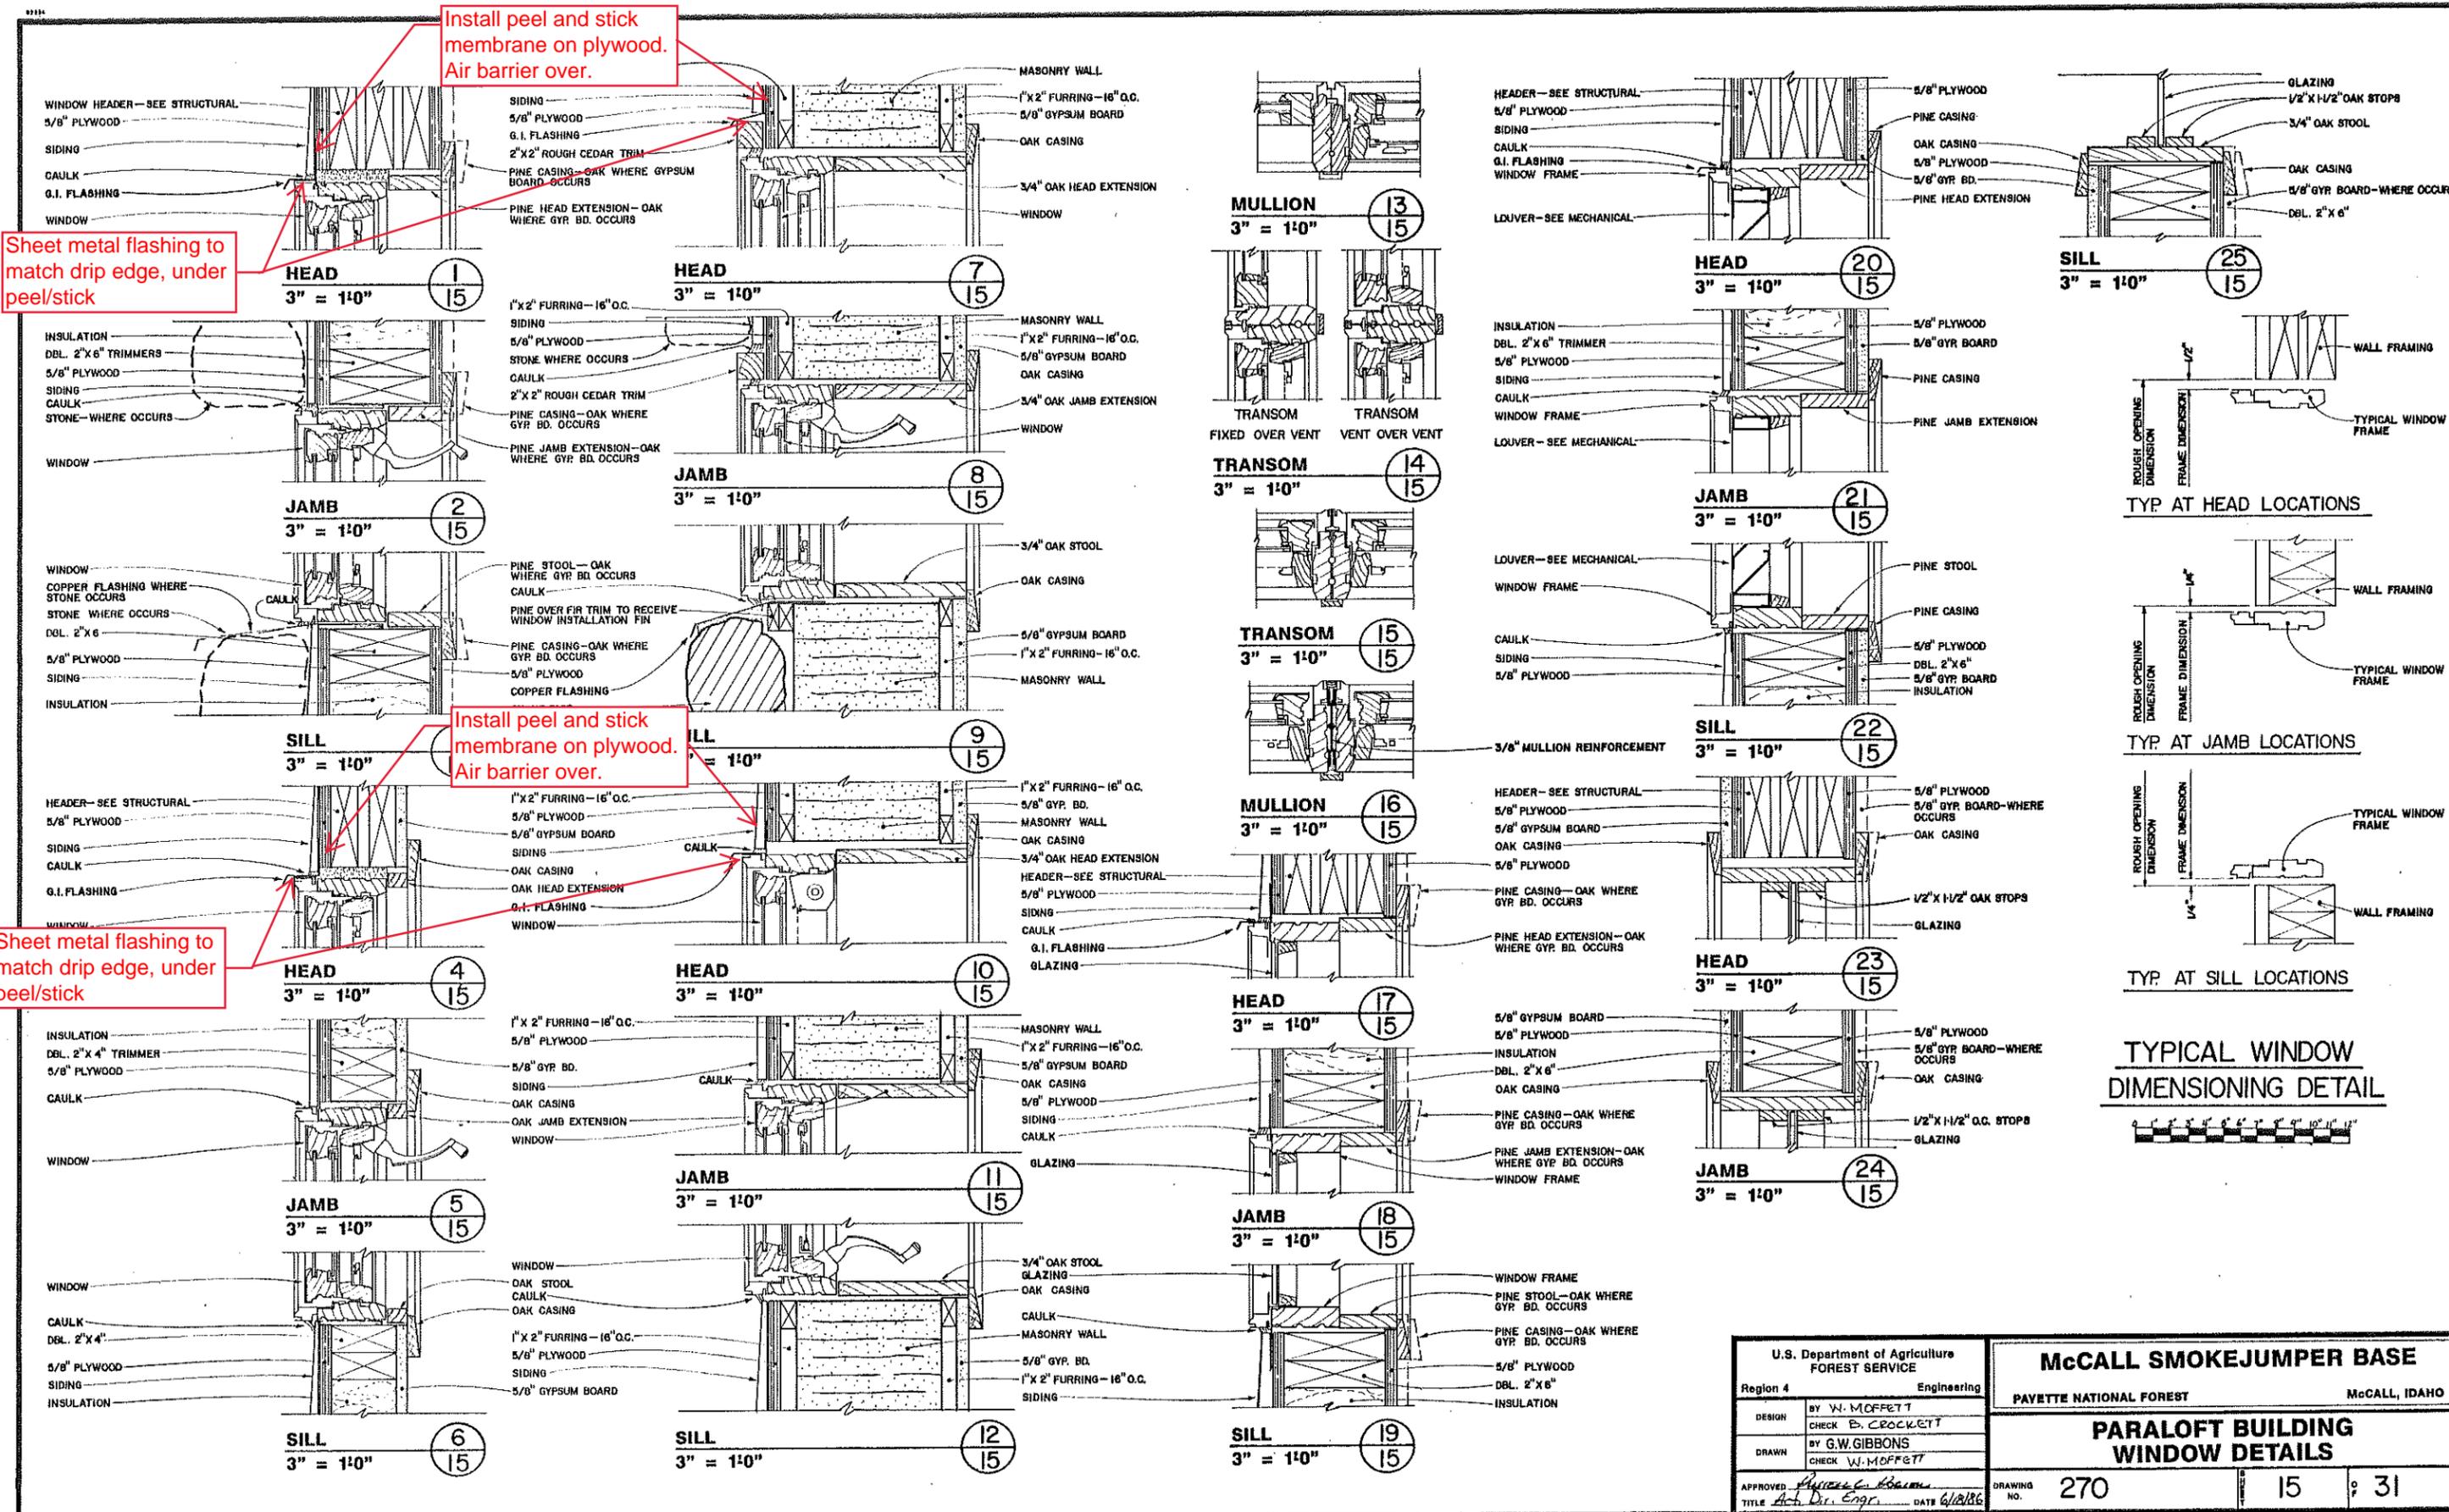


DOOR SCHEDULE								
MARK	DOOR SIZE	DOOR MATERIAL	DOOR TYPE	HEAD	JAMB	THRESH.	HARDWARE GROUP	NOTES
1	12'-0" X 10'-0" X 2"	INSULATED METAL	I	1	2	3	1	OVERHEAD DOOR
2	12'-0" X 10'-0" X 2"	INSULATED METAL	I	1	2	3	1	OVERHEAD DOOR
3	PR. 3'-0" X 6'-8" X 1-3/4"	INSULATED METAL	II	4	6	6	2	
4	3'-0" X 6'-8" X 1-3/4"	INSULATED METAL	III	7	8	6	3	
5	3'-0" X 6'-8" X 1-3/4"	INSULATED METAL	V	—	—	6	3	IN HOLLOW METAL FRAME W/SIDELIGHT, SEE 16
6	3'-0" X 6'-8" X 1-3/4"	INSULATED METAL	III	9	10	6	4	
7	6'-0" X 6'-8" X 1-3/4"	STEEL	VI	2	1	—	5	
8	6'-0" X 6'-8" X 1-3/4"	STEEL	VI	2	1	—	5	
9	6'-0" X 6'-8" X 1-3/4"	STEEL	VI	2	1	—	5	
10	4'-0" X 6'-8" X 1-3/4"	STEEL	III	11	12	—	6	
11	PR. 3'-0" X 6'-8" X 1-3/4"	STEEL	II	15	16	—	7	
12	3'-0" X 6'-8" X 1-3/4"	S.C. OAK	IV	11	12	—	6	
13	3'-0" X 6'-8" X 1-3/4"	S.C. OAK	III	11	12	—	6	
14	3'-0" X 6'-8" X 1-3/4"	S.C. OAK	IV	13	14	—	6	
15	3'-0" X 6'-8" X 1-3/4"	S.C. OAK	IV	13	14	—	6	
16	3'-0" X 6'-8" X 1-3/4"	S.C. OAK	IV	17	18	—	8	
17	3'-0" X 6'-8" X 1-3/4"	S.C. OAK	IV	17	18	—	8	
18	3'-0" X 6'-8" X 1-3/4"	S.C. OAK	IV	13	14	—	6	
19	3'-0" X 6'-8" X 1-3/4"	S.C. OAK	IV	15	16	—	6	
20	3'-0" X 6'-8" X 1-3/4"	S.C. OAK	IV	15	16	—	9	
21	3'-0" X 6'-8" X 1-3/4"	S.C. OAK	IV	15	16	—	9	
22	3'-0" X 6'-8" X 1-3/4"	S.C. OAK	IV	15	16	—	9	
23	3'-0" X 6'-8" X 1-3/4"	S.C. OAK	IV	19	20	21	10	POCKET DOOR-LATCH SIDE JAMB 29
24	4'-0" X 6'-8" X 1-3/4"	S.C. OAK	IV	11	12	—	6	
25	3'-0" X 6'-8" X 1-3/4"	S.C. OAK	IV	13	14	—	6	
26	3'-0" X 6'-8" X 1-3/4"	INSULATED METAL	V	15	16	—	6	
27	3'-0" X 6'-8" X 1-3/4"	INSULATED METAL	V	13	14	—	6	
28	3'-0" X 6'-8" X 1-3/4"	S.C. OAK	IV	22	23	24	6	
29	3'-0" X 6'-8" X 1-3/4"	S.C. OAK	IV	22	23	24	6	
30	3'-0" X 6'-8" X 1-3/4"	S.C. OAK	III	13	14	—	11	
31	3'-0" X 6'-8" X 1-3/4"	S.C. OAK	IV	17	18	9	8	
32	3'-0" X 6'-8" X 1-3/4"	S.C. OAK	IV	17	18	9	8	
33	3'-0" X 6'-8" X 1-3/4"	S.C. OAK	IV	15	16	—	11	
34	3'-0" X 6'-8" X 1-3/4"	S.C. OAK	III	13	14	—	11	
35	3'-0" X 6'-8" X 1-3/4"	S.C. OAK	III	13	14	—	11	
36	3'-0" X 6'-8" X 1-3/4"	S.C. OAK	III	15	16	—	11	
37	3'-0" X 6'-8" X 1-3/4"	S.C. OAK	III	13	14	—	11	
38	3'-0" X 6'-8" X 1-3/4"	S.C. OAK	IV	15	16	—	6	
39	3'-0" X 6'-8" X 1-3/4"	S.C. OAK	IV	15	16	—	6	
40	2'-8" X 6'-8" X 1-3/4"	S.C. OAK	IV	15	16	—	6	
41	3'-0" X 6'-8" X 1-3/4"	S.C. OAK	IV	15	16	—	6	
42	THREE— 5'-1" X 8'-2" X 1-3/4"	CUSTOM WOOD	VII	2	2	3	12	CUSTOM BUILT SEE— 2/16 & 3/16
43	THREE— 5'-1" X 8'-2" X 1-3/4"	CUSTOM WOOD	VII	2	2	3	12	CUSTOM BUILT SEE— 2/16 & 3/16
44	37'-7/8" X 9'-10-3/8" VERIFY SIZE AT SITE	FOLDING PANELS		1	2	4	—	SEE FOLDING PARTITION SPECIFICATION

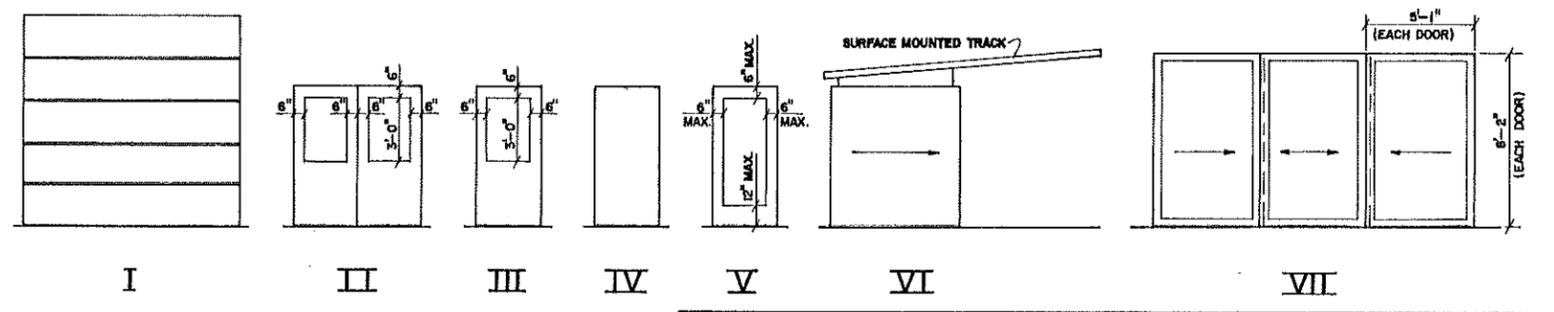


HARDWARE SCHEDULE							
HARDWARE GROUP	QUANTITY PER DOOR	ITEM	MANUFACTURER	QUANTITY PER DOOR	ITEM	MANUFACTURER	
1	1 EA.	CYLINDER 20-022 612 MK BALANCE BY DOOR SUPPLIER	A	9	1/2 PR. 1 EA. 1 EA.	HINGES BB 1279 4-1/2" X 4-1/2" USIO LOCKSET D53PD ORBIT 612 MK STOP 302TB USIO	B A D
2	3 PR. 1 EA. 2 EA. 1 EA. 1 SET 2 EA.	HINGES BB1191 4-1/2" X 4-1/2" USIO NRP LOCKSET L9553P X 42 612 MK CLOSER P8504 DBL FLUSHBOLTS 1358-12 USIO THRESHOLD 171B WEATHERSTRIP S88D DOOR BOTTOM 307B STOPS 302ES USIO	B A C D E E D	10	1 EA. 1 EA.	POCKET DOOR FRAME 2826 PULL 100 USIO	H D
3	1/2 PR. 1 EA. 1 EA. 1 EA. 1 EA. 1 SET 1 EA. 1 EA.	HINGES BB1191 4-1/2" X 4-1/2" USIO NRP EXIT DEVICE 99TP USIO CYLINDER 20-022 612 MK CLOSER P8504 DBL THRESHOLD 171B WEATHERSTRIP S88D DOOR BOTTOM 307B STOP 302ES USIO	B F A C E E D	12	4 PCS 8 EA. 2 EA. 9 EA. 2 EA. 3 EA. 3 EA.	TRACK X2641-8'-0" BRACKETS X2651-T END CAPS X2641-EC HANGERS X2650 DOOR STOPS 1231 PULLS 2689-10	H H H H H H
4	1/2 PR. 1 EA. 1 EA. 1 EA. 1 EA.	HINGES BB1191 4-1/2" X 4-1/2" USIO NRP LOCKSET L9553P X 42 612 MK CLOSER P8504 DBL THRESHOLD 171B DOOR BOTTOM 307B STOP 302TB USIO	B A C E E D				
5	1 EA. 1 SET	FIRE DOOR #647 HARDWARE FOR FIRE DOOR #2102	G G				
6	1/2 PR. 1 EA. 1 EA. 1 EA.	HINGES BB1279 4-1/2" X 4-1/2" USIO LOCKSET D53PD ORBIT 612 MK CLOSER 8504 DBL STOP 302TB USIO	B A C D				
7	3 PR. 1 EA. 2 EA. 2 EA.	HINGES BB1279 4-1/2" X 4-1/2" USIO LOCKSET D53PD ORBIT 612 MK CLOSERS 8503 DBL FLUSHBOLTS 1358-12 USIO STOPS 302TB USIO	B A C D D				
8	1/2 PR. 1 EA. 1 EA. 1 EA. 1 EA. 1 EA. 1 EA.	HINGES BB1279 4-1/2" X 4-1/2" USIO CLOSER 8503 DBL PUSH 40 3-1/2" X 15" USIO PULL 1510 3-1/2" X 15" USIO KICKPLATE 10" X 2" LDW USIO STOP 302TB USIO SIGN-MEN OR WOMEN-PLASTIC	B C D D D D D				

**MANUFACTURERS:**  
A— SCHLAGE  
B— HAGER  
C— NORTON  
D— QUALITY  
E— PEMKO  
F— VON DUPRIN  
G— RICHARDS-WILCOX  
H— STANLEY

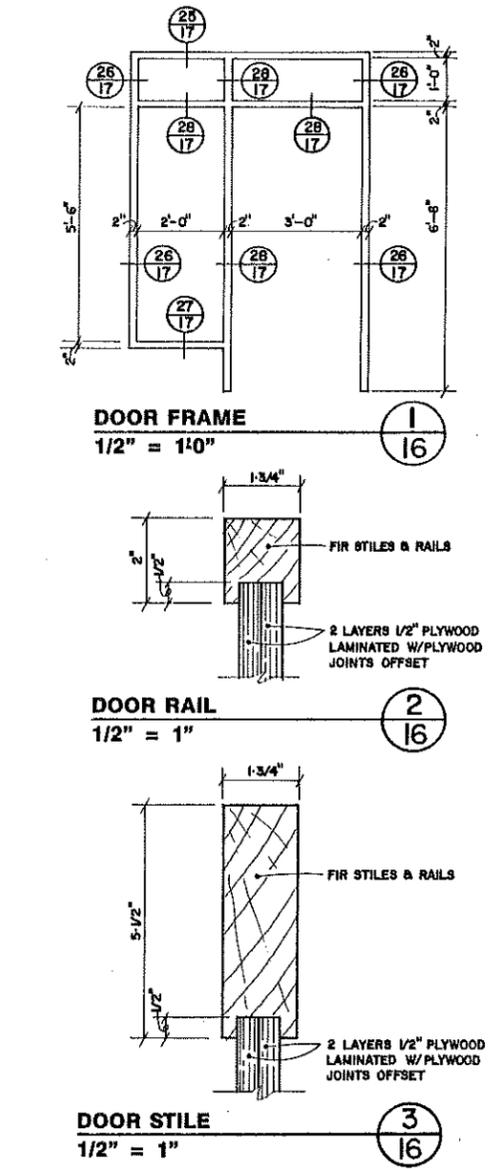

U.S. Department of Agriculture  
FOREST SERVICE  
Region 4 Engineering  
DESIGN BY W. MOFFETT  
CHECK B. CROCKETT  
DRAWN BY G. W. GIBBONS  
CHECK W. MOFFETT  
APPROVED [Signature]  
TITLE [Signature] DATE 6/18/86

**McCALL SMOKEJUMPER BASE**  
PAYETTE NATIONAL FOREST McCALL, IDAHO  
**PARALOFT BUILDING**  
**DOOR & HARDWARE SCHEDULE**  
DRAWING NO. 270 16 31

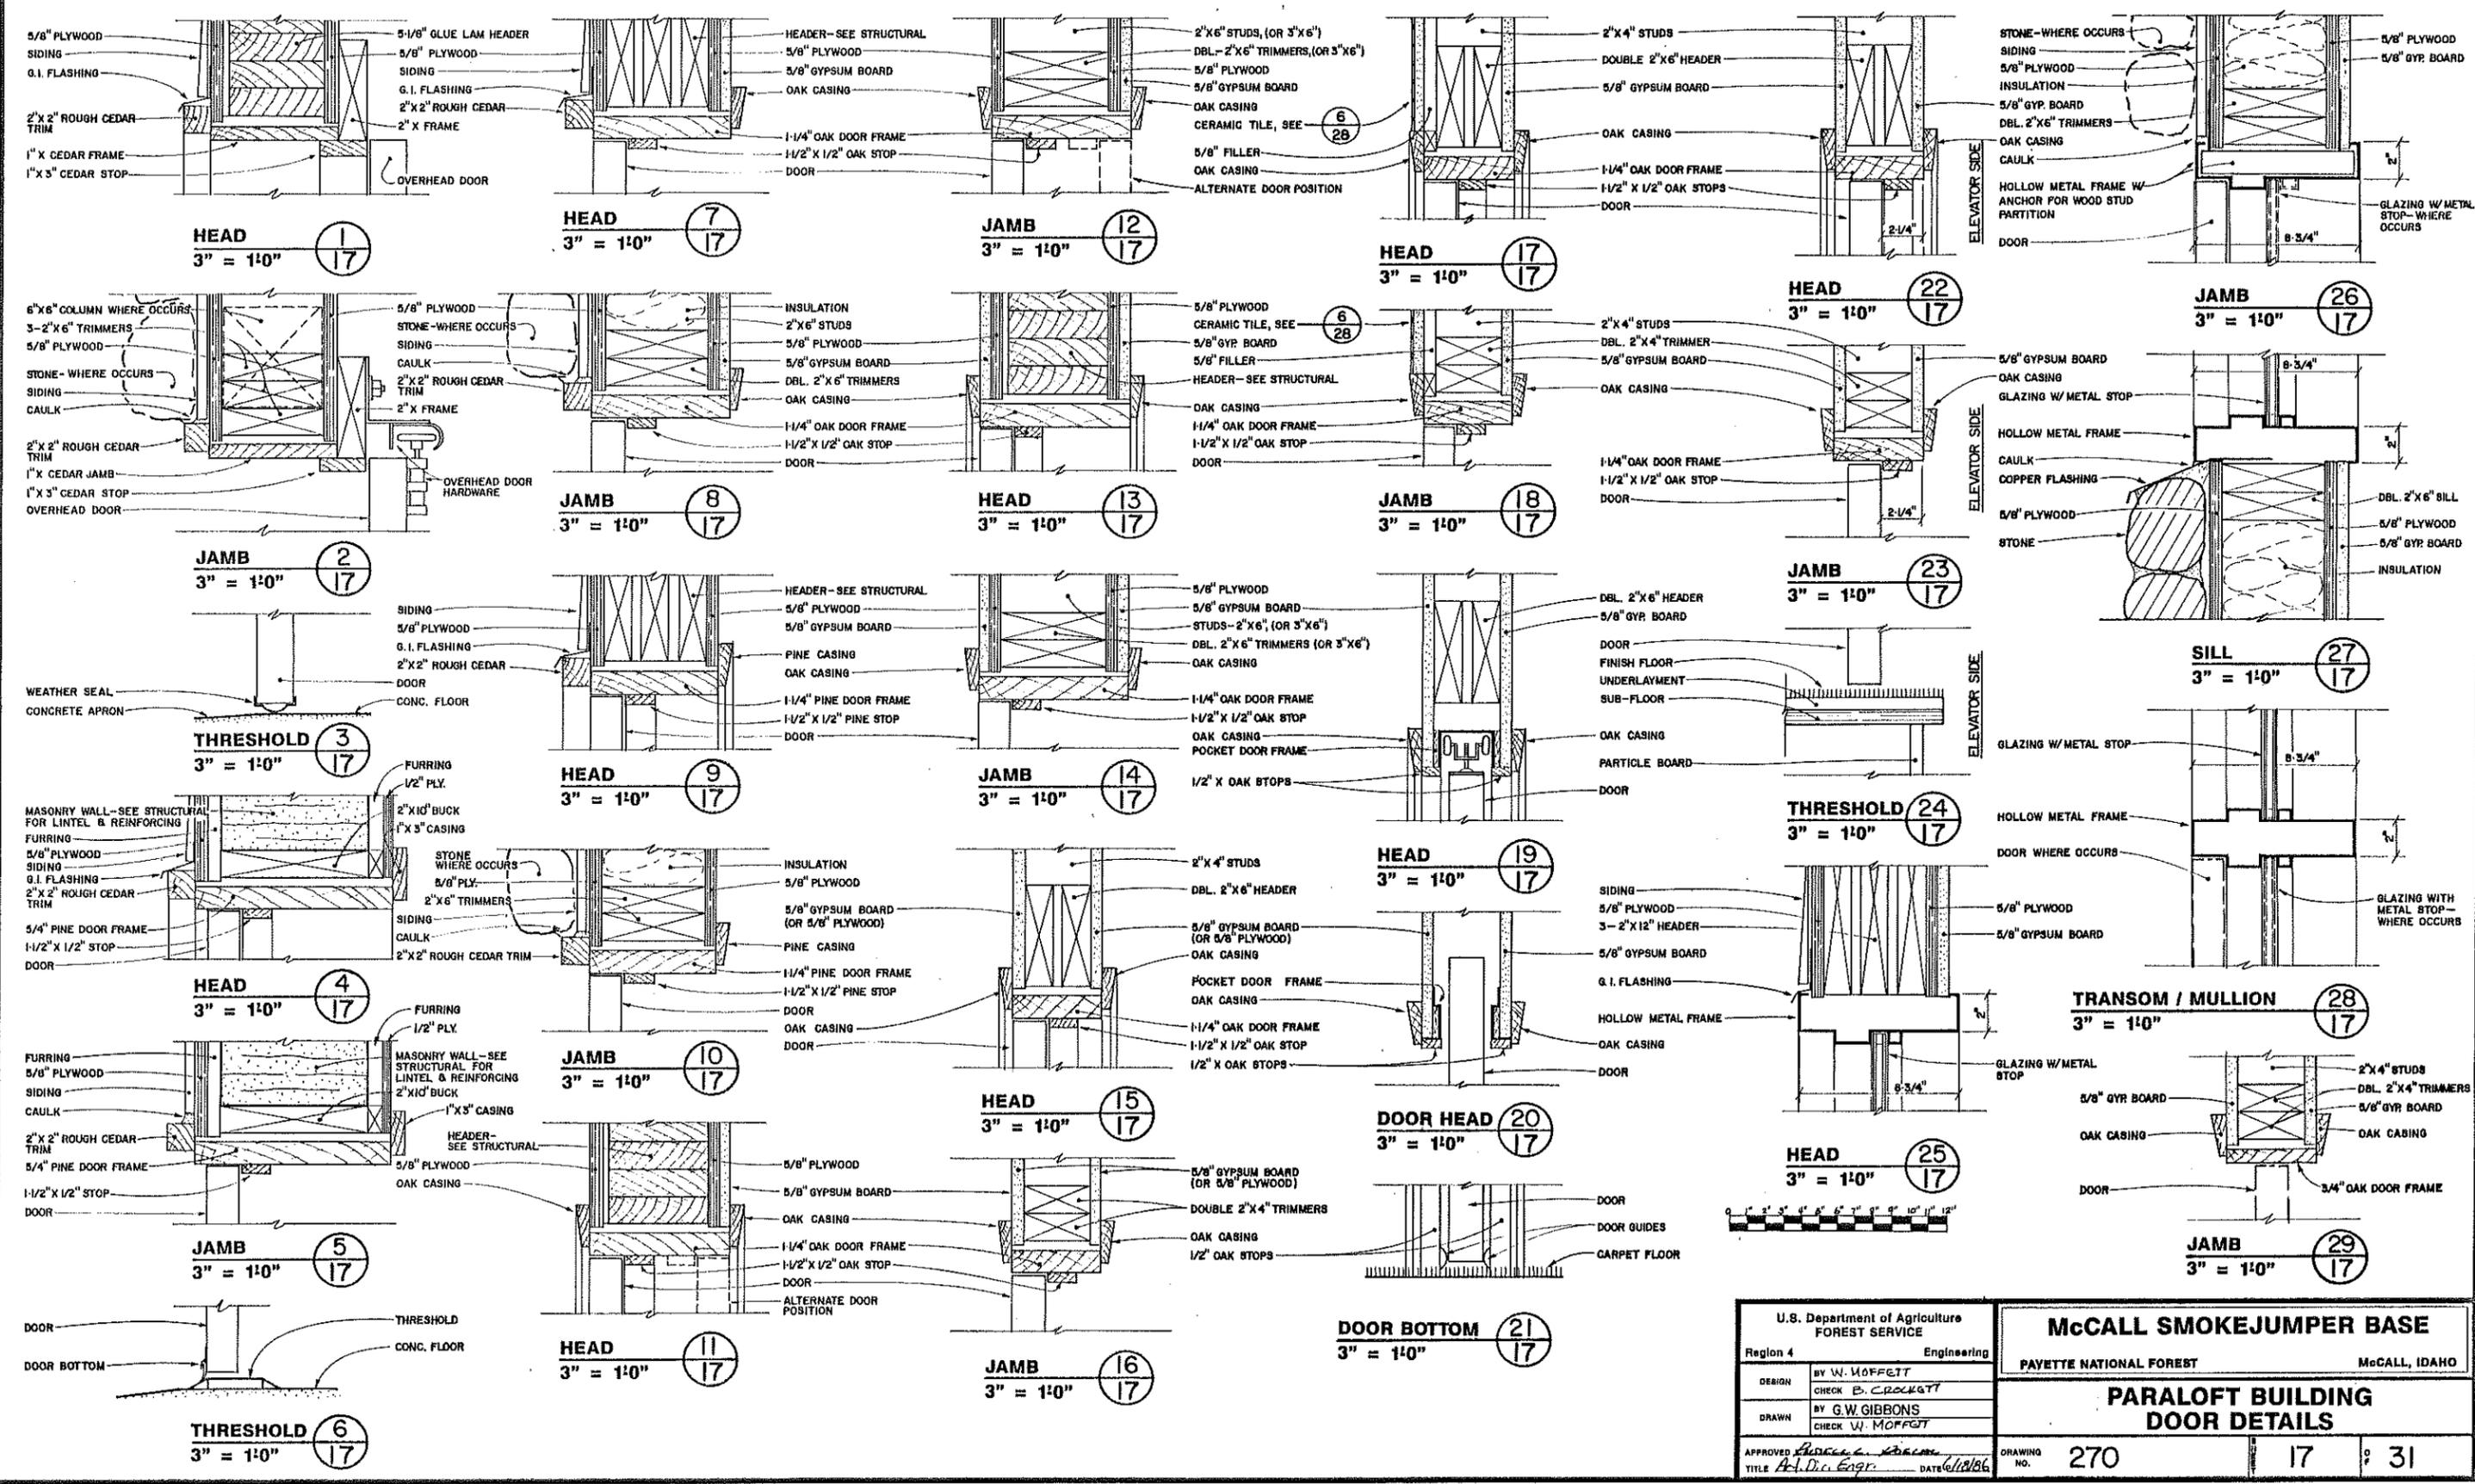

U.S. Department of Agriculture FOREST SERVICE		<b>McCALL SMOKEJUMPER BASE</b>	
Region 4	Engineering	PAYETTE NATIONAL FOREST McCALL, IDAHO	
DESIGN	BY W. MOFFETT	<b>PARALOFT BUILDING DOOR DETAILS</b>	
CHECK	B. CROCKETT		
DRAWN	BY G.W. GIBBONS	APPROVED	DATE 6/10/86
CHECK	W. MOFFETT	TITLE	DATE
DRAWING NO. 270		17 : 31	