



**US Army Corps  
of Engineers**  
Louisville District

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# **Solicitation For**

**Repair Aircraft Maintenance B1455 for  
MH-139, Maxwell AFB, AL**

**P2: 496395**

**Design-Bid-Build**

**Specifications - SID  
Certified Final Design**

**29 December 2022  
W912QR23R0003**

**ARIMS: 200A  
Disposition: Maintain for 15yrs after construction**

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MAXWELL AIR FORCE BASE, ALABAMA  
REPAIR AIRCRAFT MAINTENANCE B1455 FOR  
MH-139  
PROJECT NUMBER: PNQS21B1455, P2#: 496395

DESIGNER OF RECORD:  
JACOBS  
777 MAIN STREET, FORT WORTH, TX 76102  
CONTACT: JERI CHAMPINE

### STRUCTURAL INTERIOR DESIGN

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# FY21 Repair Aircraft Maintenance B1455 For MH-139 Maxwell AFB, AL

PREPARED BY: Mabelle Above  
DATE: November 23, 2022  
SUBJECT: Interior Design Narrative

## Codes, Standards, and Regulations

- ANSI/BIFMA Safety and Performance Standards for Furniture (2011)
- ASTM D 2047; Test for Slip Resistance of Hard Surfaces
- ETL 07-4 – Air Force Carpet Standard
- NFPA 260 – Methods of Tests and Classification System for Cigarette Ignition Resistance of Components (2009)
- NFPA 261 – Method of Test for Determining Resistance of Mock-up Upholstered Furniture Material Assemblies to Ignition by Smoldering Cigarettes (2009)
- NFPA 705 – Field Flame Test for Textiles and Films
- UFC 3-120-01 – Design, Sign Standards, with Change 3, 12 Dec 2017
- UFC 3-120-10 – Interior Design (2018)
- Wyzenbeek Abrasion Resistance Test
- Air Force Reserve Command Handbook 32-1001

## General

This project involves the renovation of the Repair Aircraft Maintenance Hanger, B1455 located at Maxwell Air force Base, AL. Included in the renovation is the existing hanger administration spaces. Additionally, the project includes a newly constructed admin space with supporting classrooms, mission planning space, administrative areas, and other support spaces.

## Comprehensive Interior Design

The Comprehensive Interior Design (CID) package includes Structural Interior Design (SID) and Furniture, Fixture & Equipment (FF&E). The goal of the CID is to provide a functional, durable, visually appealing facility to enhance the User's working environment. Finishes in the SID and FF&E package are coordinated to create a unified, cohesive facility.

## Structural Interior Design

Structural interior design includes all building finishes, built-in casework, window coverings, and signage.

Administrative and training areas will receive carpet tile flooring with resilient base, painted gypsum board walls, and acoustical ceiling tile.

Corridors will receive LVT flooring and resilient base. Walls are a light neutral color. Corridor ceilings have a combination of high NRC white acoustical tile with a few painted gypsum board soffits.

Wall protection will include corner guards at all outside corners throughout the facility.

Window shades are used throughout the facility except at entry vestibules and corridors.

Restrooms will receive porcelain tile flooring and walls, metal cove base, and moisture resistant painted gypsum board ceilings. Toilet compartments will be durable solid core phenolic. Lavatories will have solid surface countertops with a removable plastic laminate apron panel.

The break room will receive LVT flooring and resilient base, painted gypsum board walls, and acoustical ceiling tile. Casework will be plastic laminate with solid surface countertops and porcelain mosaic tile backsplash.

Simulator areas will have epoxy flooring and utility areas such as electrical/ mechanical rooms will have sealed concrete floors, resilient base, painted gypsum board walls, and painted open structure above. The telecommunication room will have the same finishes except with static control flooring. Janitor's closets will have sealed concrete flooring with resilient base, a water-resistant wainscot with paint above, and painted open structure ceilings.


## Furniture, Fixtures, & Equipment (Bid Option)

FF&E for this project is a bid option and includes freestanding modular desk systems, systems furniture with powered and non-powered panels, storage, seating, and tables. All desks and workstations will have trash and recycle bins. Desks and workstations will have plastic laminate worksurfaces with painted metal storage units.

The General Contractor is responsible for all electrical connections from the FF&E to the building.

Government furnished equipment for this project includes break room appliances, flat screen TV monitors with wall brackets, and copiers/printers.



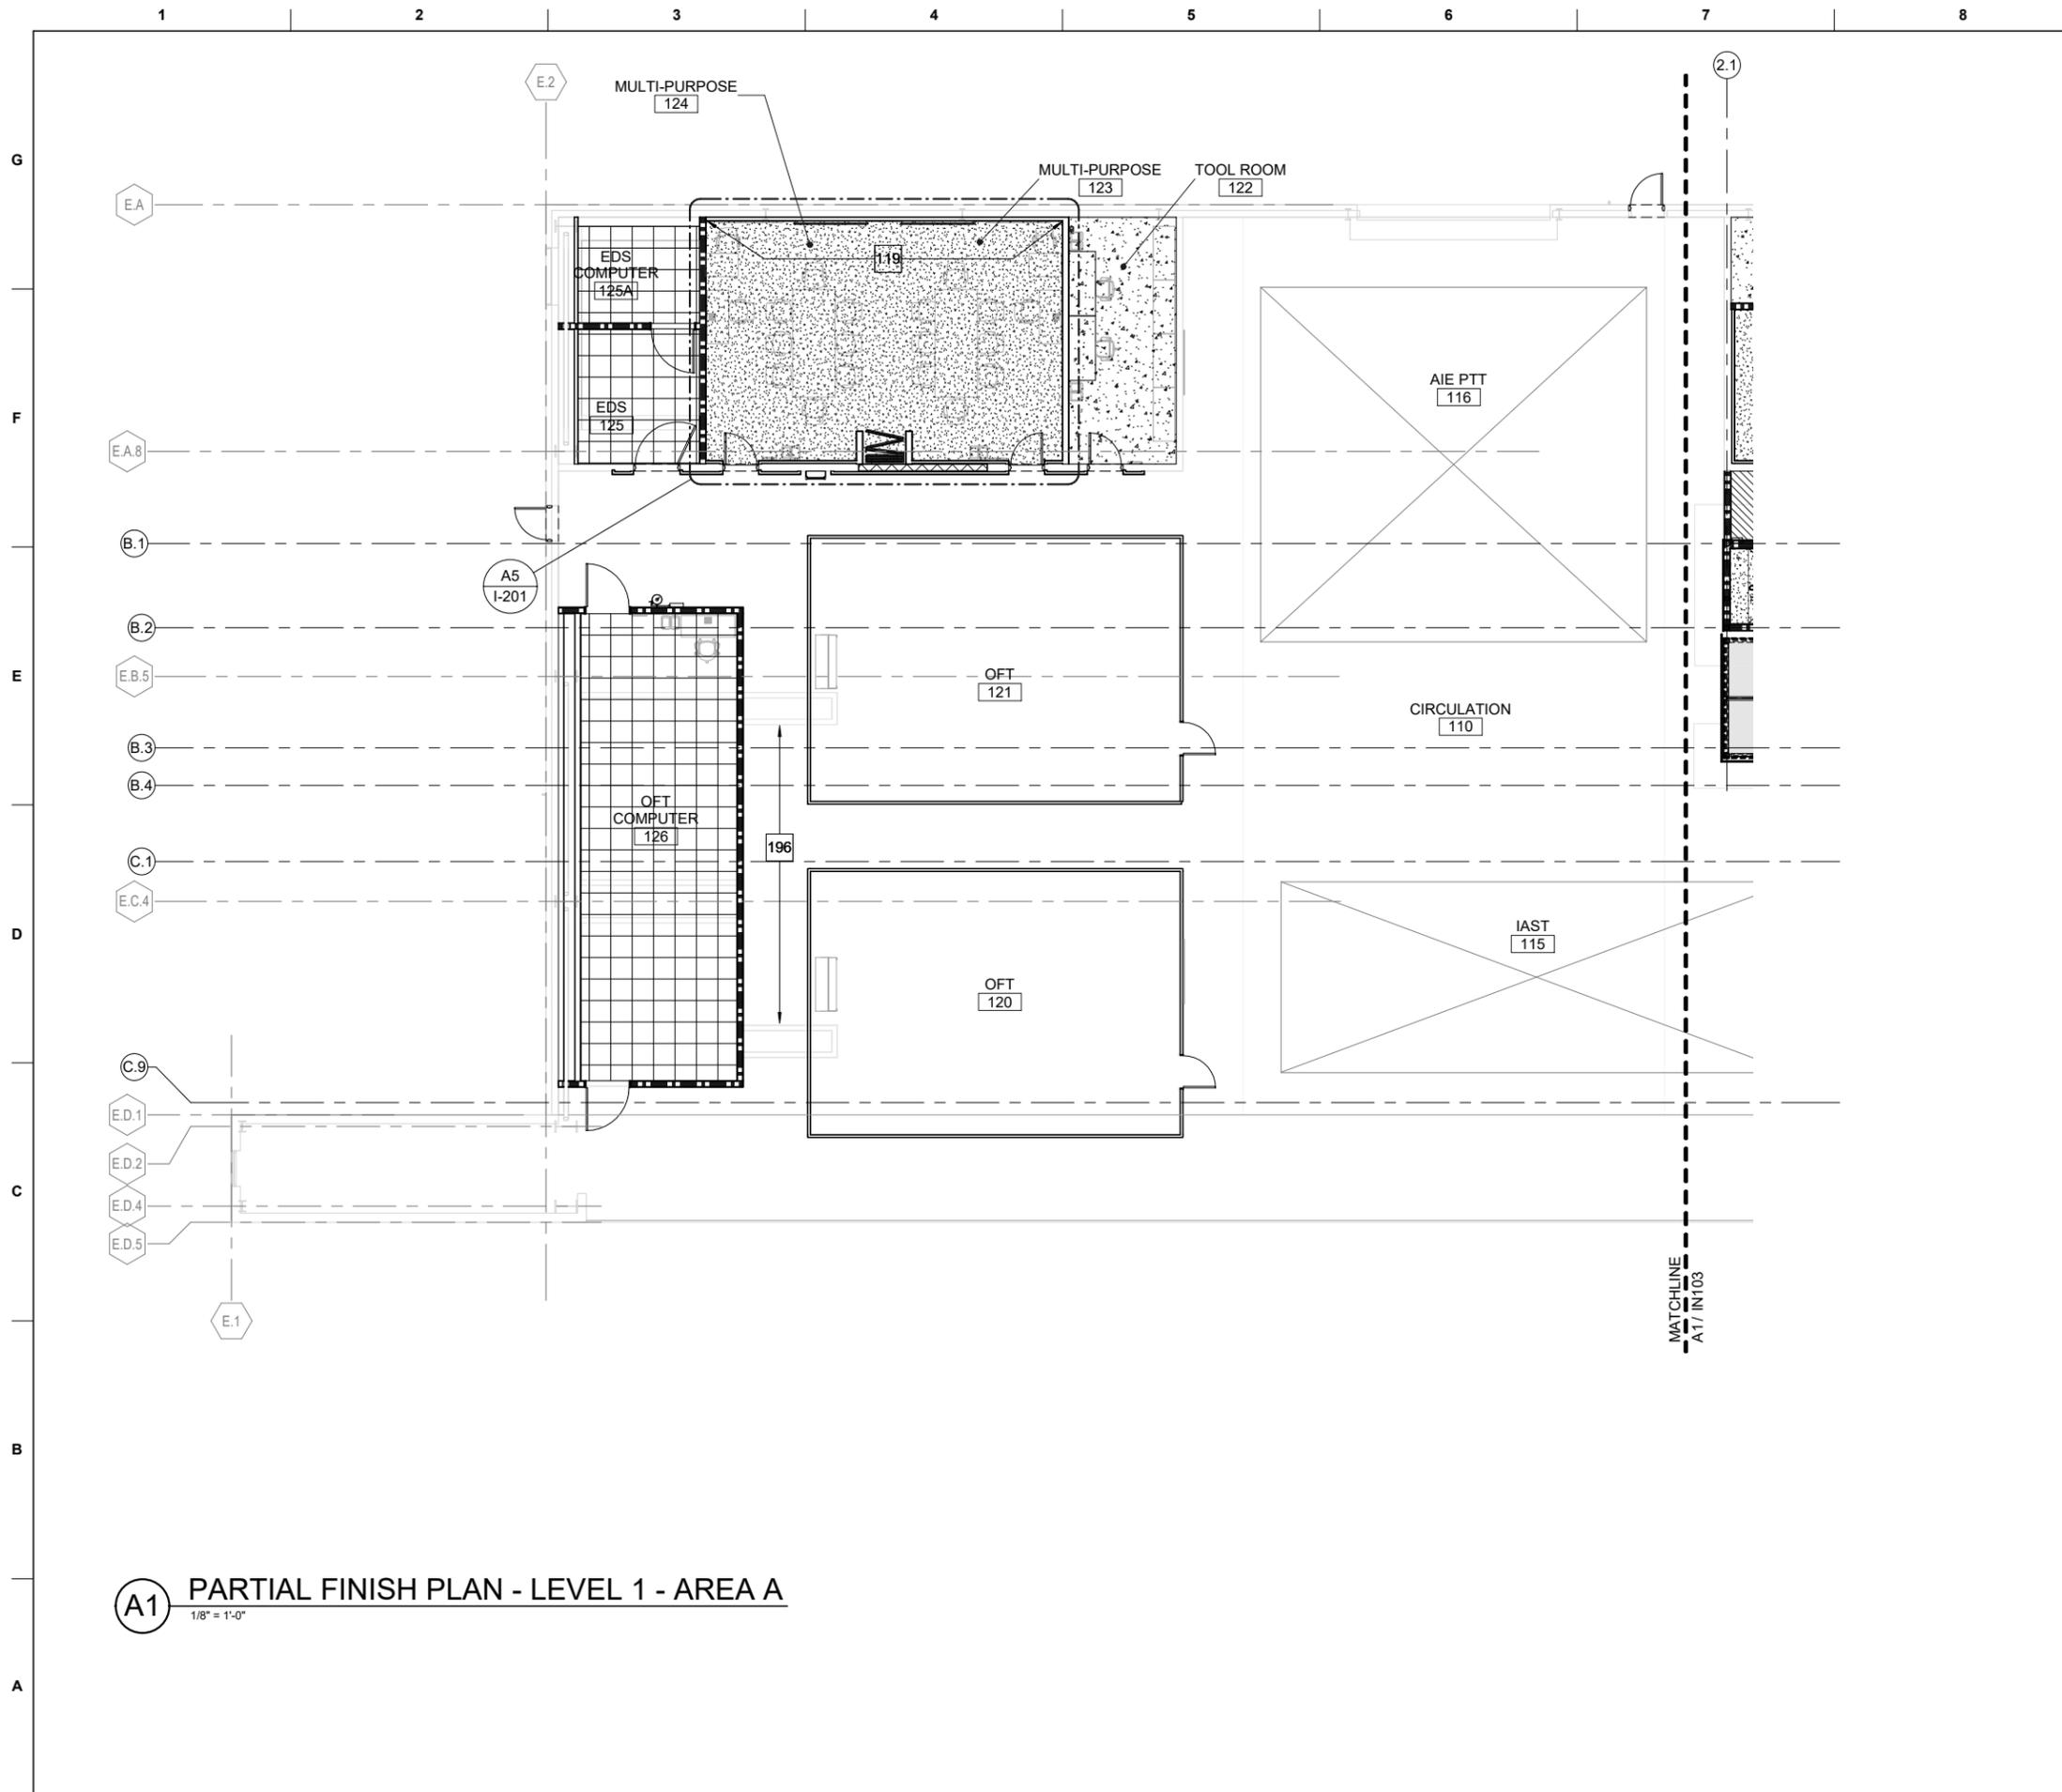

**GENERAL NOTES - FINISH PLANS**




- A FIELD VERIFY ALL DIMENSIONS PRIOR TO ORDERING MATERIALS/FINISHES.
- B REFER TO I-601 FOR FINISH LEGEND AND I-602 FOR ROOM FINISH SCHEDULE.
- C ALL TRANSITIONS ARE TO OCCUR AT THE CENTERLINE OF THE DOOR, DOORWAY OR CEILING LINE, UNLESS OTHERWISE NOTED.
- D REFER TO REFLECTED CEILING PLANS ON AE121 TO AE133 FOR ADDITIONAL INFORMATION.
- E APPLY BASE AS SPECIFIED ON ALL WALL TYPES.
- F CORNER GUARDS ARE REQUIRED ON ALL OUTSIDE CORNERS
- G PAINT EXISTING HANGAR WALLS PT-3

**KEYNOTES**

- 119 PAINT PT-2.
- 196 TRENCH - STEEL COVER PLATE

**FLOOR FINISH LEGEND**

	CPT-1
	CPT-2
	EXC-1
	LVT-1
	PFT-1
	SC-1
	SDT-1
	RAF-1
	RF-1

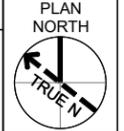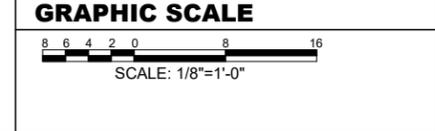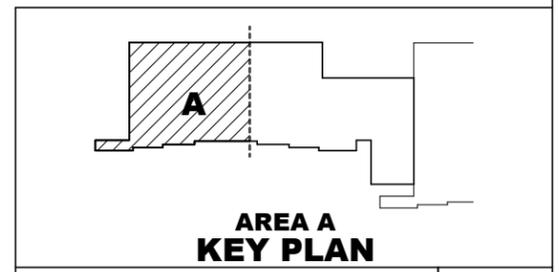

**US Army Corps of Engineers**  
Louisville District

STATE OF TEXAS  
MACHELL LARAE ABOVE  
10047  
REGISTERED  
INTERIOR DESIGNER  
TEXAS REGISTERED  
23 NOV 2022  
ENGINEERING FIRM F-2966

MARK	DESCRIPTION	DATE

DESIGNED BY: M. ABOVE  
DRAWN BY: J. WILSON  
CHECKED BY: S. LEBEAU  
SUBMITTED BY: E. OLNESS  
SIZE: ANS/D 22x34

ISSUE DATE: 23 NOV 2022  
SOLICITATION NO.:  
CONTRACT NO.:  
DRAWING CODE:

US ARMY CORPS OF ENGINEERS  
LOUISVILLE DISTRICT  
MAXWELL AIR FORCE BASE

**Jacobs**  
JACOBS ENGINEERING GROUP INC.  
777 JACOBSON BLVD  
JACOBS No. 1428513


MAXWELL AIR FORCE BASE, ALABAMA  
REPAIR AIRCRAFT MAINTENANCE B1455 FOR MH-139  
PROJECT NUMBER: PNGS21B1455, P2#: 496395  
PARTIAL FINISH PLAN - LEVEL 1 - AREA A

SHEET ID  
B1455  
IN102

**A1 PARTIAL FINISH PLAN - LEVEL 1 - AREA A**  
1/8" = 1'-0"





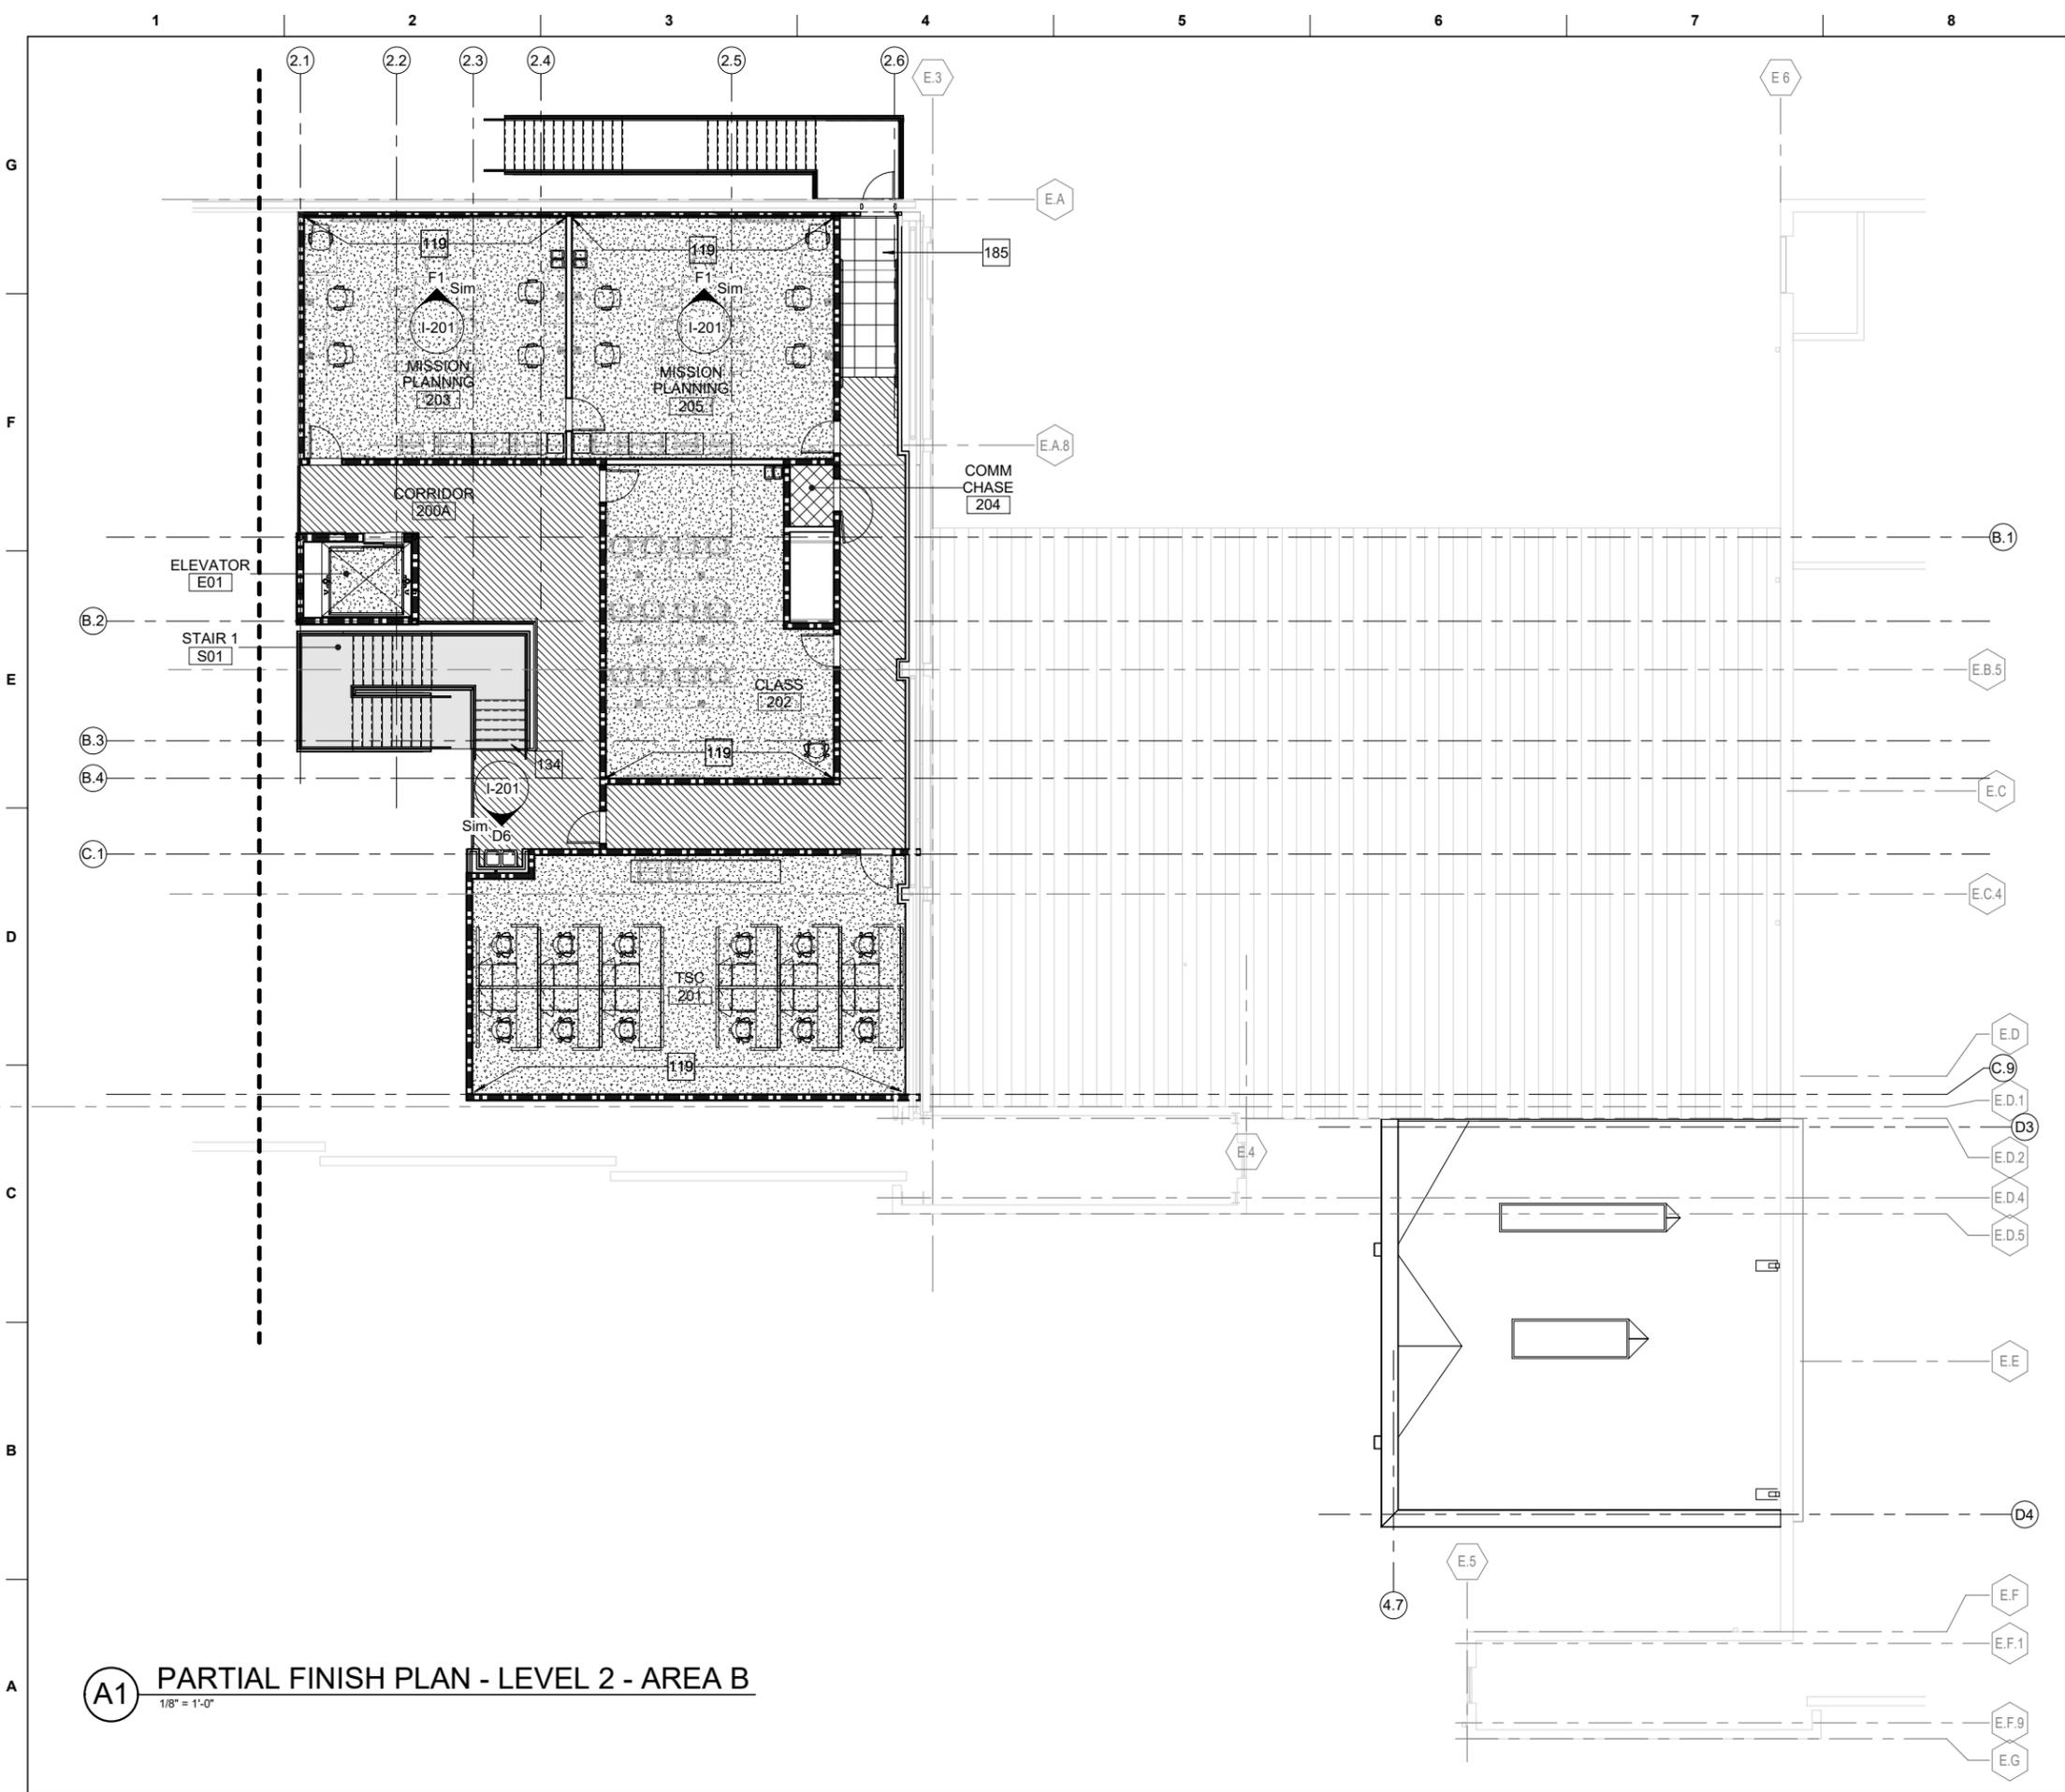

**(A1) PARTIAL FINISH PLAN - LEVEL 2 - AREA B**  
1/8" = 1'-0"

**GENERAL NOTES - FINISH PLANS**




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- F CORNER GUARDS ARE REQUIRED ON ALL OUTSIDE CORNERS
- G PAINT EXISTING HANGAR WALLS PT-3

**KEYNOTES**

119	PAINT PT-2.
134	STAIR TREADS/ RISERS RF-1. PAINT HANDRAILS PT-4.
185	RAF-1 FLOORING AT RAMP AND LANDING.

**FLOOR FINISH LEGEND**

	CPT-1
	CPT-2
	EXC-1
	LVT-1
	PFT-1
	SC-1
	SDT-1
	RAF-1
	RF-1

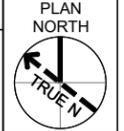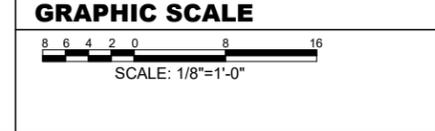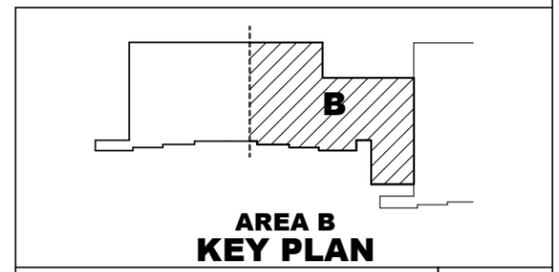

MARK	DESCRIPTION	DATE

DESIGNED BY: M. ABOVE	ISSUE DATE: 23 NOV 2022
DRAWN BY: S. LEBEAU	SOLICITATION NO.:
CHECKED BY: E. OLNESS	CONTRACT NO.:
SUBMITTED BY: E. OLNESS	DRAWING CODE:
FILE NAME: ANSI D 2234	FILE SIZE: 1282513


US ARMY CORPS OF ENGINEERS  
LOUISVILLE DISTRICT  
MAXWELL AIR FORCE BASE

**Jacobs**  
JACOBS ENGINEERING GROUP INC.  
7711 JACOBS BLVD  
JACOBS No. 1428513

MAXWELL AIR FORCE BASE, ALABAMA  
REPAIR AIRCRAFT MAINTENANCE B1455 FOR MH-139  
PROJECT NUMBER: PNGS21B1455, P2#: 496395  
PARTIAL FINISH PLAN - LEVEL 2 - AREA B

SHEET ID  
**B1455**  
**IN112**



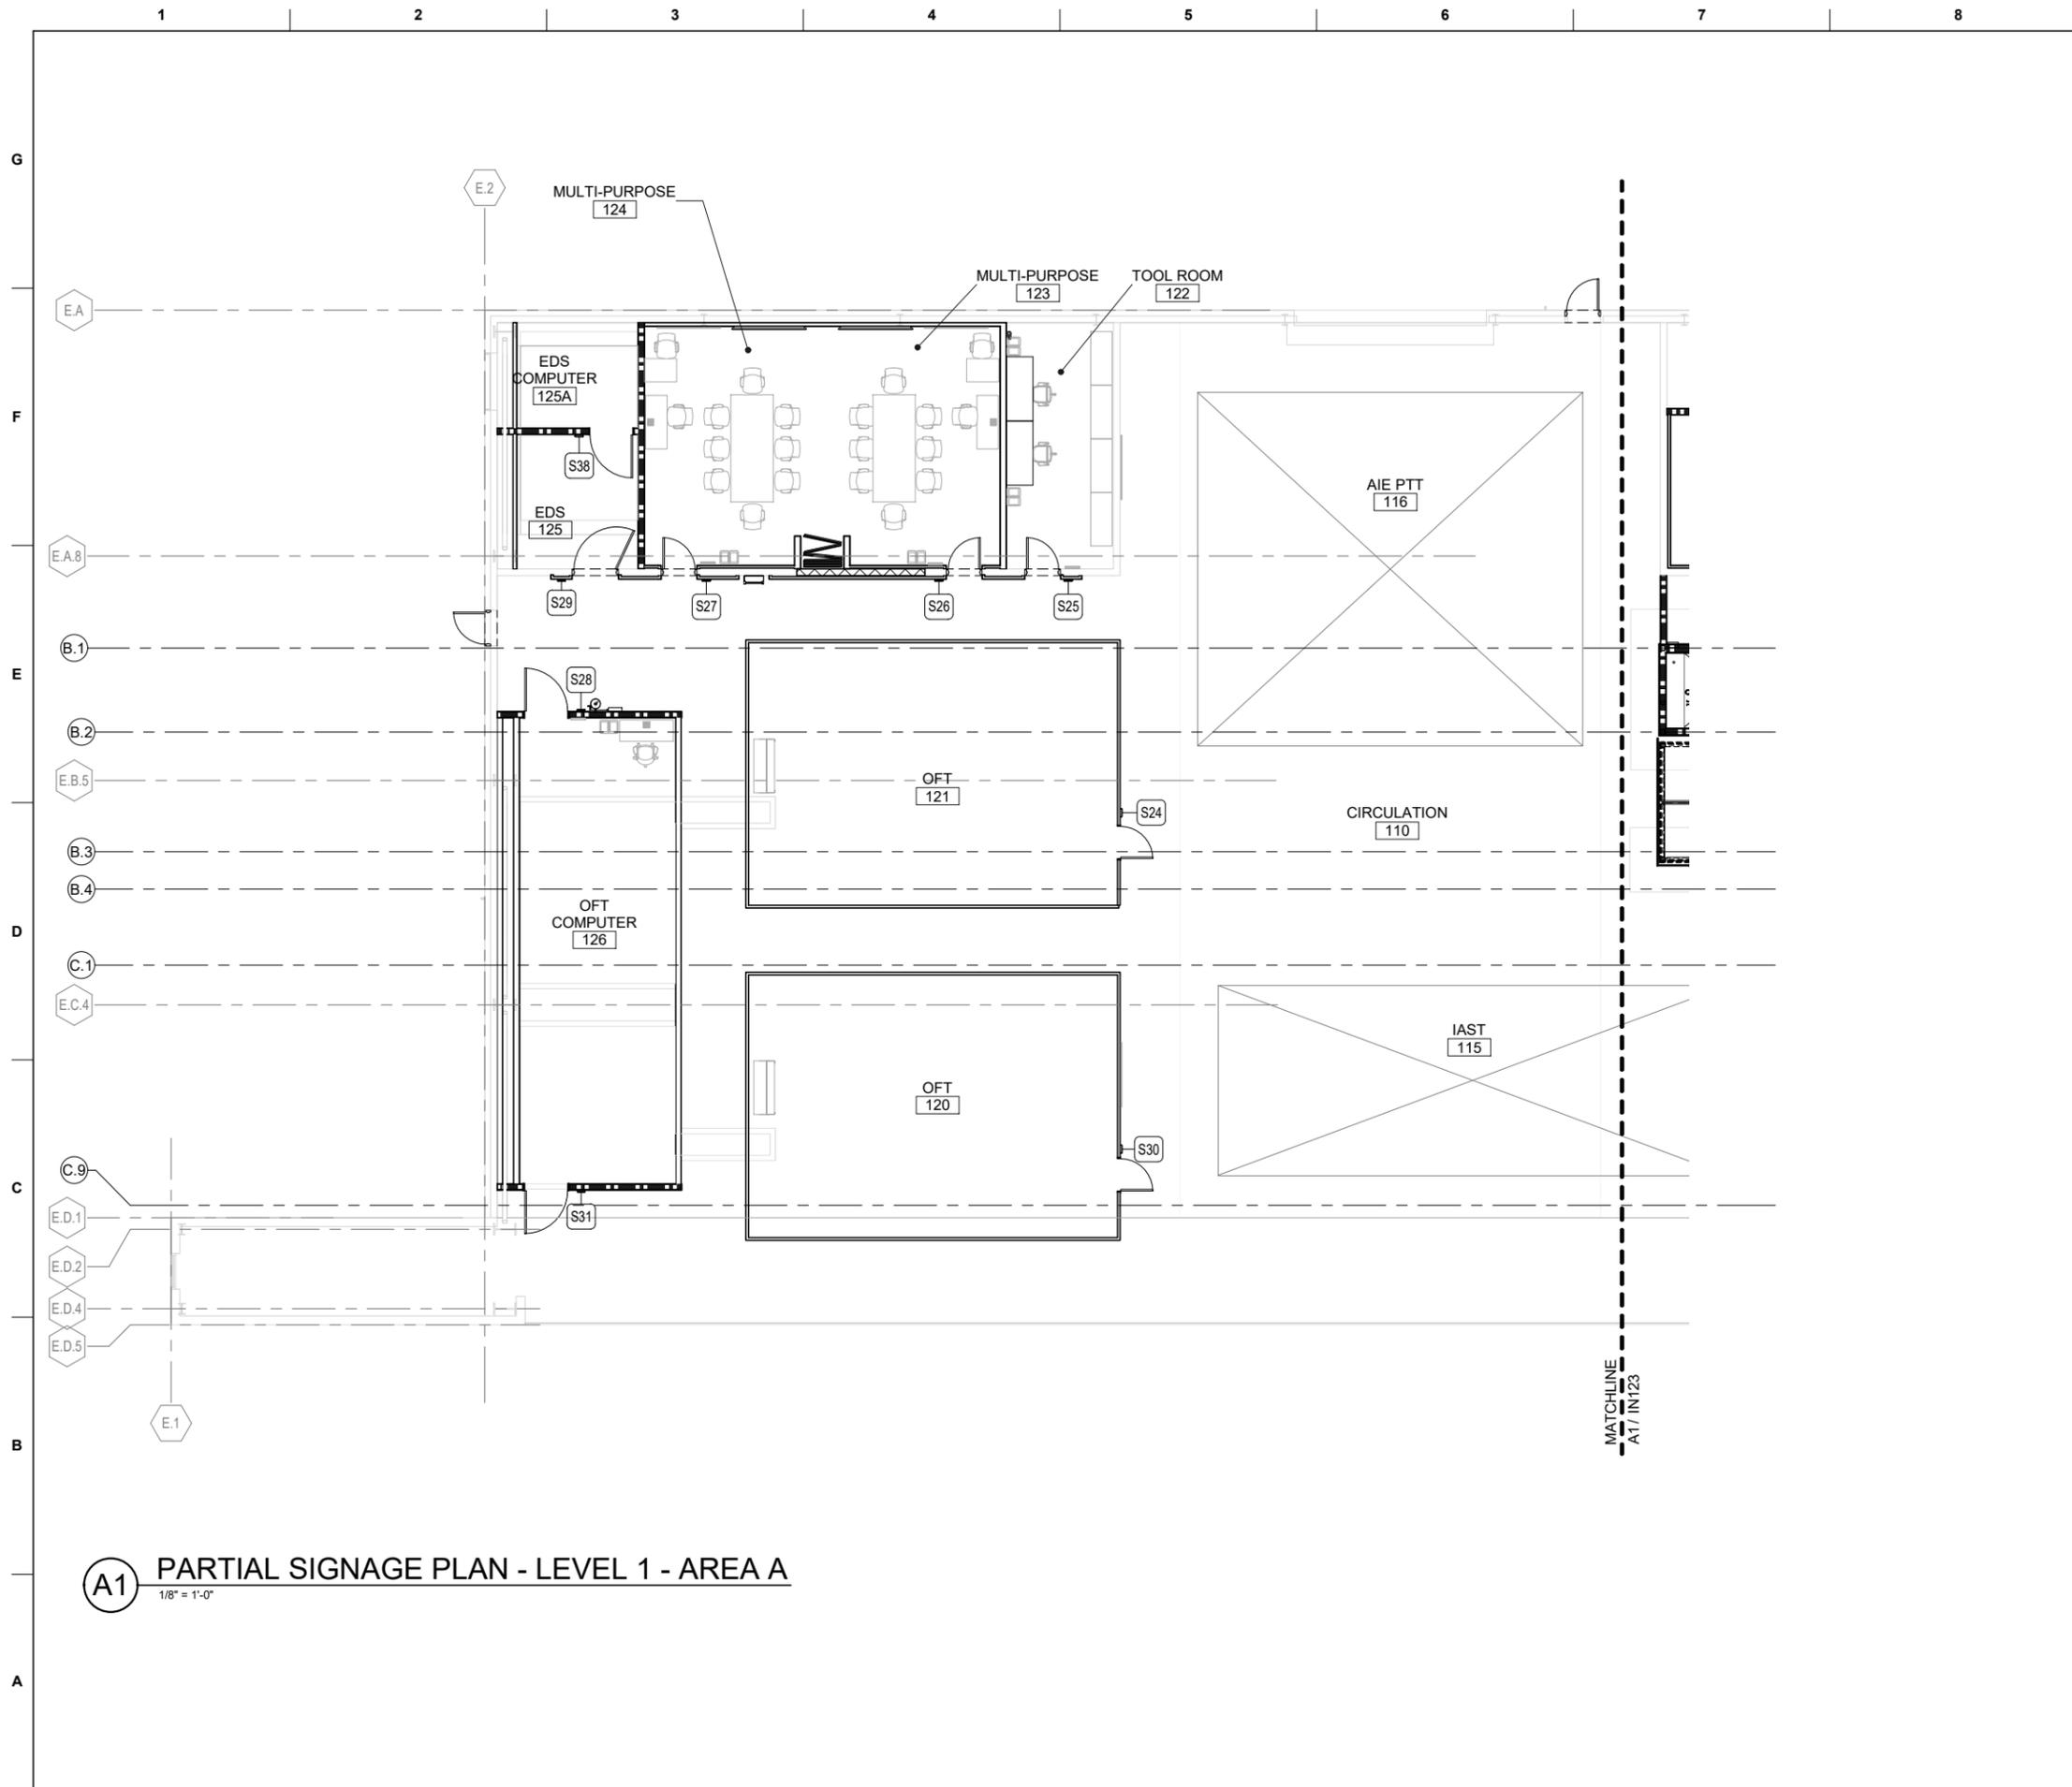

**(A1) PARTIAL SIGNAGE PLAN - LEVEL 1 - AREA A**  
 1/8" = 1'-0"

**GENERAL NOTES - SIGNAGE**

- A SIGNAGE LOCATION/PLACEMENT MUST MEET ABAAS REQUIREMENTS.
- B ALL SIGNAGE MUST COMPLY WITH UFC 3-120-01 STANDARDS.
- C ROOM NUMBERS SHOWN ON PLANS ARE FOR CONSTRUCTION PURPOSES, NOT NECESSARILY THE USER'S PREFERRED NUMBERING SYSTEM. COORDINATE ALL ROOM NUMBERS AND VERBIAGE FOR SIGNS WITH CONTRACTING OFFICER PRIOR TO FABRICATION.
- D ENSURE THAT ALL SIGN INSERTS CAN BE EASILY REMOVED/ REPLACED. CONSIDER INSTALLATION OF SIGNS IN TIGHT CORNERS AND ALCOVES/ SIDELIGHTS TO ENSURE THAT SIGN INSERT IS ACCESSIBLE.
- E MOUNT ALL LIKE-SIGNS AT SAME HEIGHT.
- F SIGNAGE IS INTENDED TO MATCH EXISTING. VERIFY EXISTING SIGNAGE TYPE AND BACKGROUND COLOR PRIOR TO ORDERING.

**SIGNAGE KEY**



**US Army Corps of Engineers**  
 Louisville District ®

STATE OF TEXAS  
 MACHELL LARAE ABOVE  
 10041  
 REGISTERED  
 INTERIOR DESIGNER  
 TEXAS REGISTERED  
 23 NOV 2022  
 ENGINEERING FIRM F-2966

MARK	DESCRIPTION	DATE

DESIGNED BY: M. ABOVE  
 DRAWN BY: J. WARD  
 CHECKED BY: S. LEBEAU  
 SUBMITTED BY: E. OLNESS  
 SIZE: ANS/D 22x34

ISSUE DATE: 23 NOV 2022  
 SOLICITATION NO.:  
 CONTRACT NO.:  
 DRAWING CODE:

FILE NAME: SXHT21920/IN122

**US ARMY CORPS OF ENGINEERS**  
 LOUISVILLE DISTRICT  
 MAXWELL AIR FORCE BASE

**Jacobs**  
 JACOBS ENGINEERING GROUP INC.  
 7711 JACOBS BLVD  
 SUITE 100  
 FORT WORTH, TX 76116

MAXWELL AIR FORCE BASE, ALABAMA  
 REPAIR AIRCRAFT MAINTENANCE B1455 FOR MH-139  
 PROJECT NUMBER: PNGS21B1455, P2#: 496395  
 PARTIAL SIGNAGE PLAN - LEVEL 1 - AREA A

**AREA A KEY PLAN**

**GRAPHIC SCALE**  
 8 6 4 2 0 8 16  
 SCALE: 1/8"=1'-0"

PLAN NORTH

SHEET ID  
**B1455**  
**IN122**














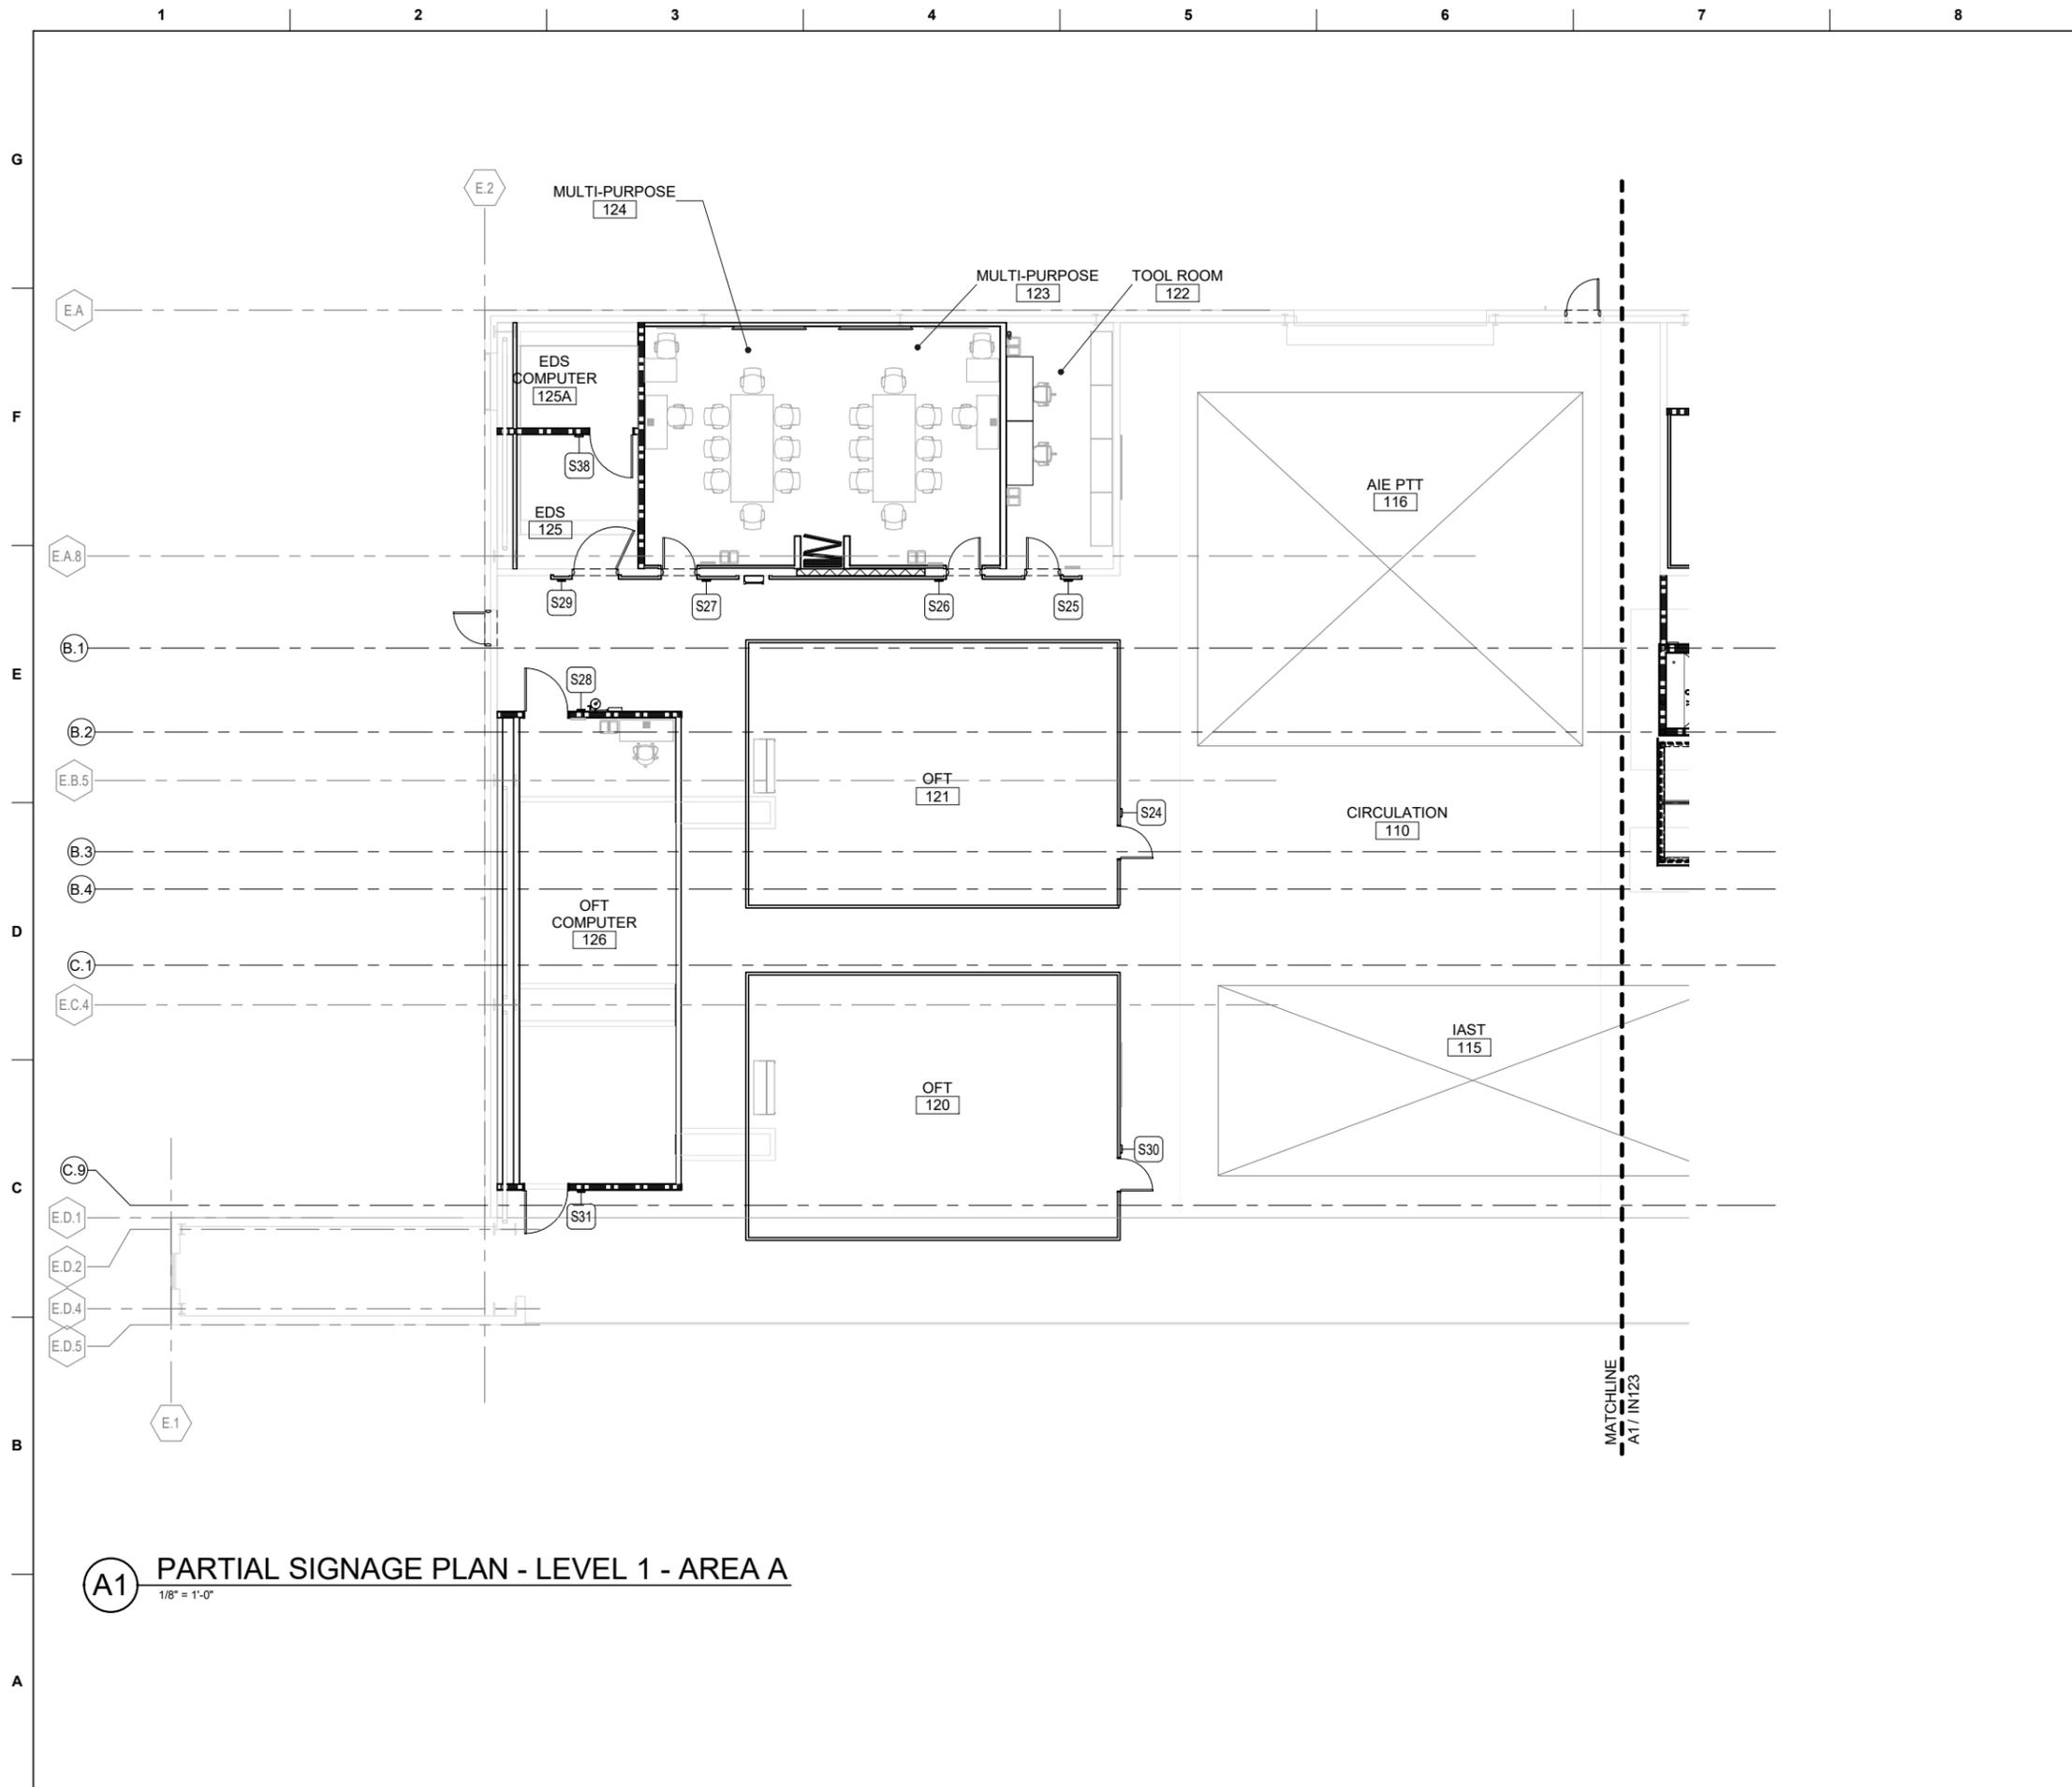

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**SIGNAGE KEY**



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US ARMY CORPS OF ENGINEERS  
 LOUISVILLE DISTRICT  
 MAXWELL AIR FORCE BASE

JACOBS ENGINEERING GROUP, INC.  
 7711 JACOBS DRIVE, SUITE 100  
 FORT WORTH, TEXAS 76114

MAXWELL AIR FORCE BASE, ALABAMA  
 REPAIR AIRCRAFT MAINTENANCE B1455 FOR MH-139  
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 PARTIAL SIGNAGE PLAN - LEVEL 1 - AREA A

**AREA A KEY PLAN**


**GRAPHIC SCALE**  
 SCALE: 1/8"=1'-0"

PLAN NORTH

SHEET ID  
**B1455**  
**IN122**





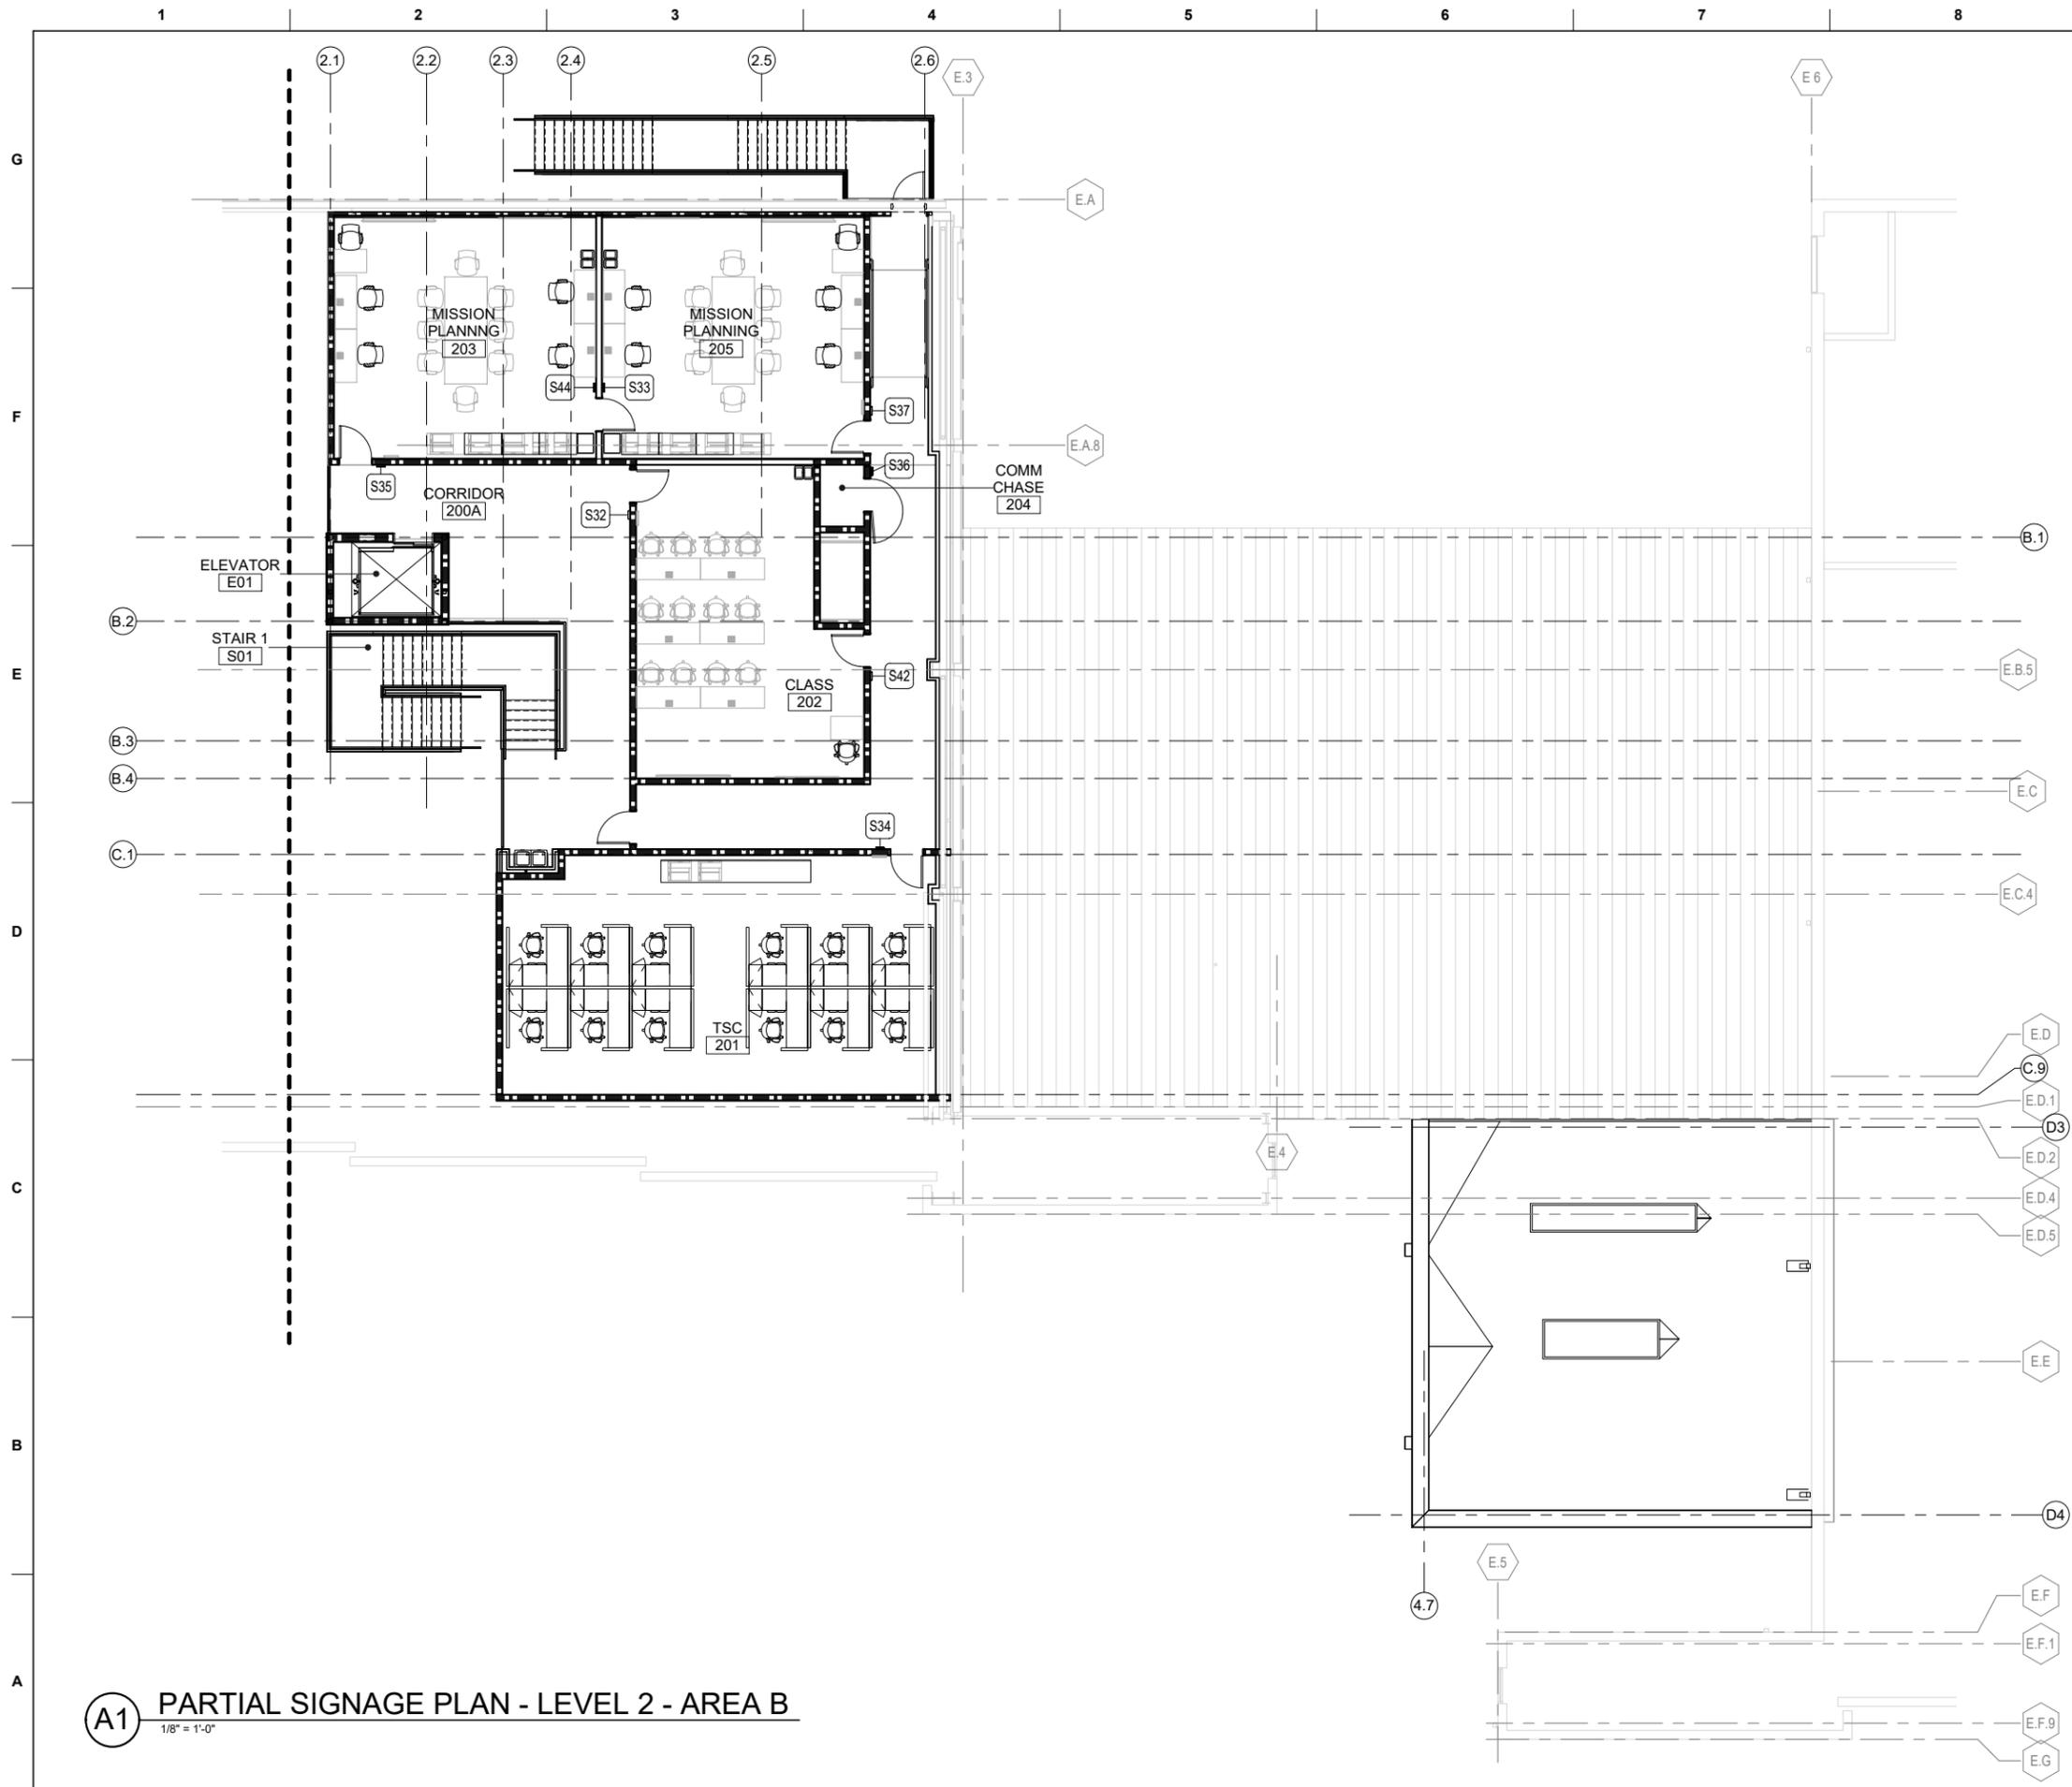


**A1 PARTIAL SIGNAGE PLAN - LEVEL 2 - AREA B**  
 1/8" = 1'-0"

**GENERAL NOTES - SIGNAGE**

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**SIGNAGE KEY**

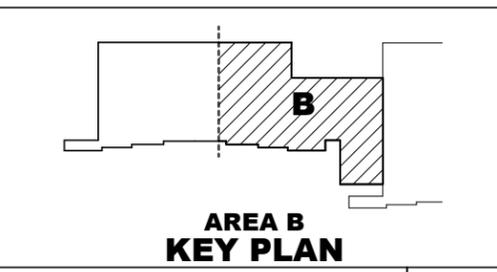

**GRAPHIC SCALE**  
 SCALE: 1/8"=1'-0"



WS 2022-01-23 SID-0000

US Army Corps of Engineers  
 Louisville District

MARK	DESCRIPTION	DATE

US ARMY CORPS OF ENGINEERS  
 LOUISVILLE DISTRICT  
 MAXWELL AIR FORCE BASE

DESIGNED BY: M. ABOVE  
 DRAWN BY: J. WARD  
 CHECKED BY: S. LEBEAU  
 SUBMITTED BY: E. OLNESS  
 SIZE: ANS/D 22x34


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 CONTRACT NO.:  
 DRAWING CODE:

FILE NAME: SXHT21920/IN132

JACOBS ENGINEERING GROUP, INC.  
 7711 JACOBS BLVD  
 JACOBS No. 1428513

MAXWELL AIR FORCE BASE, ALABAMA  
 REPAIR AIRCRAFT MAINTENANCE B1455 FOR MH-139  
 PROJECT NUMBER: PNGS21B1455, P2#-496395  
 PARTIAL SIGNAGE PLAN - LEVEL 2 - AREA B


SHEET ID  
 B1455  
 IN132

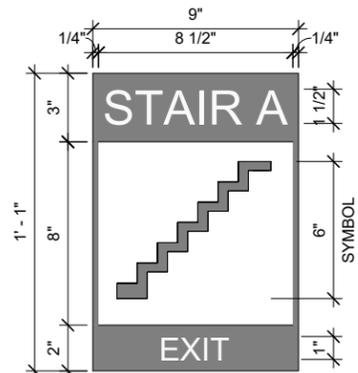

**STAIR DESIGNATION:** UPPER CASE HELVETICA NEUE 55 ROMAN, 1-1/2" CAPITAL LETTER HEIGHT, CENTERED, ACCOMPANIED BY GRADE TWO BRAILLE.


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**D8 STAIR IDENTIFICATION SIGN SS1A**  
3" = 1'-0"

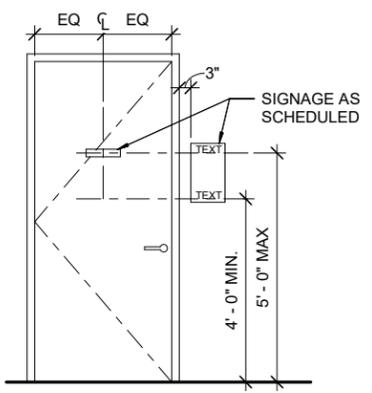

**STANDARD DOOR**  
MOUNTING HEIGHT RANGE FOR TACTILE CHARACTERS. DOOR MOUNTED SIGNS TO BE CENTERED ON DOOR WHERE APPLICABLE. ALL SIMILAR SIGN TYPES TO BE MOUNTED UNIFORMLY THROUGHOUT BUILDING.

**D1 TYP SIGNAGE MOUNTING DIAGRAM**  
1/2" = 1'-0"

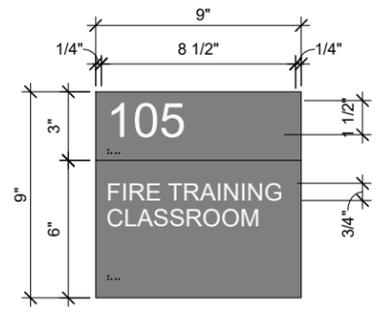


**ROOM NUMBER:** HELVETICA NEUE 55 ROMAN, 1-1/2" CAPITAL LETTER HEIGHT, FLUSH LEFT, TACTILE ROOM NUMBER ACCOMPANIED BY GRADE TWO BRAILLE

**ROOM NAME:** HELVETICA NEUE 55 ROMAN, 3/4" CAPITAL LETTER HEIGHT, FLUSH LEFT. TACTILE ROOM NAME WITH GRADE TWO BRAILLE.

SIGN SHALL HAVE WHITE LETTERS ON COLORED BACKGROUND.


**A1 PERMANENT ROOM IDENTIFICATION SIGN BB2A**  
3" = 1'-0"

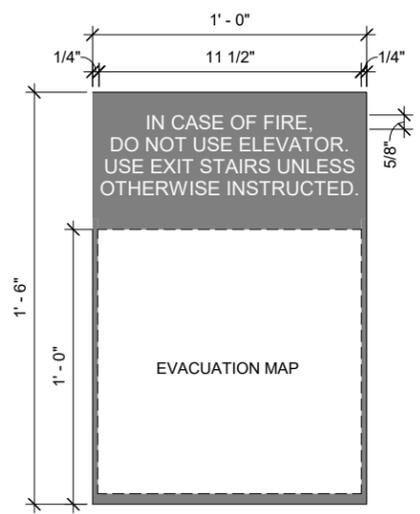

**TEXT:** HELVETICA NEUE 55 ROMAN, 5/8" CAPITAL LETTER HEIGHT, CENTERED

**INSERT:** REPLACABLE EVACUATION MAP


**D3 ELEVATOR EGRESS SIGN DD2**  
3" = 1'-0"

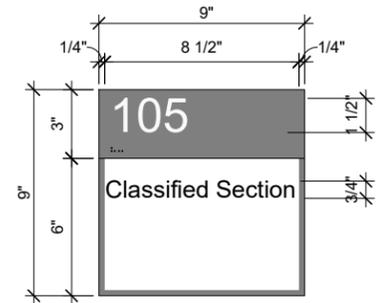

**ROOM NUMBER:** HELVETICA NEUE 55 ROMAN, 1 1/2" CAPITAL LETTER HEIGHT, FLUSH LEFT, TACTILE ROOM NUMBER ACCOMPANIED BY GRADE TWO BRAILLE

**ROOM NAME:** PRINTED PAPER INSERT WITH ROOM DESCRIPTION. UPPER AND LOWER CASE HELVETICA NEUE 55 ROMAN, 3/4" CAPITAL LETTER HEIGHT, FLUSH LEFT.

**A5 ROOM IDENTIFICATION SIGN BB2B**  
3" = 1'-0"

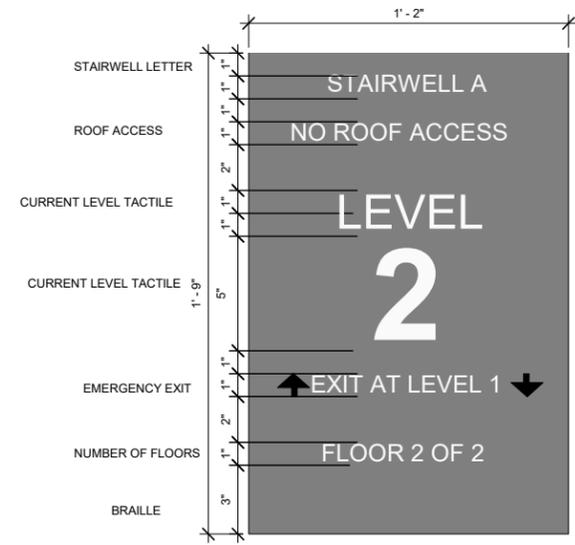


**STAIR & FLOOR NUMBER:** HELVETICA MEDIUM, 38 (1 1/2") CAPITAL LETTER HEIGHT, FLUSH LEFT. ACCOMPANIED BY GRADE TWO BRAILLE.

**BODY TEXT:** UPPER AND LOWER CASE HELVETICA MEDIUM, 12 (1/2") CAPITAL LETTER HEIGHT, FLUSH LEFT.

WHITE LETTERS ON COLORED BACKGROUND.

SIGN VERBIAGE TO INDICATE FLOOR AND ROOF ACCESS PER PLAN.

**D6 STAIRWELL SIGN BB4**  
3" = 1'-0"

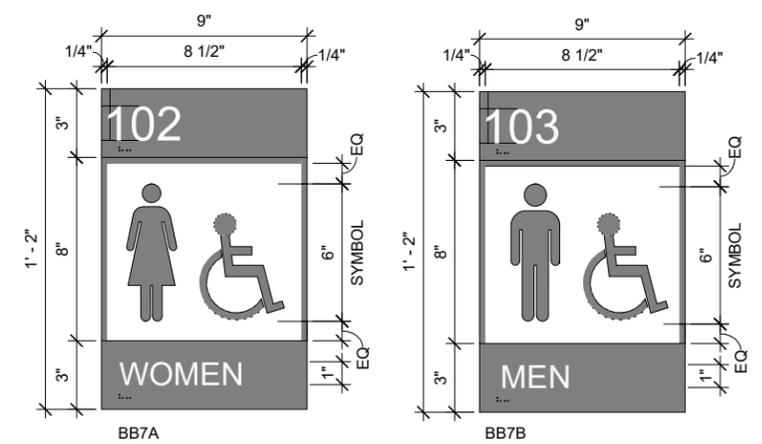

**ROOM NUMBER:** HELVETICA NEUE 55 ROMAN, 1-1/2" TACTILE ROOM NUMBER WITH GRADE TWO BRAILLE.

**ROOM NAME:** UPPER CASE HELVETICA NEUE 55 ROMAN, 1" CAPITAL LETTER HEIGHT, FLUSH LEFT, ACCOMPANIED BY GRADE TWO BRAILLE.

ROOM NAME TO BE WHITE TEXT ON A COLORED BACKGROUND AND SYMBOLS TO BE COLORED ON A WHITE BACKGROUND.

**A7 RESTROOM IDENTIFICATION SIGN BB7**  
3" = 1'-0"

GENERAL NOTES - SIGNAGE	
A	SIGNAGE LOCATION/PLACEMENT MUST MEET ABAAS REQUIREMENTS.
B	ALL SIGNAGE MUST COMPLY WITH UFC 3-120-01 STANDARDS.
C	ROOM NUMBERS SHOWN ON PLANS ARE FOR CONSTRUCTION PURPOSES, NOT NECESSARILY THE USER'S PREFERRED NUMBERING SYSTEM. COORDINATE ALL ROOM NUMBERS AND VERBIAGE FOR SIGNS WITH CONTRACTING OFFICER PRIOR TO FABRICATION.
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US Army Corps of Engineers  
Louisville District

STATE OF TEXAS  
MACHELL LARAE ABOVE  
10047  
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TEXAS REGISTERED  
ENGINEERING FIRM F-2966

MARK	DESCRIPTION	DATE


ISSUE DATE: 23 NOV 2022  
SOLICITATION NO.:  
CONTRACT NO.:  
DRAWING CODE:

DESIGNED BY: M. ABOVE  
DRAWN BY: J. HAWKINS  
CHECKED BY: S. LEBEAU  
SUBMITTED BY: E. OLNESS  
FILE NAME: SXHT219201-512

US ARMY CORPS OF ENGINEERS  
LOUISVILLE DISTRICT  
MAXWELL AIR FORCE BASE

**Jacobs**  
JACOBS ENGINEERING GROUP, INC.  
1771 JACOBS DRIVE, SUITE 100  
FAYETTEVILLE, ALABAMA 36801-1100

MAXWELL AIR FORCE BASE, ALABAMA  
REPAIR AIRCRAFT MAINTENANCE B1455 FOR MH-139  
PROJECT NUMBER: PNGS21B1455, P2#: 496395  
SIGNAGE DETAILS

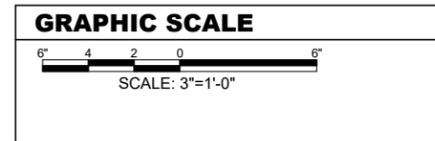

SHEET ID  
B1455  
I-512







**GENERAL NOTES - ELEVATIONS**

- A ELEVATIONS ARE SHOWN TO INDICATE FINISHES ONLY, REFER TO I-601 FOR FINISH LEGEND
- B REFERENCE REFLECTED CEILING PLANS AE121 THRU AE133 FOR CEILING HEIGHTS AND MATERIALS
- C FIELD VERIFY ALL DIMENSIONS PRIOR TO ORDERING MATERIALS AND FINISHES

**KEYNOTES**

155	MB1, MARKER BOARD
211	BASE AS SCHEDULED
214	PAINT METAL DOORS AND FRAMES, PT-4.
239	ACOUSTICAL WALL PANEL, AWP-1.
295	PAINT, PT1.



MARK	DESCRIPTION	DATE


DESIGNED BY: G. MOLICA	ISSUE DATE: 10 SEPTEMBER 2021
DRAWN BY: H. WILSON	SOLICITATION NO.:
CHECKED BY: H. WILSON	CONTRACT NO.:
SUBMITTED BY: E. OLNESS	DRAWING CODE:
SIZE: ANSI D 22x34	FILE NAME: SXHT2192011-203

US ARMY CORPS OF ENGINEERS  
LOUISVILLE DISTRICT  
PATRICK SPACE FORCE BASE


JACOBS ENGINEERING GROUP INC.  
777 JACOBS Ave. 0318903

PATRICK SPACE FORCE BASE, FLORIDA  
FY 22 PERSONNEL RECOVERY FLIGHT SIMULATOR  
PROJECT NUMBER: SXHT219201.1.P22-486413  
INTERIOR ELEVATIONS & ENLARGED PLANS

SHEET ID  
B1455  
I-203

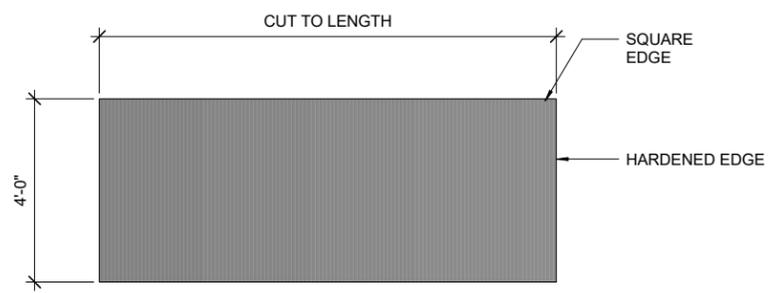


**A6** AWP-1 IMPACT PERFORMANCE ACOUSTICAL WALL PANEL  
1/2" = 1'-0"

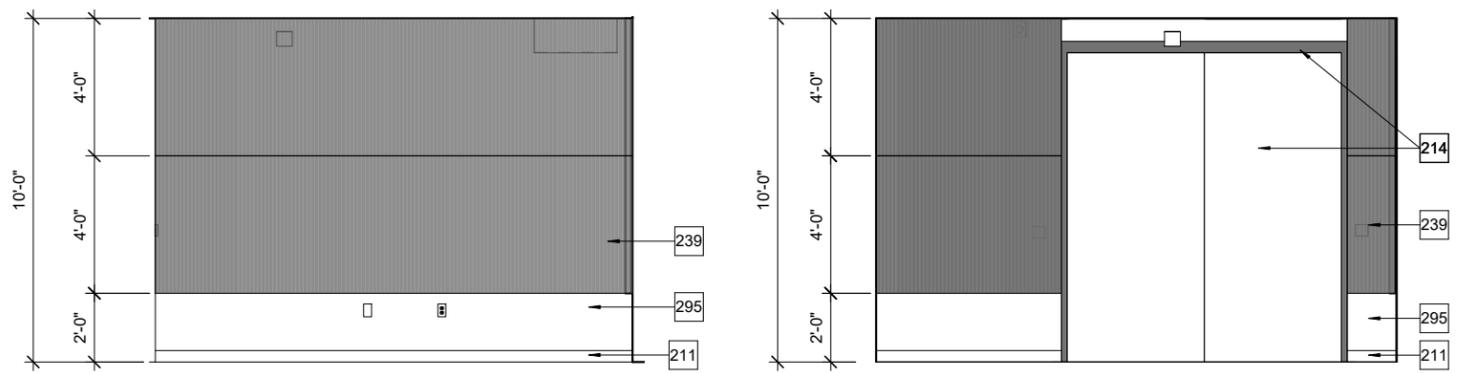


**C3** WPT 118 - WEST ELEVATION  
3/8" = 1'-0"


**C6** WPT 118 - SOUTH ELEVATION  
3/8" = 1'-0"

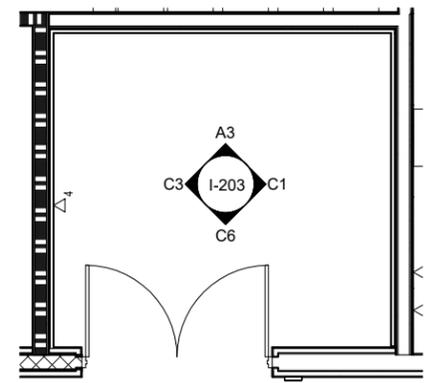


**A1** ENLARGED PLAN - WPT 118  
1/4" = 1'-0"

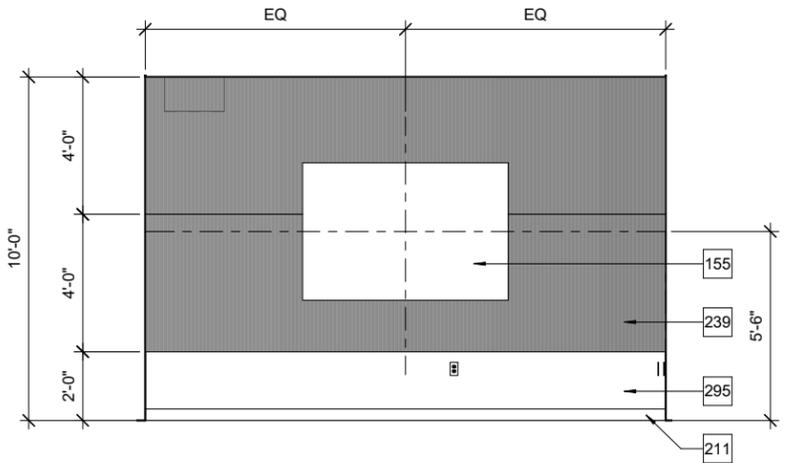

**A3** WPT 118 - NORTH ELEVATION  
3/8" = 1'-0"

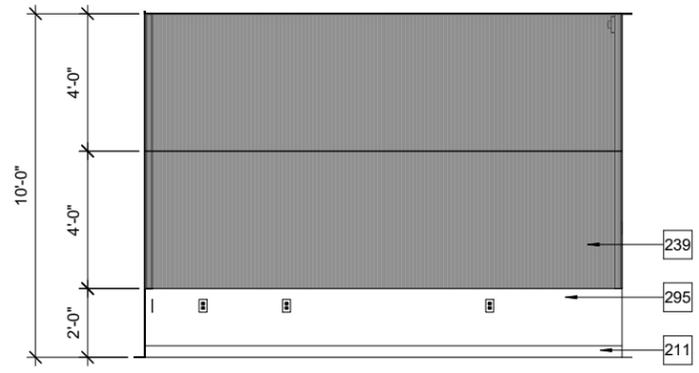

**C1** WPT 118 - EAST ELEVATION  
3/8" = 1'-0"

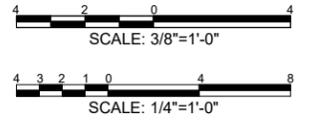





MARK	DESCRIPTION	DATE




DESIGNED BY: M. ABOVE	ISSUE DATE: 23 NOV 2022
DRAWN BY: S. LEBEAU	SOLICITATION NO.:
CHECKED BY: S. LEBEAU	CONTRACT NO.:
SUBMITTED BY: E. OLNESS	DRAWING CODE:
SIZE: ANSI D 22x34	FILE NAME: SXHT2192011-301

US ARMY CORPS OF ENGINEERS  
LOUISVILLE DISTRICT  
MAXWELL AIR FORCE BASE

**Jacobs**  
JACOBS ENGINEERING GROUP INC.  
7711 JACOBS BLVD  
JACOBS No. 1428513

MAXWELL AIR FORCE BASE, ALABAMA  
REPAIR AIRCRAFT MAINTENANCE B1455 FOR MH-139  
PROJECT NUMBER: PNGS21B1455, P2#: 496395  
MILLWORK SECTIONS AND DETAILS

SHEET ID  
B1455  
I-301

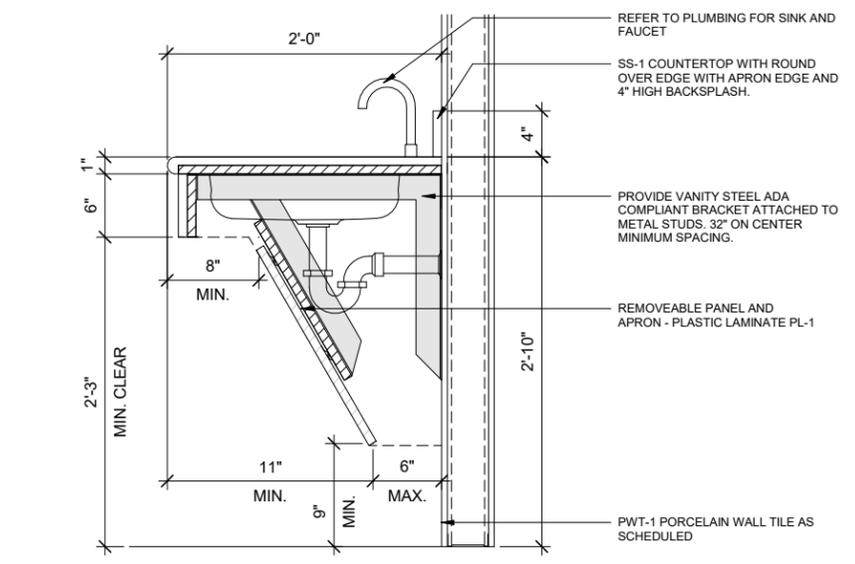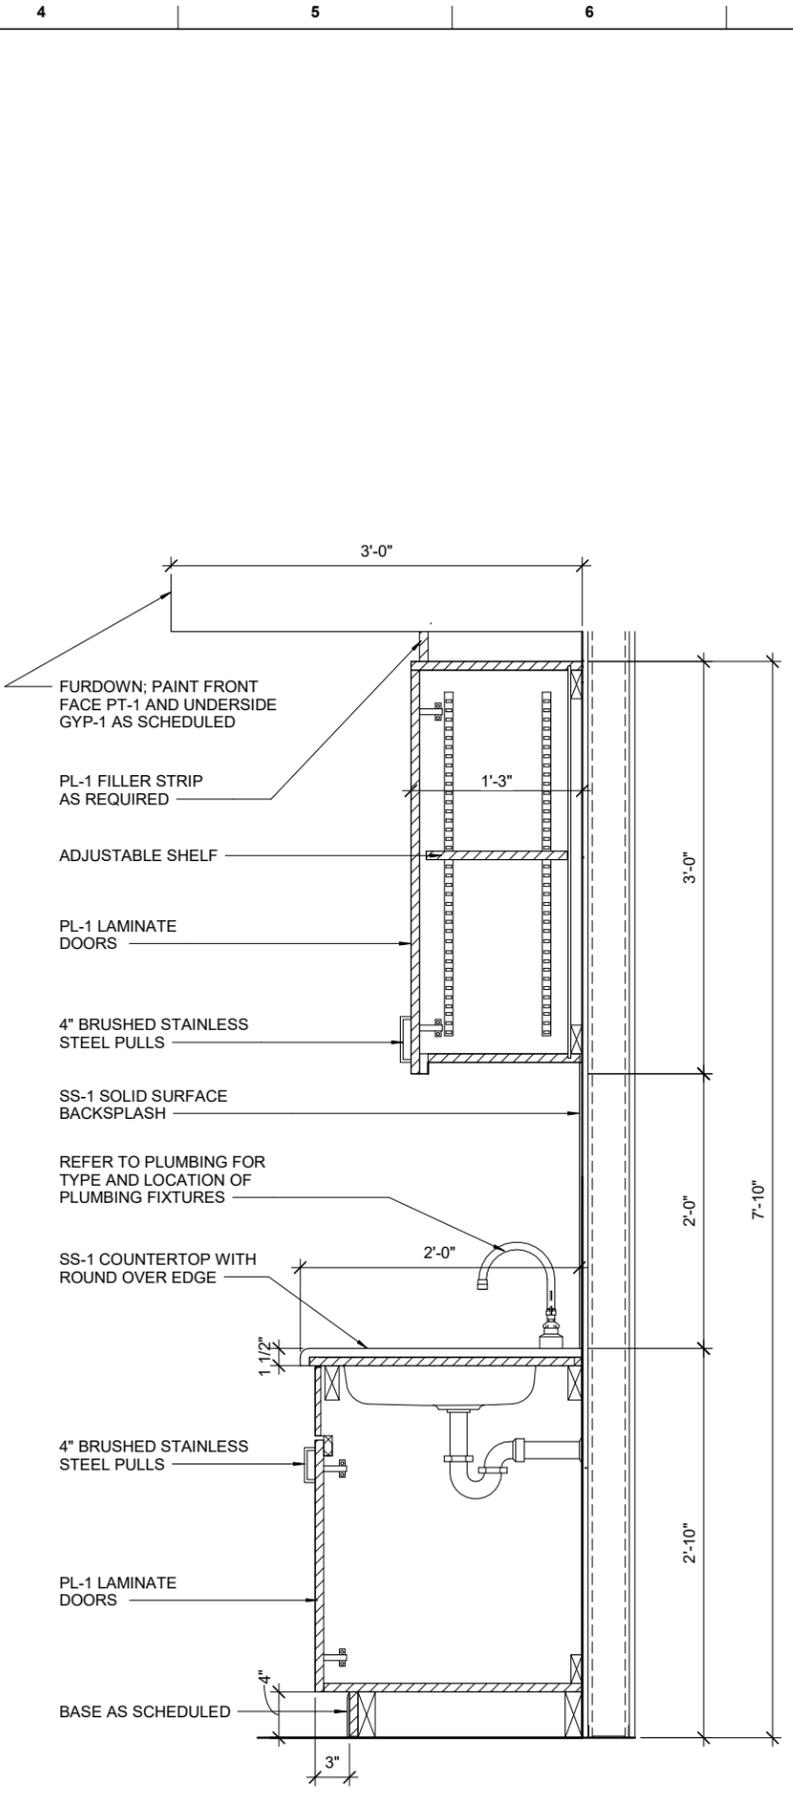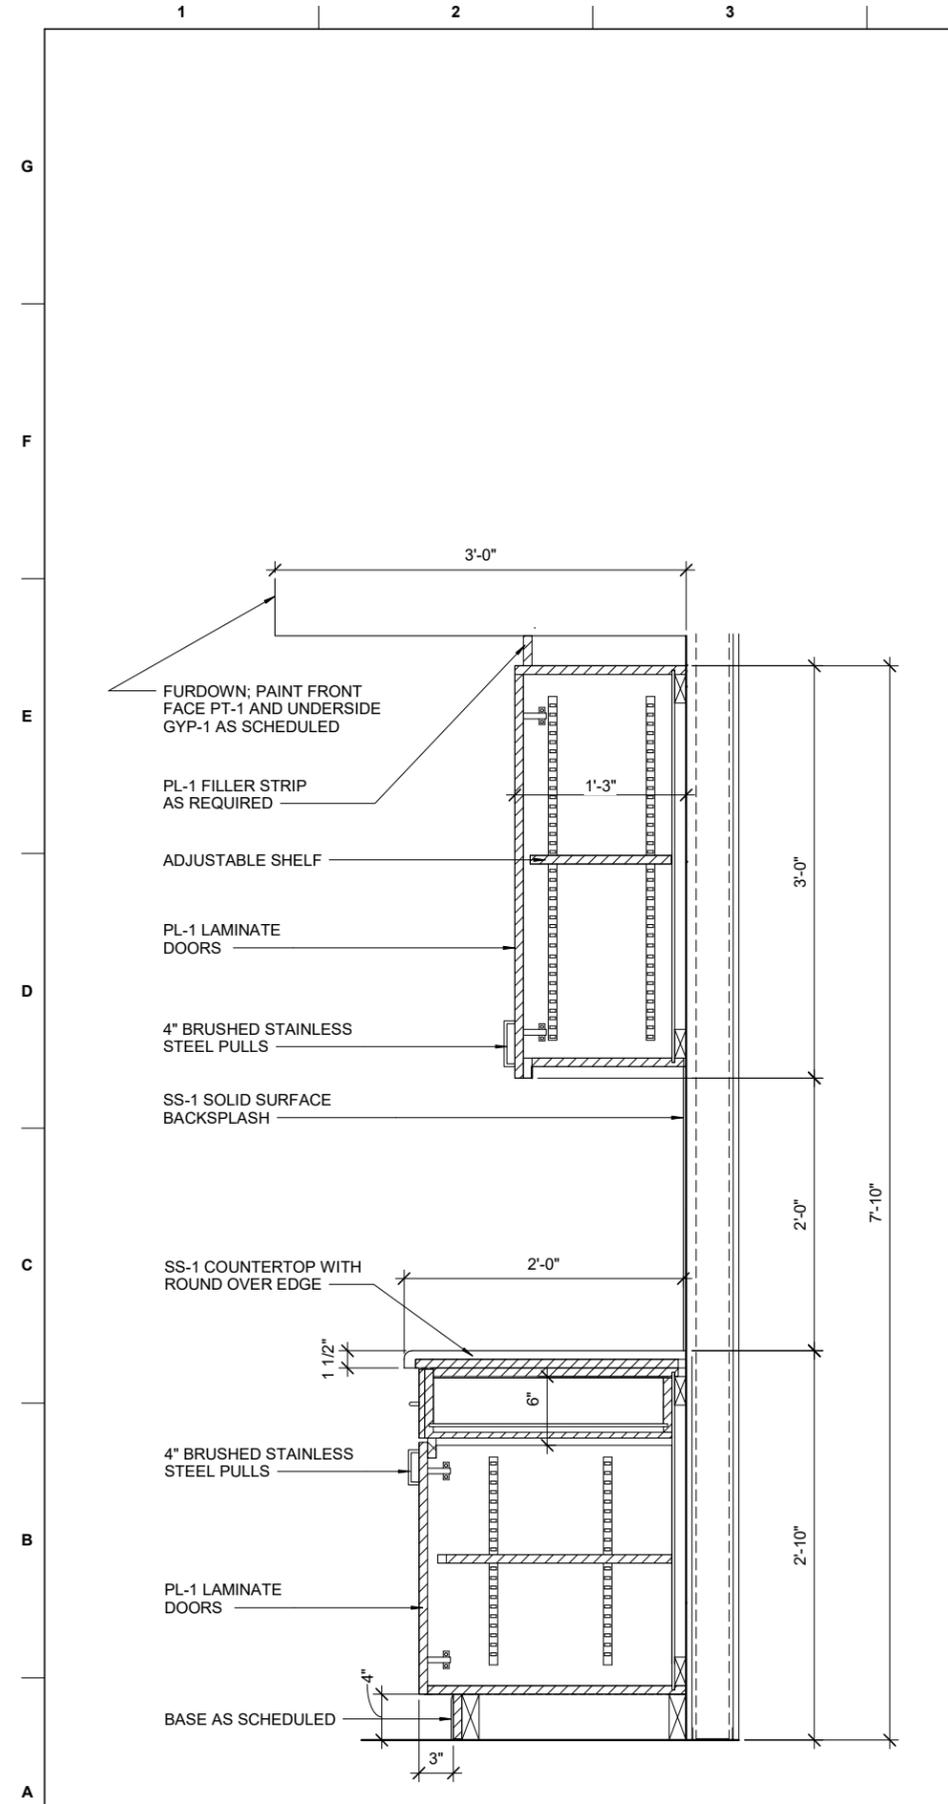







### GENERAL NOTES - FF&E PLANS

A ALL FF&E ITEMS MUST BE INCLUDED IN ITEM NO. 0004 "OPTION - FF&E"

B FURNITURE, FIXTURES & EQUIPMENT (FF&E) IS SHOWN FOR COORDINATION ONLY.

C COORDINATE WITH FURNITURE DEALER TO ALLOW BUILDING ACCESS FOR FIELD CONDITION VERIFICATION.

D FURNITURE VENDOR IS RESPONSIBLE FOR PROVIDING J BOXES AND WHIPS TO THE SUPPORT FF&E. FINAL CONNECTIONS OF SYSTEMS FURNITURE TO THE BUILDING ARE PROVIDED BY THE GENERAL CONTRACTOR.

E VERIFY FIELD CONDITIONS PRIOR TO ORDERING FF&E TO ENSURE PROPER FIT OF ALL ITEMS.

F INFORMATION TECHNOLOGY (IT) (PHONE/ LAN ETC.) WIRING SHALL BE PROVIDED BY OTHERS AFTER INSTALLATION: COORDINATE WITH CONTRACTING OFFICER.



FF&E	
MARK	DESCRIPTION
CH1	CHAIR, TASK / TRAINING
CH2	CHAIR, CONFERENCE
CH3	CHAIR, GUEST
CH4	CHAIR, BREAKROOM
CH5	CHAIR, MIDBACK CONFERENCE
CH6	TASK STOOL
CH8	LOUNGE CHAIR
CL1	WALL CLOCK
D1	DESK, L-SHAPED
D2	FACILITATOR'S STAND W/ CASTER KIT
D3	DESK, 5'-0"
D4	DESK, RECEPTION
EM1	MAT, ENTRANCE
MB1	MARKERBOARD
MC1	MOBILE CHATBOARD
ST1	STORAGE, CABINET
ST2	STORAGE, HEAVY-DUTY SHELVING
ST3	STORAGE, LATERAL FILE 2H
T1	TABLE, CONFERENCE 10'-0"
T2	TABLE, TRAINING 6'-0"
T3	TABLE, TRAINING 5'-0"
T4	TABLE, DINING
T5	TABLE, OCCASIONAL - SQUARE
T6	TABLE, OCCASIONAL - RECTANGLE
T7	TABLE, WORK AREA
TR1	TRASH RECEPTACLE
TR2	RECYCLE RECEPTACLE
TR3	3-COMPARTMENT TRASH & RECYCLING
WS1	WORKSTATION, L- SHAPED
WS2	WORKSTATION, BENCHING


DESIGNED BY: M. ABOVE  
 DRAWN BY: S. LEBEAU  
 CHECKED BY: S. LEBEAU  
 SUBMITTED BY: E. OLNESS  
 ISSUE DATE: 23 NOV 2022  
 SOLICITATION NO.:  
 CONTRACT NO.:  
 DRAWING CODE:  
 FILE NAME: SXHT1219201IF103  
 SIZE: ANS I 22x34

US ARMY CORPS OF ENGINEERS  
 LOUISVILLE DISTRICT  
 MAXWELL AIR FORCE BASE

**Jacobs**  
 JACOBS ENGINEERING GROUP INC.  
 7711 JACOBS BLVD  
 FORT WORTH, TX 76114

MAXWELL AIR FORCE BASE, ALABAMA  
 REPAIR AIRCRAFT MAINTENANCE B1455 FOR MH-139  
 PROJECT NUMBER: PMS21B1455, P#: 496395  
 PARTIAL FURNITURE, FIXTURE, & EQUIPMENT PLAN  
 - LEVEL 1 - AREA B


SHEET ID  
**B1455**  
**IF103**

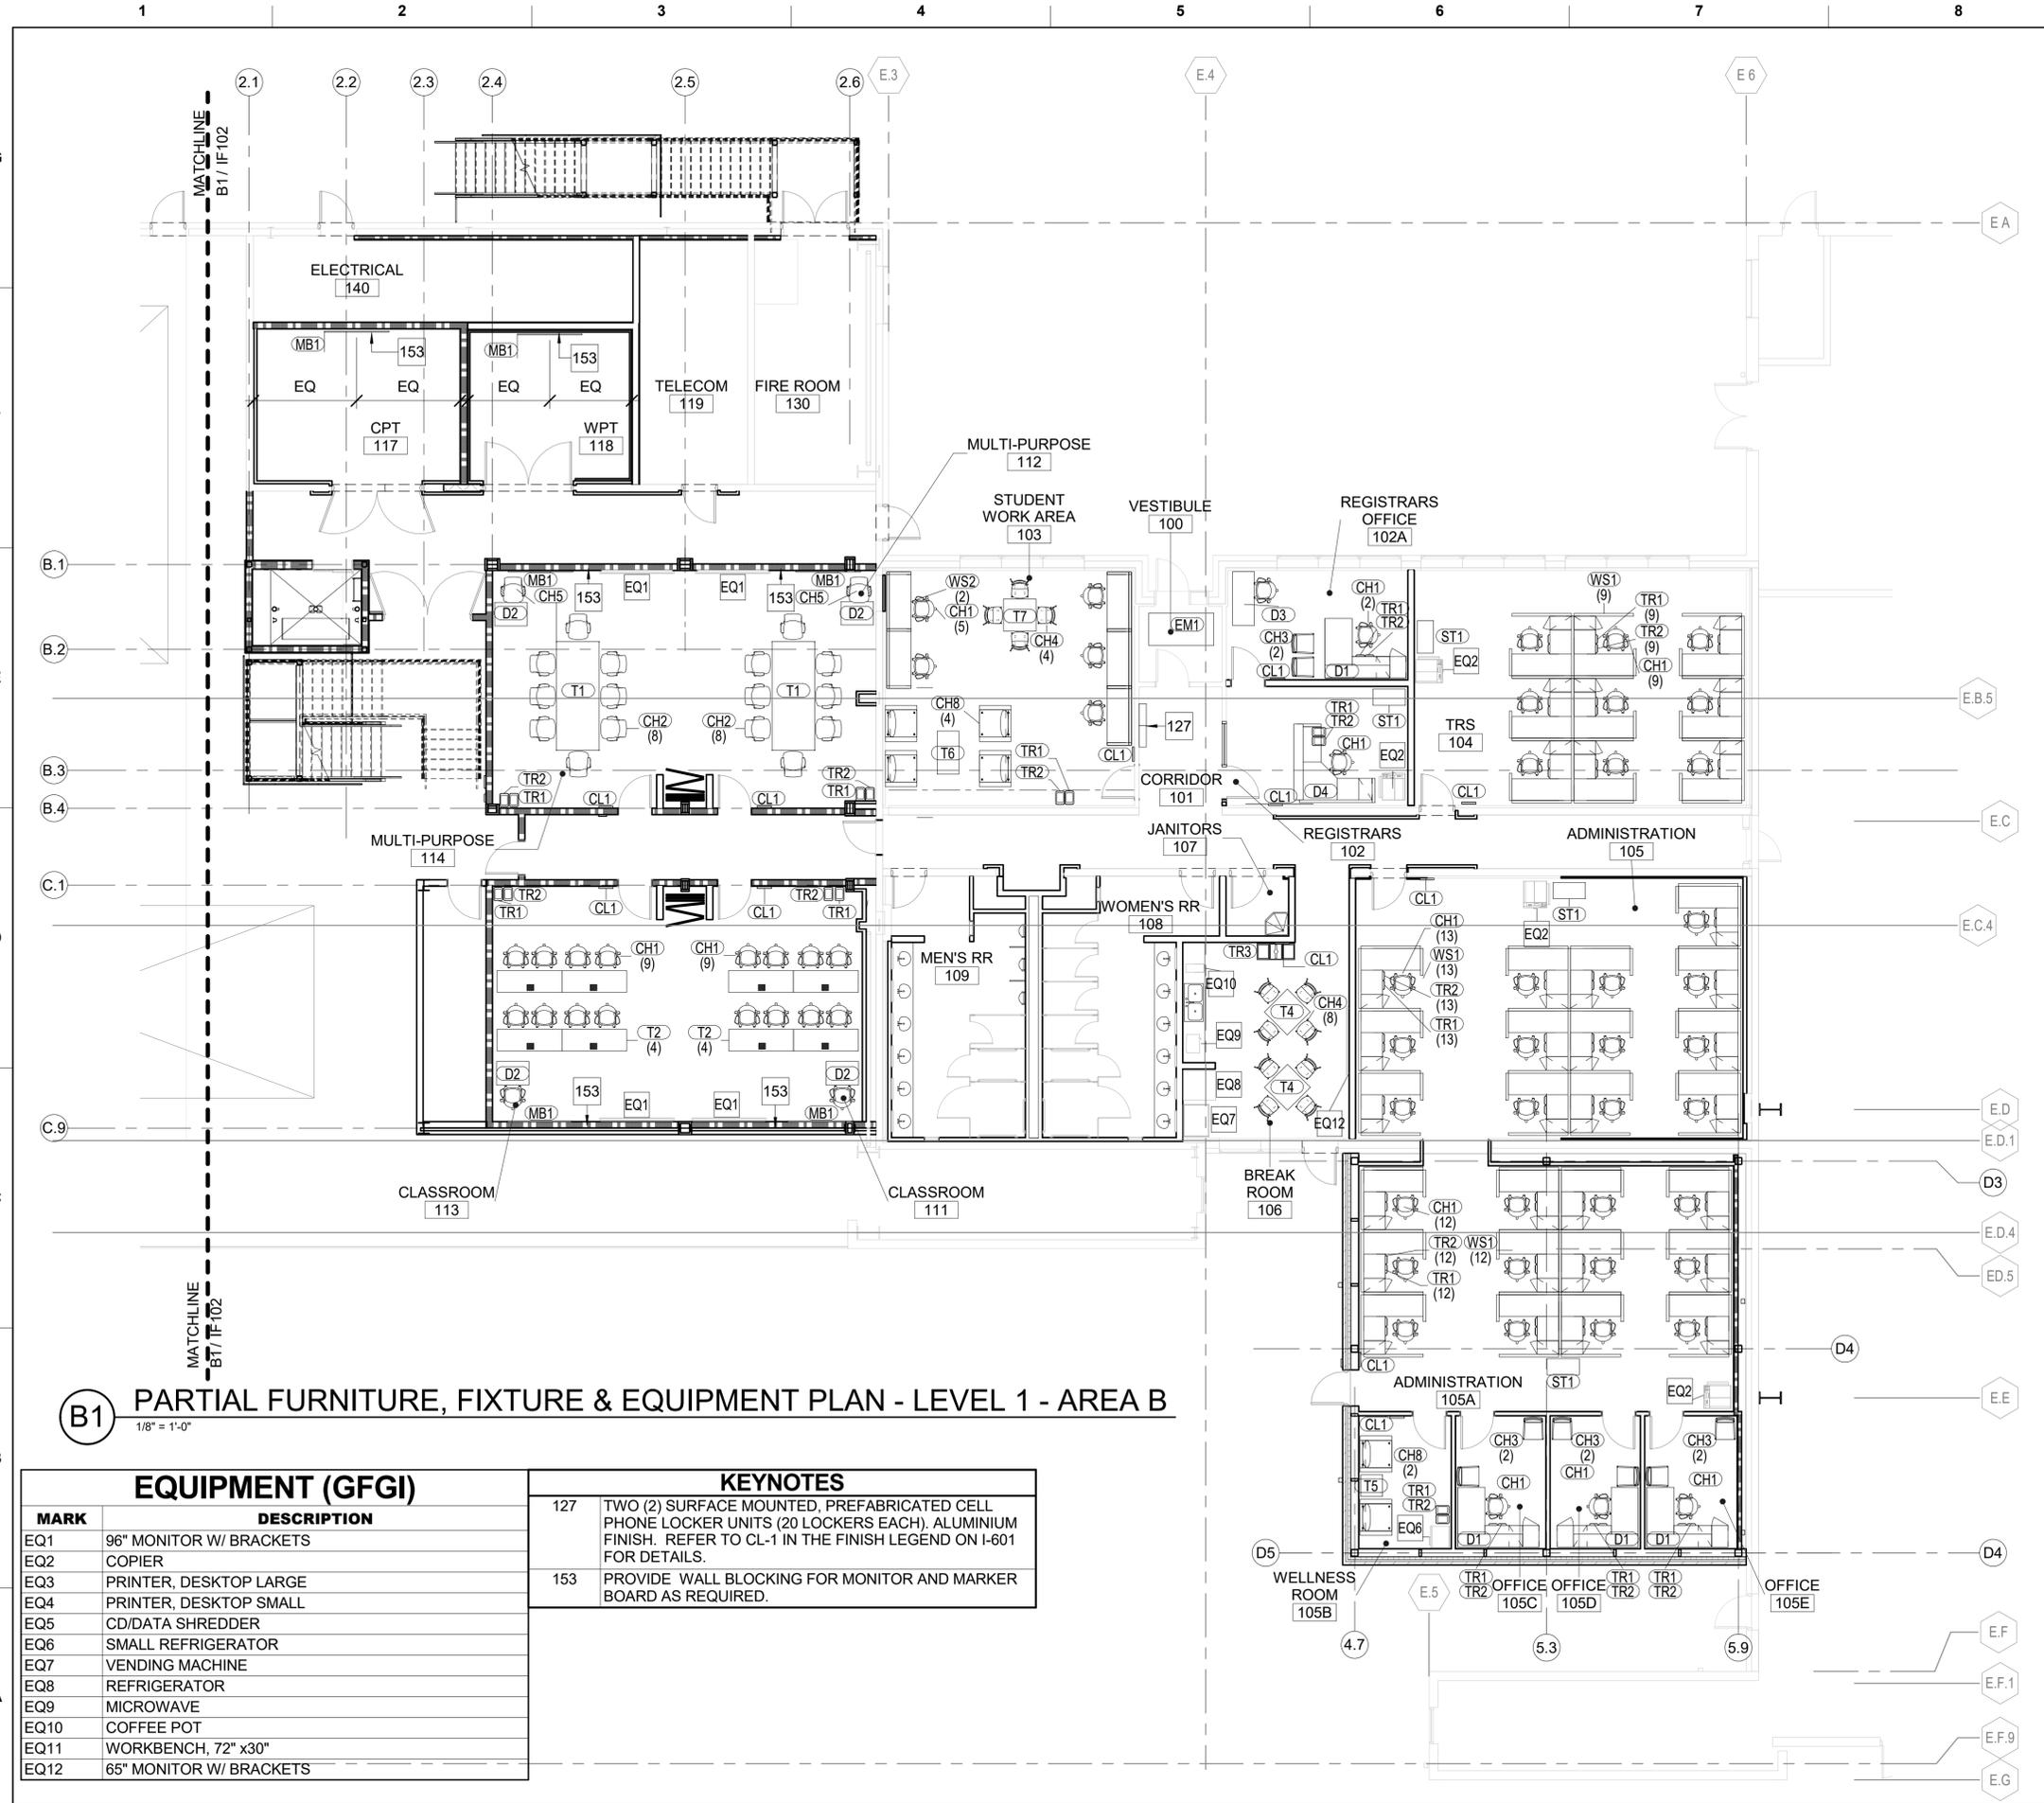

**B1 PARTIAL FURNITURE, FIXTURE & EQUIPMENT PLAN - LEVEL 1 - AREA B**  
 1/8" = 1'-0"

MARK	DESCRIPTION
EQ1	96" MONITOR W/ BRACKETS
EQ2	COPIER
EQ3	PRINTER, DESKTOP LARGE
EQ4	PRINTER, DESKTOP SMALL
EQ5	CD/DATA SHREDDER
EQ6	SMALL REFRIGERATOR
EQ7	VENDING MACHINE
EQ8	REFRIGERATOR
EQ9	MICROWAVE
EQ10	COFFEE POT
EQ11	WORKBENCH, 72" x30"
EQ12	65" MONITOR W/ BRACKETS

KEYNOTES	
127	TWO (2) SURFACE MOUNTED, PREFABRICATED CELL PHONE LOCKER UNITS (20 LOCKERS EACH). ALUMINIUM FINISH. REFER TO CL-1 IN THE FINISH LEGEND ON I-601 FOR DETAILS.
153	PROVIDE WALL BLOCKING FOR MONITOR AND MARKER BOARD AS REQUIRED.

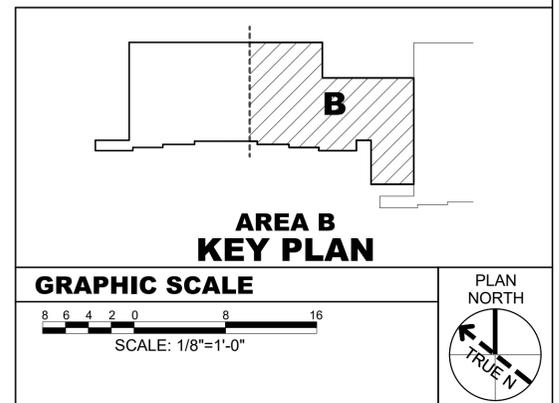










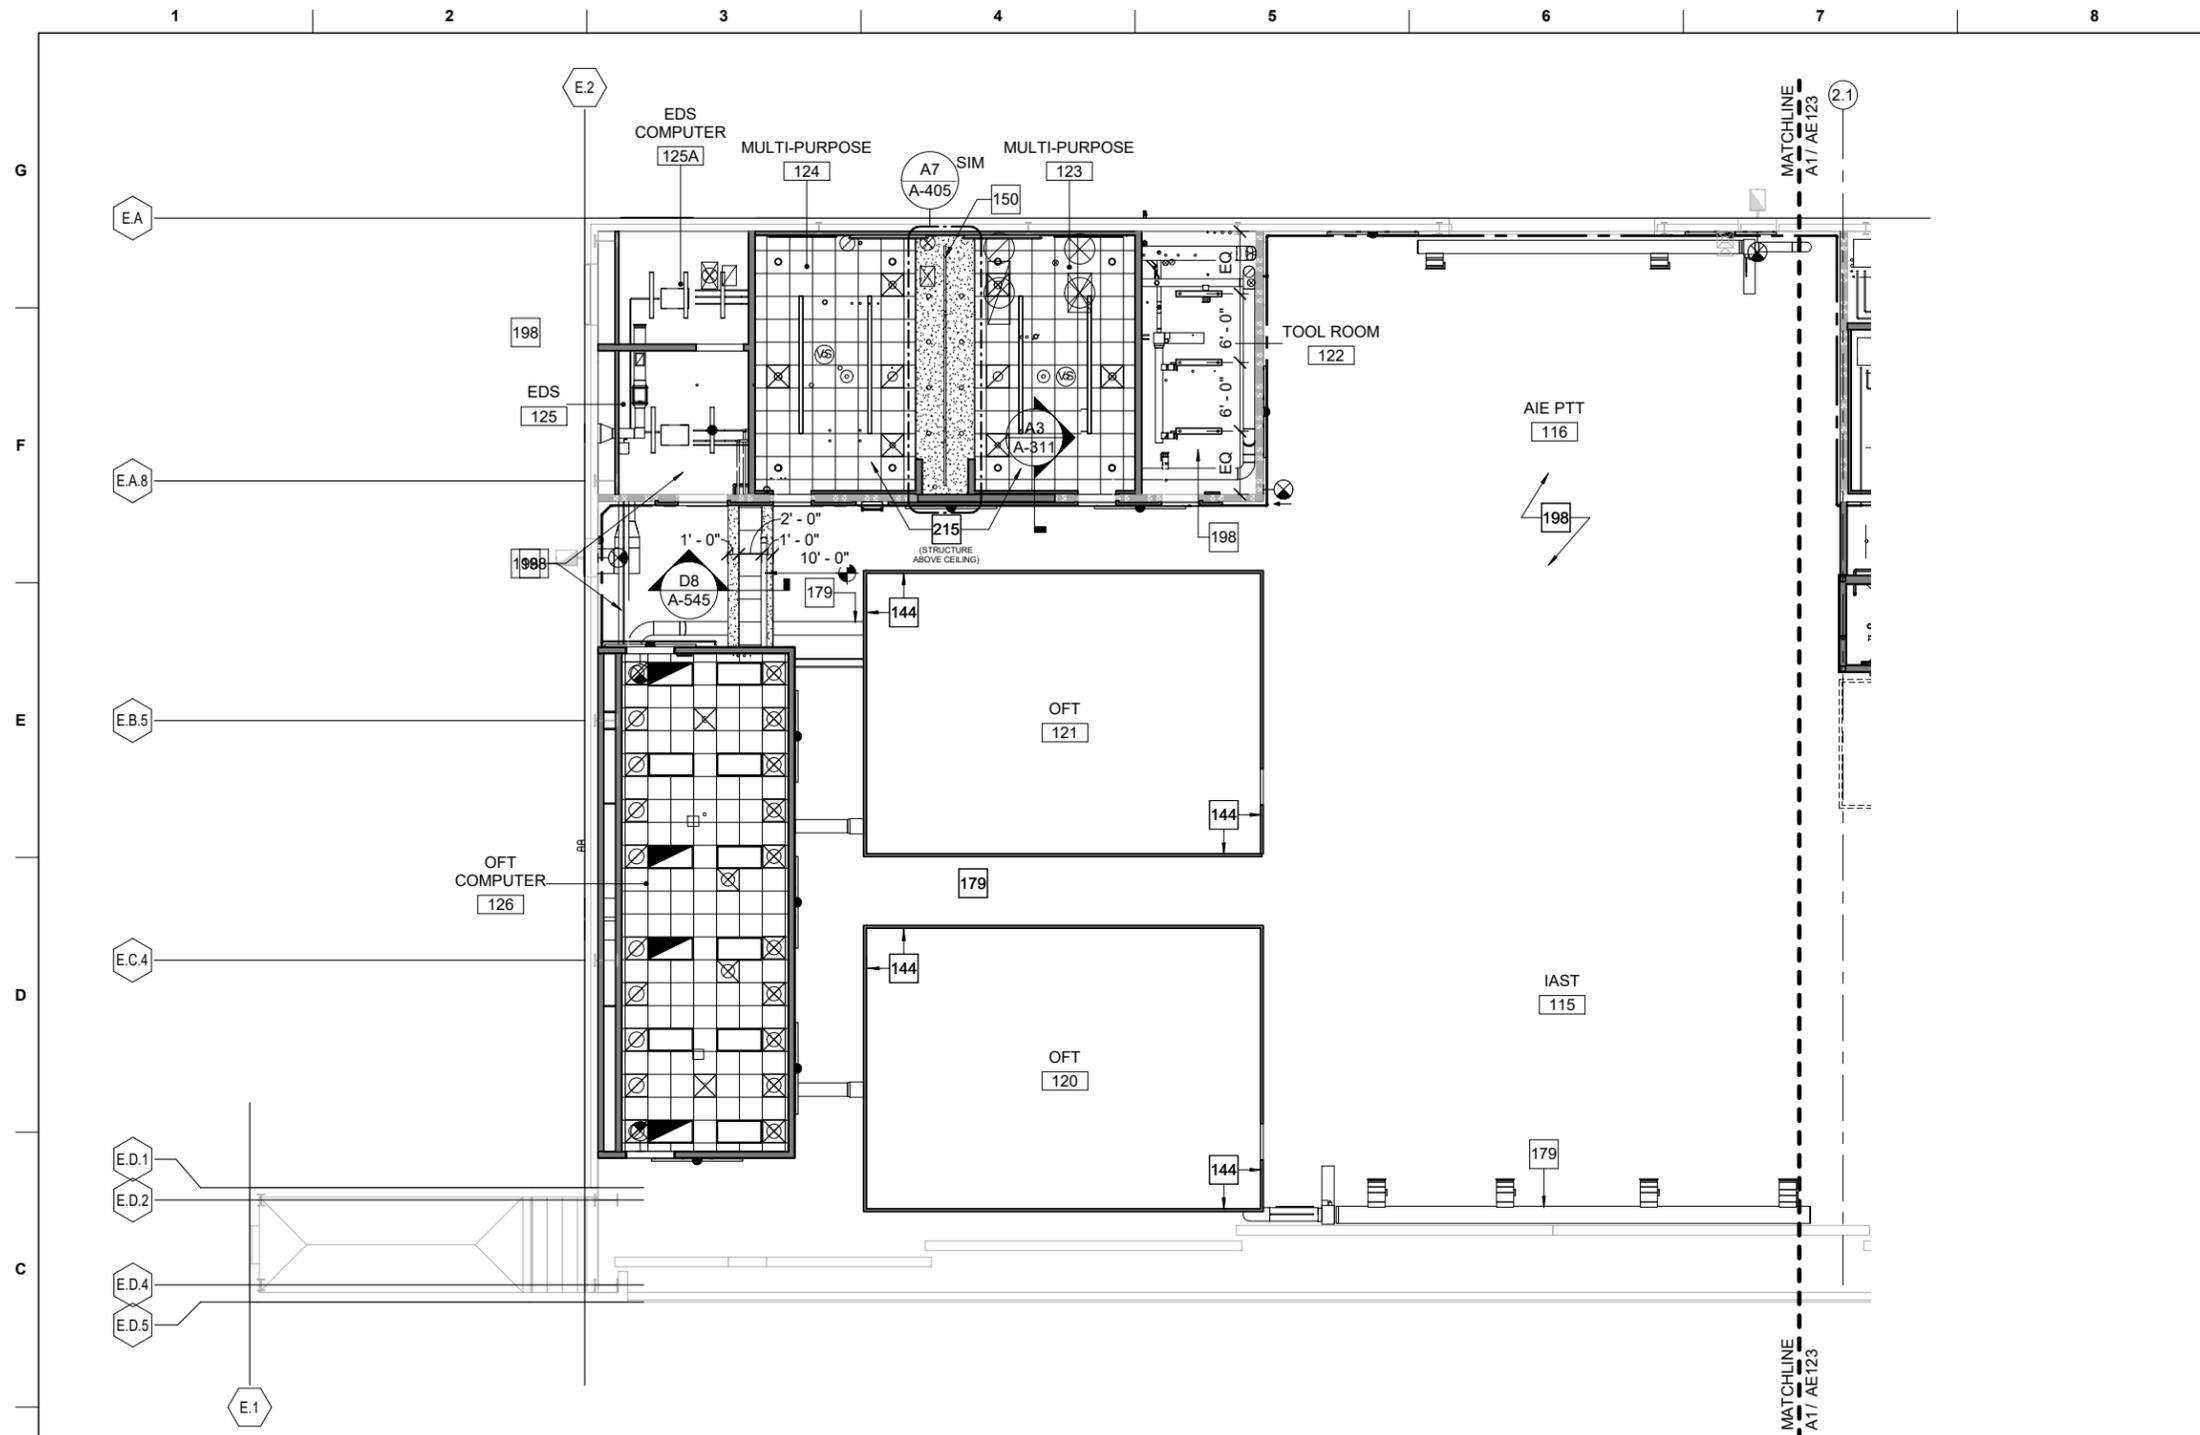

**(A1) PARTIAL REFLECTED CEILING PLAN - LEVEL 1 - AREA A**  
 1/8" = 1'-0"

KEYNOTES	
144	PRE-MANUFACTURED LIGHT-TIGHT ENCLOSURE
150	CEILING TRACK FOR OPERABLE PARTITION; REFER TO D1/A-510 FOR TRACK DETAIL AND STRUCTURAL DETAILS FOR PARTITION SUPPORT
179	EXPOSED UNFINISHED SPIRAL DUCT WITH INTERIOR LINER, PAINT SUPPORT HANGERS WHITE; REFER TO MECHANICAL
198	OPEN TO STRUCTURE
215	CONCEALED STRUCTURAL BEAM AND METAL DECKING WITH SPRAY APPLIED CEMENTITIOUS FIREPROOFING

GENERAL NOTES	
A	REFER TO AE101 THRU AE113 FOR FLOOR PLANS
B	REFER TO A-570 FOR PARTITION TYPES AND DETAILS
C	REFER TO IN101 THRU IN112 FOR FINISH PLANS. REFER TO I-602 FOR FINISH SCHEDULE
D	ALL GYPSUM BOARD AND ACOUSTICAL CEILINGS TO BE 9'-0" ABOVE FINISH FLOOR UNLESS OTHERWISE NOTED
E	PROVIDE HOLD-DOWN CLIPS AT ALL ACOUSTICAL CEILING TILE WITHIN 10'-0" OF AN EXTERIOR DOOR
F	AT CONDITIONS WHERE LIGHTS, SPRINKLERS, OR OTHER DEVICES ARE COINCIDENT ON PLAN, FIXTURES ARE AT DIFFERENT LOCATIONS. REFER TO ELECTRICAL AND FIRE PROTECTION FOR FIXTURE MOUNTING HEIGHTS
G	EXTERIOR FINISHES AT AREAS OF NEW CONSTRUCTION ARE TO MATCH THE EXISTING FINISHES; CONTACT 42 CES FOR ADDITIONAL INFORMATION
H	FIRE RATING OF THE LEVEL 2 FLOOR SLAB AND LEVEL 2 CEILINGS ARE TO MATCH THE FIRE RATING OF THE WALLS PER NFPA 101 AND TSPFEGW

REFLECTED CEILING PLAN LEGEND	
	GYPSUM BOARD CEILING AS SCHEDULED
	CONTROL JOINT
	2x2' ACOUSTICAL CEILING TILE AS SCHEDULED CENTERED IN SPACE AS INDICATED
	LINEAR SLOT DIFFUSERS
	SPRINKLERS, SMOKE DETECTORS, AND SPEAKER STROBES; REFER TO FIRE PROTECTION DRAWINGS.
	LIGHT FIXTURE; REFER TO ELECTRICAL DRAWINGS.
	OCCUPANCY/VACANCY SENSOR; REFER TO ELECTRICAL DRAWINGS.
	EXIT LIGHT FIXTURE; REFER TO ELECTRICAL DRAWINGS.
	SUPPLY AIR DIFFUSERS; REFER TO MECHANICAL DRAWINGS.
	RETURN AIR GRILLE; REFER TO MECHANICAL DRAWINGS.
	SPEAKER; REFER TO TELECOMMUNICATION DRAWINGS
	WIRELESS ACCESS POINT; REFER TO TELECOMMUNICATION DRAWINGS
	LADDER CABLE TRAY; REFER TO TELECOMMUNICATION DRAWINGS
	FIXED POSITION SECURITY CAMERA; REFER TO TELECOMMUNICATION DRAWINGS
	CEILING ACCESS PANEL

**AREA A KEY PLAN**

**GRAPHIC SCALE**

SCALE: 1/8"=1'-0"

PLAN NORTH



MARK	DESCRIPTION	DATE

ISSUE DATE:	23 NOVEMBER 2022
DESIGNED BY:	J. PERRY
DRAWN BY:	D. MCKINLEY
CHECKED BY:	M. HOLLER
SUBMITTED BY:	E. OLNESS
SIZE:	ANSI D 22x34
FILE NAME:	SXHT21920/AE122
SOLICITATION NO.:	
CONTRACT NO.:	
DRAWING CODE:	

US ARMY CORPS OF ENGINEERS  
 LOUISVILLE DISTRICT  
 MAXWELL AIR FORCE BASE  
**Jacobs**  
 JACOBS ENGINEERING GROUP, INC.  
 7711 JACOBS BLVD  
 JACOBS No. 1428513

MAXWELL AIR FORCE BASE, ALABAMA  
 REPAIR AIRCRAFT MAINTENANCE B1455 FOR MH-139  
 PROJECT NUMBER: PNGS21B1455, P2#: 498395  
 PARTIAL REFLECTED CEILING PLAN - LEVEL 1 - AREA A

SHEET ID  
**B1455**  
**AE122**

- A REFER TO AE101 THRU AE113 FOR FLOOR PLANS
- B REFER TO A-570 FOR PARTITION TYPES AND DETAILS
- C REFER TO IN101 THRU IN112 FOR FINISH PLANS. REFER TO I-602 FOR FINISH SCHEDULE
- D ALL GYPSUM BOARD AND ACOUSTICAL CEILINGS TO BE 9'-0" ABOVE FINISH FLOOR UNLESS OTHERWISE NOTED
- E PROVIDE HOLD-DOWN CLIPS AT ALL ACOUSTICAL CEILING TILE WITHIN 10'-0" OF AN EXTERIOR DOOR
- F AT CONDITIONS WHERE LIGHTS, SPRINKLERS, OR OTHER DEVICES ARE COINCIDENT ON PLAN, FIXTURES ARE AT DIFFERENT LOCATIONS. REFER TO ELECTRICAL AND FIRE PROTECTION FOR FIXTURE MOUNTING HEIGHTS
- G EXTERIOR FINISHES AT AREAS OF NEW CONSTRUCTION ARE TO MATCH THE EXISTING FINISHES; CONTACT 42 CES FOR ADDITIONAL INFORMATION
- H FIRE RATING OF THE LEVEL 2 FLOOR SLAB AND LEVEL 2 CEILINGS ARE TO MATCH THE FIRE RATING OF THE WALLS PER NFPA 101 AND TSFPEWG



**REFLECTED CEILING PLAN LEGEND**


- GYPSUM BOARD CEILING AS SCHEDULED
- CONTROL JOINT
- 2'x2' ACOUSTICAL CEILING TILE AS SCHEDULED CENTERED IN SPACE AS INDICATED
- LINEAR SLOT DIFFUSERS
- SPRINKLERS, SMOKE DETECTORS, AND SPEAKER STROBES; REFER TO FIRE PROTECTION DRAWINGS.
- LIGHT FIXTURE; REFER TO ELECTRICAL DRAWINGS.
- OCCUPANCY/VACANCY SENSOR; REFER TO ELECTRICAL DRAWINGS.
- EXIT LIGHT FIXTURE; REFER TO ELECTRICAL DRAWINGS.
- SUPPLY AIR DIFFUSERS; REFER TO MECHANICAL DRAWINGS.
- RETURN AIR GRILLE; REFER TO MECHANICAL DRAWINGS.
- SPEAKER; REFER TO TELECOMMUNICATION DRAWINGS
- WIRELESS ACCESS POINT; REFER TO TELECOMMUNICATION DRAWINGS
- LADDER CABLE TRAY; REFER TO TELECOMMUNICATION DRAWINGS
- FIXED POSITION SECURITY CAMERA; REFER TO TELECOMMUNICATION DRAWINGS
- CEILING ACCESS PANEL

ISSUE DATE: 23 NOVEMBER 2022  
 SOLICITATION NO.:  
 CONTRACT NO.:  
 DRAWING CODE:  
 FILE NAME: SXHT21920/AE123



DESIGNED BY: J. PERRY  
 DRAWN BY: D. WAINWRIGHT  
 CHECKED BY: M. HOLLER  
 SUBMITTED BY: E. OLNESS  
 SIZE: ANS/D 22234

US ARMY CORPS OF ENGINEERS  
 LOUISVILLE DISTRICT  
 MAXWELL AIR FORCE BASE


**Jacobs**  
 JACOBS ENGINEERING GROUP, INC.  
 7711 JACOBS BLVD  
 SUITE 100  
 FORT WORTH, TX 76116

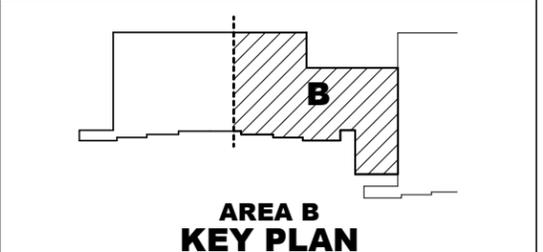

**GRAPHIC SCALE**

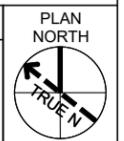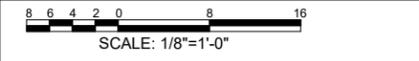


SHEET ID  
 B1455  
 AE123

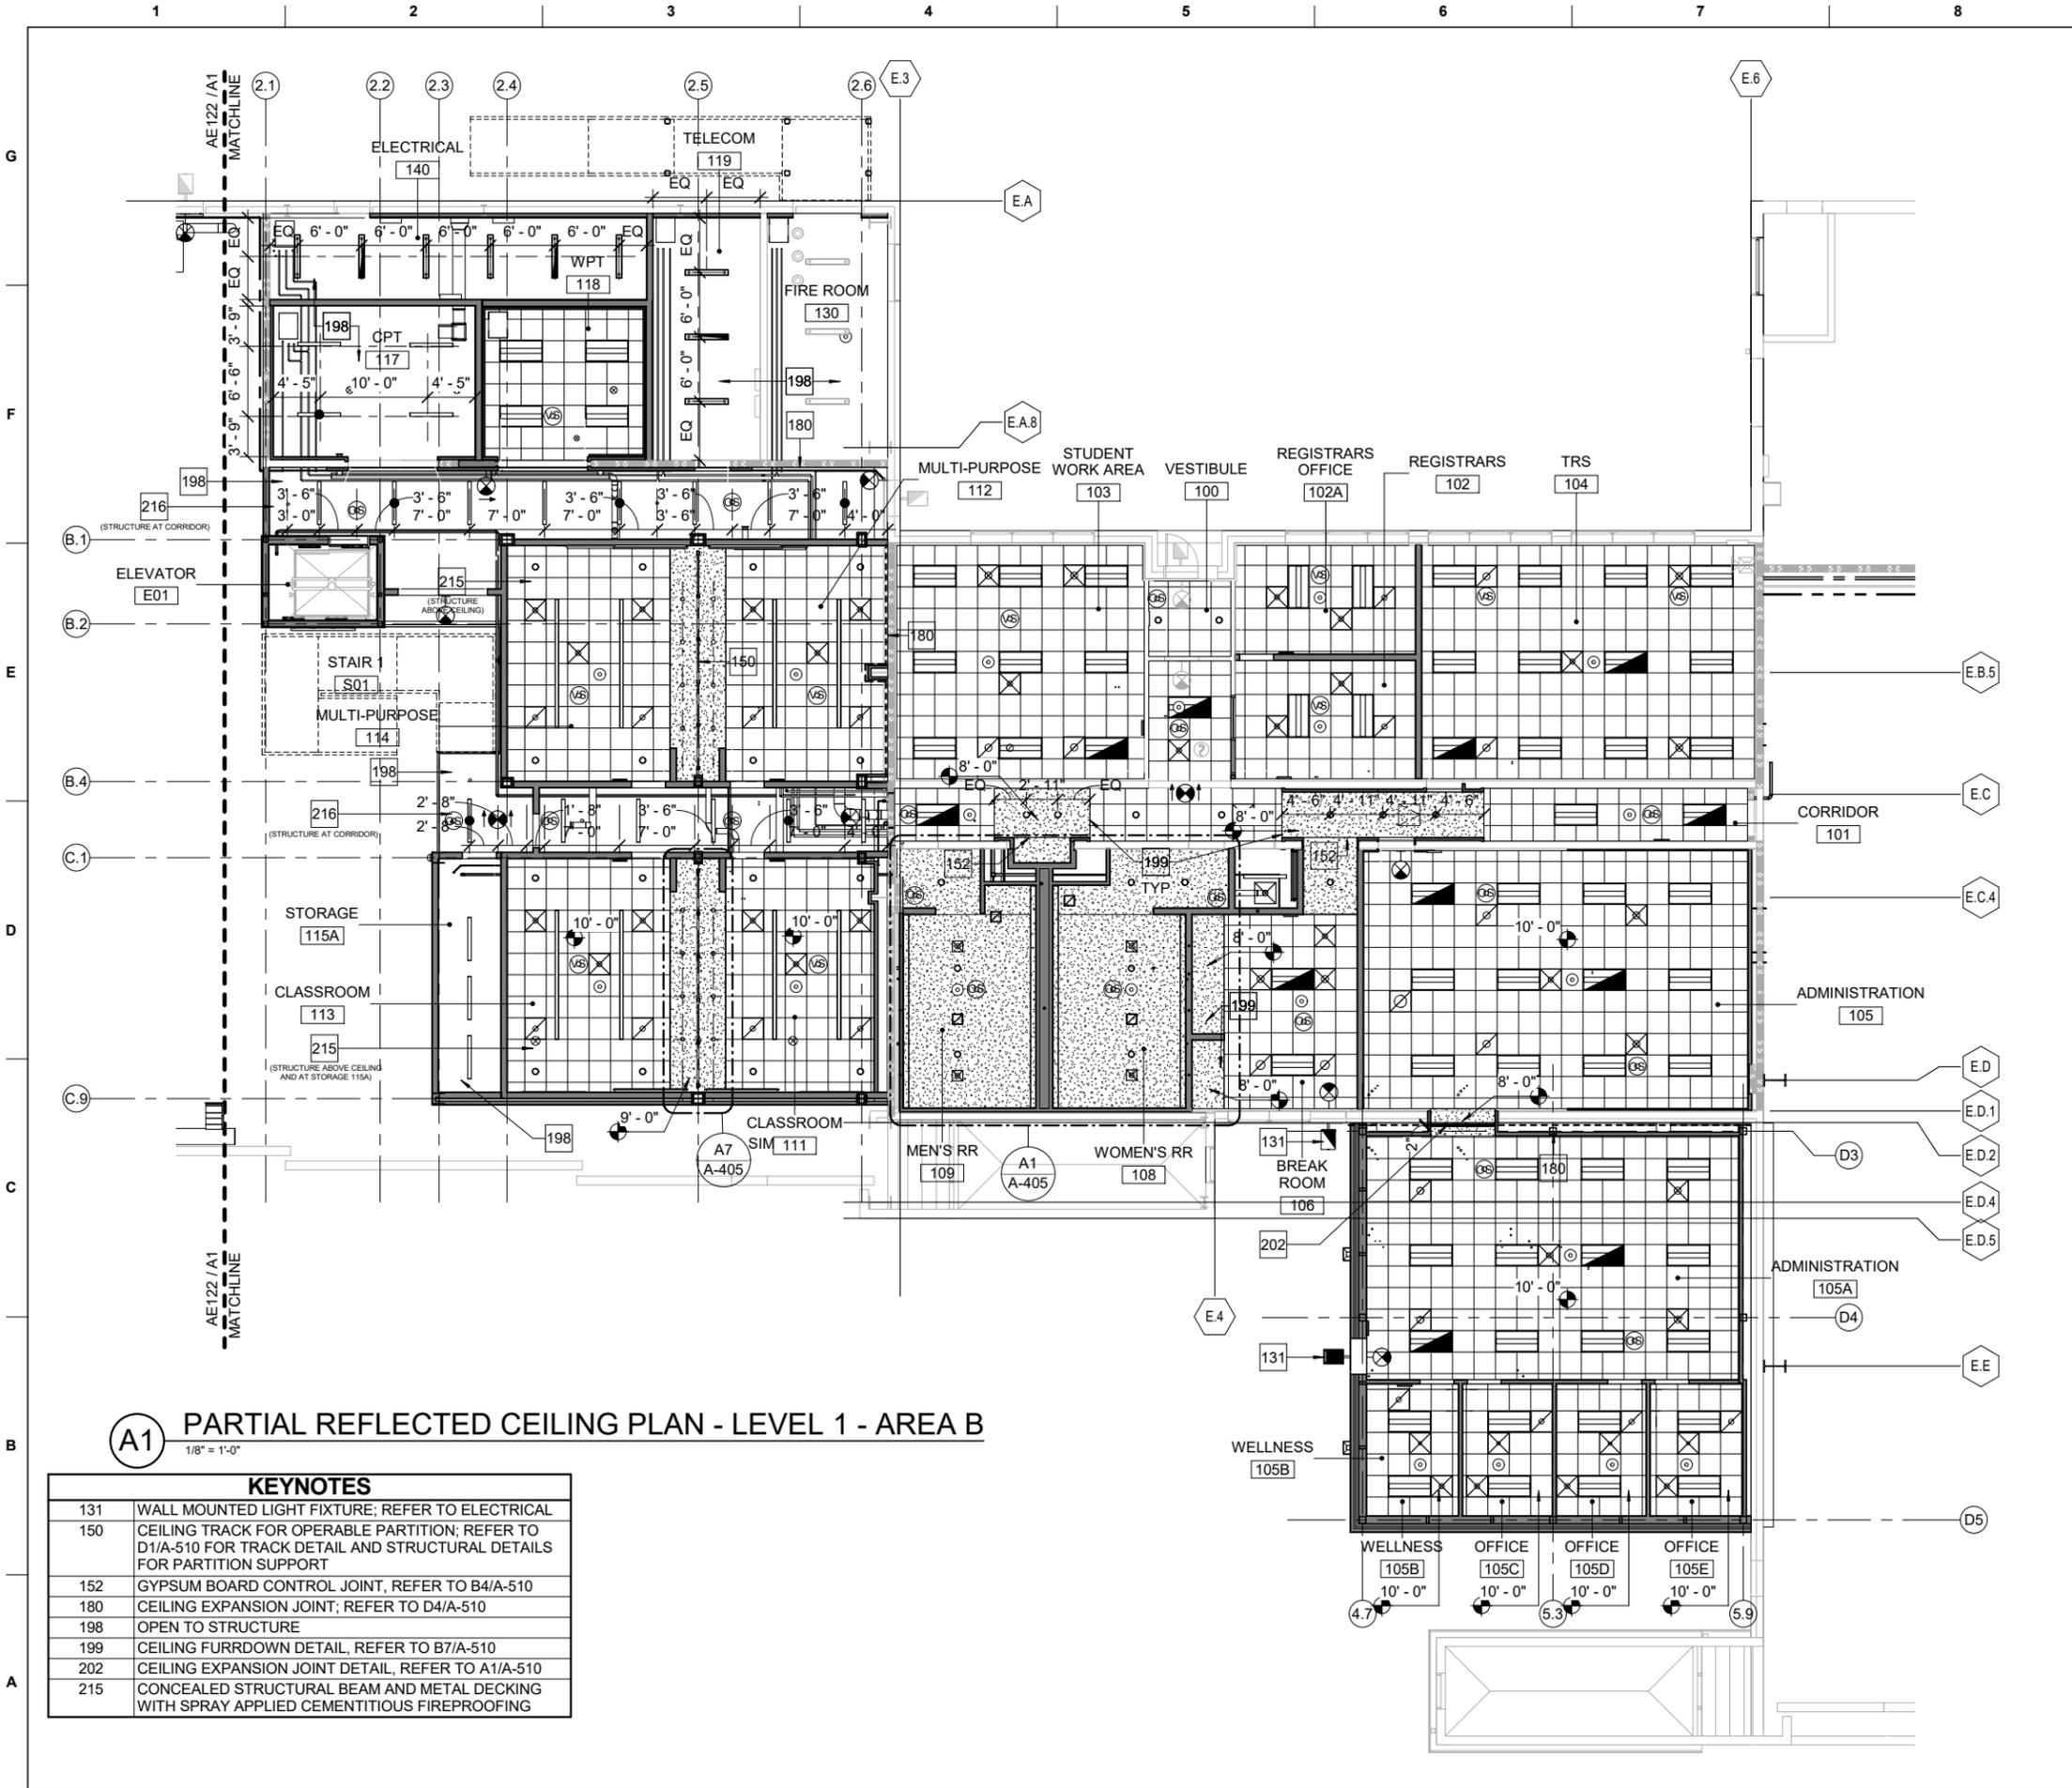

**(A1) PARTIAL REFLECTED CEILING PLAN - LEVEL 1 - AREA B**  
 1/8" = 1'-0"

KEYNOTES	
131	WALL MOUNTED LIGHT FIXTURE; REFER TO ELECTRICAL
150	CEILING TRACK FOR OPERABLE PARTITION; REFER TO D1/A-510 FOR TRACK DETAIL AND STRUCTURAL DETAILS FOR PARTITION SUPPORT
152	GYPSUM BOARD CONTROL JOINT; REFER TO B4/A-510
180	CEILING EXPANSION JOINT; REFER TO D4/A-510
198	OPEN TO STRUCTURE
199	CEILING FURDOWN DETAIL; REFER TO B7/A-510
202	CEILING EXPANSION JOINT DETAIL; REFER TO A1/A-510
215	CONCEALED STRUCTURAL BEAM AND METAL DECKING WITH SPRAY APPLIED CEMENTITIOUS FIREPROOFING

NAME	NUMBER
OFT	120
OFT	121
MECH MEZZ	150
CIRCULATION	200A
CORRIDOR	200B
TSC	201
CLASS	202
MISSION PLANNING	203
COMM CHASE	204
MISSION PLANNING	205
TOTAL:	

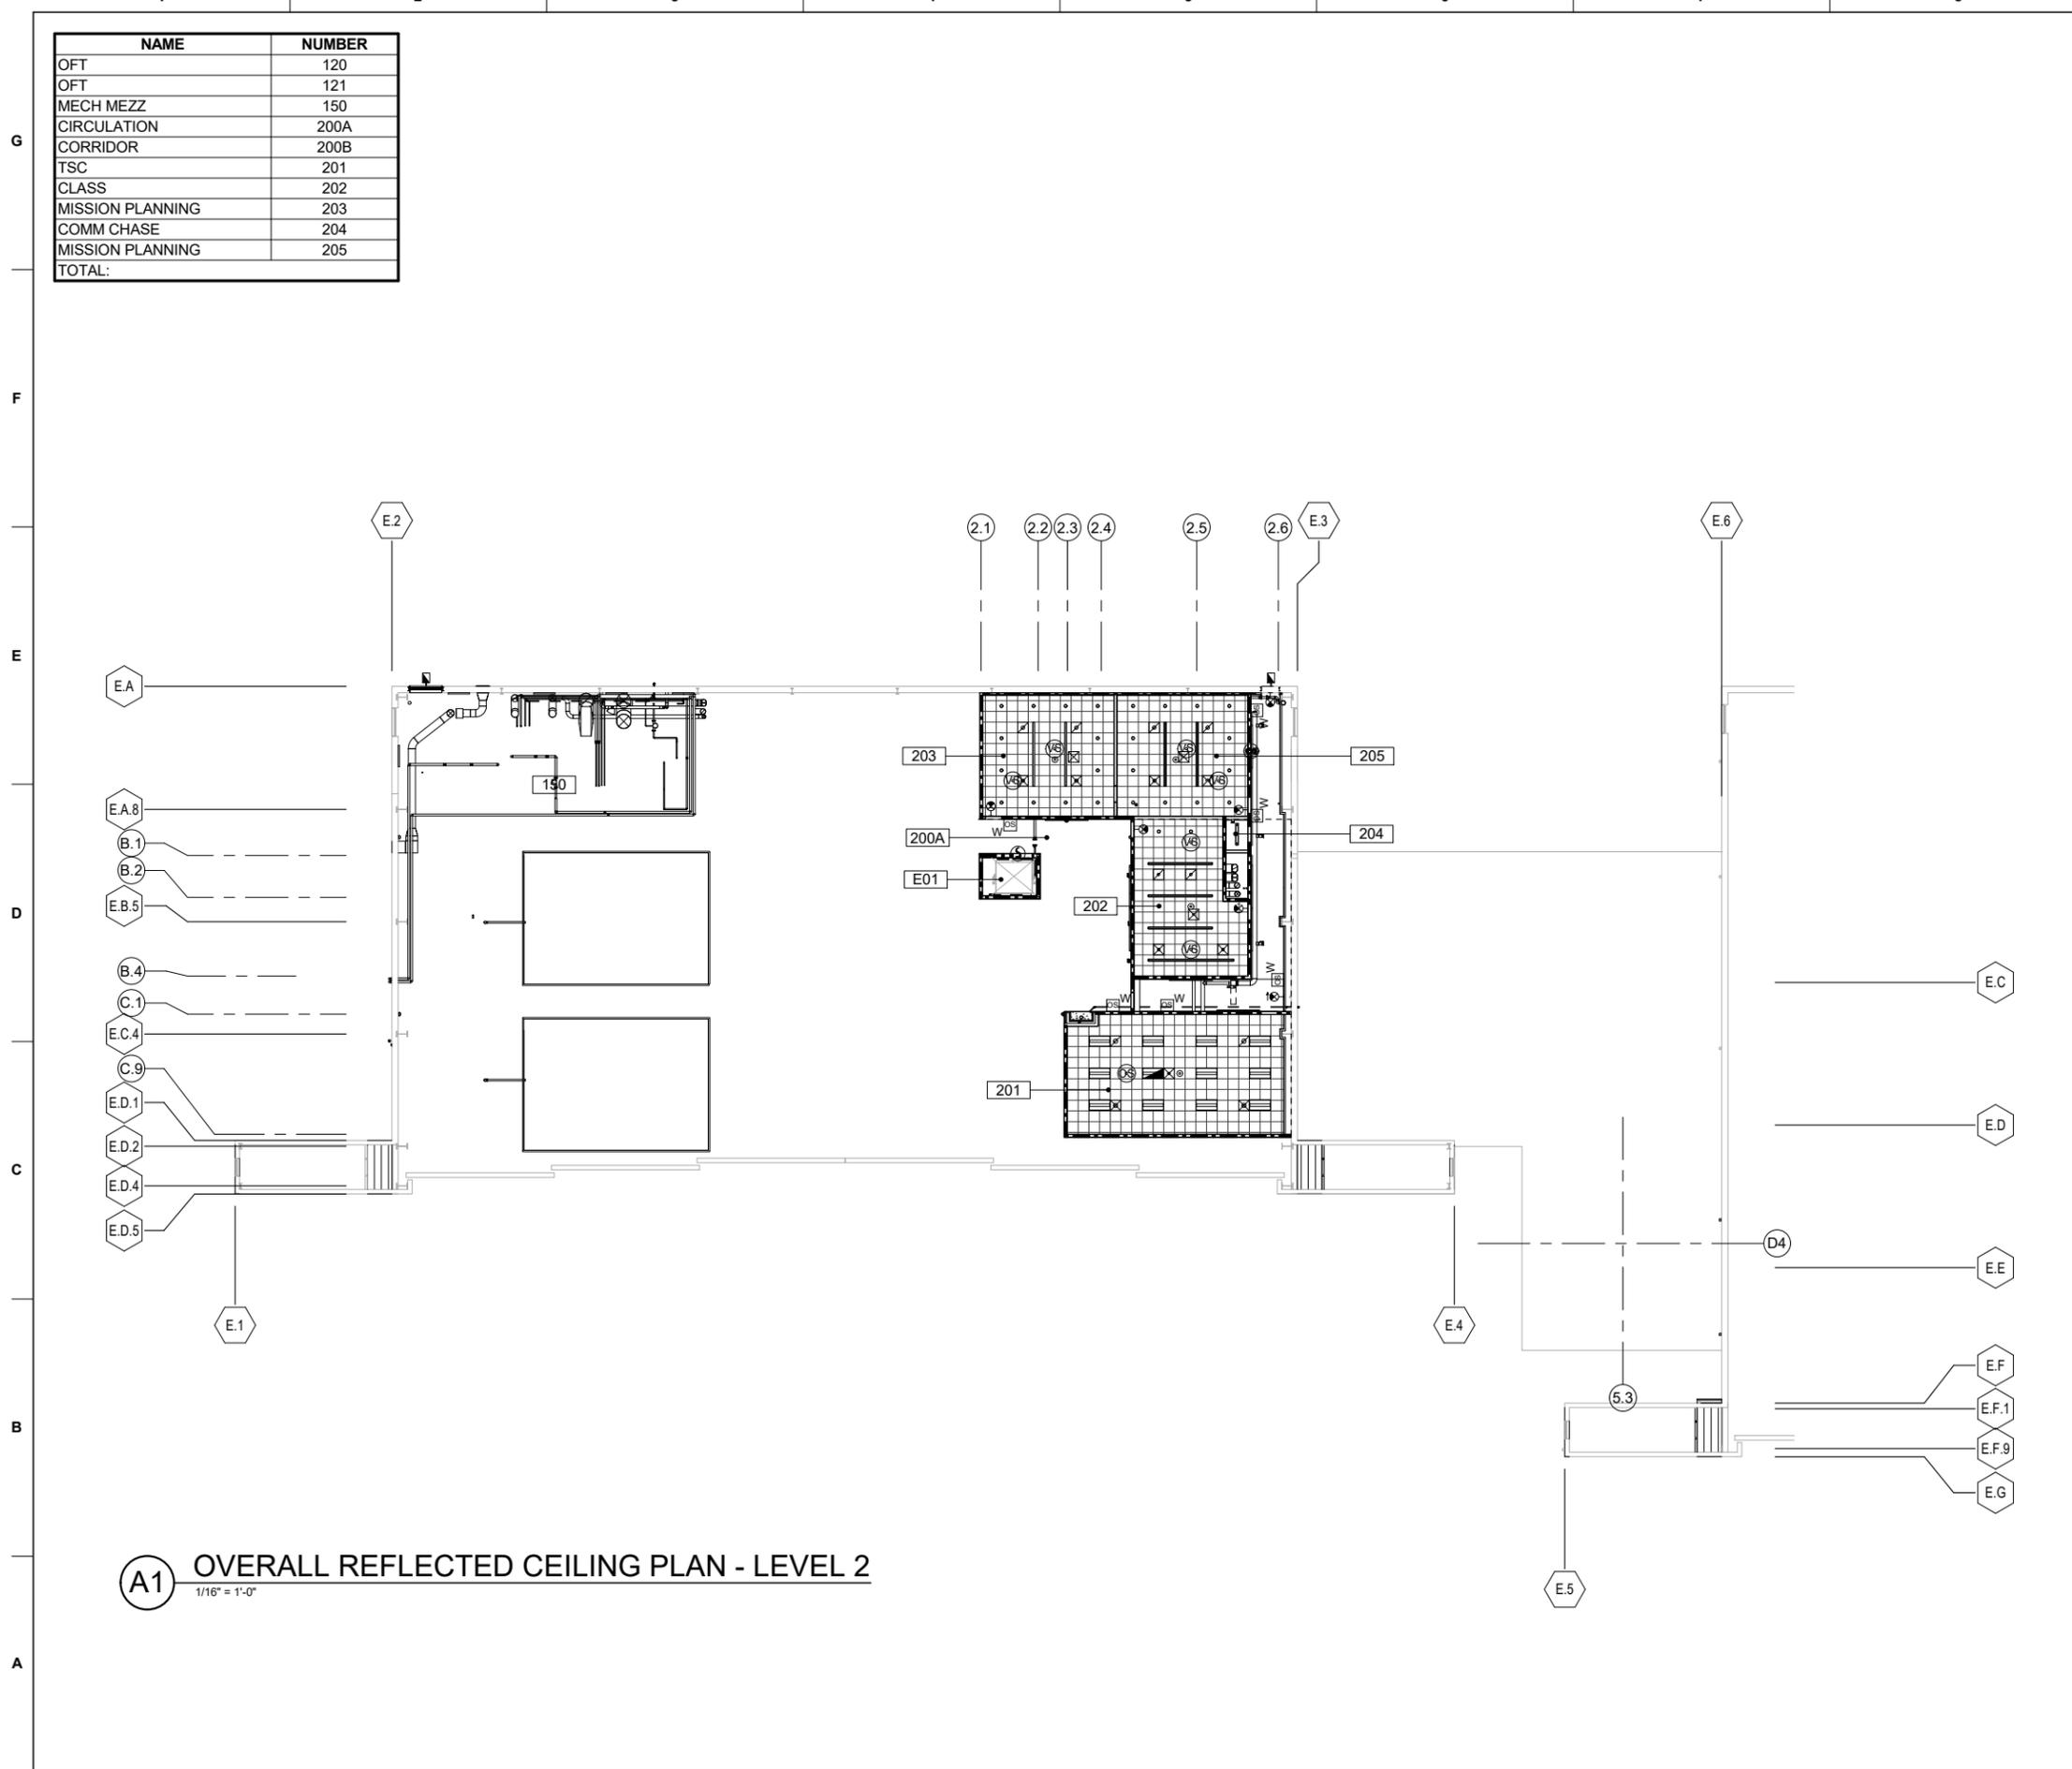


**A1** OVERALL REFLECTED CEILING PLAN - LEVEL 2  
1/16" = 1'-0"

GENERAL NOTES	
A	REFER TO AE101 THRU AE113 FOR FLOOR PLANS
B	REFER TO A-570 FOR PARTITION TYPES AND DETAILS
C	REFER TO IN101 THRU IN112 FOR FINISH PLANS. REFER TO I-602 FOR FINISH SCHEDULE
D	ALL GYPSUM BOARD AND ACOUSTICAL CEILINGS TO BE 9'-0" ABOVE FINISH FLOOR UNLESS OTHERWISE NOTED
E	PROVIDE HOLD-DOWN CLIPS AT ALL ACOUSTICAL CEILING TILE WITHIN 10'-0" OF AN EXTERIOR DOOR
F	AT CONDITIONS WHERE LIGHTS, SPRINKLERS, OR OTHER DEVICES ARE COINCIDENT ON PLAN, FIXTURES ARE AT DIFFERENT LOCATIONS. REFER TO ELECTRICAL AND FIRE PROTECTION FOR FIXTURE MOUNTING HEIGHTS
G	EXTERIOR FINISHES AT AREAS OF NEW CONSTRUCTION ARE TO MATCH THE EXISTING FINISHES; CONTACT 42 CES FOR ADDITIONAL INFORMATION
H	FIRE RATING OF THE LEVEL 2 FLOOR SLAB AND LEVEL 2 CEILINGS ARE TO MATCH THE FIRE RATING OF THE WALLS PER NFPA 101 AND TSFPEWG

KEYNOTES	

REFLECTED CEILING PLAN LEGEND	
	GYPSUM BOARD CEILING AS SCHEDULED CONTROL JOINT
	2'x2' ACOUSTICAL CEILING TILE AS SCHEDULED CENTERED IN SPACE AS INDICATED
	LINEAR SLOT DIFFUSERS
	SPRINKLERS, SMOKE DETECTORS, AND SPEAKER STROBES; REFER TO FIRE PROTECTION DRAWINGS.
	LIGHT FIXTURE; REFER TO ELECTRICAL DRAWINGS.
	OCCUPANCY/VACANCY SENSOR; REFER TO ELECTRICAL DRAWINGS.
	EXIT LIGHT FIXTURE; REFER TO ELECTRICAL DRAWINGS.
	SUPPLY AIR DIFFUSERS; REFER TO MECHANICAL DRAWINGS.
	RETURN AIR GRILLE; REFER TO MECHANICAL DRAWINGS.
	SPEAKER; REFER TO TELECOMMUNICATION DRAWINGS
	WIRELESS ACCESS POINT; REFER TO TELECOMMUNICATION DRAWINGS
	LADDER CABLE TRAY; REFER TO TELECOMMUNICATION DRAWINGS
	FIXED POSITION SECURITY CAMERA; REFER TO TELECOMMUNICATION DRAWINGS
	CEILING ACCESS PANEL

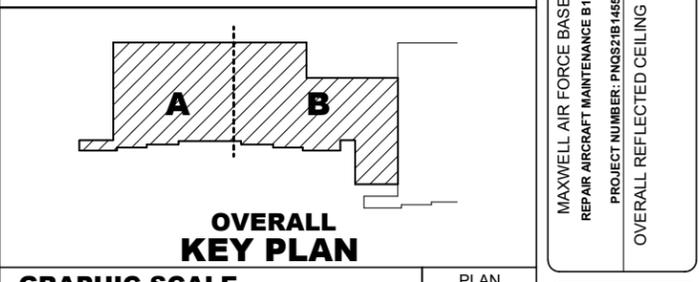

GRAPHIC SCALE	
SCALE: 1/16"=1'-0"	



MARK	DESCRIPTION	DATE


DESIGNED BY: J. PERRY	ISSUE DATE: 23 NOVEMBER 2022
DRAWN BY: D. MAXWELL	SOLICITATION NO.:
CHECKED BY: M. HOLLER	CONTRACT NO.:
SUBMITTED BY: E. OLNESS	DRAWING CODE:
SIZE: ANSI D 22x34	FILE NAME: SXHT21920/AE131

US ARMY CORPS OF ENGINEERS  
LOUISVILLE DISTRICT  
MAXWELL AIR FORCE BASE

**Jacobs**  
JACOBS ENGINEERING GROUP INC.  
777 JACOBSON BLVD  
SUITE 1000  
HOUSTON, TX 77030

MAXWELL AIR FORCE BASE, ALABAMA  
REPAIR AIRCRAFT MAINTENANCE B 1455 FOR MH-139  
PROJECT NUMBER: PNGS21B1455, P2#: 496395  
OVERALL REFLECTED CEILING PLAN - LEVEL 2

SHEET ID  
B1455  
AE131

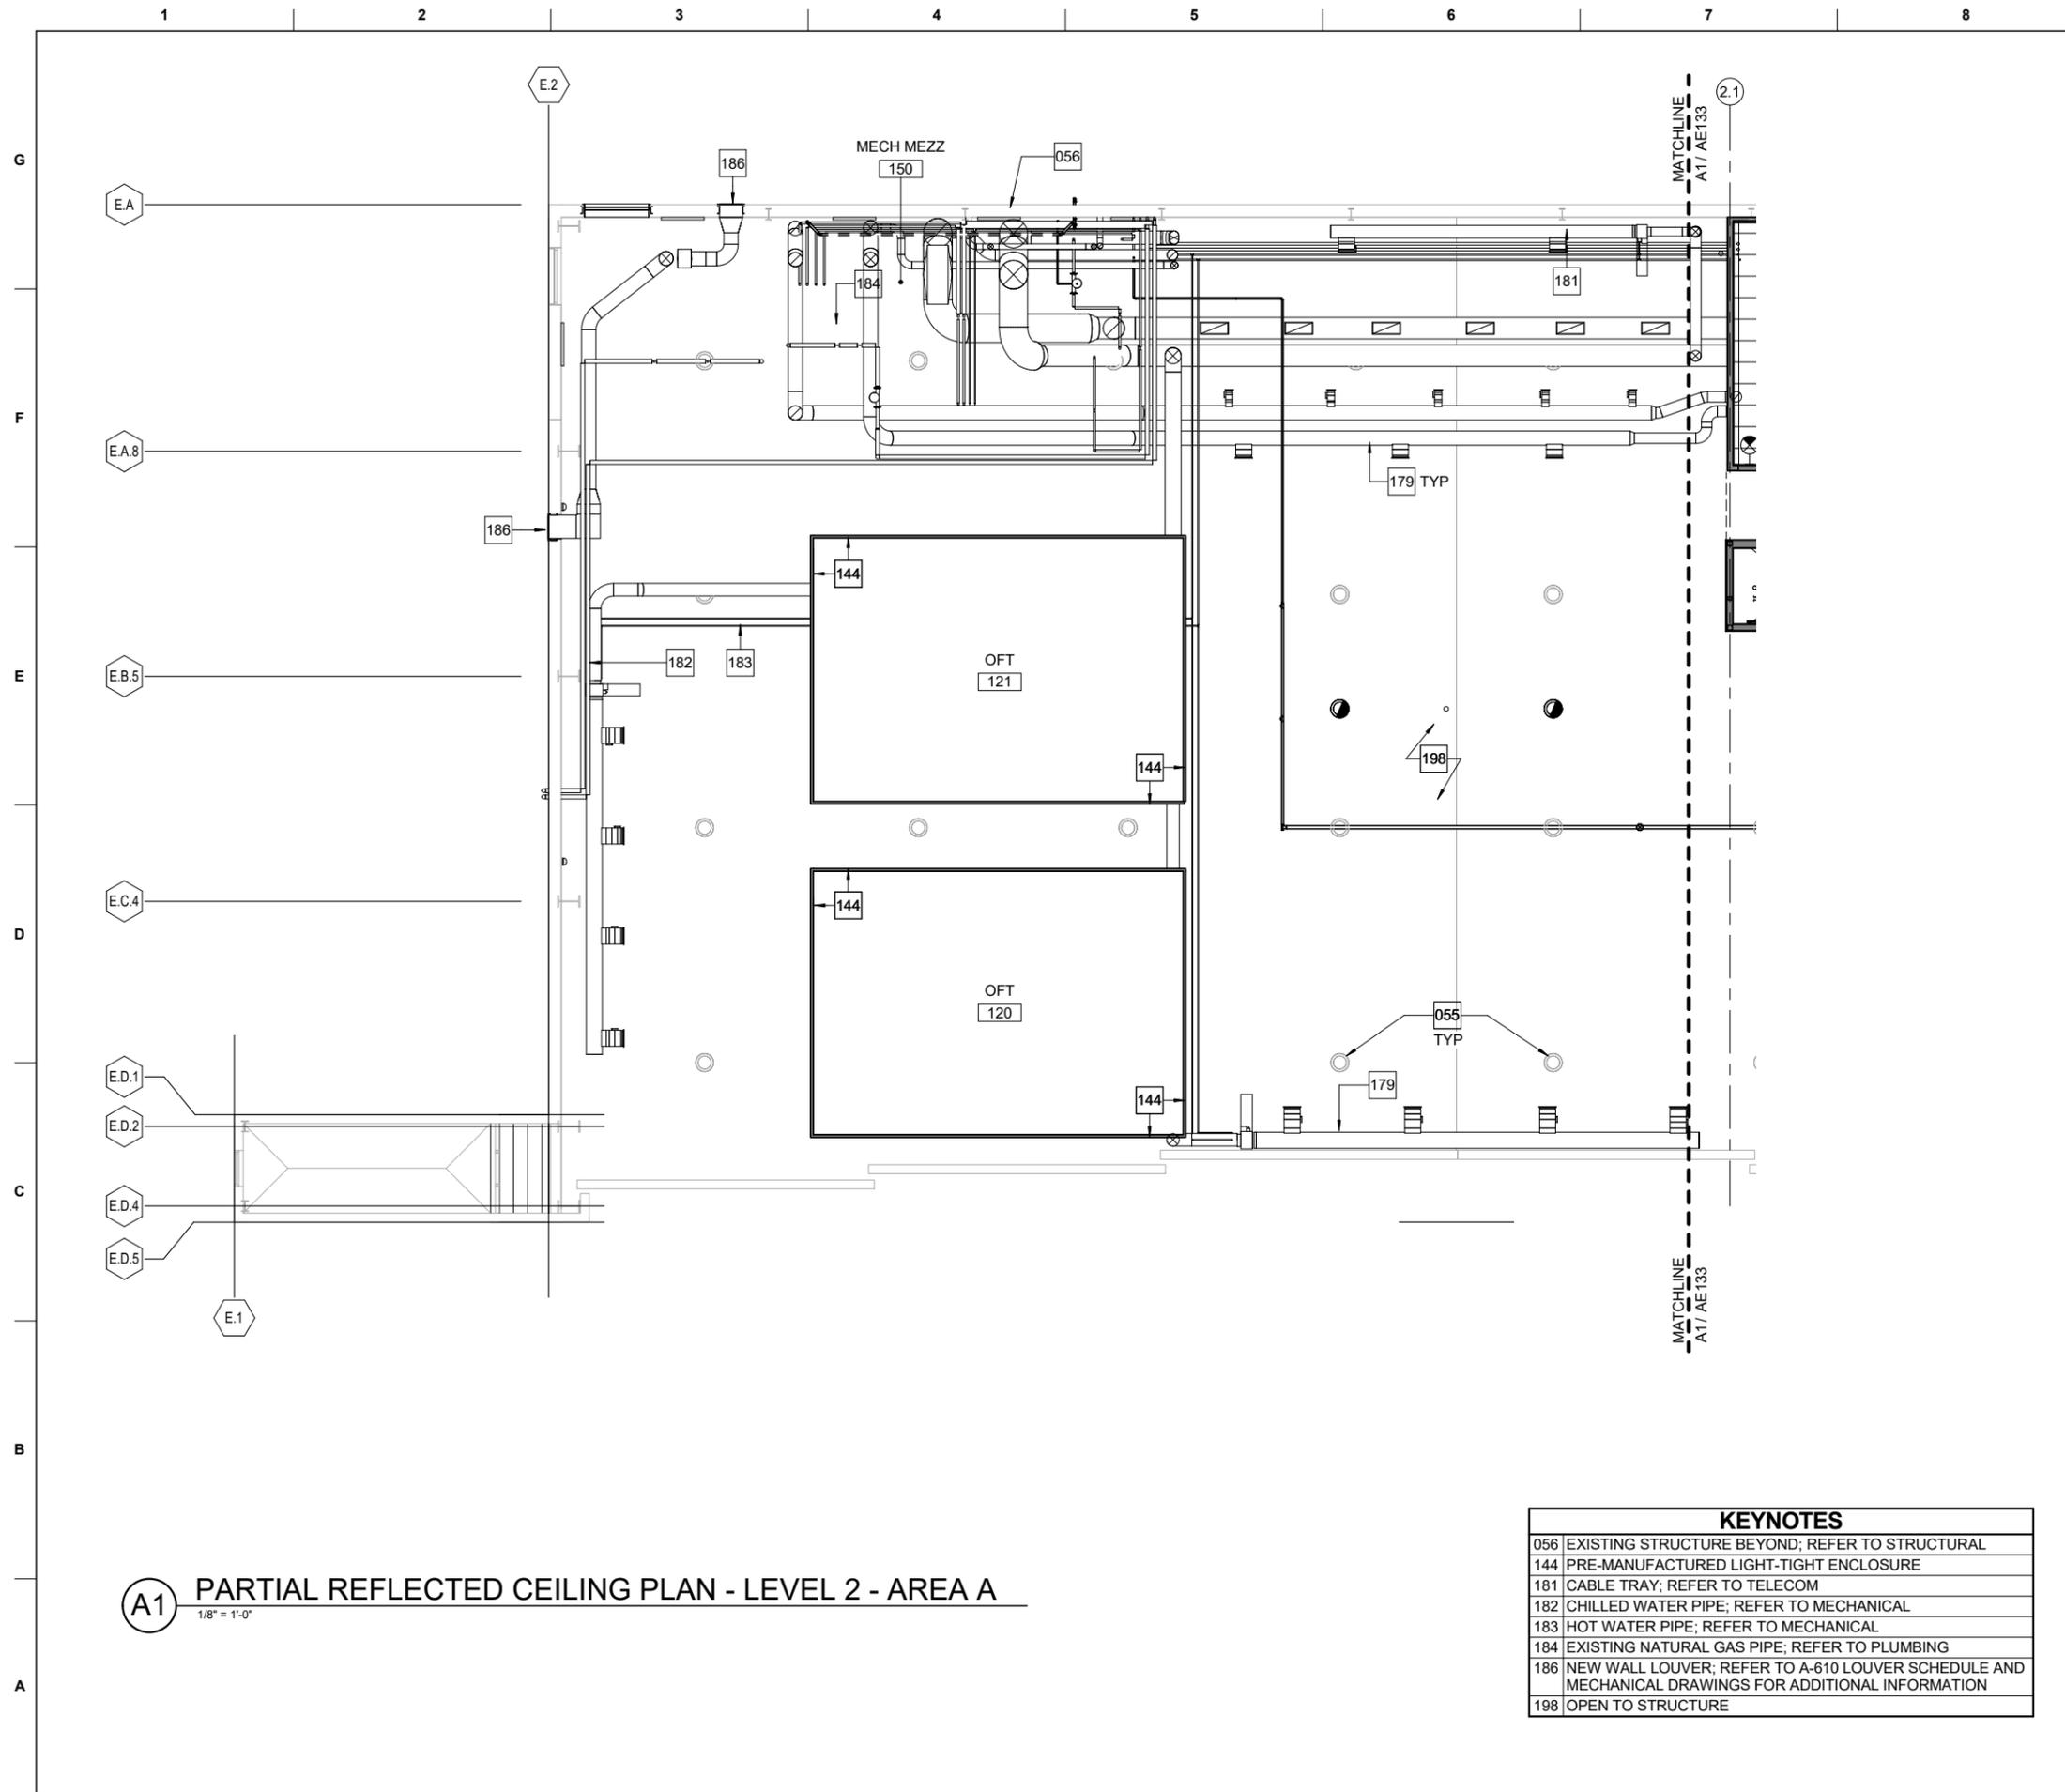

**A1** PARTIAL REFLECTED CEILING PLAN - LEVEL 2 - AREA A  
1/8" = 1'-0"

KEYNOTES	
056	EXISTING STRUCTURE BEYOND; REFER TO STRUCTURAL
144	PRE-MANUFACTURED LIGHT-TIGHT ENCLOSURE
181	CABLE TRAY; REFER TO TELECOM
182	CHILLED WATER PIPE; REFER TO MECHANICAL
183	HOT WATER PIPE; REFER TO MECHANICAL
184	EXISTING NATURAL GAS PIPE; REFER TO PLUMBING
186	NEW WALL LOUVER; REFER TO A-610 LOUVER SCHEDULE AND MECHANICAL DRAWINGS FOR ADDITIONAL INFORMATION
198	OPEN TO STRUCTURE

GENERAL NOTES	
A	REFER TO AE101 THRU AE113 FOR FLOOR PLANS
B	REFER TO A-570 FOR PARTITION TYPES AND DETAILS
C	REFER TO IN101 THRU IN112 FOR FINISH PLANS. REFER TO I-602 FOR FINISH SCHEDULE
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H	FIRE RATING OF THE LEVEL 2 FLOOR SLAB AND LEVEL 2 CEILINGS ARE TO MATCH THE FIRE RATING OF THE WALLS PER NFPA 101 AND TSFPEWG

REFLECTED CEILING PLAN LEGEND	
	GYPSUM BOARD CEILING AS SCHEDULED
	CONTROL JOINT
	2x2' ACOUSTICAL CEILING TILE AS SCHEDULED CENTERED IN SPACE AS INDICATED
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	LADDER CABLE TRAY; REFER TO TELECOMMUNICATION DRAWINGS
	FIXED POSITION SECURITY CAMERA; REFER TO TELECOMMUNICATION DRAWINGS
	CEILING ACCESS PANEL

**AREA A KEY PLAN**

**GRAPHIC SCALE**

SCALE: 1/8"=1'-0"

PLAN NORTH

SHEET ID  
**B1455**  
**AE132**

**US Army Corps of Engineers**  
Louisville District

REGISTERED ARCHITECT  
STATE OF TEXAS  
NOV 2022  
REGISTERED ENGINEERING FIRM F-2986

ISSUE DATE: 23 NOVEMBER 2022	SOLUTION NO.:	CONTRACT NO.:	DRAWING CODE:
DESIGNED BY: J. PERRY	DRAWN BY: D. WAINWRIGHT	CHECKED BY: M. HOLLER	SUBMITTED BY: E. OLNESS
FILE NAME: ANSI D 22234	FILE SIZE: 177	FILE DATE: 23 NOVEMBER 2022	FILE SIZE: 177

**JACOBS**  
JACOBS ENGINEERING GROUP, INC.  
777 JACOBS DRIVE, SUITE 100  
HOUSTON, TEXAS 77057-1399

US ARMY CORPS OF ENGINEERS  
LOUISVILLE DISTRICT  
MAXWELL AIR FORCE BASE


MAXWELL AIR FORCE BASE, ALABAMA  
REPAIR AIRCRAFT MAINTENANCE B1455 FOR MH-139  
PROJECT NUMBER: PNGS21B1455, P2#: 496395  
PARTIAL REFLECTED CEILING PLAN - LEVEL 2 - AREA A

A	REFER TO AE101 THRU AE113 FOR FLOOR PLANS
B	REFER TO A-570 FOR PARTITION TYPES AND DETAILS
C	REFER TO IN101 THRU IN112 FOR FINISH PLANS. REFER TO I-602 FOR FINISH SCHEDULE
D	ALL GYPSUM BOARD AND ACOUSTICAL CEILINGS TO BE 9'-0" ABOVE FINISH FLOOR UNLESS OTHERWISE NOTED
E	PROVIDE HOLD-DOWN CLIPS AT ALL ACOUSTICAL CEILING TILE WITHIN 10'-0" OF AN EXTERIOR DOOR
F	AT CONDITIONS WHERE LIGHTS, SPRINKLERS, OR OTHER DEVICES ARE COINCIDENT ON PLAN, FIXTURES ARE AT DIFFERENT LOCATIONS. REFER TO ELECTRICAL AND FIRE PROTECTION FOR FIXTURE MOUNTING HEIGHTS
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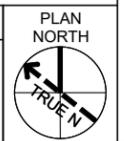
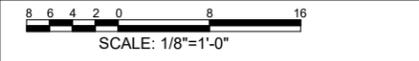


**REFLECTED CEILING PLAN LEGEND**

	GYPSUM BOARD CEILING AS SCHEDULED
	CONTROL JOINT
	2'x2' ACOUSTICAL CEILING TILE AS SCHEDULED CENTERED IN SPACE AS INDICATED
	LINEAR SLOT DIFFUSERS
	SPRINKLERS, SMOKE DETECTORS, AND SPEAKER STROBES; REFER TO FIRE PROTECTION DRAWINGS.
	LIGHT FIXTURE; REFER TO ELECTRICAL DRAWINGS.
	OCCUPANCY/VACANCY SENSOR; REFER TO ELECTRICAL DRAWINGS.
	EXIT LIGHT FIXTURE; REFER TO ELECTRICAL DRAWINGS.
	SUPPLY AIR DIFFUSERS; REFER TO MECHANICAL DRAWINGS.
	RETURN AIR GRILLE; REFER TO MECHANICAL DRAWINGS.
	SPEAKER; REFER TO TELECOMMUNICATION DRAWINGS
	WIRELESS ACCESS POINT; REFER TO TELECOMMUNICATION DRAWINGS
	LADDER CABLE TRAY; REFER TO TELECOMMUNICATION DRAWINGS
	FIXED POSITION SECURITY CAMERA; REFER TO TELECOMMUNICATION DRAWINGS
	CEILING ACCESS PANEL

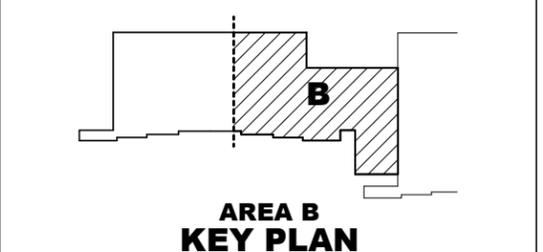

**GRAPHIC SCALE**



MARK	DESCRIPTION	DATE

ISSUE DATE: 23 NOVEMBER 2022	SOLICITATION NO.:	CONTRACT NO.:	DRAWING CODE:
DESIGNED BY: J. PERRY	DRAWN BY: D. MAXWELL	CHECKED BY: M. HOLLER	SUBMITTED BY: E. OLNESS
FILE NAME: SXHT21920/AE133	SIZE:	ANSI D 22x34	

US ARMY CORPS OF ENGINEERS  
LOUISVILLE DISTRICT  
MAXWELL AIR FORCE BASE


**Jacobs**  
JACOBS ENGINEERING GROUP, INC.  
7711 JACOBS BLVD  
SUITE 100  
FORT WORTH, TEXAS 76116

MAXWELL AIR FORCE BASE, ALABAMA  
REPAIR AIRCRAFT MAINTENANCE B1455 FOR MH-139  
PROJECT NUMBER: PNGS21B1455, P2#: 496395  
PARTIAL REFLECTED CEILING PLAN - LEVEL 2 - AREA B

SHEET ID  
B1455  
AE133

**(A1) PARTIAL REFLECTED CEILING PLAN - LEVEL 2 - AREA B**  
1/8" = 1'-0"

KEYNOTES	
055	EXISTING LIGHT FIXTURE; REFER TO ELECTRICAL
136	2" EXPANSION JOINT; REFER TO STRUCTURAL
179	EXPOSED UNFINISHED SPIRAL DUCT WITH INTERIOR LINER, PAINT SUPPORT HANGERS WHITE; REFER TO MECHANICAL
180	CEILING EXPANSION JOINT; REFER TO D4/A-510
184	EXISTING NATURAL GAS PIPE; REFER TO PLUMBING
198	OPEN TO STRUCTURE
199	CEILING FURRDOWN DETAIL, REFER TO B7/A-510
214	VERTICAL EXPANSION JOINT AT WALL

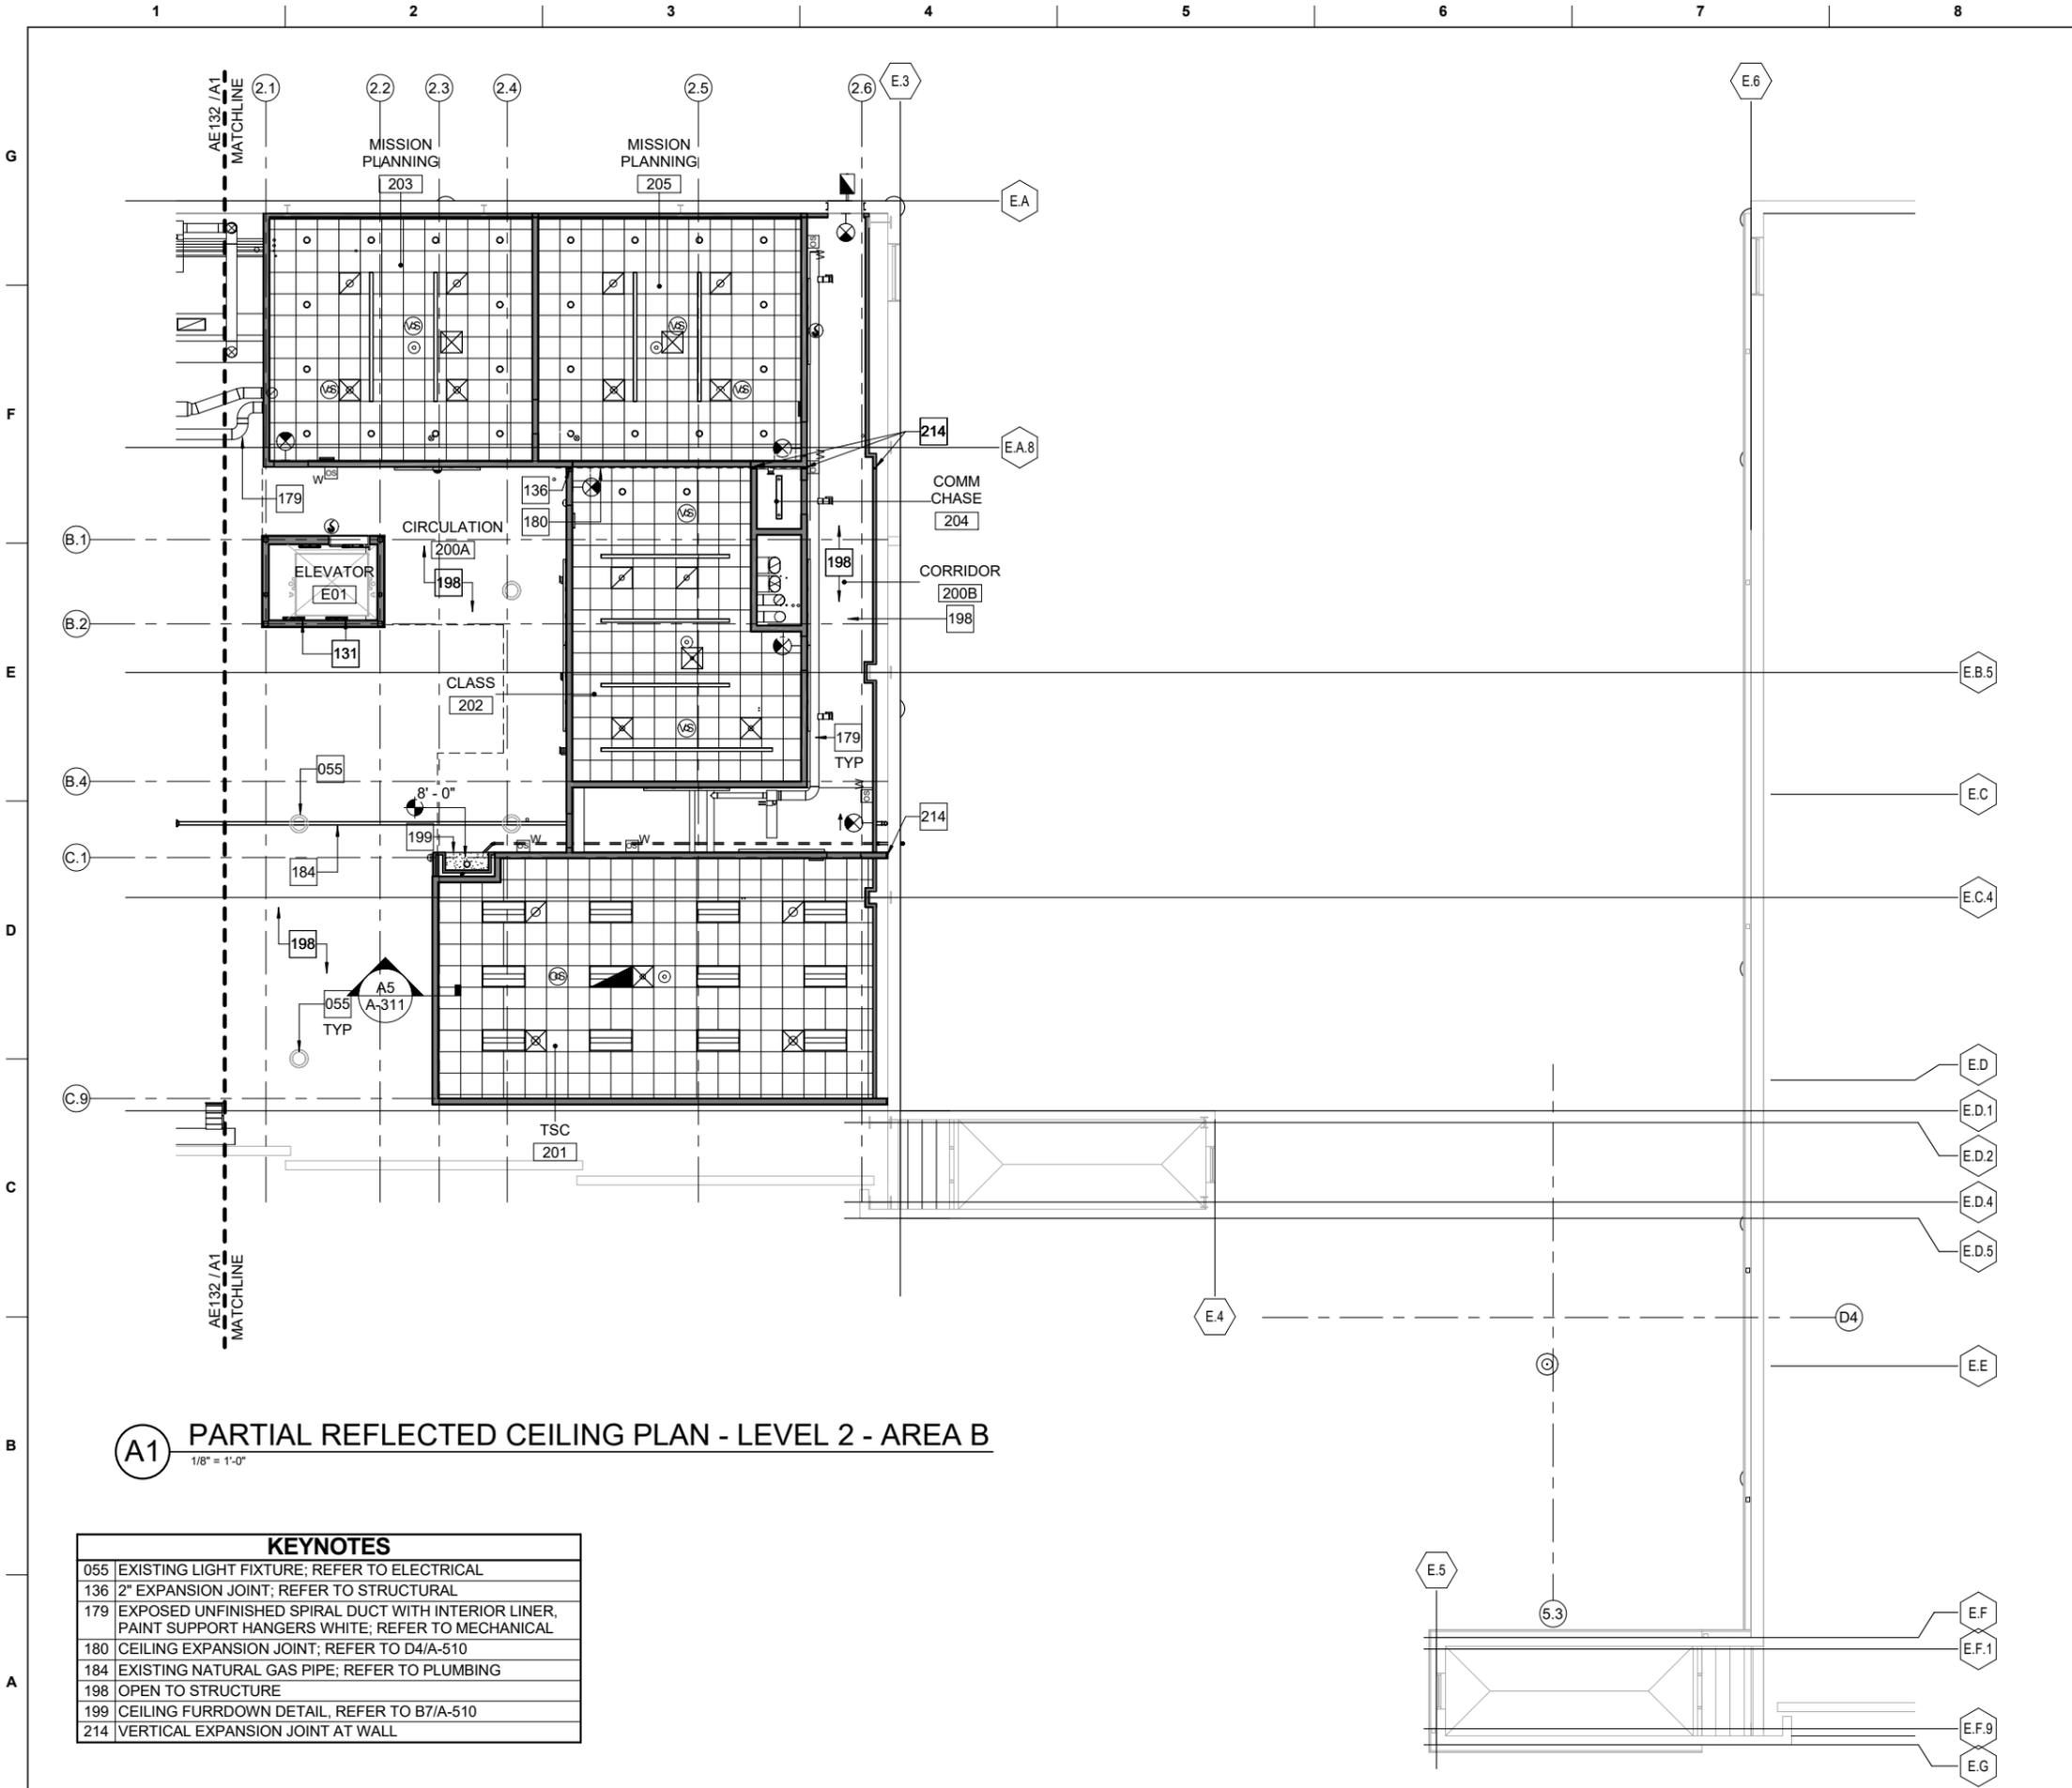

# STRUCTURAL INTERIOR DESIGN COLOR/SAMPLE BOARDS


PROJECT: REPAIR AIRCRAFT MAINTENANCE – B1455 FOR MH-139  
MAXWELL AIR FORCE BASE, ALABAMA  
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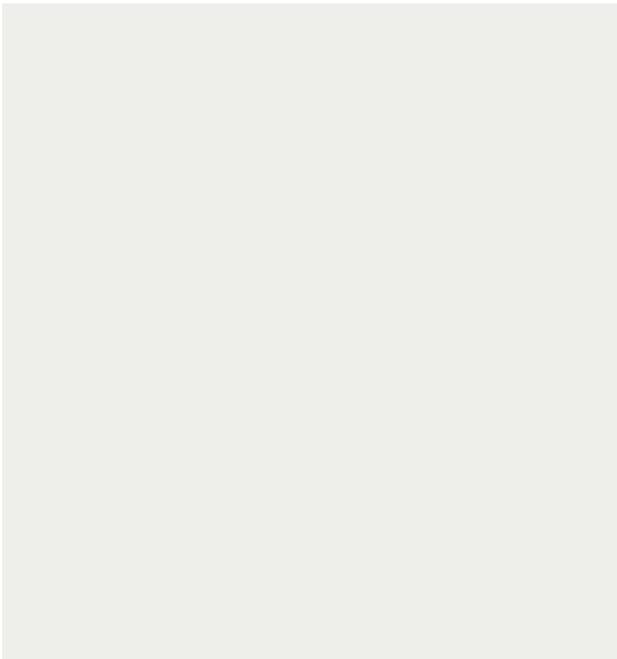
## GENERAL FINISHES - PAINT




**PT-1 PAINT – GENERAL USE**  
*BENJAMIN MOORE*  
NATURAL CREAM OC-14



**PT-2 PAINT- DOORS & TRIM, ACCENT,  
SIGNAGE BACKGROUND**  
*BENJAMIN MOORE*  
BRIARWOOD HC-175

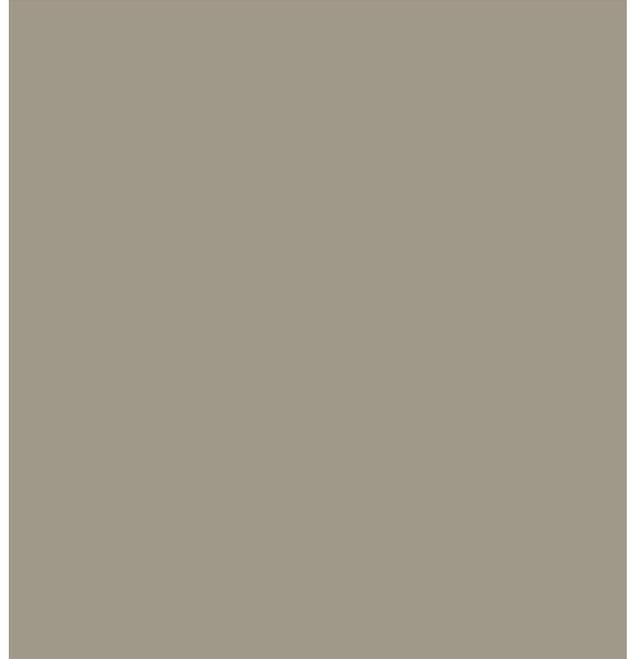

**PT-3 PAINT – HANGAR WALLS**  
*BENJAMIN MOORE*  
ICE MIST OC-67

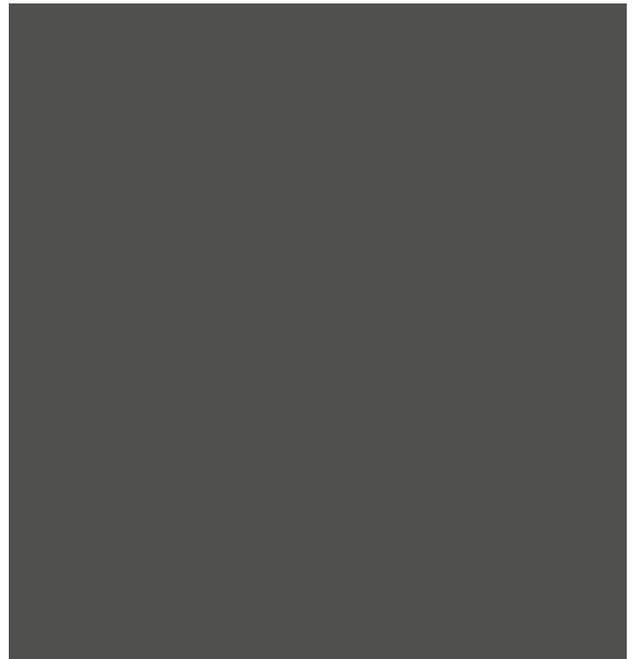


**PT-4 PAINT –STAIR ASSEMBLY**  
*BENJAMIN MOORE*  
JET BLACK 2120-10

# STRUCTURAL INTERIOR DESIGN COLOR/SAMPLE BOARDS


PROJECT: REPAIR AIRCRAFT MAINTENANCE – B1455 FOR MH-139  
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## GENERAL FINISHES - CARPET



**CPT-1 CARPET TILE**  
*MILLIKEN*  
MAJOR FREQUENCY ONE – DISTORTION  
PERCEIVE DTN218-106

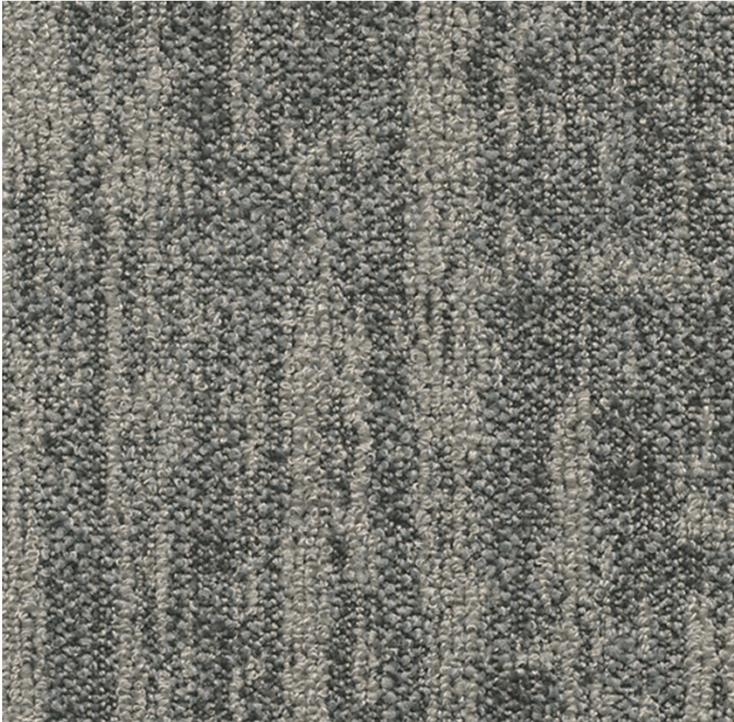

**CPT-2 CARPET TILE**  
*MILLIKEN*  
MAJOR FREQUENCY ONE – VIBRATION  
PERCEIVE VBN218-106
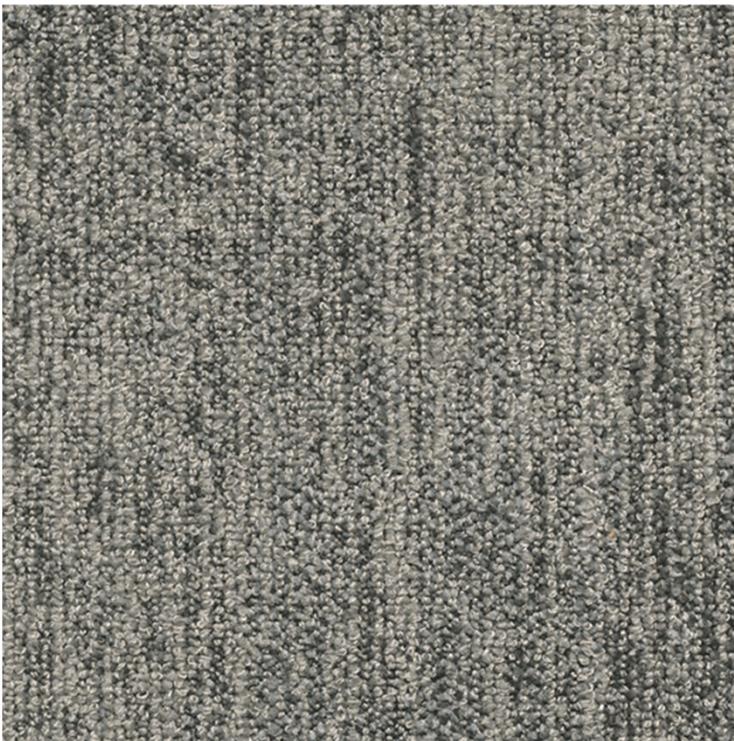
# STRUCTURAL INTERIOR DESIGN COLOR/SAMPLE BOARDS

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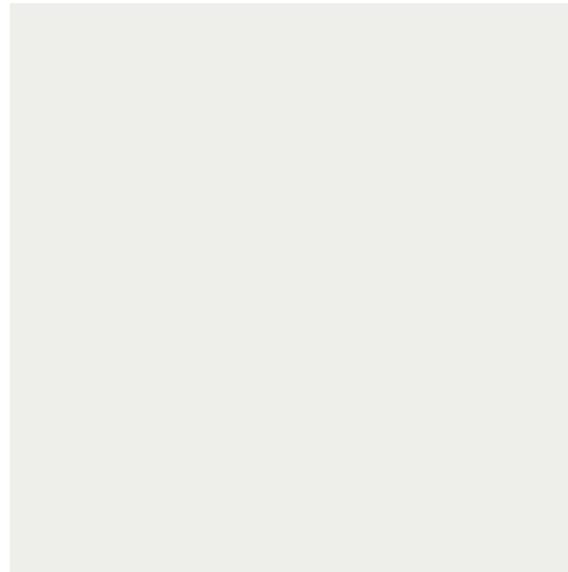
## GENERAL FINISHES - CEILING



**ACT-1 ACOUSTICAL CEILING TILE**  
*ARMSTRONG CEILINGS*  
OPTIMA TEGULAR  
WHITE



**EC-1 ELEVATOR CEILING**  
*TK ELEVATOR*  
BRUSHED STAINLESS STEEL



**GYP-1 GYPSUM BOARD CEILING**  
**OTS-1 OPEN TO STRUCTURE**  
*BENJAMIN MOORE*  
ICE MIST OC-67

# STRUCTURAL INTERIOR DESIGN COLOR/SAMPLE BOARDS

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## BREAKROOM



**LVT-1 LUXURY VINYL TILE**  
*MILLIKEN*  
FORTIFIED FOUNDATIONS 2.5MM  
CHARLOTTE CHT120



**RB-1 RESILIENT BASE**  
**RF-1 RUBBER TREADS AND RISERS**  
*TARKETT*  
TRADITIONAL WALL BASE  
BURNT UMBER 63



**PL-1 PLASTIC LAMINATE**  
*FORMICA*  
SILVER RIFTWOOD 6413-NG



**SS-1 SOLID SURFACE - COUNTERTOPS**  
*WILSONART*  
MORNING ICE 9204CE

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## RESTROOM



**PFT-1 PORCELAIN FLOOR TILE**  
*STONEPEAK*  
SIMPLY MODERN - SIMPLY GREY



**TP-1 TOILET PARTITIONS**  
*ASI GLOBAL PARTITIONS*  
SOLID PHENOLIC CORE  
FOG 3450C




**PWT-1 PORCELAIN WALL TILE**  
*STONEPEAK*  
SIMPLY MODERN - SIMPLY CREME



**GR-1 GROUT (FLOORS)**  
*LATICRETE*  
34 SANDSTONE



**GR-2 GROUT (WALLS)**  
*LATICRETE*  
89 SMOKE GREY

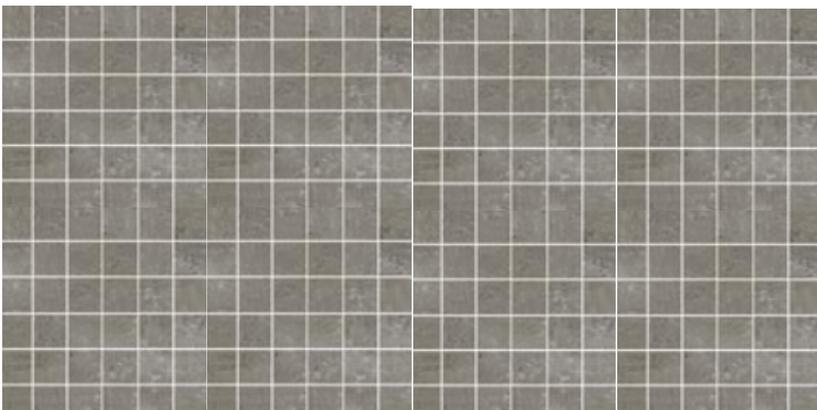

**PWT-2 PORCELAIN WALL TILE - MOSAIC**  
*STONEPEAK*  
SIMPLY MODERN - SIMPLY GREY



**CB-1 METAL COVE TRANSITION**  
*SCHLUTER*  
DILEX AHK  
SATIN ANODIZED ALUMINUM AE

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## MISCELLANEOUS




**WST-1 WOOD STAIN, INTERIOR WOOD DOORS**  
*SHERWIN WILLIAMS*  
MINWAX TINTABLE STAINS  
CLASSIC GRAY MW271



**CG-1 CORNER GUARD**  
*CS ACROVYN*  
SSM-20AN SURFACE MOUNTED  
PEARL 934



**SS-2 SOLID SURFACE – WINDOWSILLS**  
*CORIAN*  
CANVAS

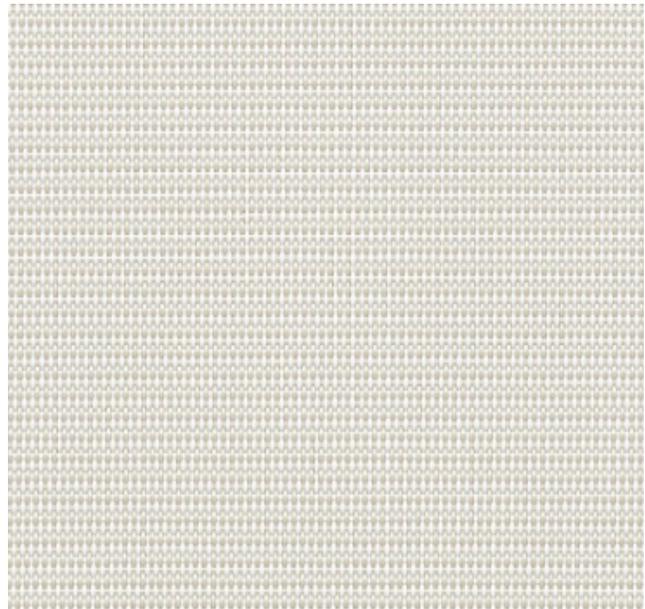

**WS-1 WINDOW SHADE**  
*MECHOSHADE*  
ECOVEIL SERIES 5% OPEN  
EGGSHELL 1366

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## MISCELLANEOUS



### EXC-1 EPOXY COVERING

TENNANT  
ECO-MPE MULTIPURPOSE EPOXY  
BATTLESHIP GRAY





### CL-1 CELL PHONE LOCKERS

SALSBURY INDUSTRIES  
SERIES 19158-25  
ALUMINUM



### FRP-1 FIBER REINFORCHED PANEL

MARLITE  
SYMMETRIX FRP  
WHITE C100-G44

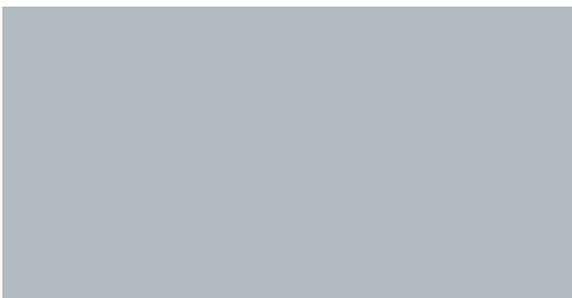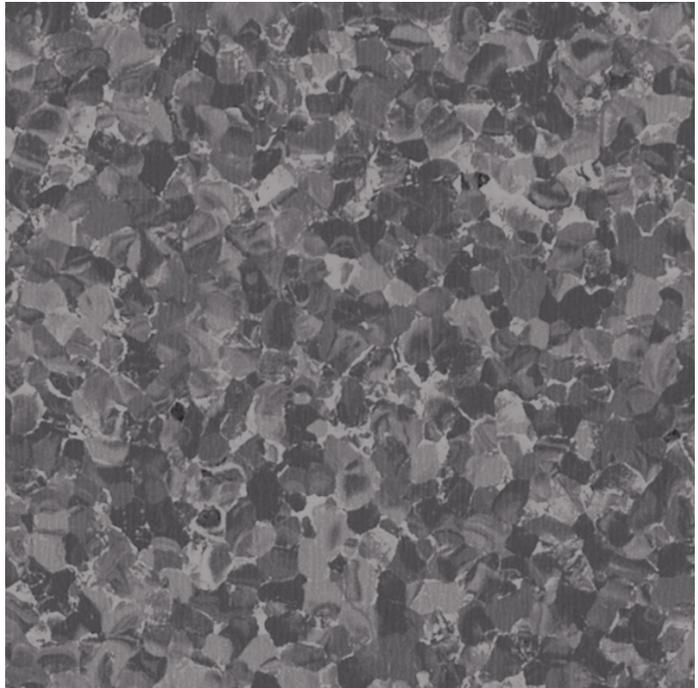

### SC-1 SEALED CONCRETE

SURECRETE  
COLORTEK 400WB  
DOVE GRAY 12

### SDT-1 STATIC DISSIPATIVE TILE

TARKETT / JOHN SHONITE  
IQ GRANIT SD TILE  
SIDEWALK 0726

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## MISCELLANEOUS



**EC-1 ELEVATOR CEILING**  
**EW-1 ELEVATOR WALL**  
*TK ELEVATOR*  
BRUSHED STAINLESS STEEL



**AWP-1 ACOUSTICAL WALL PANEL**  
*CF STINSON*  
NIKKO, SHARK NIK93



**FPF-1 FOLDING PARTITION FABRIC**  
*KOROSEAL*  
LINEAGE, PEDIGREE 9521-35