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Autosketch Docs:\Oscar G Johnson VA Medical Center\GOLARCH-1.rvt

6163.03 - NEW ROOM FINISH SCHEDULE																
FLOOR NUMBER	ROOM NUMBER	ROOM NAME	FLOOR		BASE		WAINSCOT		HEIGHT	WALL		REMARKS	REVISION			
			MATERIAL	TYPE	MATERIAL	TYPE	MATERIAL	TYPE		FINISH	FINISH TYPE					
00	B202	RELEASE OF INFO PASSAGE	LUXURY RESILIENT TILE	CP11	4" RUBBER	RB2	SHEET WALL PROTECTION	SWP1	6'-0"	GYPSUM BOARD / PATCH EXISTING / GYPSUM BOARD AT NEW	PAINT	P1				
00	B203A	PHARMACY CACHE	SEALED CONCRETE	SC1	4" RUBBER	RB2	SHEET WALL PROTECTION	SWP1	4'-4"	GYPSUM BOARD / CONCRETE BLOCK	EPOXY PAINT	EP1				
00	B203B	VAULT	SEALED CONCRETE	SC1	4" RUBBER	RB2			-	GYPSUM BOARD	EPOXY PAINT	EP1				
00	B203C	SUPPLY CHAIN STORAGE	SEALED CONCRETE	SC1	4" RUBBER	RB2	SHEET WALL PROTECTION	SWP1	6'-0"	GYPSUM BOARD / CONCRETE BLOCK	PAINT	P1				
00	B206	PASSAGE	PATCH TO MATCH VINYL COMPOSITION TILE	VC11 AS NEEDED	4" RUBBER AT NEW WALLS	RB2	SHEET WALL PROTECTION AT NEW WALLS	SWP1	6'-0"	PATCH EXISTING / GYPSUM BOARD AT NEW	PAINT AT NEW WALLS	P6	PATCH FLOOR AS REQUIRED WITH VC11			
00	B231	STORAGE LOGISTICS	-	-	-	-	-	-	-	PATCH EXISTING / GYPSUM BOARD AT NEW	PAINT AT NEW WALLS	P1				
00	B231A	MECH.	PATCH EXISTING/SEALED CONCRETE AT NEW	- , SC1	4" RUBBER AT NEW WALLS	RB2	-	-	-	PATCH EXISTING/GYPSUM BOARD AT NEW WALL	PAINT	P1				
00	B231E	ENTRY	SEALED CONCRETE	SC1	4" RUBBER	RB2	-	-	-	PATCH EXISTING / CONCRETE BLOCK AT NEW	PAINT	P1				
00	B231F	EMERGENCY DISTRIBUTION ROOM	SEALED CONCRETE	SC1	4" RUBBER	RB2	-	-	-	PATCH EXISTING / CONCRETE BLOCK AT NEW	PAINT	P1				
00	B231G	NORMAL DISTRIBUTION ROOM	SEALED CONCRETE	SC1	4" RUBBER	RB2	-	-	-	PATCH EXISTING / CONCRETE BLOCK AT NEW	PAINT	P1				
00	B231H	STORAGE	SEALED CONCRETE	SC1	4" RUBBER	RB2	-	-	-	PATCH EXISTING / CONCRETE BLOCK AT NEW	PAINT	PT1				
00	B291	SUPPLIES	PATCH TO MATCH	-	PATCH TO MATCH	-	SHEET WALL PROTECTION	SWP1	6'-0"	PATCH EXISTING / GYPSUM BOARD AT NEW	PAINT AT NEW WALLS	P1				
00	B291C	ETO	PATCH TO MATCH	-	PATCH TO MATCH	-	-	-	-	PATCH EXISTING / GYPSUM BOARD AT NEW	PAINT	P1				
00	B299A-1	CORRIDOR	PATCH TO MATCH VINYL COMPOSITION TILE	VC11 AS NEEDED	4" RUBBER AT NEW WALLS	RB2	SHEET WALL PROTECTION FOR PATCHING AND AT NEW WALLS	SWP1	6'-0"	PATCH EXISTING / GYPSUM BOARD AT NEW	PAINT FOR PATCHING AND AT NEW WALLS	P6	PATCH FLOOR AS REQUIRED WITH VC11			
01	1100	LOBBY	PATCH TO MATCH	-	PATCH TO MATCH	-	PATCH TO MATCH WOOD PANELING	-	-	PATCH EXISTING / GYPSUM BOARD AT NEW	PAINT AT NEW WALLS	P1				
01	1105	POLICE CONFERENCE / TRAINING CLOSET	CARPET TILE	CP11	4" RUBBER	RB1	-	-	-	GYPSUM BOARD	PAINT	P1, P3	SEE SHEET 102K FOR PAINT LOCATIONS			
01	1107	EQUIPMENT STORAGE	VINYL COMPOSITION TILE	PATCH TO MATCH	4" RUBBER AT NEW WALLS	RB1	SHEET WALL PROTECTION	SWP1	4'-4"	PATCH EXISTING / GYPSUM BOARD AT NEW	PAINT	P1				
01	1201	POLICE VESTIBULE EQUIP / EVIDENCE	LUXURY RESILIENT TILE	LRT3	4" RUBBER	RB1	SHEET WALL PROTECTION	SWP1	4'-4"	GYPSUM BOARD / GYPSUM BOARD AT NEW	PAINT	P1, P3	SEE SHEET 102K FOR PAINT LOCATIONS			
01	1201A		LUXURY RESILIENT TILE	LRT3	4" RUBBER	RB1	SHEET WALL PROTECTION	SWP1	4'-4"	GYPSUM BOARD / GYPSUM BOARD AT NEW	PAINT	P1				
01	1201B	OPERATIONS	CARPET TILE	CP11	4" RUBBER	RB1	-	-	-	GYPSUM BOARD	PAINT	P1, P3	SEE SHEET 102K FOR PAINT LOCATIONS			
01	1202	PASSAGE	LUXURY RESILIENT TILE	LRT3	4" RUBBER	RB1	-	-	-	GYPSUM BOARD	PAINT	P1				
01	1202A	HOLDING	PEDESTRIAN TRAFFIC COATING	PTC1	6" INTEGRAL PEDESTRIAN TRAFFIC COATING FLOORING	PTC1	-	-	-	CONCRETE BLOCK	EPOXY PAINT	EP1				
01	1202B	WEAPONS	LUXURY RESILIENT TILE	LRT3	4" RUBBER	RB1	SHEET WALL PROTECTION	SWP1	4'-4"	GYPSUM BOARD	PAINT	P1				
01	1202C	CHIEF, POLICE	CARPET TILE	CP11	4" RUBBER	RB1	-	-	-	GYPSUM BOARD	PAINT	P1, P4	SEE SHEET 102K FOR PAINT LOCATIONS			
01	1202D	SHARED WORKSTATIONS	CARPET TILE	CP11	4" RUBBER	RB1	-	-	-	PATCH EXISTING / GYPSUM BOARD AT NEW	PAINT	P1, P4	SEE SHEET 102K FOR PAINT LOCATIONS			
01	1202E	OFFICE	CARPET TILE	CP11	4" RUBBER	RB1	-	-	-	PATCH EXISTING / GYPSUM BOARD AT NEW	PAINT	P1, P4	SEE SHEET 102K FOR PAINT LOCATIONS			
01	1203	KITCHENETTE	LUXURY RESILIENT TILE	LRT3	4" RUBBER	RB1	-	-	-	GYPSUM BOARD	PAINT	P1, P3	SEE SHEET 102K FOR PAINT LOCATIONS			
01	1203A	MALE LOCKERS	12" x 12" PORCELAIN TILE	PP13	4" X 16" CERAMIC TILE	CWT1	-	-	-	GYPSUM BOARD	EPOXY PAINT	EP1				
01	1203B	MALE TOILET	6" X 6" PORCELAIN TILE	PP12	PART OF WAINSCOT	CWT1	4" X 16" CERAMIC TILE	CWT1	6'-4"	GYPSUM BOARD	EPOXY PAINT	EP1				
01	1203C	FEMALE LOCKERS	12" x 12" PORCELAIN TILE	PP13	4" X 16" CERAMIC TILE	CWT1	-	-	-	GYPSUM BOARD	EPOXY PAINT	EP1				
01	1203D	FEMALE TOILET	6" X 6" PORCELAIN TILE	PP12	PART OF WAINSCOT	CWT1	4" X 16" CERAMIC TILE	CWT1	6'-4"	GYPSUM BOARD	EPOXY PAINT	EP1				
01	1221	LOUNGE	SHEET RUBBER	SR1	4" RUBBER	RB1	-	-	-	PATCH EXISTING / GYPSUM BOARD AT NEW	PAINT	P1				
01	1222	PHARMACY SUPPLY	SHEET RUBBER	SR1	4" RUBBER	RB1	SHEET WALL PROTECTION	SWP1	4'-4"	PATCH EXISTING / GYPSUM BOARD AT NEW	PAINT	P1				
01	1223	PASSAGE	SHEET RUBBER	SR1	4" RUBBER	RB1	-	-	-	PATCH EXISTING / GYPSUM BOARD AT NEW	PAINT	P1				
01	1224	PASSAGE	SHEET RUBBER	SR1	4" RUBBER	RB1	-	-	-	PATCH EXISTING / GYPSUM BOARD AT NEW	PAINT	P1, P4	SEE SHEET 102K FOR PAINT LOCATIONS			
01	1224A	COAT ROOM	SHEET RUBBER	SR1	4" RUBBER	RB1	-	-	-	PATCH EXISTING / GYPSUM BOARD AT NEW	PAINT	P1				
01	1224B	TOILET	12" x 12" PORCELAIN TILE	PP11	4" X 16" CERAMIC TILE	CWT1	4" X 16" CERAMIC TILE	CWT1	5'-4"	GYPSUM BOARD	PAINT, FULL HEIGHT CERAMIC TILE AT FIXTURE WALLS	P1, CWT1				
01	1225	PHARMACY INVENTORY	SHEET RUBBER	SR1	4" RUBBER	RB1	-	-	-	PATCH EXISTING / GYPSUM BOARD AT NEW	PAINT	P1				
01	1226	PROCUREMENT	SHEET RUBBER	SR1	4" RUBBER	RB1	-	-	-	PATCH EXISTING / GYPSUM BOARD AT NEW	PAINT	P1, P4	SEE SHEET 102K FOR PAINT LOCATIONS			
01	1227	PHARMACY PREP	SHEET RUBBER	SR1	4" RUBBER	RB1	-	-	-	PATCH EXISTING / GYPSUM BOARD AT NEW	PAINT	P1				
01	1229	OFFICE	SHEET RUBBER	SR1	4" RUBBER	RB1	-	-	-	GYPSUM BOARD	PAINT	P1, P4	SEE SHEET 102K FOR PAINT LOCATIONS			
01	1230	OFFICE	SHEET RUBBER	SR1	4" RUBBER	RB1	-	-	-	GYPSUM BOARD	PAINT	P1, P4	SEE SHEET 102K FOR PAINT LOCATIONS			
01	1231	OFFICE	SHEET RUBBER	SR1	4" RUBBER	RB1	-	-	-	GYPSUM BOARD	PAINT	P1, P4	SEE SHEET 102K FOR PAINT LOCATIONS			
01	1232	OFFICE	SHEET RUBBER	SR1	4" RUBBER	RB1	-	-	-	GYPSUM BOARD	PAINT	P1, P4	SEE SHEET 102K FOR PAINT LOCATIONS			
01	1233	IV ROOM	SHEET RUBBER	SR1	INTEGRAL SHEET RUBBER	SR1	-	-	-	PATCH EXISTING / GYPSUM BOARD AT NEW	RESINOUS COATING SYSTEM PATCH TO MATCH/RES1 AT NEW WALLS	SEE SHEET 102K FOR PAINT LOCATIONS				
01	1233A	HAZARD HOOD ROOM	SHEET RUBBER	SR1	INTEGRAL SHEET RUBBER	SR1	-	-	-	PATCH EXISTING / GYPSUM BOARD AT NEW	RESINOUS COATING SYSTEM	RES1				
01	1234	ADMIN	SHEET RUBBER	SR1	4" RUBBER	RB1	-	-	-	PATCH EXISTING / GYPSUM BOARD AT NEW	PAINT	P1, P4	SEE SHEET 102K FOR PAINT LOCATIONS			
01	1234A	PHARMACY CHIEF	SHEET RUBBER	SR1	4" RUBBER	RB1	-	-	-	PATCH EXISTING / GYPSUM BOARD AT NEW	PAINT	P1, P4	SEE SHEET 102K FOR PAINT LOCATIONS			
01	1235	CHEMO PHARM. OFFICE	SHEET RUBBER	SR1	4" RUBBER	RB1	-	-	-	PATCH EXISTING / GYPSUM BOARD AT NEW	PAINT	P1, P4	SEE SHEET 102K FOR PAINT LOCATIONS			
01	1236	SEGREG. COMPOUND ROOM	SHEET RUBBER	SR1, SR2	INTEGRAL SHEET RUBBER	SR1	-	-	-	PATCH EXISTING / GYPSUM BOARD AT NEW	PAINT	P1	SEE SHEET 101K FOR FLOOR PATTERN			
01	1237	OFFICES	SHEET RUBBER	SR1	4" RUBBER	RB1	-	-	-	PATCH EXISTING / GYPSUM BOARD AT NEW	PAINT	P1, P4	SEE SHEET 102K FOR PAINT LOCATIONS			
01	1244	PASSAGE	WALK-OFF CARPET TILE	WCPT1	4" RUBBER	RB1	SHEET WALL PROTECTION	SWP1	4'-4"	GYPSUM BOARD	PAINT	P1				
01	1245	VOLUNTEER AREA	PATCH TO MATCH	-	PATCH TO MATCH	-	-	-	-	PATCH EXISTING / GYPSUM BOARD AT NEW	PAINT AT NEW WALLS	P1				
01	1246	ALCOVE	LUXURY RESILIENT TILE	LRT2	4" RUBBER	RB1	-	-	-	PATCH EXISTING / GYPSUM BOARD AT NEW	PAINT	P1, P2	SEE SHEET 102K FOR PAINT LOCATIONS			
01	1247	PASSAGE	LUXURY RESILIENT TILE	LRT1	4" RUBBER	RB1	-	-	-	GYPSUM BOARD	PAINT	P1, P2	SEE SHEET 102K FOR PAINT LOCATIONS			
01	1247A	MRI WAIT	LUXURY RESILIENT TILE	LRT1	4" RUBBER	RB1	-	-	-	GYPSUM BOARD	PAINT	P1, P2	SEE SHEET 102K FOR PAINT LOCATIONS			
01	1247B	DRESS	LUXURY RESILIENT TILE	LRT1	4" RUBBER	RB1	-	-	-	GYPSUM BOARD	PAINT	P1				
01	1247C	PATIENT TOILET	12" x 12" PORCELAIN TILE	PP11	4" X 16" CERAMIC TILE	CWT1	4" X 16" CERAMIC TILE	CWT1	5'-4"	GYPSUM BOARD	PAINT, FULL HEIGHT CERAMIC TILE AT FIXTURE WALLS	P1, CWT1				
01	1247D	DRESS	LUXURY RESILIENT TILE	LRT1	4" RUBBER	RB1	SHEET WALL PROTECTION	SWP1	4'-4"	GYPSUM BOARD	PAINT	P1				
01	1248	HOLDING BAY	LUXURY RESILIENT TILE	LRT1	4" RUBBER	RB1	SHEET WALL PROTECTION	SWP1	4'-4"	GYPSUM BOARD	PAINT	P1				
01	1249	PASSAGE	LUXURY RESILIENT TILE	LRT1	4" RUBBER	RB1	SHEET WALL PROTECTION	SWP1	4'-4"	GYPSUM BOARD	PAINT / WALL COVERING	P1, WC1	SEE SHEET 102K FOR WALL COVERING LOCATION			
01	1249A	WORK	LUXURY RESILIENT TILE	LRT1	4" RUBBER	RB1	SHEET WALL PROTECTION	SWP1	4'-4"	GYPSUM BOARD	PAINT	P1				
01	1249B	STAFF TOILET	12" x 12" PORCELAIN TILE	PP11	4" X 16" CERAMIC TILE	CWT1	4" X 16" CERAMIC TILE	CWT1	5'-4"	GYPSUM BOARD	PAINT, FULL HEIGHT CERAMIC TILE AT FIXTURE WALLS	P1, CWT1				
01	1250	VESTIBULE	LUXURY RESILIENT TILE	LRT1	4" RUBBER	RB1	SHEET WALL PROTECTION	SWP1	4'-4"	GYPSUM BOARD	PAINT	P1				
01	1250A	MRI EQUIPMENT	STATIC DISSIPATIVE SHEET VINYL	SDSV1	4" RUBBER	RB1	-	-	-	GYPSUM BOARD	PAINT	P1				
01	1250B	CONTROL	LUXURY RESILIENT TILE	LRT1	4" RUBBER	RB1	-	-	-	GYPSUM BOARD	PAINT	P1				
01	1250C	MRI	STATIC DISSIPATIVE SHEET VINYL	SDSV1	4" RUBBER	RB1	-	-	-	GYPSUM BOARD	PAINT	P2				
01	1250E	CLOSET	STATIC DISSIPATIVE SHEET VINYL	SDSV1	4" RUBBER	RB1	-	-	-	GYPSUM BOARD	PAINT	P1				
01	1299A	CORRIDOR	PATCH TO MATCH	-	PATCH TO MATCH	-	-	-	-	PATCH EXISTING / GYPSUM BOARD AT NEW	PAINT AT NEW WALLS	P1				
01	1300	WAITING AREA	PATCH TO MATCH	-	PATCH TO MATCH	-	-	-	-	PATCH EXISTING / GYPSUM BOARD AT NEW	PAINT AT NEW WALLS	P1				
01	C1-02	CORRIDOR	PATCH TO MATCH	-	-	-	-	-	-	-	-	-				
02	2203	ENDOSCOPY	PATCH TO MATCH	-	PATCH TO MATCH	-	-	-	-	PATCH EXISTING / GYPSUM BOARD AT NEW	PAINT AT NEW WALLS	PAINT TO MATCH EXISTING				
02	2204	ENDOSCOPY	PATCH TO MATCH	-	PATCH TO MATCH	-	-	-	-	PATCH EXISTING / GYPSUM BOARD AT NEW	PAINT AT NEW WALLS	PAINT TO MATCH EXISTING				
02	2205	CYSTOSCOPY	PATCH TO MATCH	-	PATCH TO MATCH	-	-	-	-	PATCH EXISTING / GYPSUM BOARD AT NEW	PAINT AT NEW WALLS	PAINT TO MATCH EXISTING				
02	2236	TECH WORK ROOM	PATCH TO MATCH	-	PATCH TO MATCH	-	PATCH TO MATCH	-	-	PATCH EXISTING / GYPSUM BOARD AT NEW	PAINT AT NEW WALLS	PAINT TO MATCH EXISTING				
02	2236A	PENTHOUSE	PEDESTRIAN TRAFFIC COATING	PTC1	INTEGRAL PEDESTRIAN TRAFFIC COATING FLOORING	PTC1	-	-	-	EXISTING / CONCRETE BLOCK OR GYPSUM BOARD AT NEW	PAINT	PAINT TO MATCH EXISTING				
02	2237	ULTRASOUND	PATCH TO MATCH	-	PATCH TO MATCH	-	PATCH TO MATCH	-	-	PATCH EXISTING / GYPSUM BOARD AT NEW	PAINT AT NEW WALLS	PAINT TO MATCH EXISTING				
02	2237A	PENTHOUSE	PEDESTRIAN TRAFFIC COATING	PTC1	INTEGRAL PEDESTRIAN TRAFFIC COATING FLOORING	PTC1	-	-	-	EXISTING / CONCRETE BLOCK OR GYPSUM BOARD AT NEW	PAINT	PAINT TO MATCH EXISTING				
02	2238	STRESS TEST	PATCH TO MATCH	-	PATCH TO MATCH	-	PATCH TO MATCH	-	-	PATCH EXISTING / GYPSUM BOARD AT NEW	PAINT AT NEW WALLS	PAINT TO MATCH EXISTING				
02	2241	ULTRASOUND	PATCH TO MATCH	-	PATCH TO MATCH	-	PATCH TO MATCH	-	-	PATCH EXISTING / GYPSUM BOARD AT NEW	PAINT AT NEW WALLS	PAINT TO MATCH EXISTING				
02	2247	PATIENT TOILET	PATCH TO MATCH	-	PATCH TO MATCH	-	PATCH TO MATCH	-	-	PATCH EXISTING / GYPSUM BOARD AT NEW	PAINT AT NEW WALLS	PAINT TO MATCH EXISTING				
02	2256	CT SCAN	SHEET VINYL	PATCH TO MATCH	INTEGRAL BASE	PATCH TO MATCH	-	-	-	PATCH EXISTING / GYPSUM BOARD AT NEW	PAINT AT NEW WALLS	PAINT TO MATCH EXISTING				
02	2257	CT SCAN CONTROL	SHEET VINYL	PATCH TO MATCH	INTEGRAL BASE	PATCH TO MATCH	-	-	-	PATCH EXISTING / GYPSUM BOARD AT NEW	PAINT AT NEW WALLS	PAINT TO MATCH EXISTING				
02	2378	MEETING ROOM	EXISTING CARPET	-	4" RUBBER	PATCH TO MATCH	-	-	-	PATCH EXISTING / GYPSUM BOARD AT NEW	EXISTING VINYL WALL COVERING / PAINT	PAINT TO MATCH EXISTING				
02	2384	WAITING AREA	EXISTING CARPET	-	EXISTING RUBBER BASE	-	-	-	-	PATCH EXISTING / GYPSUM BOARD AT NEW	PAINT AT NEW WALLS	PAINT TO MATCH EXISTING				
03	1107M	STAIR 3	PATCH TO MATCH	-	PATCH TO MATCH	-	-	-	-	PATCH EXISTING / GYPSUM BOARD AT NEW	PAINT AT NEW WALLS	PAINT TO MATCH EXISTING				
03	3332	ELECTRICAL PENTHOUSE	PEDESTRIAN TRAFFIC COATING	PTC1	INTEGRAL PEDESTRIAN TRAFFIC COATING FLOORING	PTC1	-	-	-	GYPSUM BOARD	PAINT	PT1				

FINISH LEGEND

03 35 00 SEALED CONCRETE FINISHING
SC1 PROSCOCO, CONSOLIDECK LS
06 20 00 FINISH CARPENTRY
SOLID SURFACE WINDOW SILLS: SS2 CORIAN BONE
07 18 13 PEDESTRIAN TRAFFIC COATINGS
PTC1 DEX-O-TEX BARRIER GUARD BASE, RESISTITE WITH AJ-44 URETHANE TOPCOAT, GREY

08 14 00 INTERIOR WOOD DOORS
GRADE A, ROTARY CUT WHITE BIRCH, CLEAR STAIN

08 87 00 GLAZING SURFACE FILMS
GSF1 OLEEVUE, 471DM EUCALYPTUS
GSF2 LUMAR, RD07G SR CDF (ONE-WAY MIRROR)

09 30 13 CERAMIC/PORCELAIN TILING
PORCELAIN TILE:
PPT1 CROSSVILLE, 12" X 12", BASALT CALDERA
PPT2 CROSSVILLE, 6" X 6" MAINSTREET AV213 BISTRO BROWN
PPT3 CROSSVILLE, 12" X 12" MAINSTREET AV213 BISTRO BROWN

CERAMIC WALL TILE:
CWT1 DAL TILE, COLOR WHEEL COLLECTION, 4" X 16" K175 BISCUIT
GROUT:
GT1 TEC POWERGROUT
GT2 928 PRALINE - AT WALLS
GT3 933 STANDARD GRAY - AT FLOORS

TRIM PIECES:
TR1 SCHLUTER, BULLNOSE, RONDEC, AE SATIN ANODIZED ALUMINUM
TR2 SCHLUTER, COVE BASE, DILEX-AHK, AE SATIN ANODIZED ALUMINUM
TR3 SCHLUTER, EDGE PROTECTION, SCHIENE, AE SATIN ANODIZED ALUMINUM

09 51 00 ACOUSTICAL CEILING
ACT1 USG, SHEETROCK BRAND LAY-IN CEILING PANEL, 3260, 2' X 2' SQUARE EDGE, 15/16" GRID
ACT2 USG DOWN BRAND ZALA SUSPENSION SYSTEM WITH HOLD DOWN CLIPS
ACT3 ARMSTRONG, ULTIMA HEALTHZONE 1937, 2' X 2' TEGULAR EDGE, 15/16" GRID
ACT4 ARMSTRONG, ULTIMA HEALTHZONE 1935, 2' X 2' SQUARE EDGE, 15/16" GRID
ACT5 ARMSTRONG, CORTESA 704, 2' X 2' TEGULAR EDGE, 15/16" GRID
ACT6 ARMSTRONG, AQUAROCK 1182-CRF-15V, 2' X 2' SQUARE EDGE, 15/16" ALUMINUM GRID
ACT7 ARMSTRONG, CIRBUS 534, 2' X 2' TEGULAR EDGE, 15/16" GRID

09 65 13 RESILIENT BASE AND ACCESSORIES
COVED BASE:
RB2 TARKETT, BASEWORKS 4", 280 SHORELINE
RB2 TARKETT, BASEWORKS 4", 80 FAWN

TRANSITIONS AND REDUCER STRIPS:
TRS1 TARKETT, 80 FAWN

09 65 16 RESILIENT SHEET FLOORING
SHEET RUBBER:
SR1 MONDO, NATURA NAGS GREIGE
SR2 MONDO, UMI U013 FIREBRICK (2" WIDE DEMARCATON BAND)

STATIC DISSIPATIVE SHEET VINYL:
SDSV1 TARKETT, IQ GRANIT SD 3096468 SAND

09 65 19 RESILIENT TILE FLOORING
LUXURY RESILIENT TILE:
LRT1 INTERFACE, 25CM X 1M TEXTURED WOODGRAIN A00408 ANTIQUE LIGHT OAK (ASHLAR INSTALL)
LRT2 INTERFACE, 25CM X 1M TEXTURED WOODGRAIN A00409 ASH WALNUT (ASHLAR INSTALL)
LRT3 KARDEAN, 16" X 16" DA VINCI SANTI LIMESTONE (MONOLITHIC INSTALL)


VINYL COMPOSITION TILE:
VC11 ARMSTRONG, STANDARD EXCELOX 51811 ANTIQUE WHITE (USED FOR PATCHING)

09 68 00 CARPETTING
CPT1 MILLIKEN, LOW COUNTRY ESTUARY EST124-259 OYSTER (ASHLAR INSTALL)

WALK-OFF CARPET TILE:
WCPT1 VAN GELDER INC. CHAMPION LP, BEIGE 1153, 19.69" X 19.69", QUARTER TURN INSTALLATION

09 72 00 WALL COVERING
WC1 MDC, DIGITAL WALL COVERING, CUSTOM IMAGE, HENRY DOWKE, ARBOR-AUTUMN-PANORAMA_2370KWP

09 91 00 PAINTING
PAINT:
P1 SHERWIN WILLIAMS 7526 MAISON BLANCHE
P2 SHERWIN WILLIAMS 2844 ROYOCROFT MIST GRAY
P3 SHERWIN WILLIAMS 7343 MOUNTAIN ROAD
P4 SHERWIN WILLIAMS 0049 SILVER GRAY
P5 SHERWIN WILLIAMS 7006 EXTRA WHITE
P6 SHERWIN WILLIAMS 6156 RAMME
P7 S

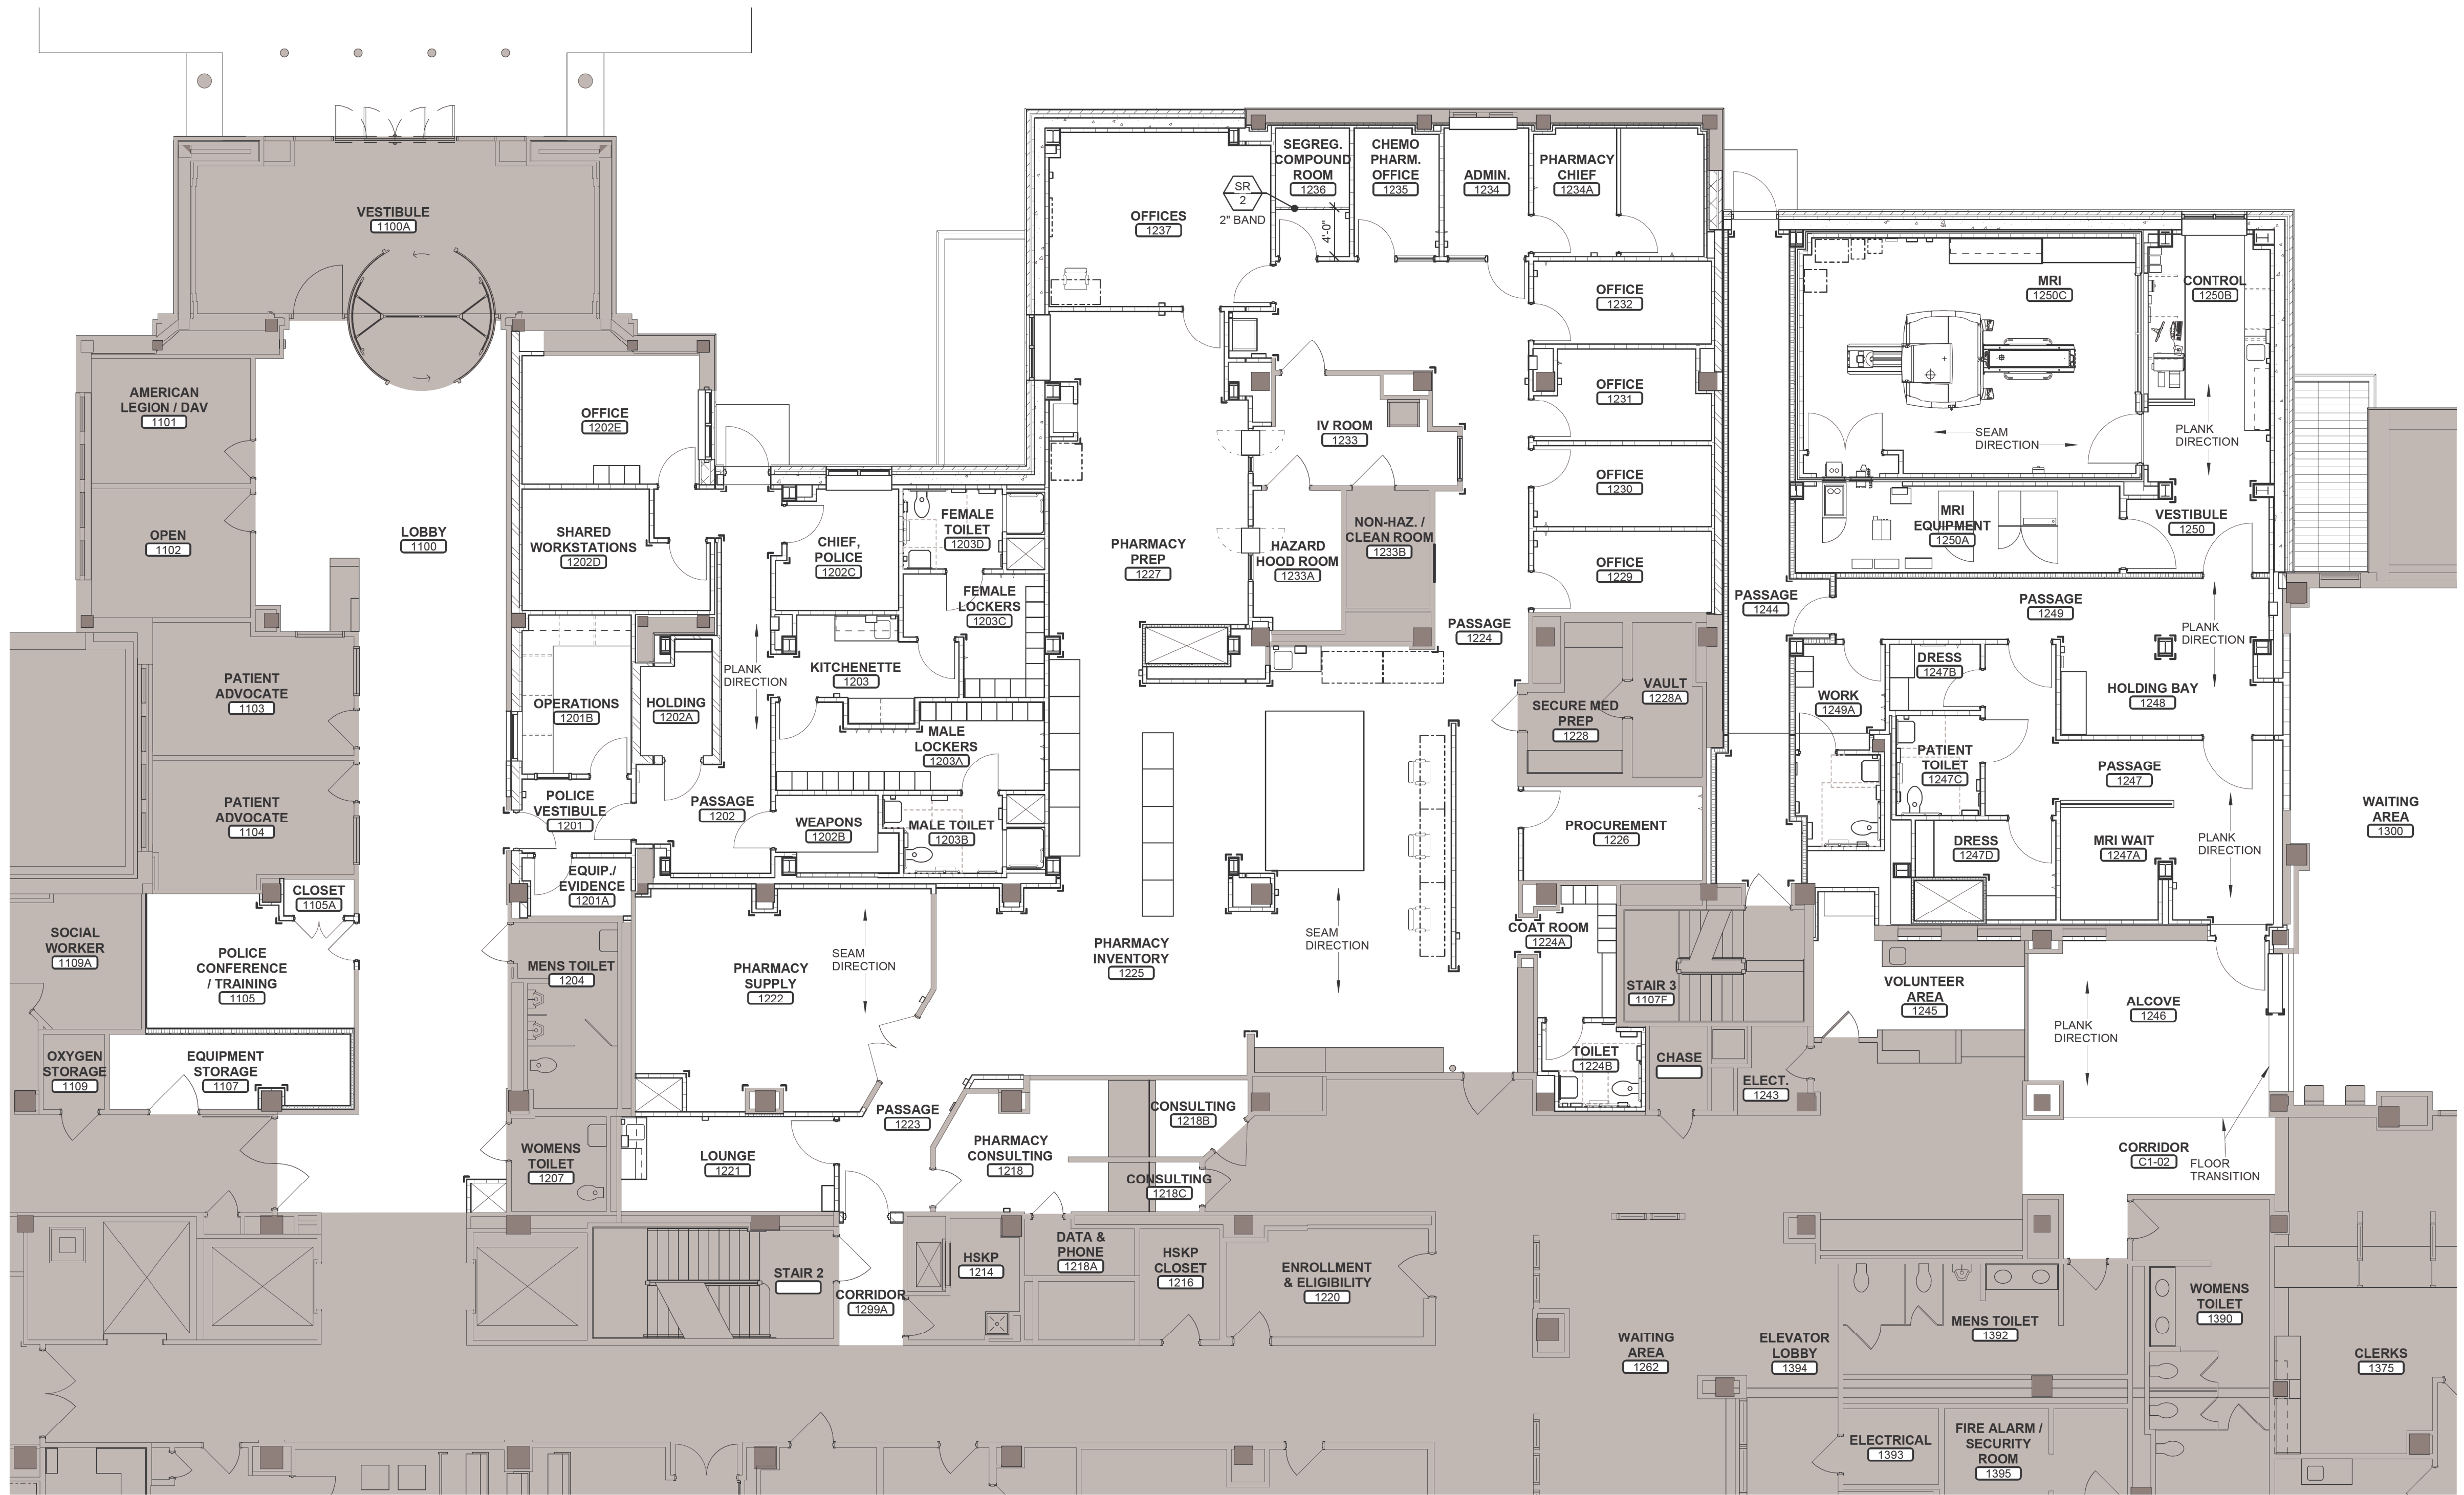

F4 FIRST FLOOR - FLOOR SPECIAL PLAN
1/8" = 1'-0"

0 2' 4' 6' 12'

CONSTRUCTION SET	05/08/2023
Revisions:	Date:

ARCHITECT/ENGINEER OF RECORD

bernerschaber

Comm. Number: 6163.03
310 Pine Street | Green Bay, WI 54301
920-432-4865 | www.bernerschaber.com

ARCHITECT/ENGINEER

STAMP



Office of
Construction
and Facilities
Management



U.S. Department
of Veterans Affairs

Drawing Title

INTERIOR FLOOR SPECIAL PLAN

Approved:

Phase

CONSTRUCTION SET

FULLY SPRINKLERED

Project Title

EXPAND PHARMACY AND RADIOLOGY
OSCAR G. JOHNSON VA MEDICAL CENTER

Location

325 H STREET,
IRON MOUNTAIN, MI 49801

Issue Date

MAY 8, 2023

Checked

CMB

Drawn

CMB

Project Number

585-337

Building Number

1


Drawing Number

1101K

DWG. 43 OF 126

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Project Number
585-337

Building Number
1

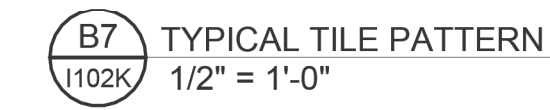Drawing Number
102K

DWG. 44 OF 126

Bc

D



1



SCALE: 3" = 1'-0"



SCALE: 1" = 1'-0"



SCALE: 1" = 1'-0"

BBBc

D

D

1

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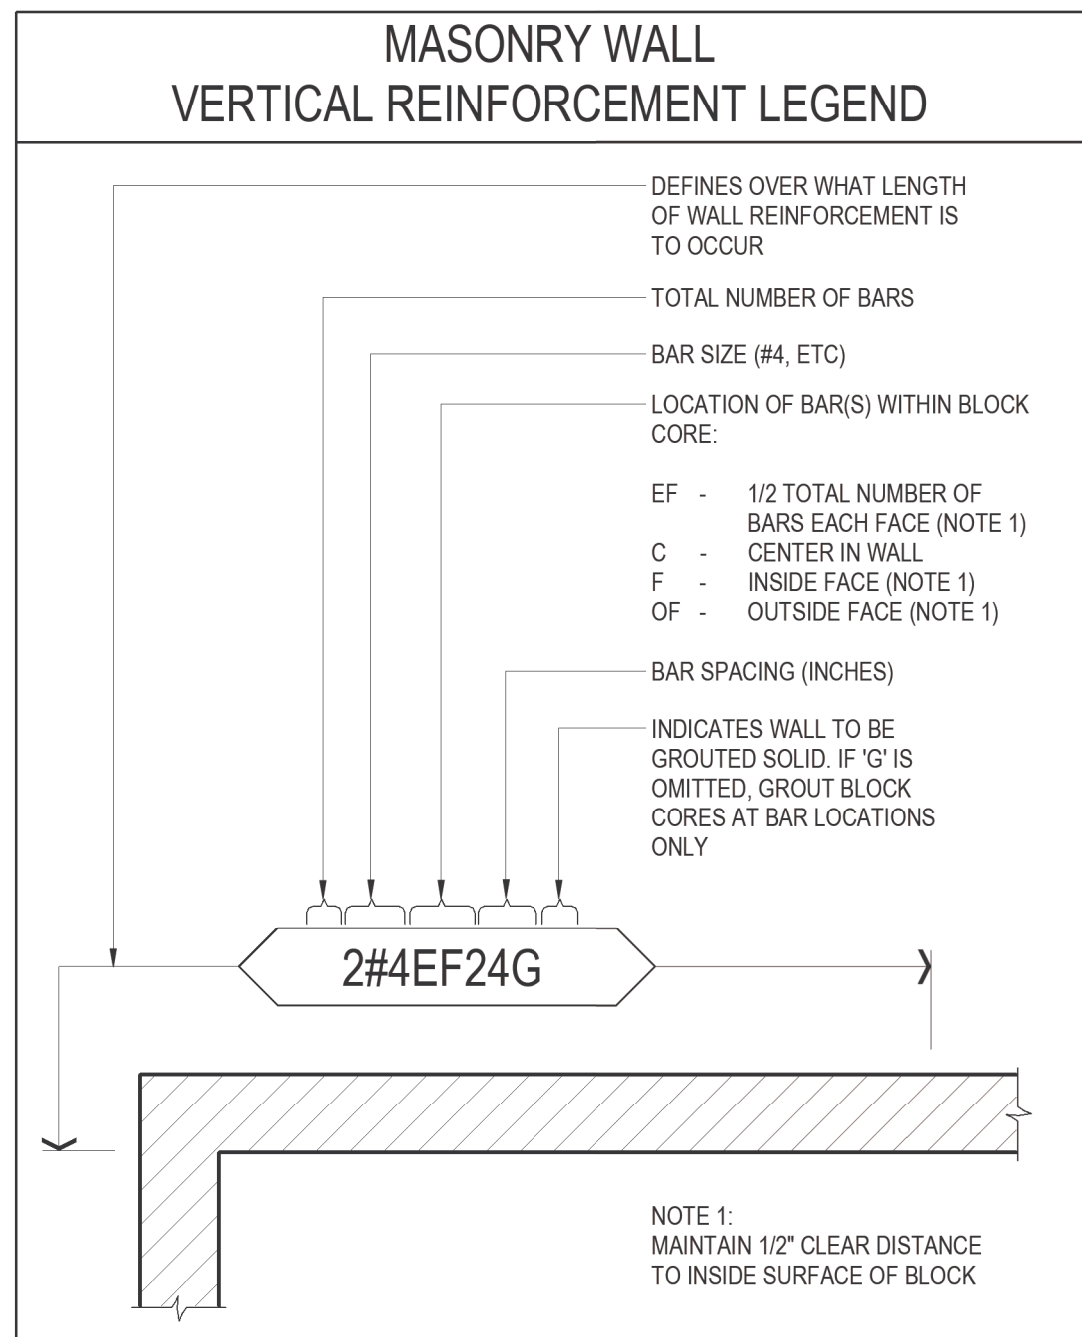
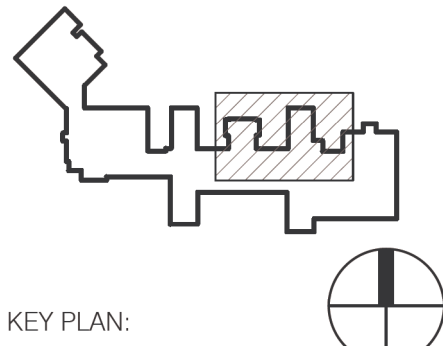
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VA FORM 08-6231

S002

DWG 46 OF 136







FOUNDATION PLAN NOTES

- SLAB FINISH ELEVATION 1135'-0" LOCAL DATUM UNLESS NOTED OTHERWISE. FOR T/SLAB AT AREAWAYS, SEE PLAN AND KEYNOTES. TOP OF FOOTING ELEVATION = 1131'-2" UNLESS NOTED OTHERWISE. T/WALL = 1146'-0" UNO. T/LEDGE = 1146'-0" UNO.
- SLAB-ON-GRADE TO BE 4" THICK WITH SYNTHETIC FIBERS (REFER TO SPECIFICATION) ON VAPOR BARRIER ON 1" CHOKER COURSE OVER 6" THICK (MINIMUM) COARSE STONE BASE MEETING THE REQUIREMENTS OF ASTM D2940 UNLESS NOTED OTHERWISE.
- TYPICAL WHERE SLAB-ON-GRADE ABUTS WALL OR COLUMN, PROVIDE 1/4" x (50G THICKNESS) ISOLATION FILLER STRIP. SET STRIP 1/4" BELOW FINISH SLAB ELEVATION.
- OVER-EXCAVATION PER DETAIL 1/8800 MAY BE REQUIRED TO REMOVE EXISTING UNDOCUMENTED FILL AND UNSUITABLE BEARING SOIL. OVER-EXCAVATION WILL BE REQUIRED BENEATH MAT FOOTING TO BOTTOM OF ADJACENT EXISTING FOOTINGS.
- TYPICAL DETAILS THAT APPLY TO PLAN INCLUDE:
 - 2/8800 SLAB-ON-GRADE JOINT DETAIL
 - 3/8800 CORNER REINFORCEMENT DETAIL
 - 4/8800 CONCRETE WALL JOINT DETAIL
 - 5/8800 WALL FOOTING OVER LATERAL
 - 6/8800 FOOTING STEP DETAIL
 - 7/8800 STOOP DETAIL
 - 9/8800 CONCRETE WALL OPENING DETAIL
 - 10/8800 FOUNDATION WALL DRAINAGE AND BACKFILL

FOUNDATION PLAN KEYED NOTES

- PROVIDE SLIP SHEET OVER ENTIRE MAT DEPTH BETWEEN NEW MAT AND EXISTING FOUNDATION WALL.
- IN SHADED AREA PROVIDE 6" VOID FORM BELOW BOTTOM OF NEW FOUNDATION. PROVIDE HIGH DENSITY (30 PSI) EXTRUDED POLYSTYRENE INSULATION BOARDS BELOW VOID FORM TO TOP OF EXISTING FOOTING.
- IN SHADED AREA PROVIDE 6" VOID FORM BELOW BOTTOM OF NEW FOUNDATION. PROVIDE HIGH DENSITY (30 PSI) EXTRUDED POLYSTYRENE INSULATION BOARDS BELOW VOID FORM TO BOTTOM OF EXISTING FOOTING.
- 3'-0" THICK MAT FOUNDATION OVER AREA SHOWN. POUR TIGHT TO SLIP SHEET ON EXISTING FOUNDATION WALL. TOP OF MAT FOUNDATION ELEVATION = 1134'-2". PROVIDE #6 AT 12" OC EACH WAY BOTTOM, #6 AT 12" OC EAST-WEST TOP, AND #6 AT 9" OC NORTH-SOUTH TOP (#6 AT 12" OC NORTH-SOUTH TOP AT 4a). CLASS B LAP ON ALL BARS. HOOK TOP BARS AT BUILDING FACE.
- REMOVE EXISTING WALL FOOTING PROJECTION OVER WIDTH OF FOOTING F2. UNDERPIN EXISTING FOOTING AS REQUIRED TO CONSTRUCT NEW FOOTING.
- FIELD VERIFY EXISTING FOOTING ELEVATION. UNDERPIN EXISTING FOOTING AS REQUIRED FOR CONSTRUCTION OF NEW FOOTING. SEE DETAIL 16/8800 FOR ADDITIONAL INFORMATION REGARDING UNDERPINNING.
- INFILL EXISTING OPENING IN CIP FOUNDATION WALL PER DETAIL 7/8801.
- 4" SLAB-ON-GROUND AT AREAWAY. SEE PLAN NOTES 1 & 2. T/SLAB = 1138'-6".
- 4" SLAB-ON-GROUND AT AREAWAY. SEE PLAN NOTES 1 & 2. T/SLAB = 1138'-6".
- LOUVER OPENING. SEE ARCH AND MECH FOR SIZE AND LOCATION. SEE DETAIL 9/8800 FOR ADDITIONAL REQUIREMENTS AT OPENING IN CIP CONCRETE WALL.
- AT NEW OPENING IN EXISTING FOUNDATION WALL, PROVIDE CHANNEL REINFORCING PER DETAIL 8/8821. REFER TO ARCHITECTURAL AND MECHANICAL DRAWINGS FOR LOCATIONS AND DIMENSIONS OF NEW OPENINGS.

FOUNDATION LEGEND

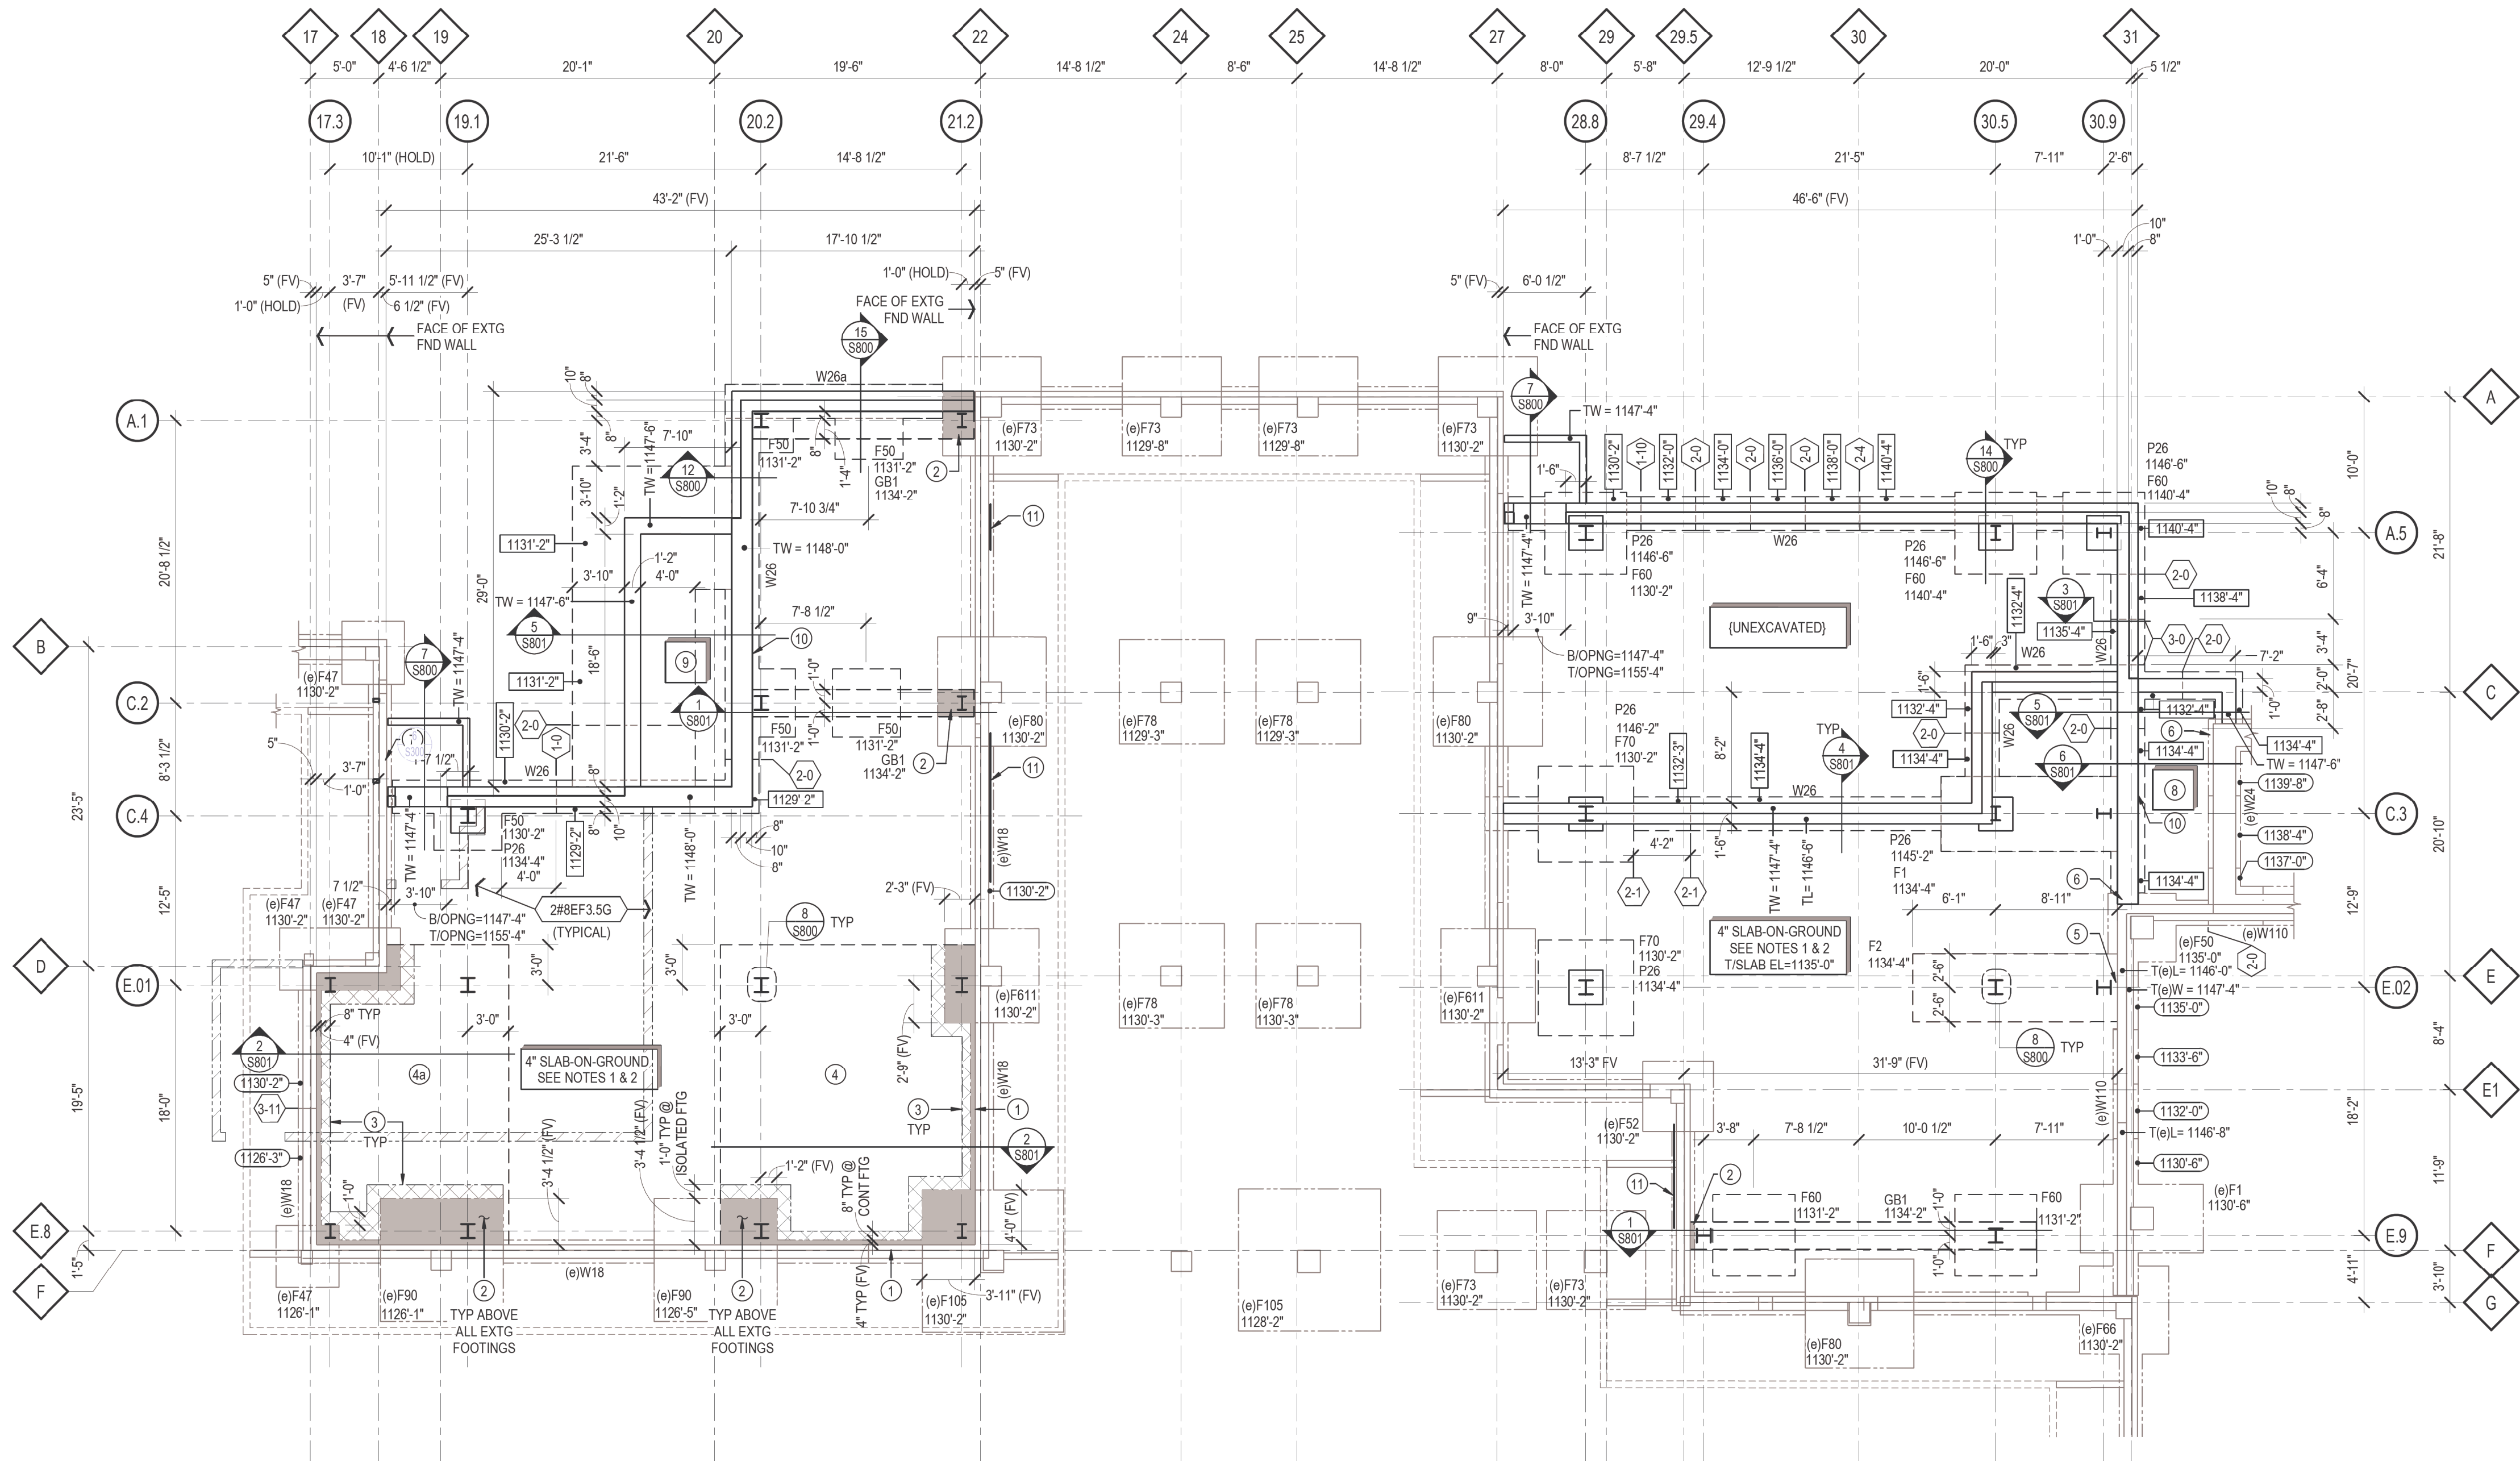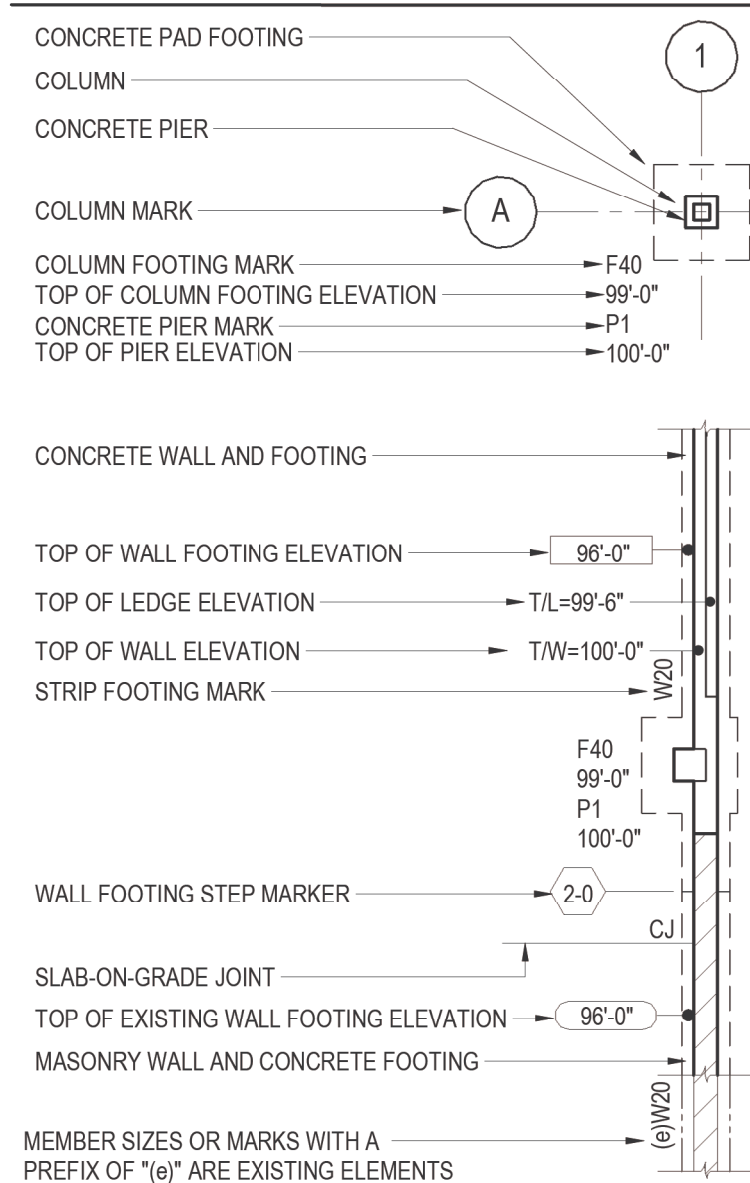

1 S100 FOUNDATION PLAN
SCALE: 1/8" = 1'-0"

raSmith
CREATIVITY BEYOND ENGINEERING

16745 W. Bluemound Road
Brookfield, WI 53005-5938
(262) 781-1000
rasmith.com

raSmith Project Number: 1200712

CONSTRUCTION SET	05/08/2023
Revisions:	Date:

ARCHITECT/ENGINEER OF RECORD

bernerschaber

Comm. Number: 6163.03
310 Pine Street | Green Bay, WI 54301
920-432-4865 | www.bernerschaber.com
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Office of
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VA

U.S. Department
of Veterans Affairs

Drawing Title

FOUNDATION PLAN

Approved:

Phase

CONSTRUCTION SET

FULLY SPRINKLERED

Project Title

EXPAND PHARMACY AND RADIOLOGY
OSCAR G. JOHNSON VA MEDICAL CENTER

Location

325 H STREET,
IRON MOUNTAIN, MI 49801

Issue Date

MAY 8, 2023

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COMPOSITE FLOOR SYSTEM PLAN NOTES



1. FINISH SLAB ELEVATION = 1148'-0" UNO. TOP OF FOUNDATION WALL = 1148'-0" UNO. TOP OF FOUNDATION WALL LEDGE = 1148'-0" UNO.
2. STEEL ELEVATION = 1147'-6 3/4" UNLESS NOTED OTHERWISE ON THE PLAN AS (X-X').
3. TYPICAL SLAB IS 5-1/4" THICK CONSISTING OF 3 1/4" LIGHTWEIGHT (115 PCF) CONCRETE WITH SYNTHETIC FIBERS (4 LBS/CY - SEE SPECIFICATIONS) ON 2" X 2" GAGE GALVANIZED COMPOSITE UNSHORED METAL DECK WITH THE FOLLOWING PROPERTIES UNDER 2 OR MORE SPANS.

THICK = 0.0356 in	$I_y = 0.409 \text{ in}^4/\text{ft}$	$S_y = 0.341 \text{ in}^3/\text{ft}$
$F_y = 50 \text{ KSI}$	$I_x = 0.406 \text{ in}^4/\text{ft}$	$S_x = 0.346 \text{ in}^3/\text{ft}$
4. HEADED WELD STUDS TO BE 3/4" DIAMETER BY 3 1/2" LONG (AFTER WELD LENGTH). HEADED WELD STUDS SHOULD BE ATTACHED DIRECTLY TO TOP OF BEAM AND NOT TO EDGE OF SLAB ANGLES OR BENT PLATES WELDED TO THE TOP OF BEAMS UNLESS DETAILED SPECIFICALLY OTHERWISE. SEE DETAILS 1/S820, 2/S820, & 3/S820 FOR COMPOSITE SLAB DETAILS.
5. VERIFY ALL OPENING DIMENSIONS AND LOCATIONS WITH ARCHITECTURAL AND MECHANICAL DRAWINGS PRIOR TO STEEL FABRICATION.
6. SEE SHEET S002 FOR COLUMN SCHEDULE.
7. REACTIONS INDICATED ARE FACTORED VALUES THAT CONNECTION DESIGN IS TO SATISFY AS A MINIMUM. CONNECTION DESIGN SHALL BE BASED ON A $\phi = 1.0$. SHALL HAVE THE SAME CAPACITY BOTH UP AND DOWN, AND THE GOVERNING LIMIT STATE OF THE CONNECTION SHALL BE A DUCTILE MODE OF FAILURE. IN THE EVENT OF A BRITTLE FAILURE, MULTIPLY THE INDICATED REACTION BY 1.5.
8. NUMBER(S) IN BRACKETS NEXT TO BEAM SIZE INDICATES NUMBER OF HEADED WELD STUDS REQUIRED. IF SINGLE NUMBER, INDICATED STUDS TO BE UNIFORMLY SPACED ALONG BEAM LENGTH. IF SERIES OF NUMBERS, INDICATED NUMBER OF STUDS TO BE UNIFORMLY SPACED BETWEEN INFRAMING BEAM(S).
9. SEE DETAIL 14/S820 FOR TYPICAL MOMENT CONNECTION (SHOWN AS \blacktriangleright ON PLAN). SEE GENERAL NOTES ON SHEET S001 FOR MOMENT CONNECTION DESIGN CRITERIA.

FIRST FLOOR PLAN KEYED NOTES

1. PROVIDE #4 X 7'-6" LONG TOP BARS AT 18" OC CENTERED OVER GIRDER BEAMS ALONG GRIDS E.01, C.2, AND AT OTHER LOCATIONS WHERE THIS NOTE IS SPECIFICALLY REFERENCED. CHAIR BARS TO LOCATE 3/4" CLEAR TO TOP OF SLAB.
2. AT ALL RE-ENTRANT CORNERS, PROVIDE (2) - #4 X 7'-6" LONG DIAGONAL BARS PLACED AT MID-DEPTH OF SLAB.

STRUCTURAL STEEL LEGEND

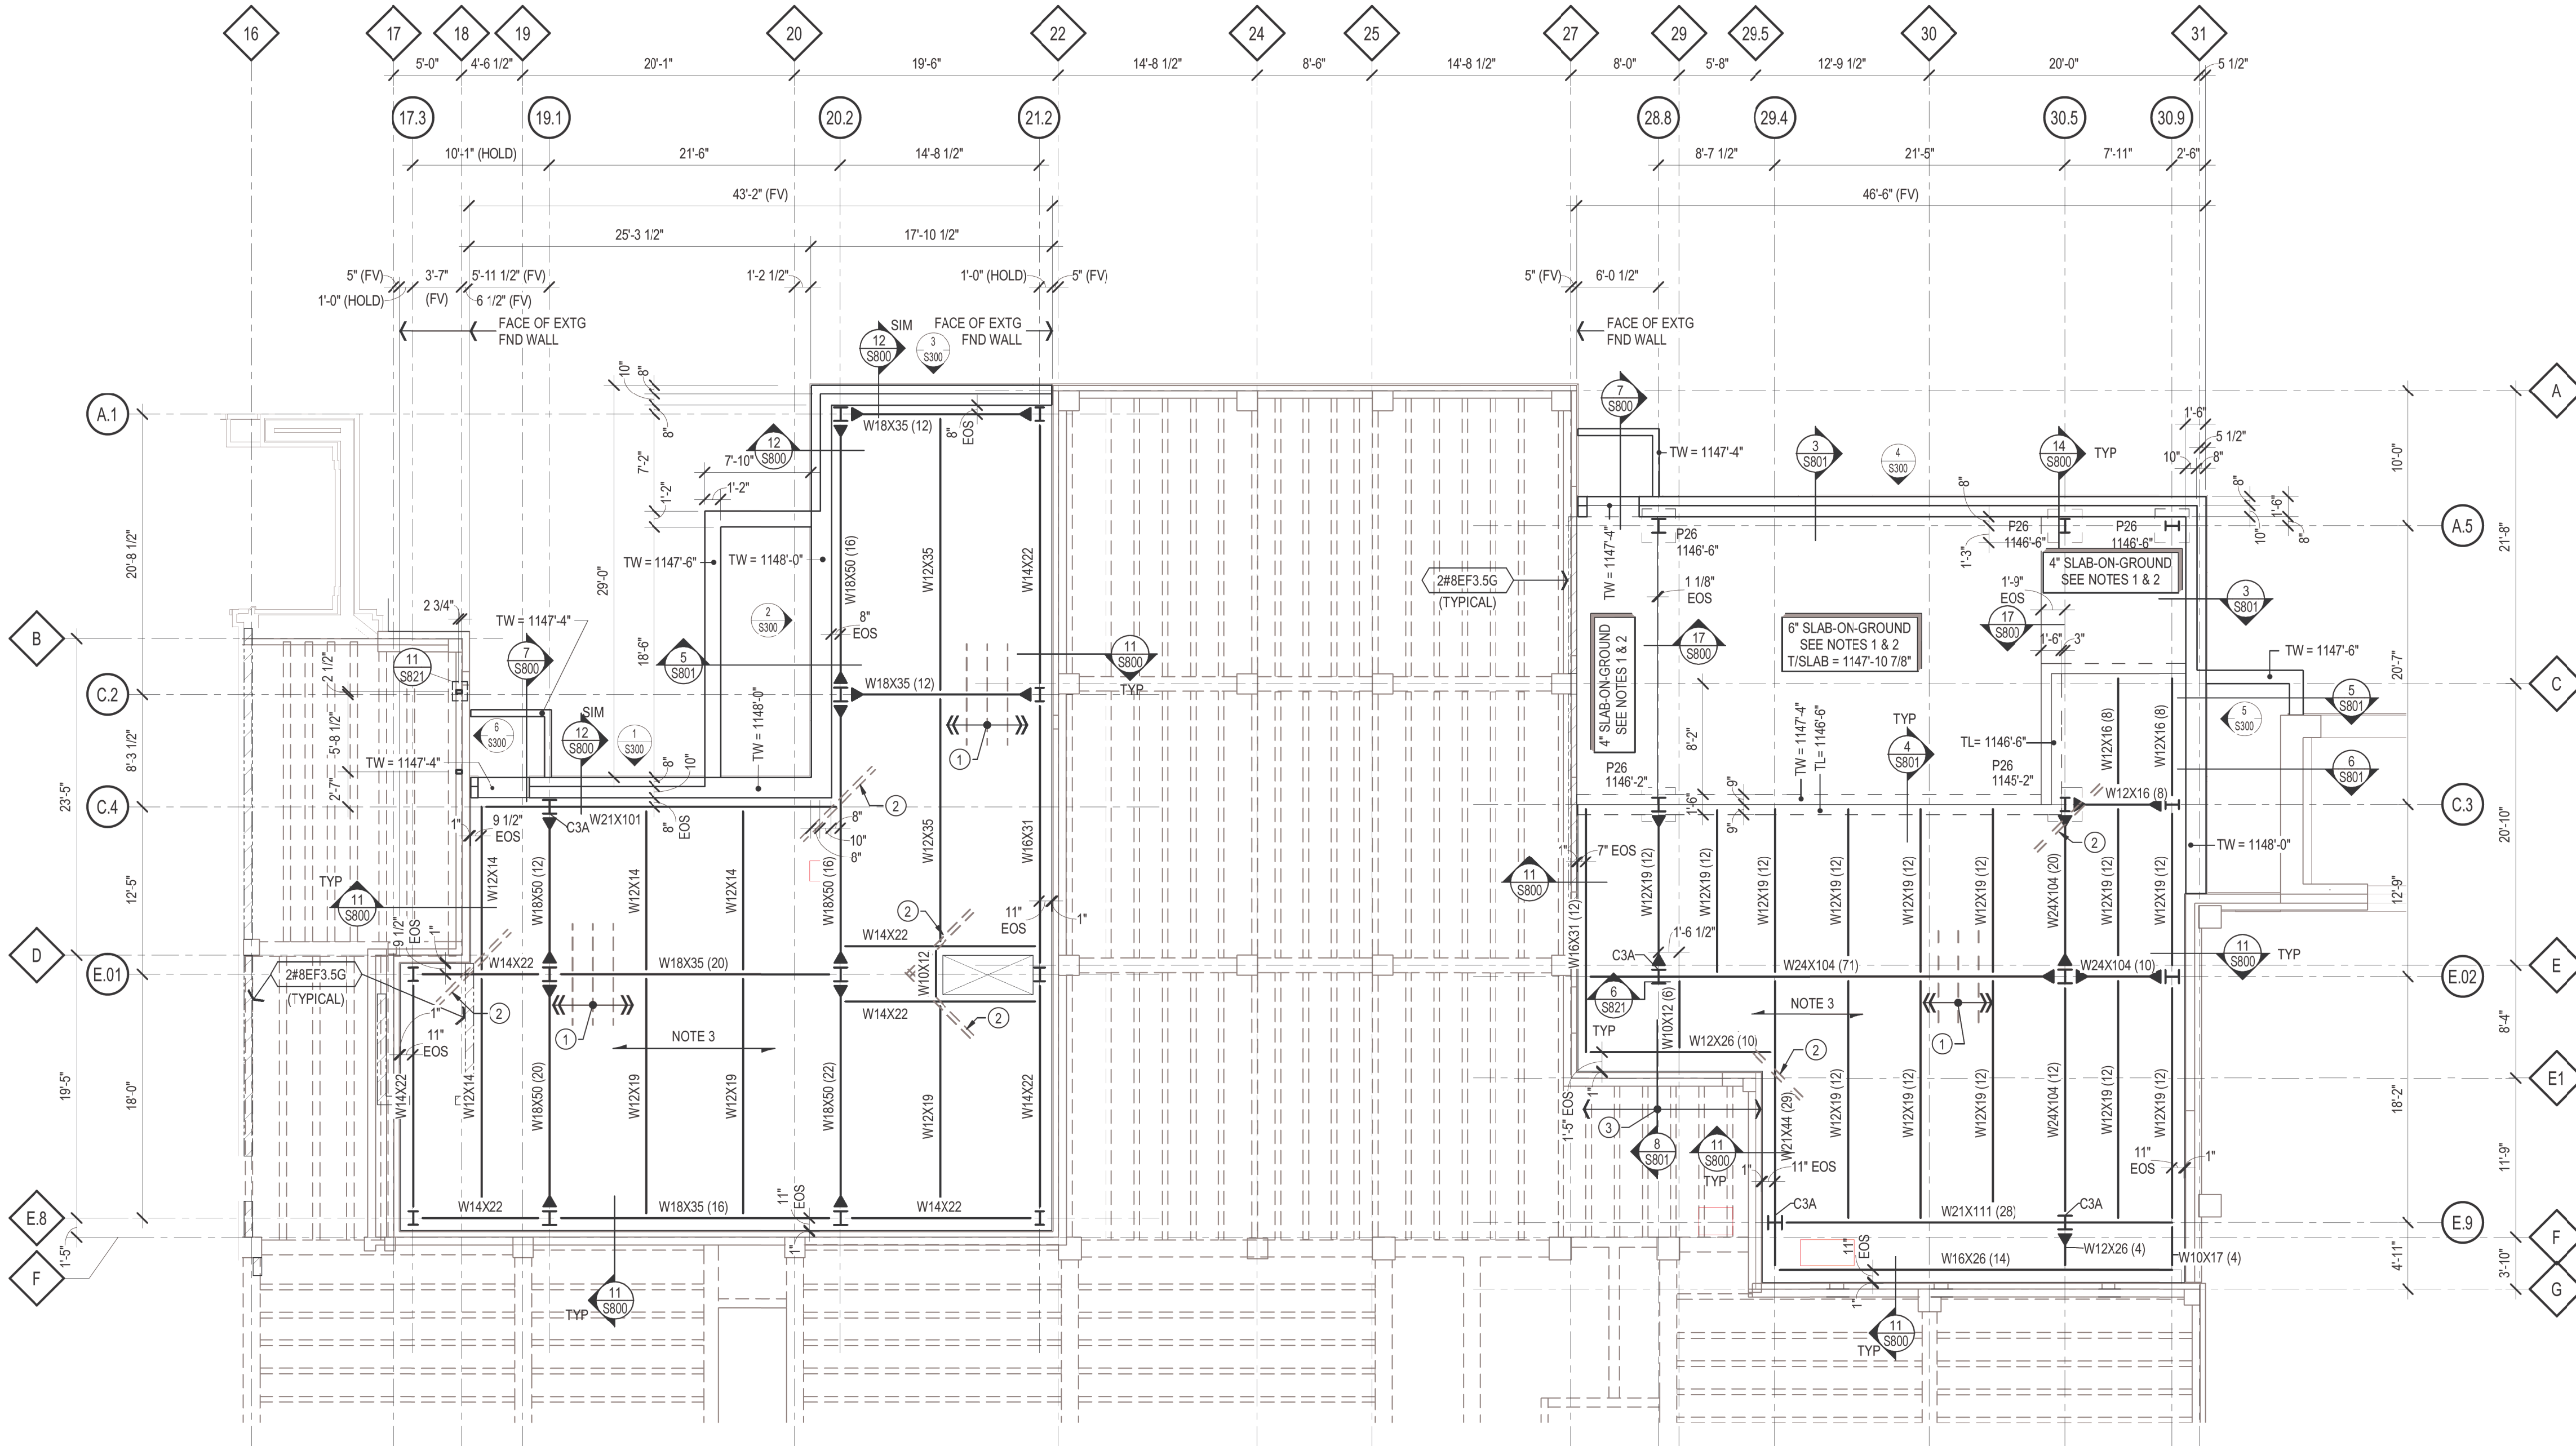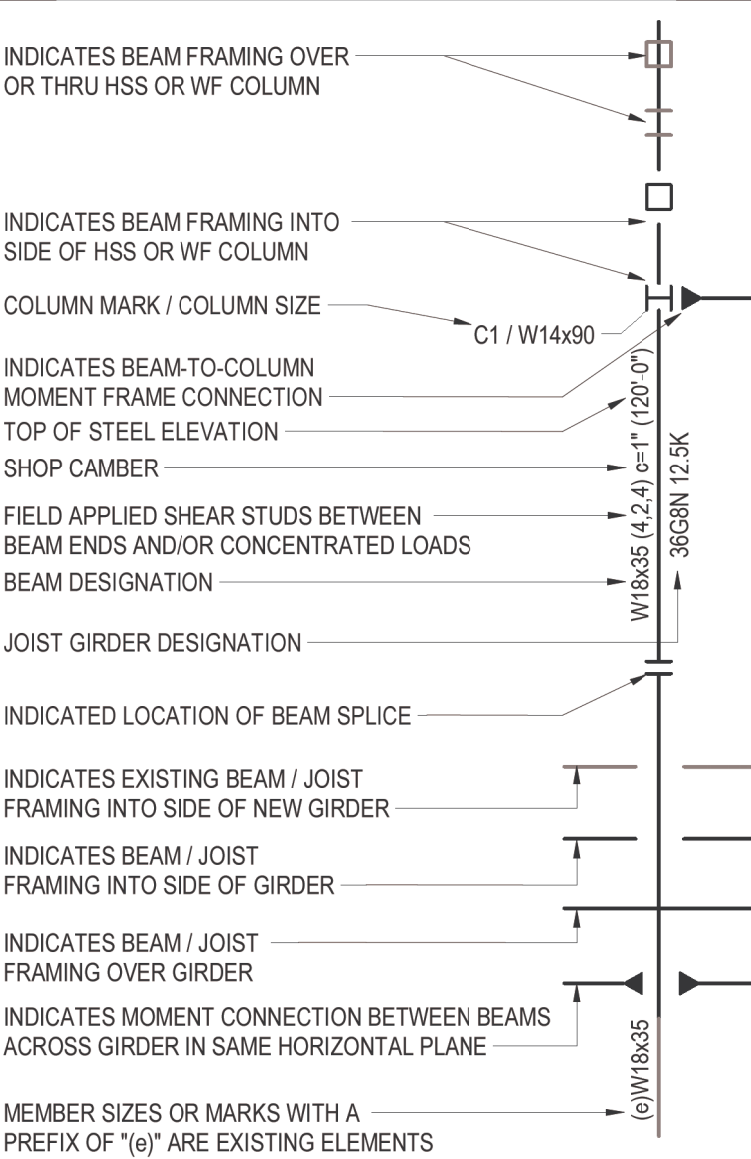


SECOND FLOOR FRMAING PLAN NOTES

- FINISH SLAB ELEVATION=1161'-0" UNLESS NOTED OTHERWISE.
- STEEL ELEVATION=1160'-6" UNLESS NOTED OTHERWISE ON THE PLAN AS (X'-X").
- TYPICAL SLAB IS 6" THICK CONSISTING OF 4" LIGHTWEIGHT (115 PCF) CONCRETE WITH SYNTHETIC FIBERS (4 LBS/CY - SEE SPECIFICATIONS) ON 2" X 15 GAGE GALVANIZED COMPOSITE UNSHORED METAL DECK WITH THE FOLLOWING PROPERTIES UNDER 2 OR MORE SPANS.
 $\begin{matrix} \text{THICK} = 0.0556 \text{ in} & I_p = 0.699 \text{ in}^4/\text{ft} & S_p = 0.638 \text{ in}^3/\text{ft} \\ F_y = 80 \text{ KSI} & I_x = 0.700 \text{ in}^4/\text{ft} & S_x = 0.648 \text{ in}^3/\text{ft} \end{matrix}$
SEE PLAN FOR ADDITIONAL REINFORCEMENT REQUIREMENTS.
- HEADED WELD STUDS TO BE 3/4" DIAMETER BY 3 1/2" LONG (AFTER WELD LENGTH). HEADED WELD STUDS SHOULD BE ATTACHED DIRECTLY TO TOP OF BEAM AND NOT TO EDGE OF SLAB ANGLES OR BENT PLATES WELDED TO THE TOP OF BEAMS UNLESS DETAILED SPECIFICALLY OTHERWISE. SEE DETAILS 1/S820 , 2/S820 , & 3/S820 FOR COMPOSITE SLAB DETAILS.
- VERIFY ALL OPENING DIMENSIONS AND LOCATIONS WITH ARCHITECTURAL AND MECHANICAL DRAWINGS PRIOR TO STEEL FABRICATION.
- SEE SHEET S002 FOR COLUMN SCHEDULE.
- REACTIONS INDICATED ARE FACTORED VALUES THAT CONNECTION DESIGN IS TO SATISFY AS A MINIMUM. CONNECTION DESIGN SHALL BE BASED ON A $\Phi = 1.0$. SHALL HAVE THE SAME CAPACITY BOTH UP AND DOWN, AND THE GOVERNING LIMIT STATE OF THE CONNECTION SHALL BE A DUCTILE MODE OF FAILURE. IN THE EVENT OF A BRITTLE FAILURE, MULTIPLY THE INDICATED REACTION BY 1.5.
- NUMBER(S) IN BRACKETS NEXT TO BEAM SIZE INDICATES NUMBER OF HEADED WELD STUDS REQUIRED. IF SINGLE NUMBER, INDICATED STUDS TO BE UNIFORMLY SPACED ALONG BEAM LENGTH. IF SERIES OF NUMBERS, INDICATED NUMBER OF STUDS TO BE UNIFORMLY SPACED BETWEEN INFRAMING BEAM(S).
- SEE DETAIL 14/S820 FOR TYPICAL MOMENT CONNECTION (SHOWN AS ► ON PLAN). SEE GENERAL NOTES ON SHEET S001 FOR MOMENT CONNECTION DESIGN CRITERIA.

SECOND FLOOR PLAN KEYED NOTES

- PROVIDE #4 X 7'-6" LONG TOP BARS AT 18" OC CENTERED OVER GIRDER BEAMS ALONG GRIDS E 01, C 2, C 3, E 02, E 9, AND AT OTHER LOCATIONS WHERE THIS NOTE IS SPECIFICALLY REFERENCED. CHAIR BARS TO LOCATE 3/4" CLEAR TO TOP OF SLAB.
- AT ALL RE-ENTRANT CORNERS, PROVIDE (2) - #4 X 7'-6" LONG DIAGONAL BARS PLACED AT MID-DEPTH OF SLAB.
- PROVIDE #7 AT 12" OC BETWEEN THE LIMITS SHOWN ON PLAN WITHIN THE COMPOSITE SLAB METAL DECK RIBS BETWEEN SUPPORTS. CHAIR BARS TO 1-1/4" CLEAR FROM THE BOTTOM OF THE METAL DECK.
- W8X10. ALIGN WITH HSS POST ABOVE.
- (NOT USED)
- W8X10. VERIFY OPENING DIMENSION WITH ARCHITECT AND MECHANICAL, AND PROVIDE APPROPRIATE SLAB EDGE DETAILS 4, 5, 6, OR 7/S820 BASED ON EOS DIMENSION.
- W12X40. DESIGN FOR END REACTION OF 32.0 K. SEE NOTE 7 FOR ADDITIONAL INFORMATION.

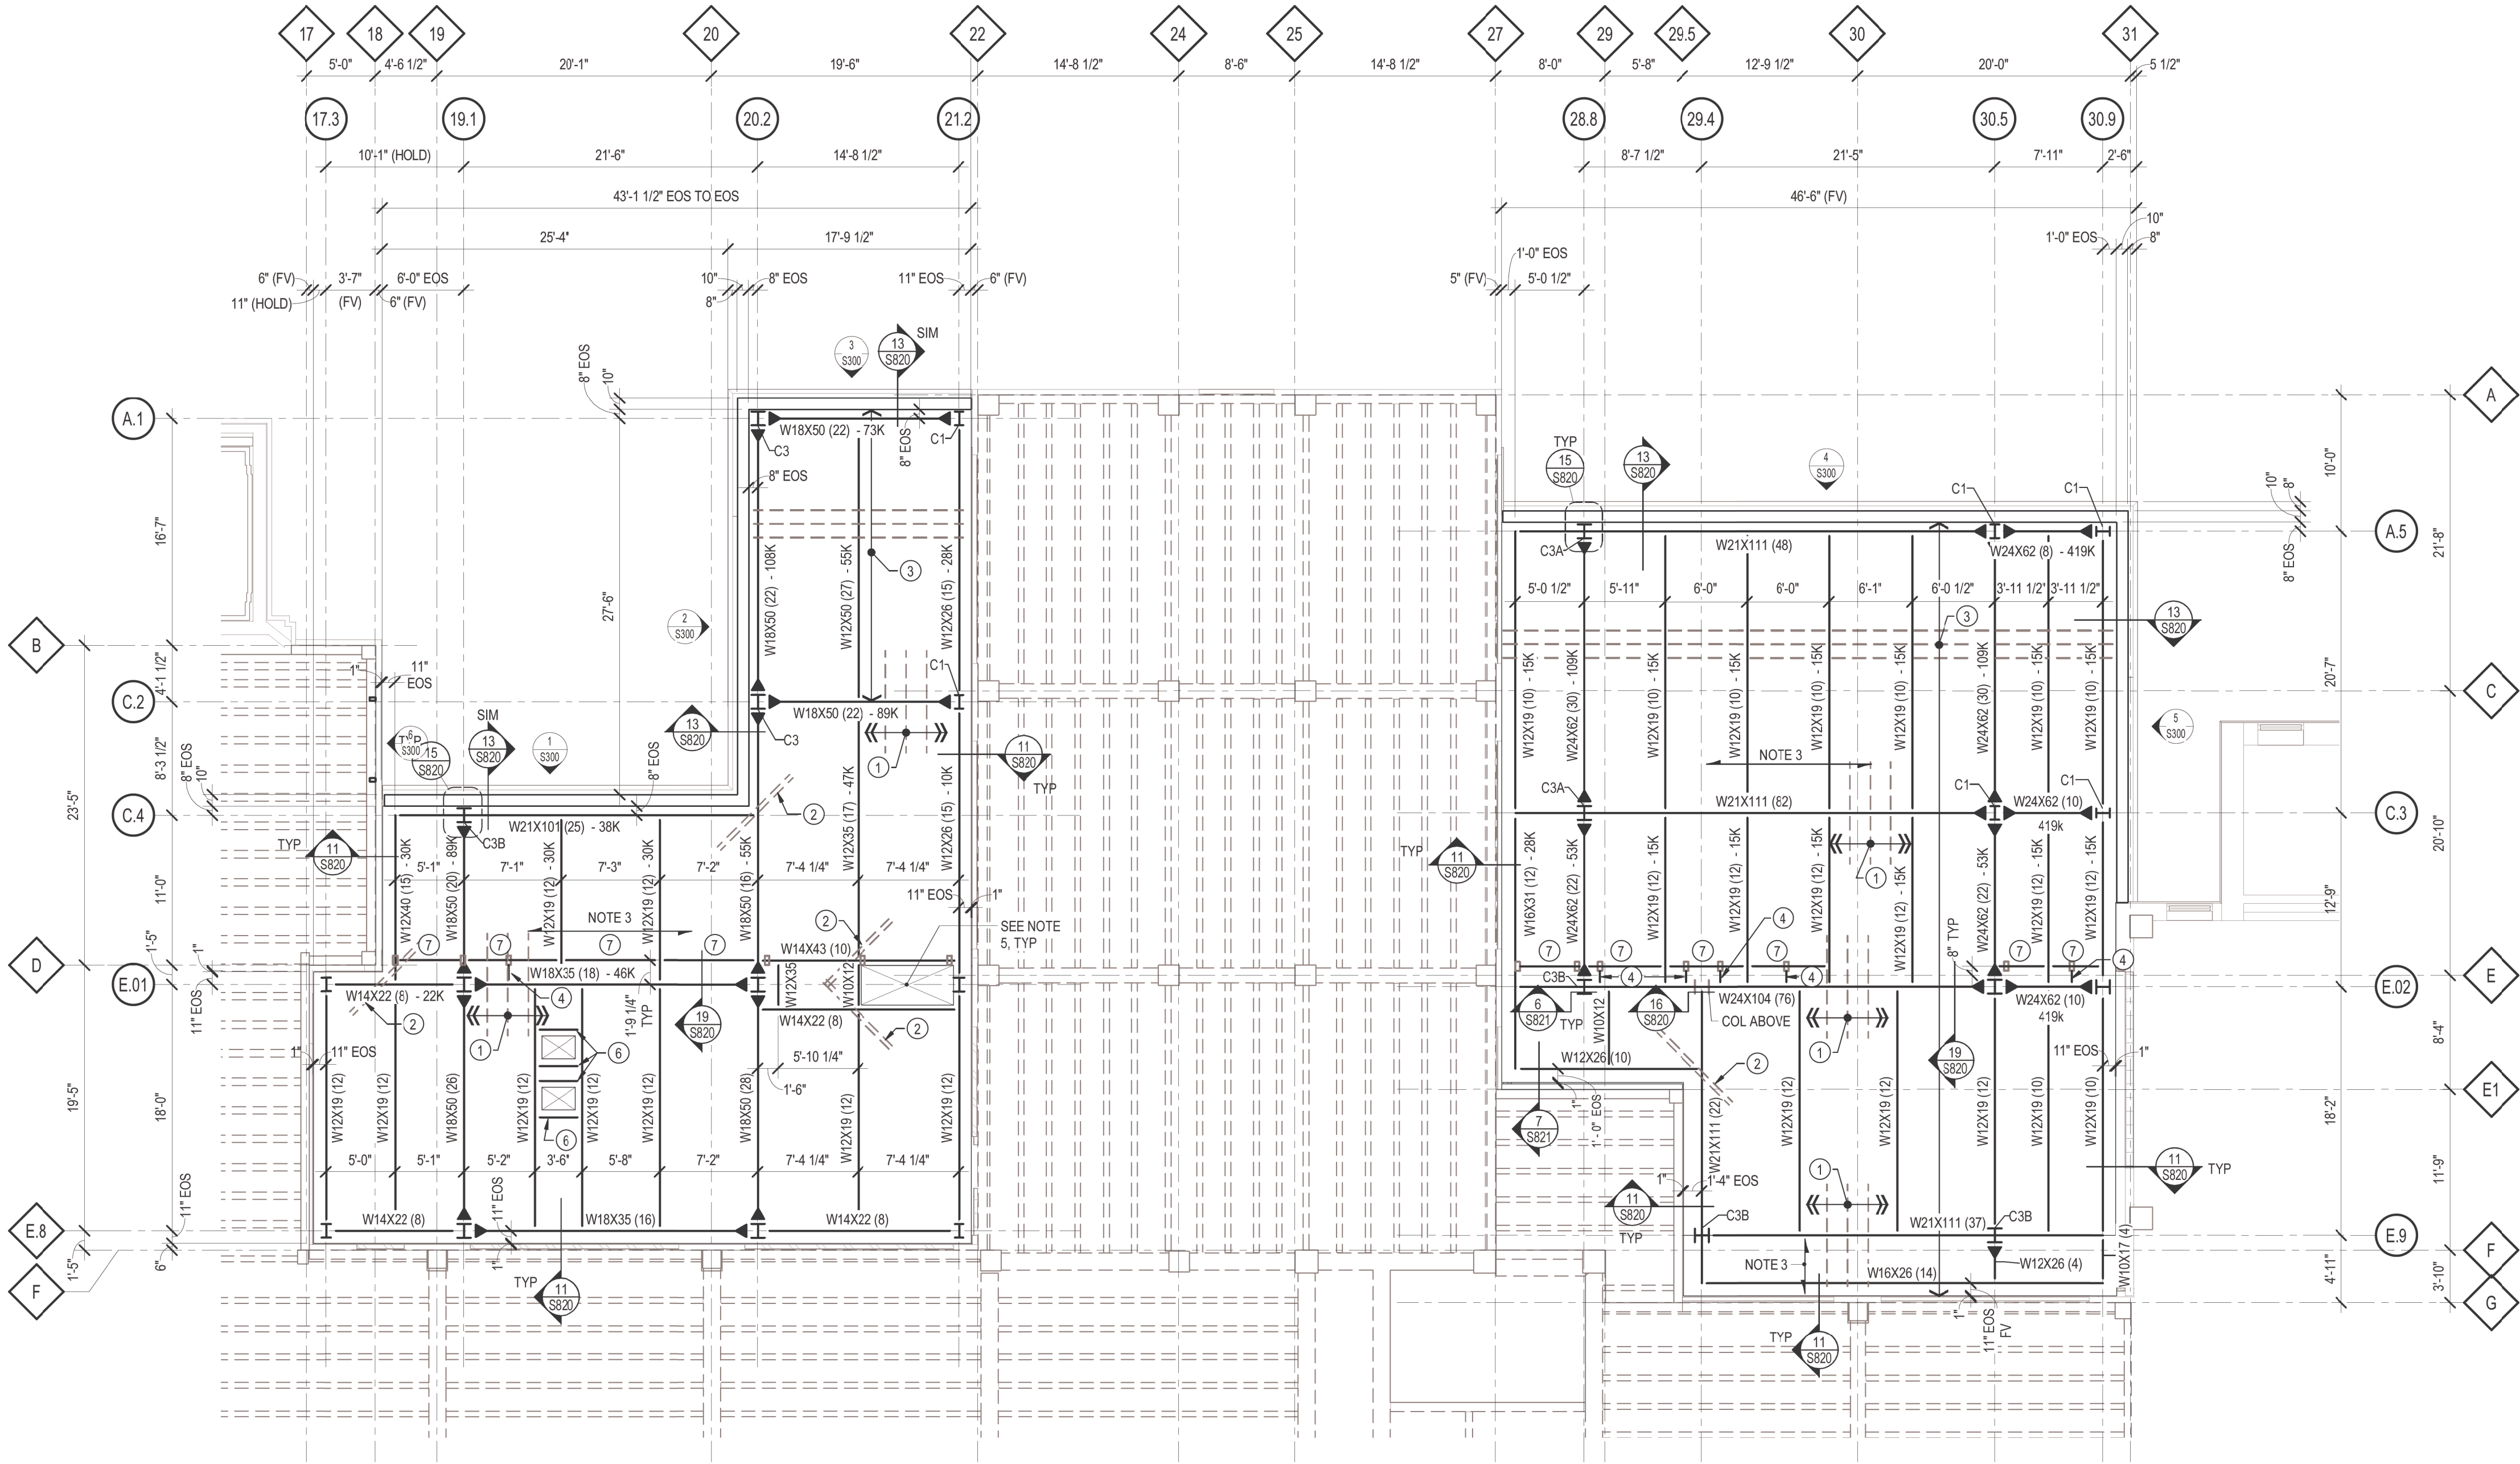

SECOND FLOOR / ROOF FRAMING PLAN

SCALE: 1/8" = 1'-0"

raSmith
CREATIVITY BEYOND ENGINEERING

16745 W. Bluemound Road
Brookfield, WI 53005-5938
(262) 781-1000
rasmith.com

raSmith Project Number: 1200712

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Revisions:	Date:

ARCHITECT/ENGINEER OF RECORD

bernerschaber

Comm. Number: 6163.03
310 Pine Street | Green Bay, WI 54301
920-432-4865 | www.bernerschaber.com

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Drawing Title

SECOND FLOOR FRAMING PLAN

Approved:

Phase

CONSTRUCTION SET

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Project Title

EXPAND PHARMACY AND RADIOLOGY
OSCAR G. JOHNSON VA MEDICAL CENTER

Location

325 H STREET,
IRON MOUNTAIN, MI 49801

Issue Date

MAY 8, 2023

Checked

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Project Number

585-337


Building Number

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Drawing Number

S202

DWG. 49 OF 126



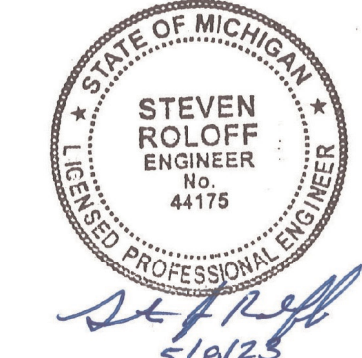

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6. SEE DETAIL 14/S820 FOR TYPICAL MOMENT CONNECTION (SHOWN AS ► ON PLAN). SEE GENERAL NOTES ON SHEET S001 FOR MOMENT CONNECTION DESIGN CRITERIA.



1. EXISTING TOP OF SLAB ELEVATION = 1173'-6" - FV
2. EXISTING ROOF/NEW PENTHOUSE FLOOR SLAB CONSIST OF 3-1/4" CONCRETE SLAB ON 20 GA METAL DECK (TOTAL SLAB THICKNESS = 5 1/4") - FV
3. CONNECT NEW W12X14 BEAMS TO EXISTING BEAMS USING (2)-L3X3X3/8 AND (3) 3/4" DIA F3125 GR A325 BOLTS.



6. SEE DETAIL 14/S820 FOR TYPICAL MOMENT CONNECTION (SHOWN AS ► ON PLAN). SEE GENERAL NOTES ON SHEET S001 FOR MOMENT CONNECTION DESIGN CRITERIA.



SCALE: 1/8" = 1'-0"



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THIRD FLOOR FRAMING PLAN

Approved:

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EXPAND PHARMACY AND RADIOLOGY
OSCAR G. JOHNSON VA MEDICAL CENTER

Location	325 H STREET IRON MOUNTAIN
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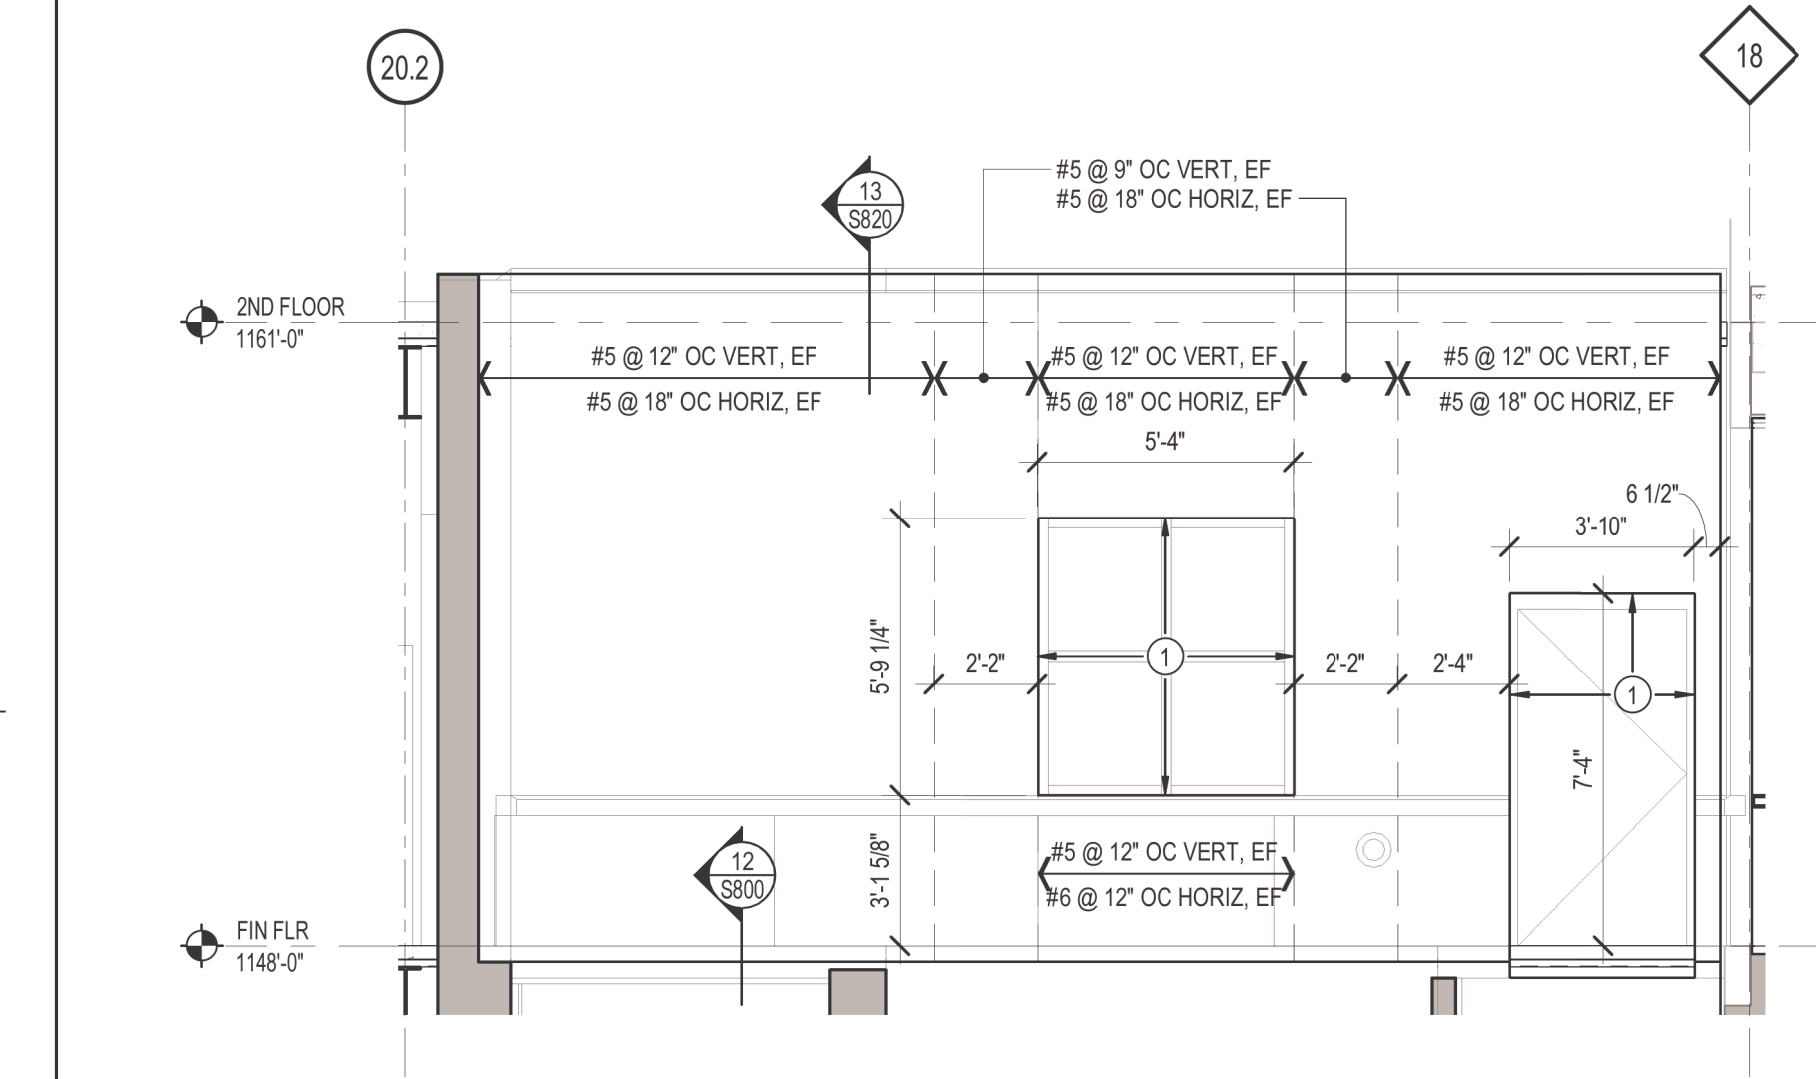
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585-337


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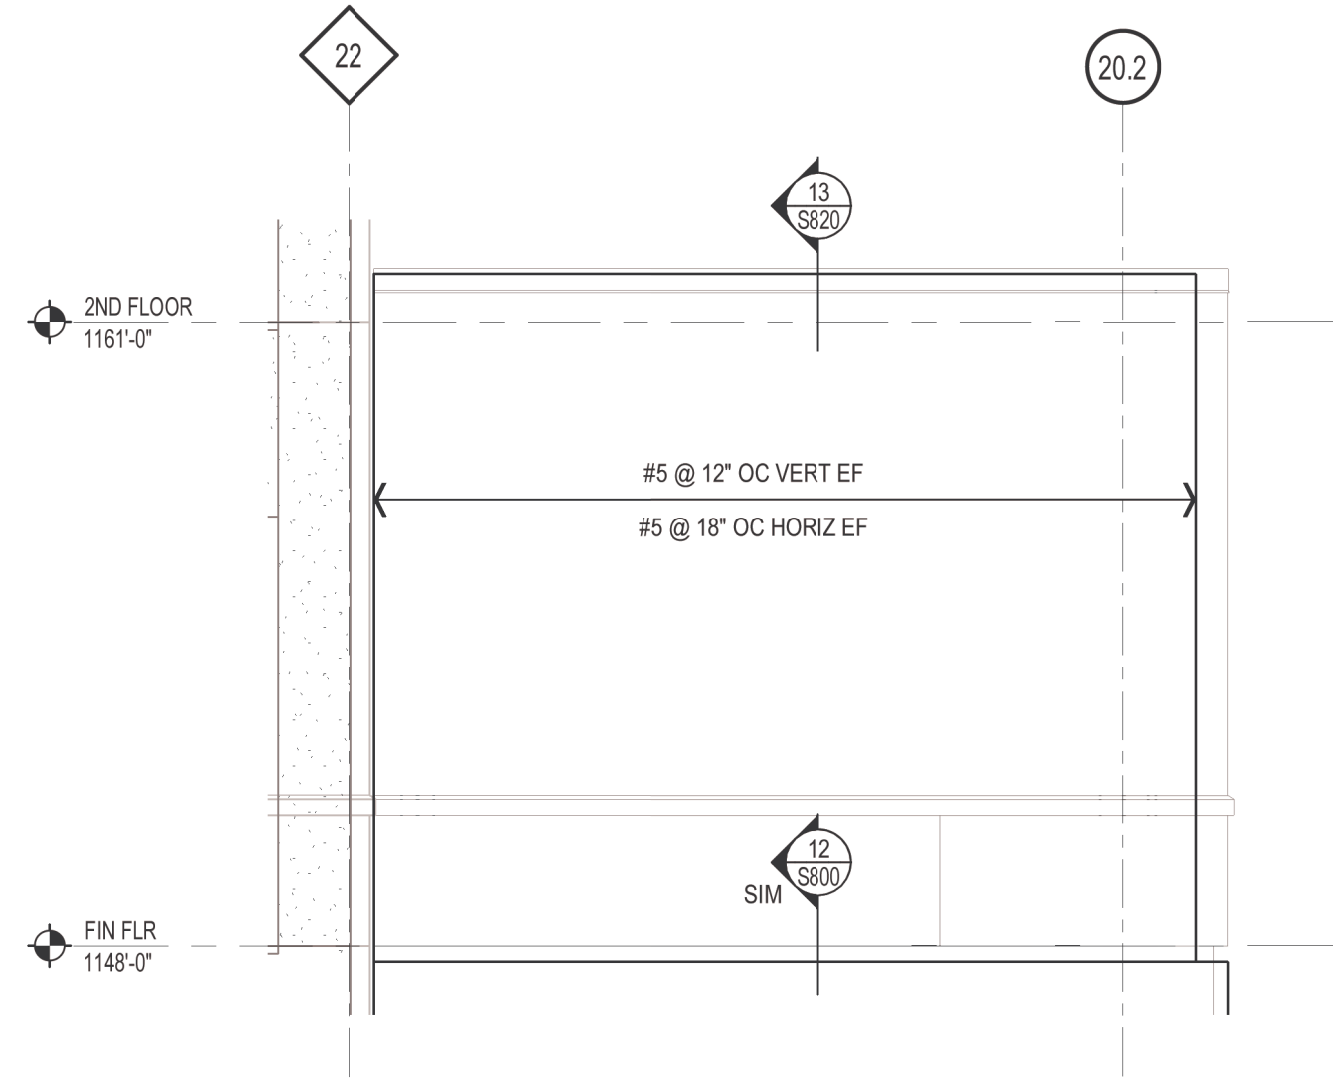
S203
DWG. 50 OF 126



1 WEST ADDITION, WEST ELEVATION: WALL REINFORCEMENT
SCALE: 1/4" = 1'-0"




2 WEST ADDITION, WEST ELEVATION: WALL REINFORCEMENT
SCALE: 1/4" = 1'-0"

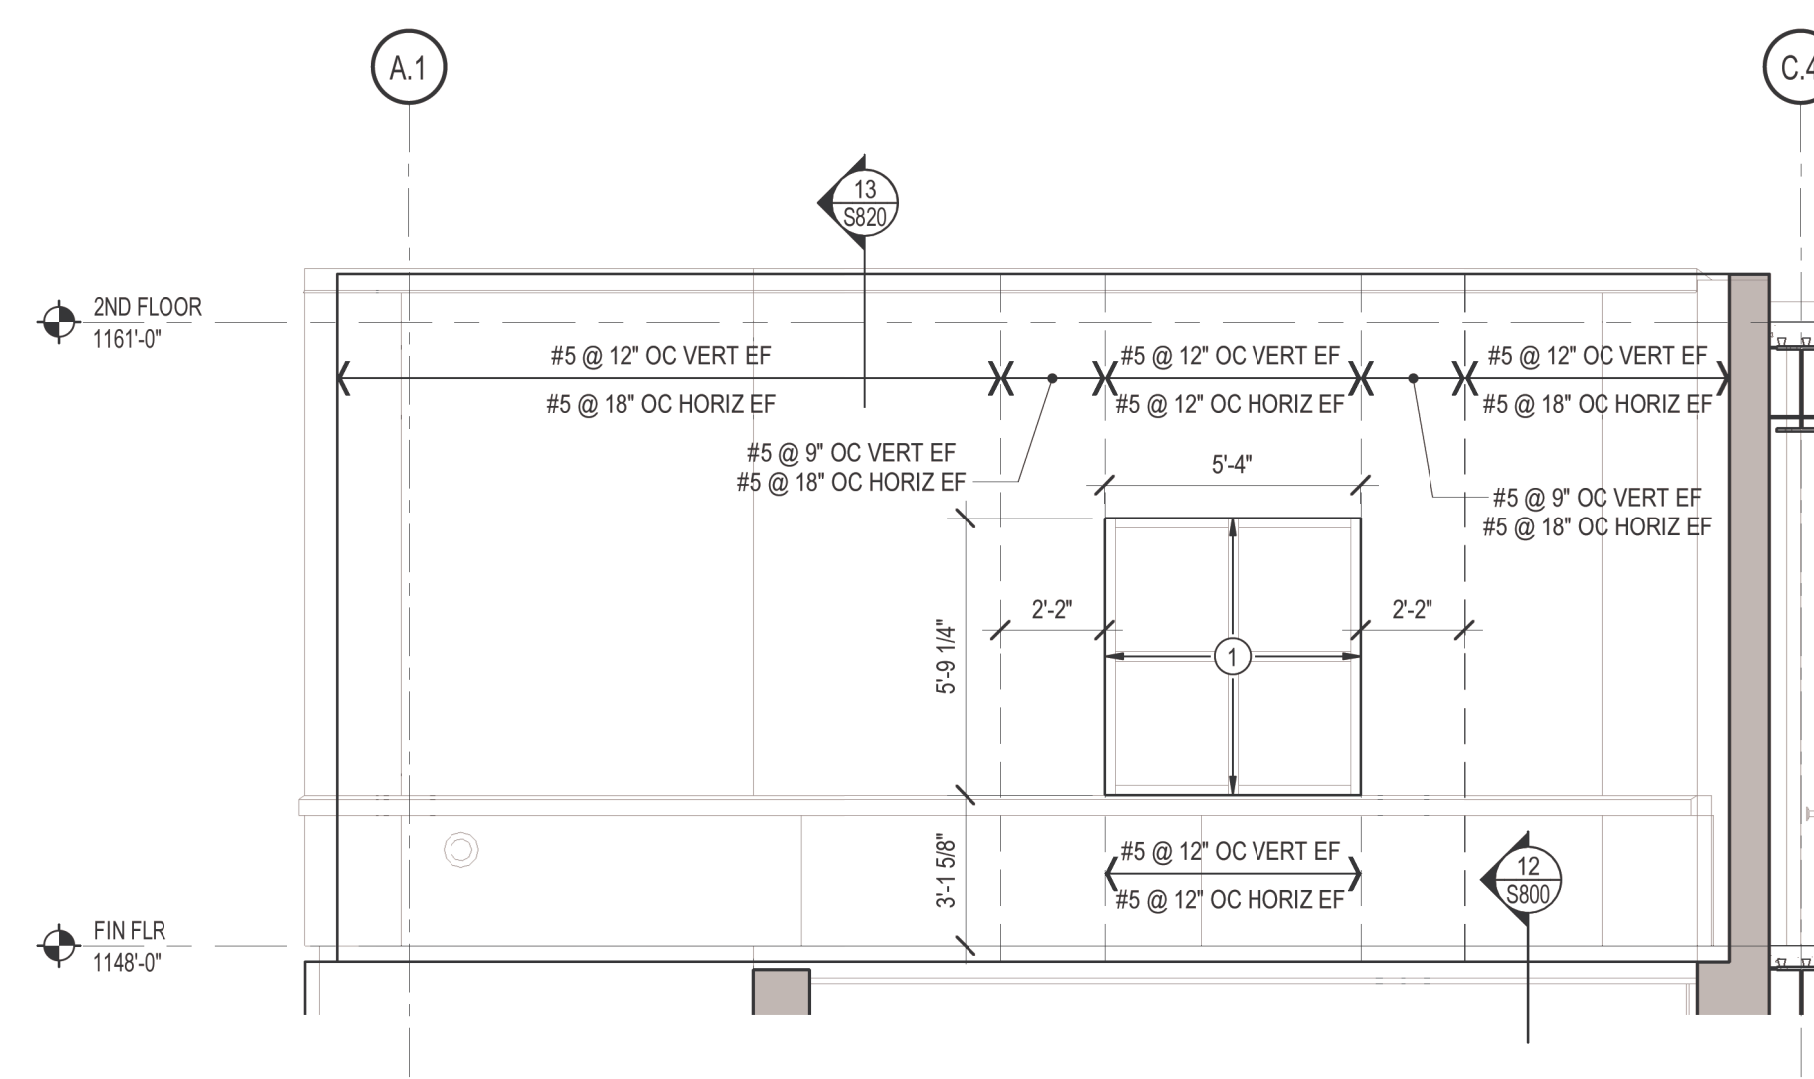


3 WEST ADDITION, NORTH ELEVATION: WALL REINFORCEMENT
SCALE: 1/4" = 1'-0"

WALL ELEVATION KEY NOTES


- 1 PROVIDE PL12X8XCONT w/ 1/2" DIA x 6" LONG NELSON STUDS AT 12" OC ALONG JAMES AND HEADERS. PLATE SIZING IS FOR INFORMATIONAL PURPOSES ONLY AND SHALL BE FINALIZED BASED ON COORDINATION WITH WINDOW/DOOR SUPPLIER.
- 2 PROVIDE PL12X8XCONT w/ 3/4" DIA CONCRETE SCREW ANCHORS (MIN 5" EMBED) AT 12" OC ALONG INTO EXISTING CONCRETE BEAM. PLATE SIZING IS FOR INFORMATIONAL PURPOSES ONLY AND SHALL BE FINALIZED BASED ON COORDINATION WITH WINDOW/DOOR SUPPLIER.

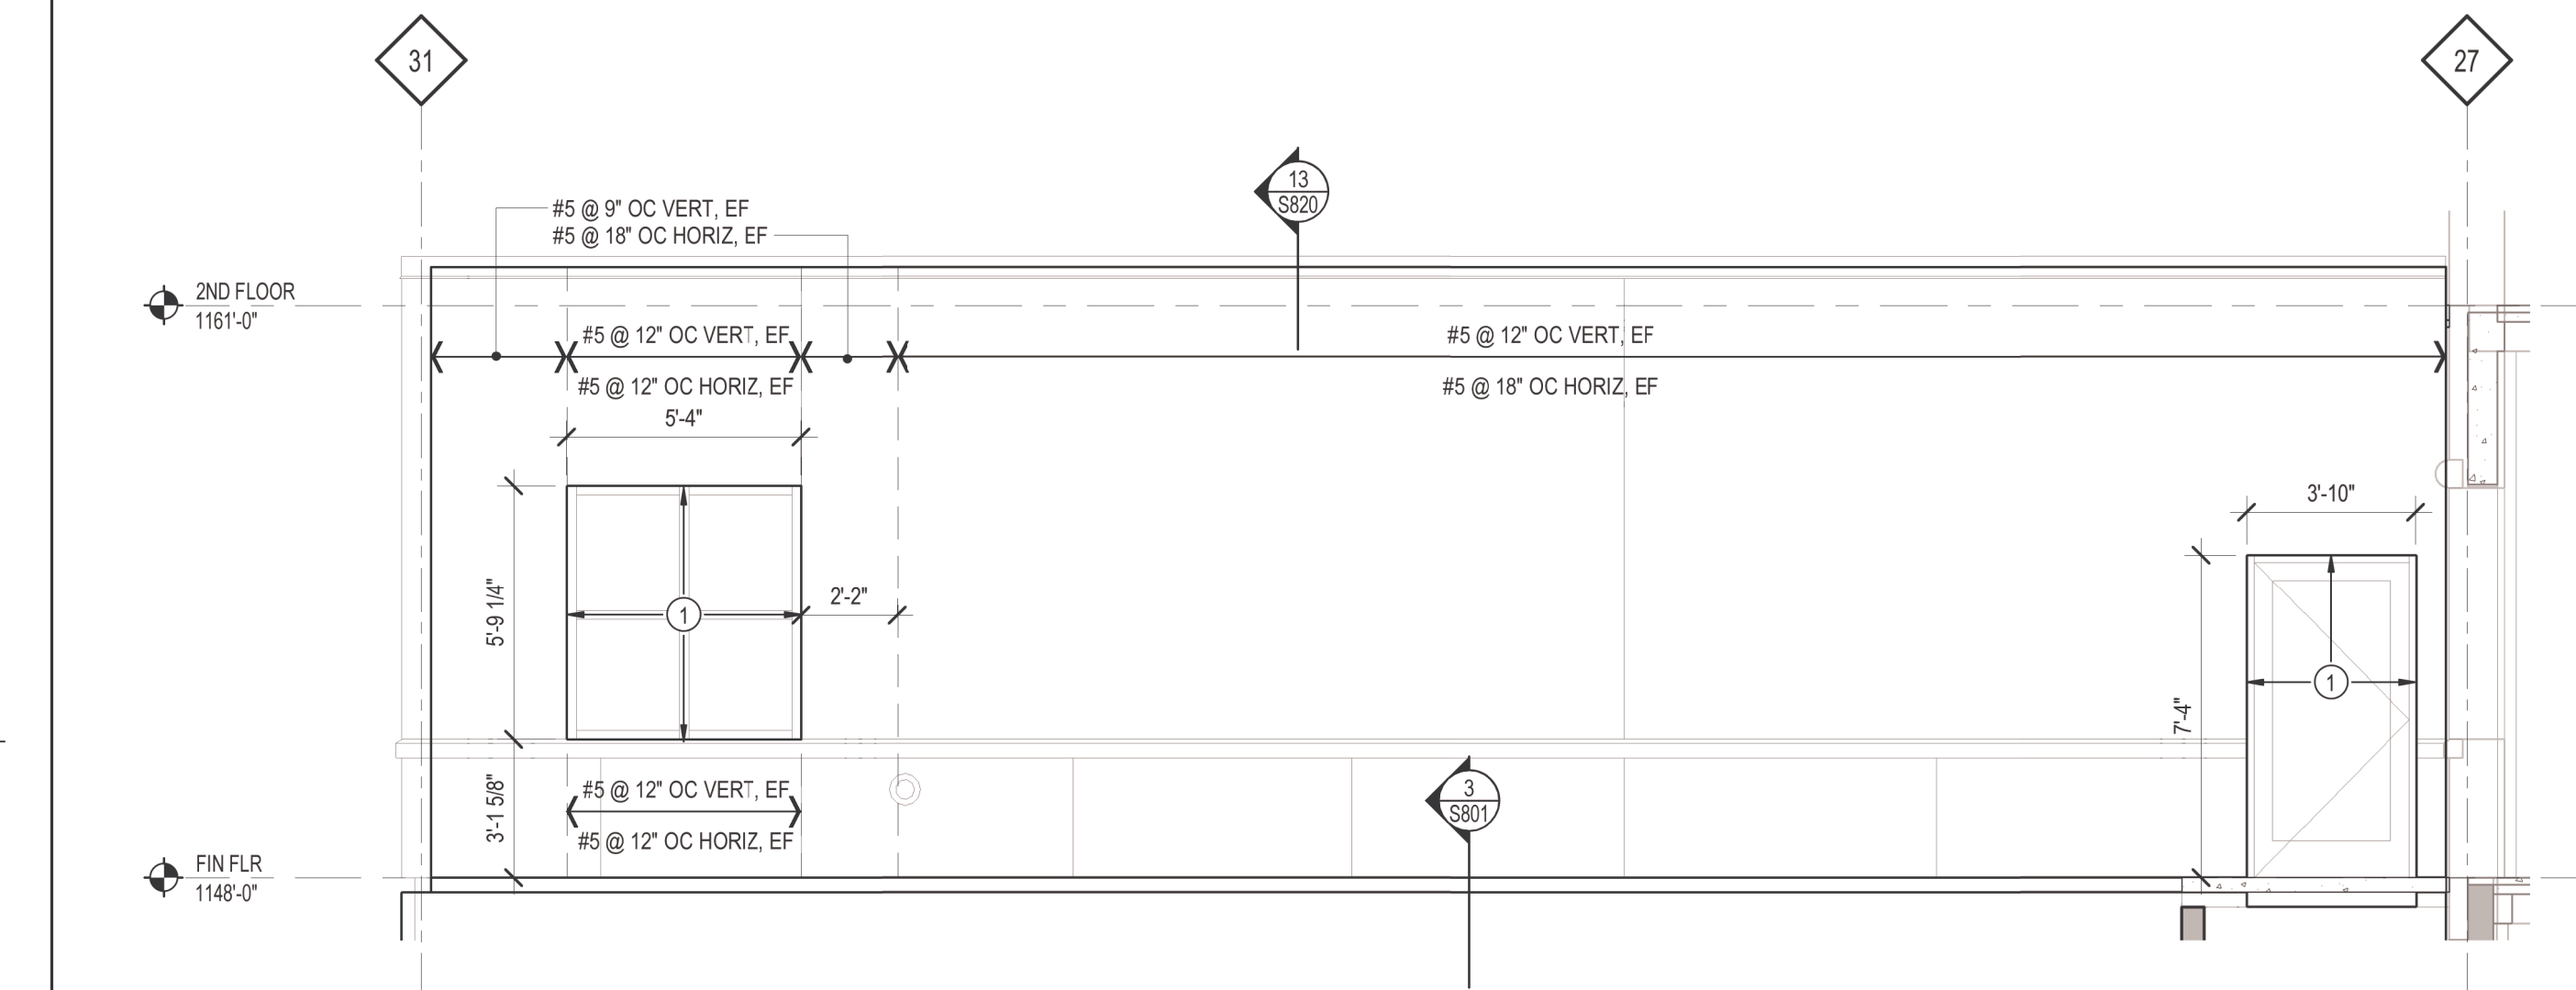


4 EAST ADDITION, NORTH ELEVATION: WALL REINFORCEMENT
SCALE: 1/4" = 1'-0"

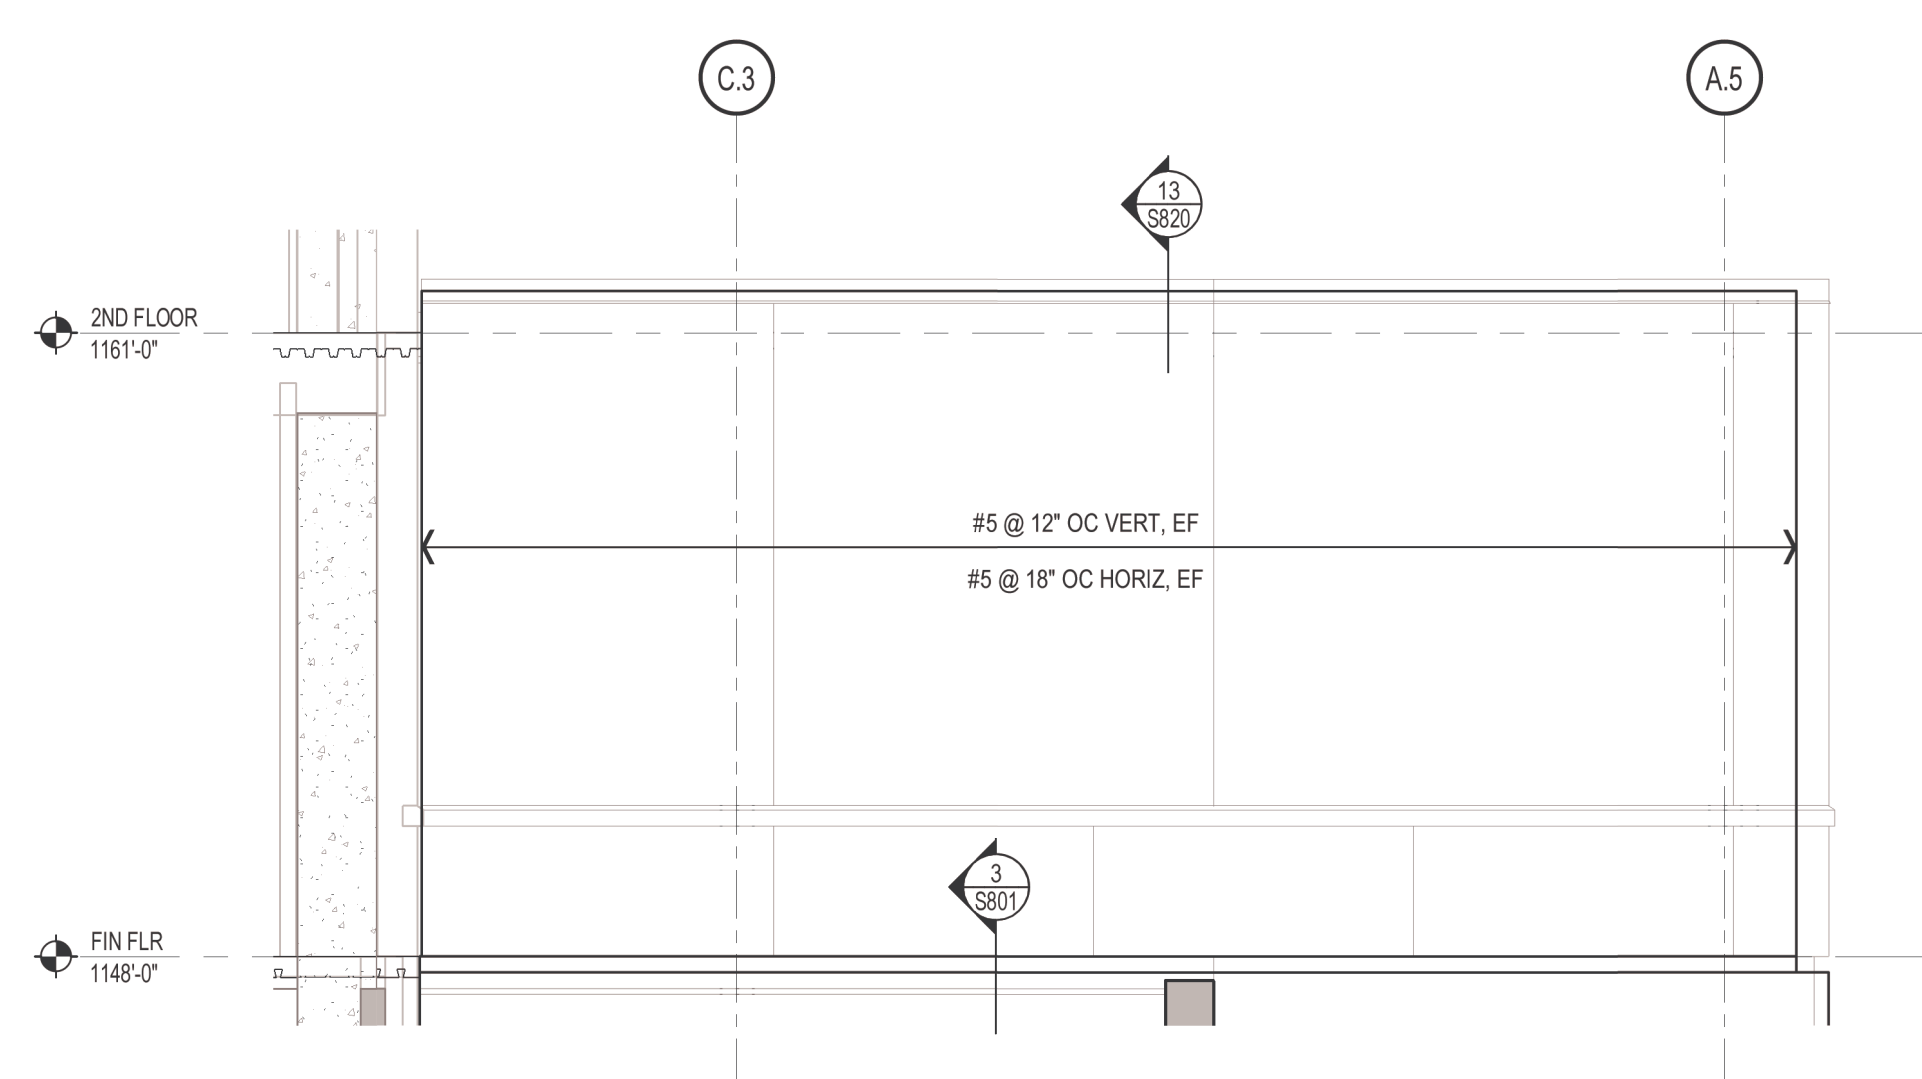


5 EAST ADDITION, EAST ELEVATION: WALL REINFORCEMENT
SCALE: 1/4" = 1'-0"

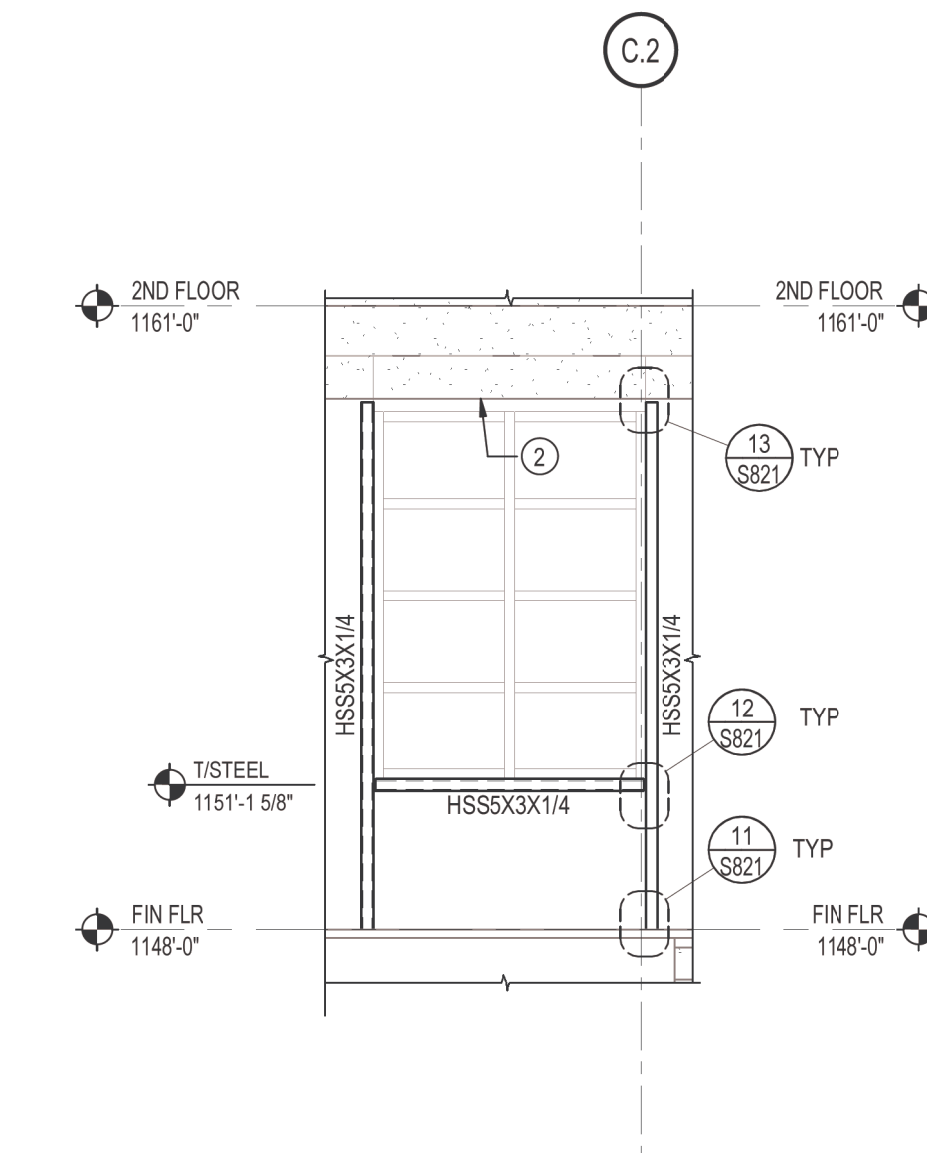


6 WALL FRAME ELEVATION
SCALE: 1/4" = 1'-0"

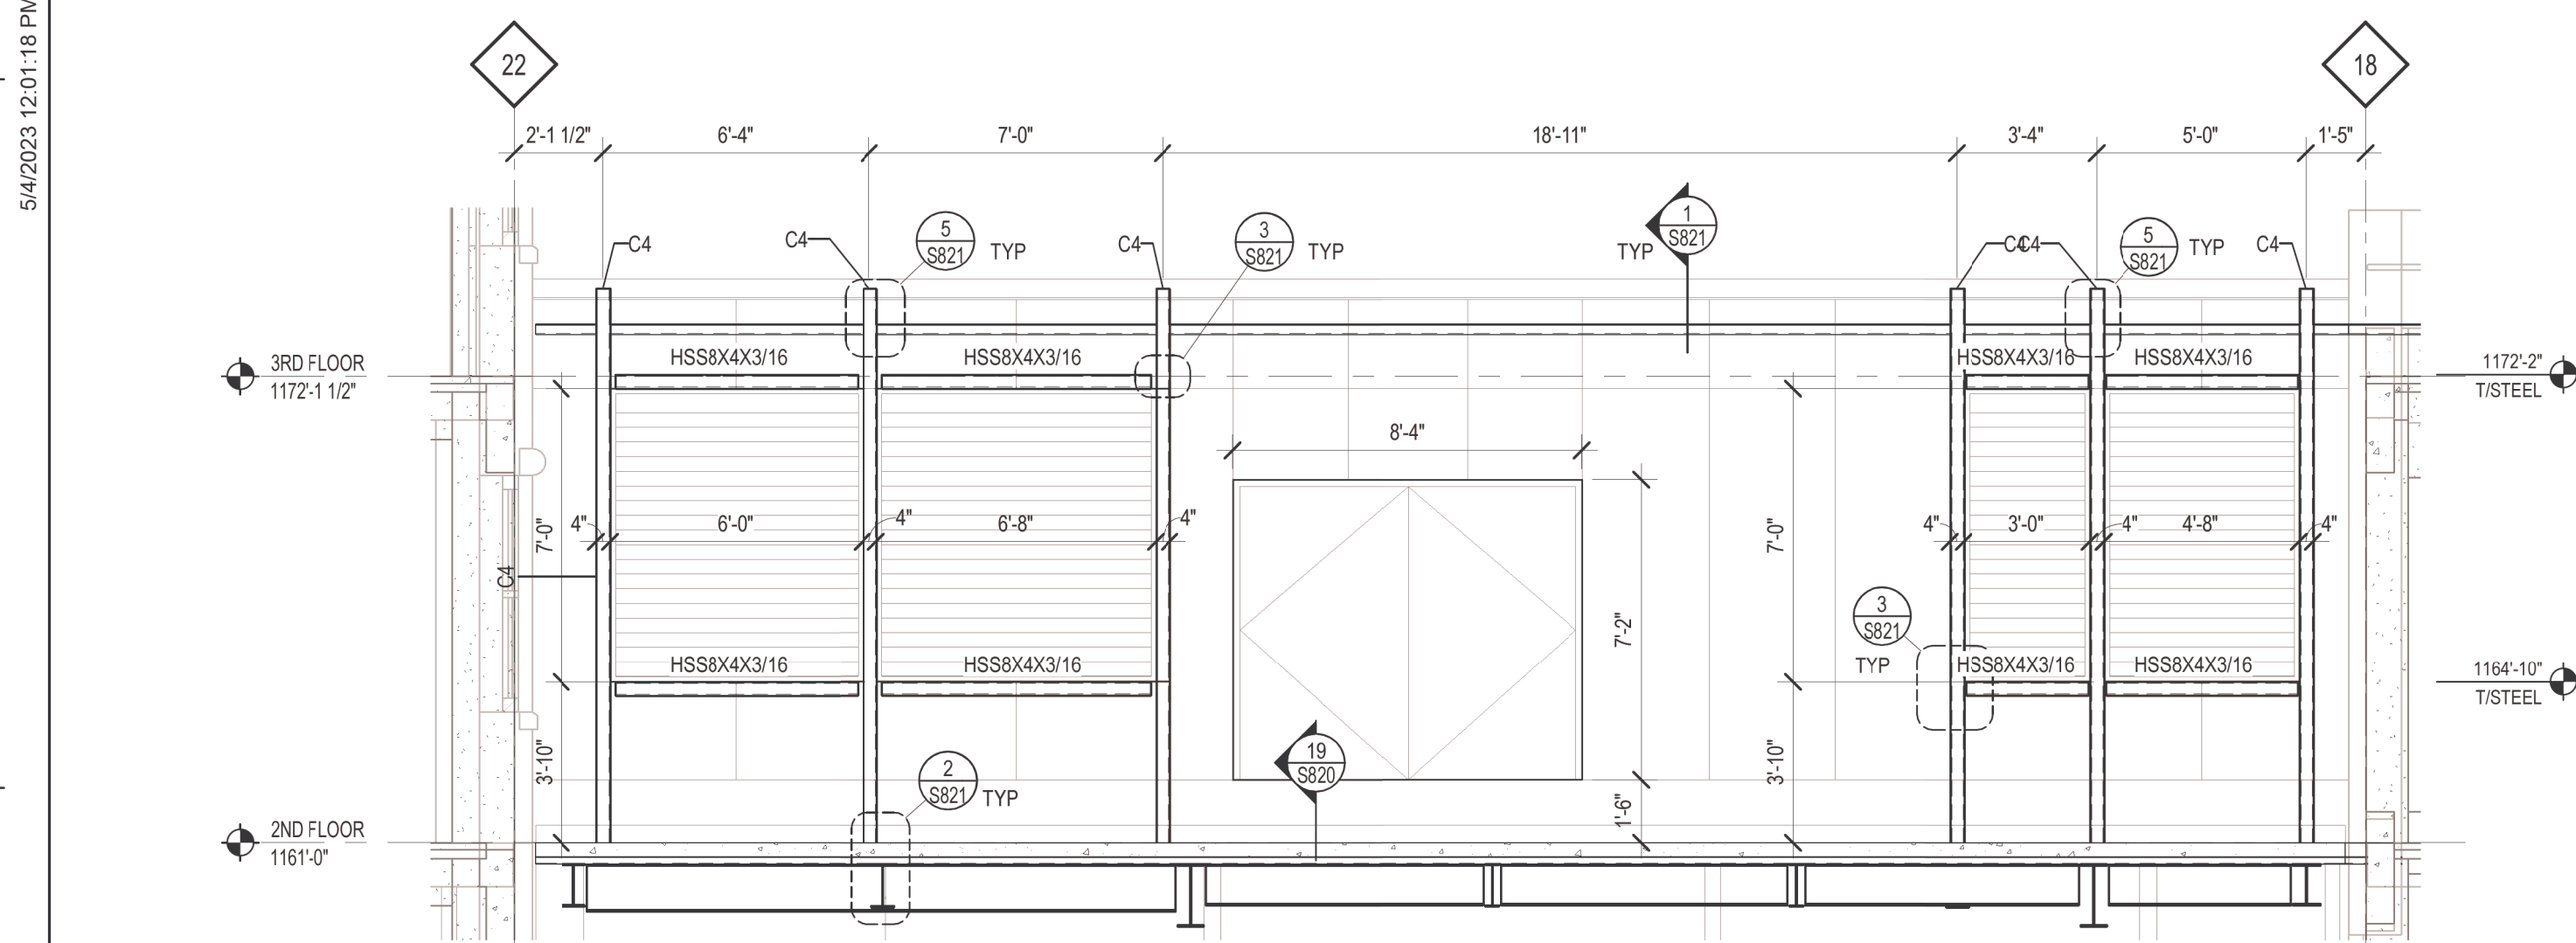

7 WALL FRAME ELEVATION
SCALE: 1/4" = 1'-0"

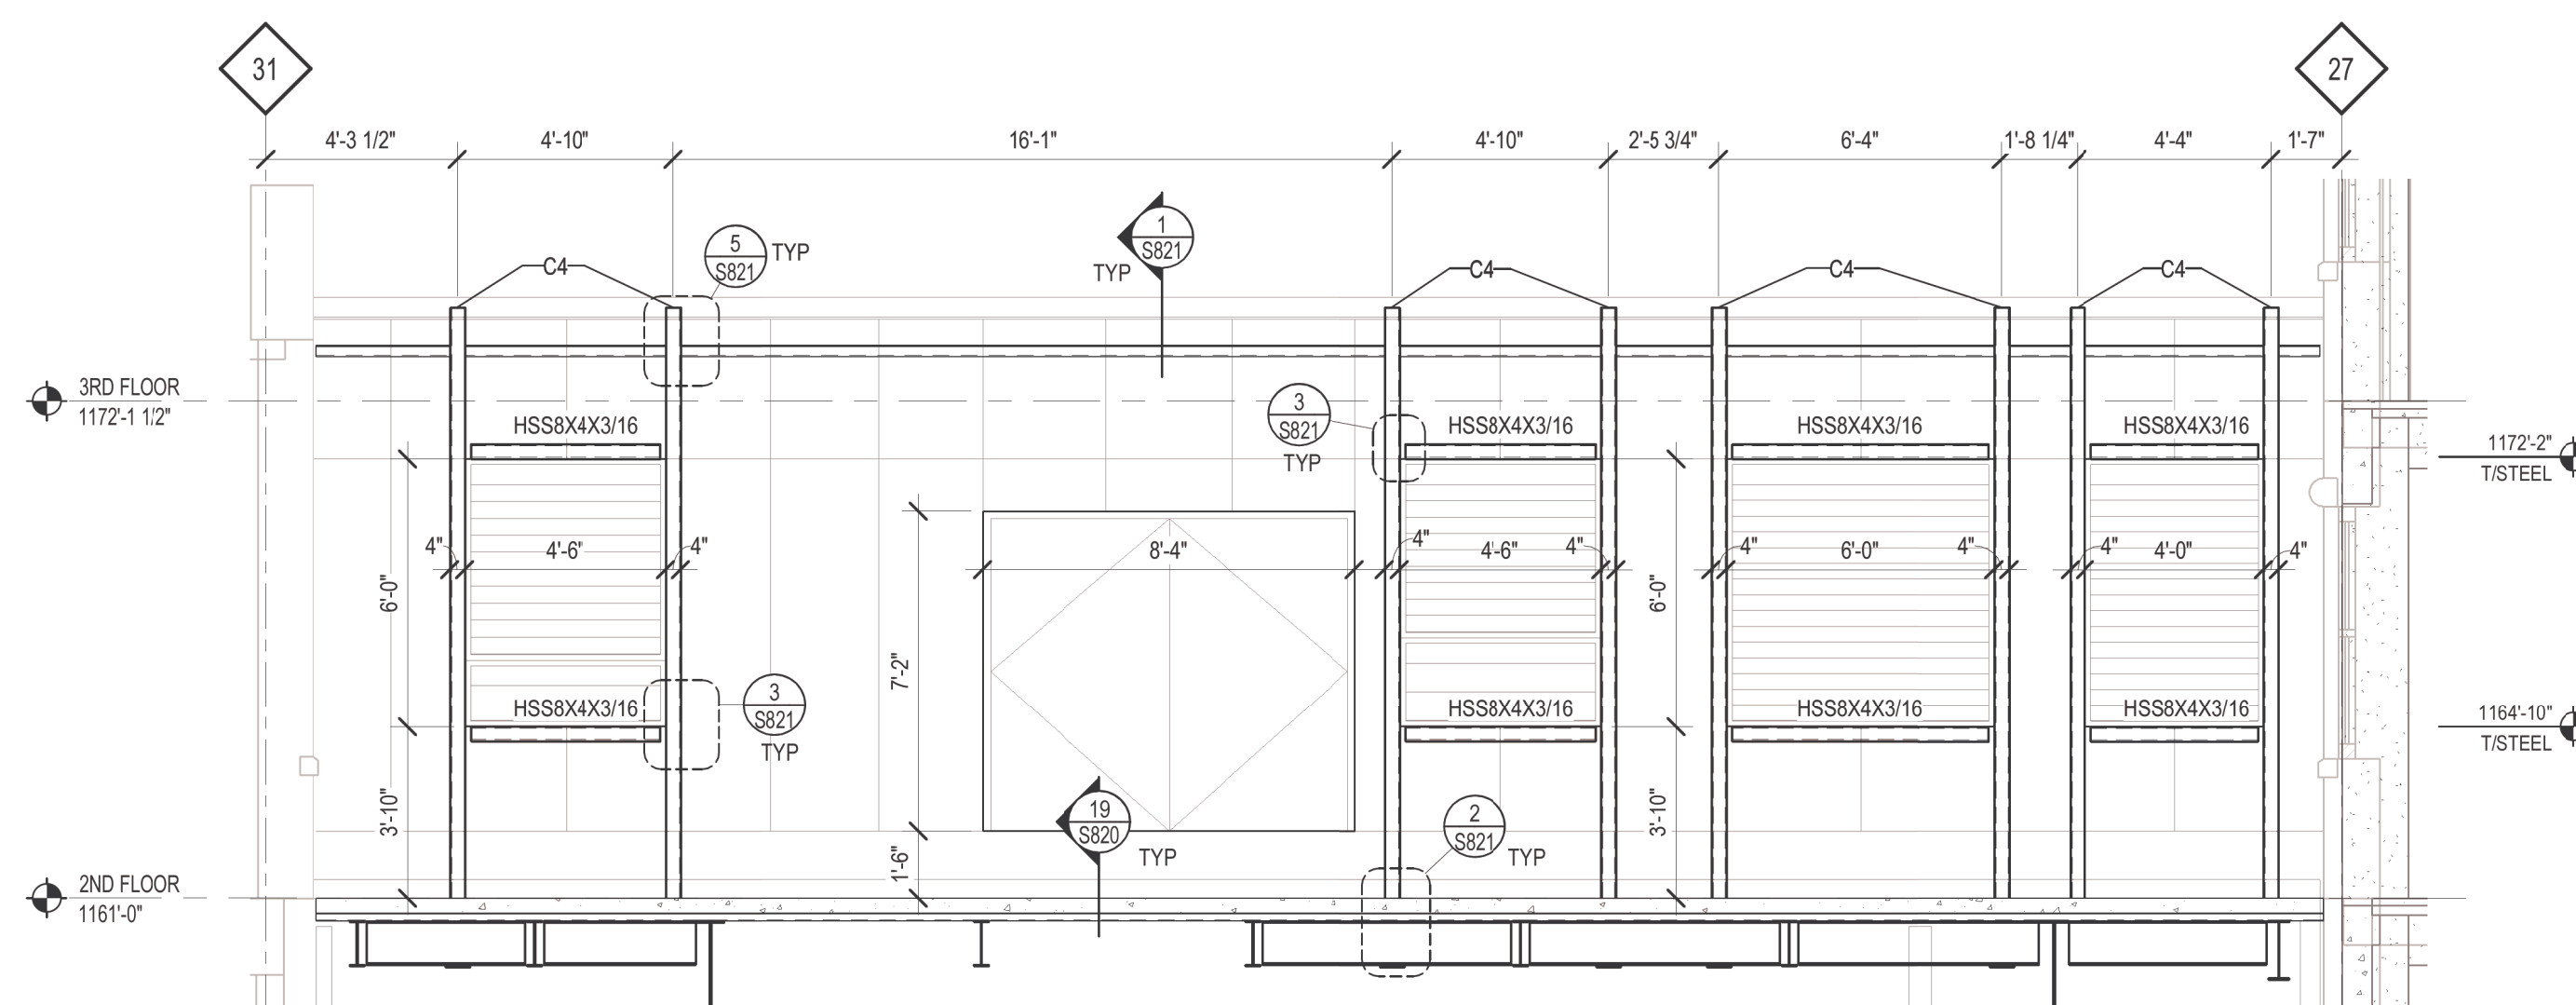

8 WALL FRAME ELEVATION
SCALE: 1/4" = 1'-0"

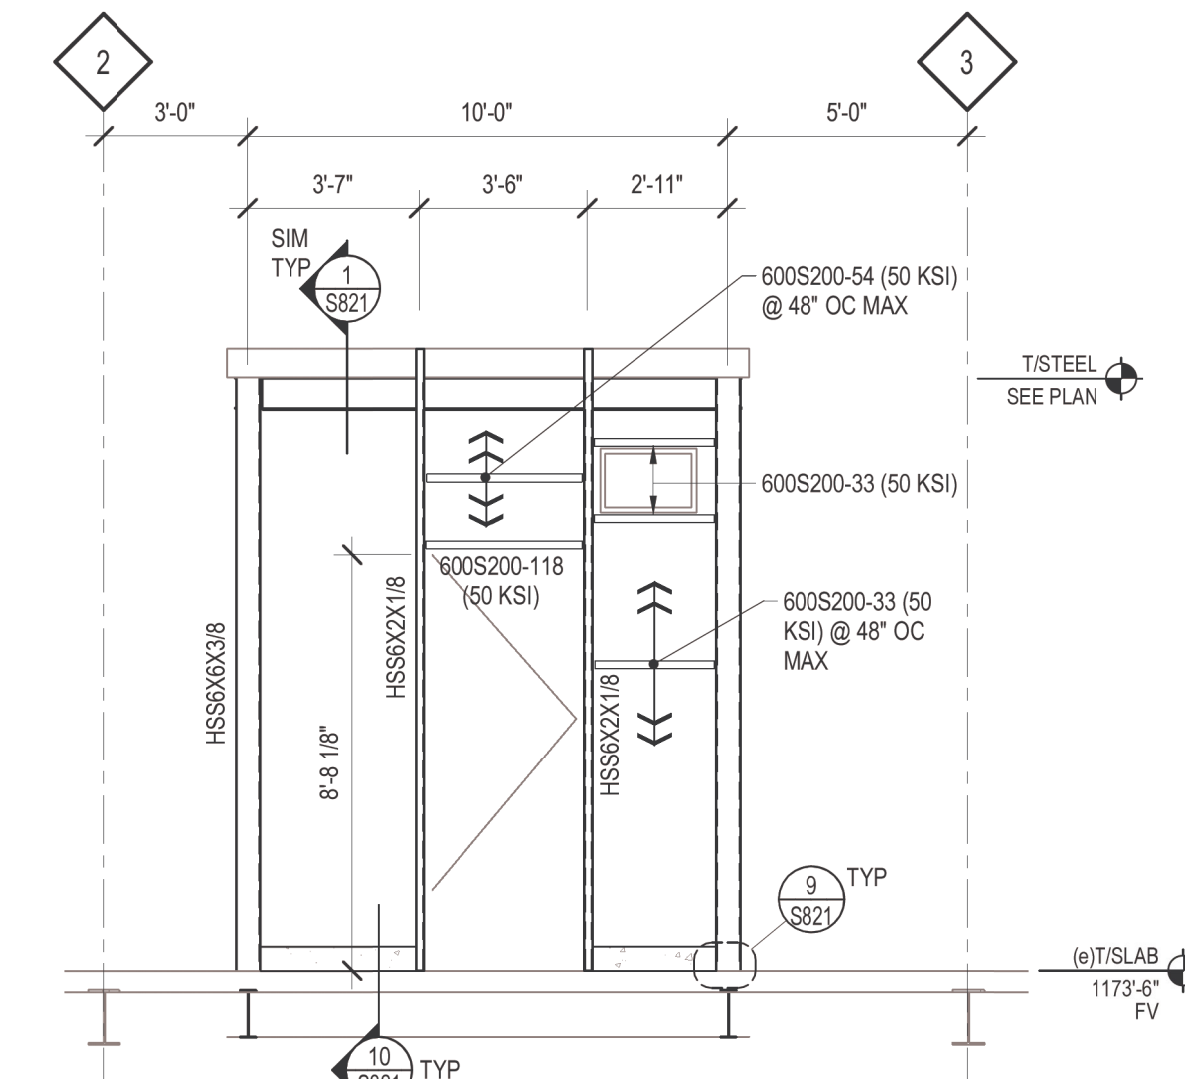

9 WALL FRAME ELEVATION
SCALE: 1/4" = 1'-0"

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raSmith
CREATIVITY BEYOND ENGINEERING

16745 W. Bluemound Road
Brookfield, WI 53005-5938
(262) 781-1000
rasmith.com

raSmith Project Number: 1200712

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ARCHITECT/ENGINEER OF RECORD

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Comm. Number: 6163.03
310 Pine Street | Green Bay, WI 54301
920-432-4865 | www.bernerschaber.com
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Drawing Title

WALL REINFORCEMENT ELEVATIONS

Approved:

Phase

CONSTRUCTION SET

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Project Title

EXPAND PHARMACY AND RADIOLOGY
OSCAR G. JOHNSON VA MEDICAL CENTER

Location

325 H STREET,
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Issue Date

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585-337


Building Number




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DWG. 51 OF 126





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raSmith Project Number: 1200712

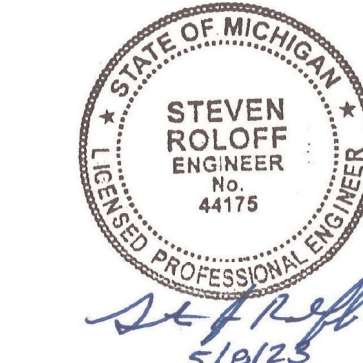16745 W. Bluemound Road
Brookfield, WI 53005-5938
(262) 781-1000
rasmith.com

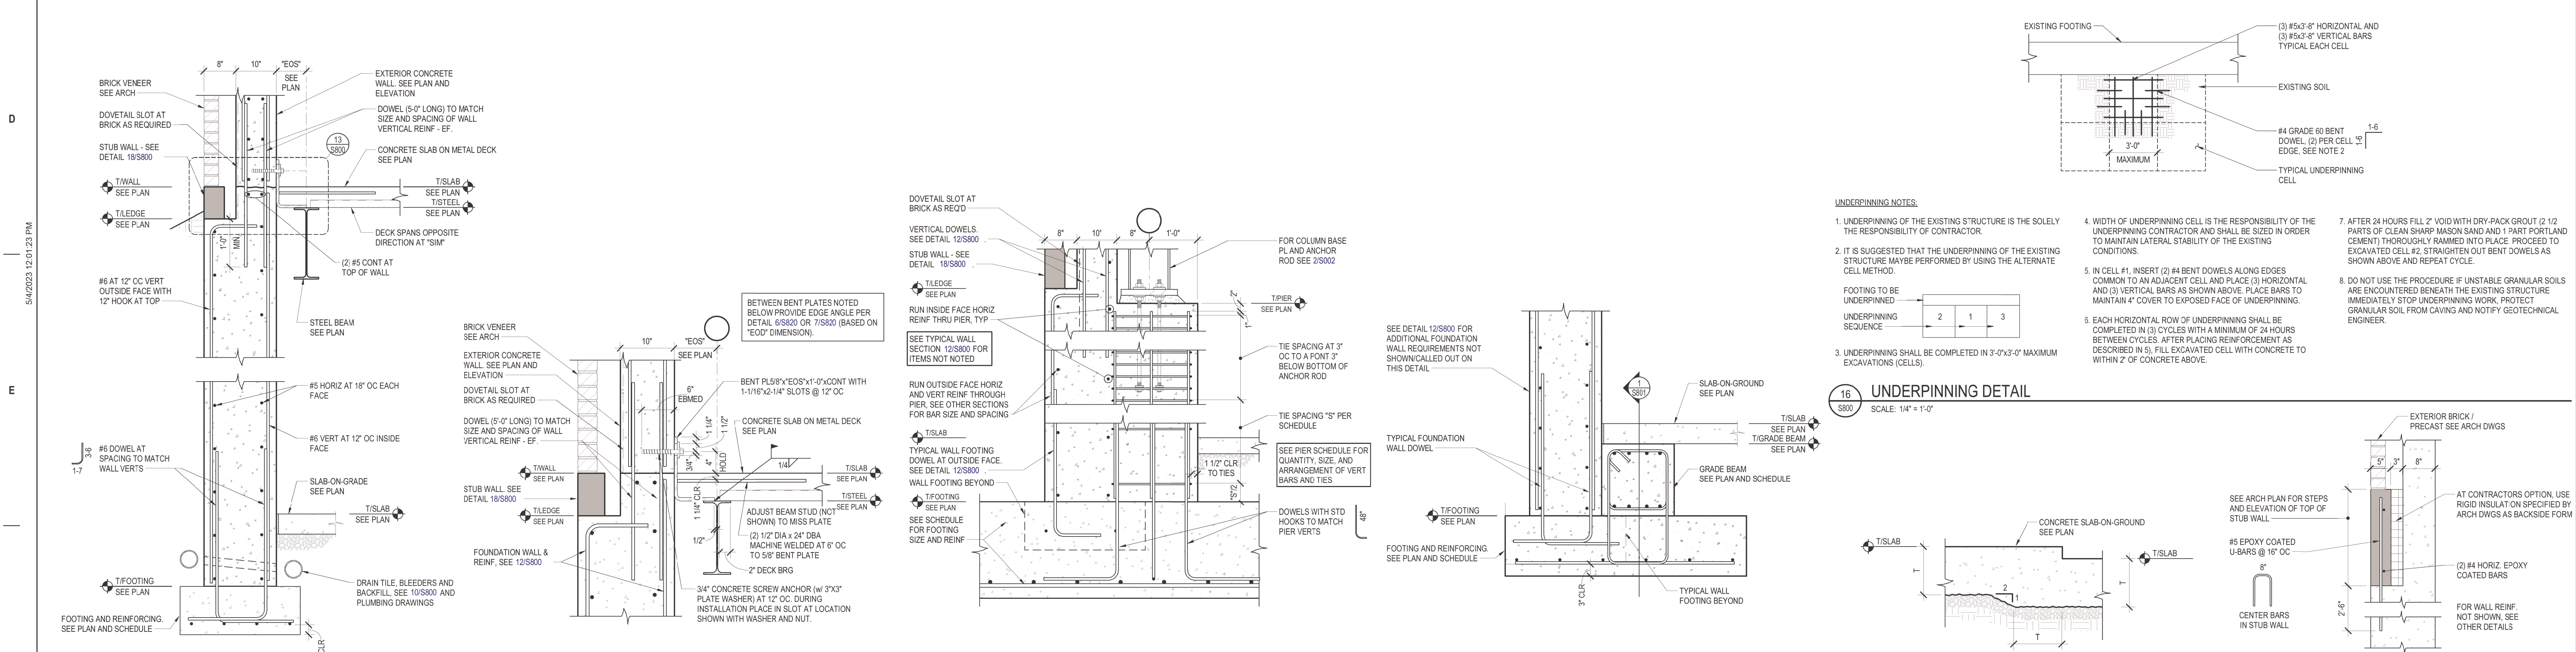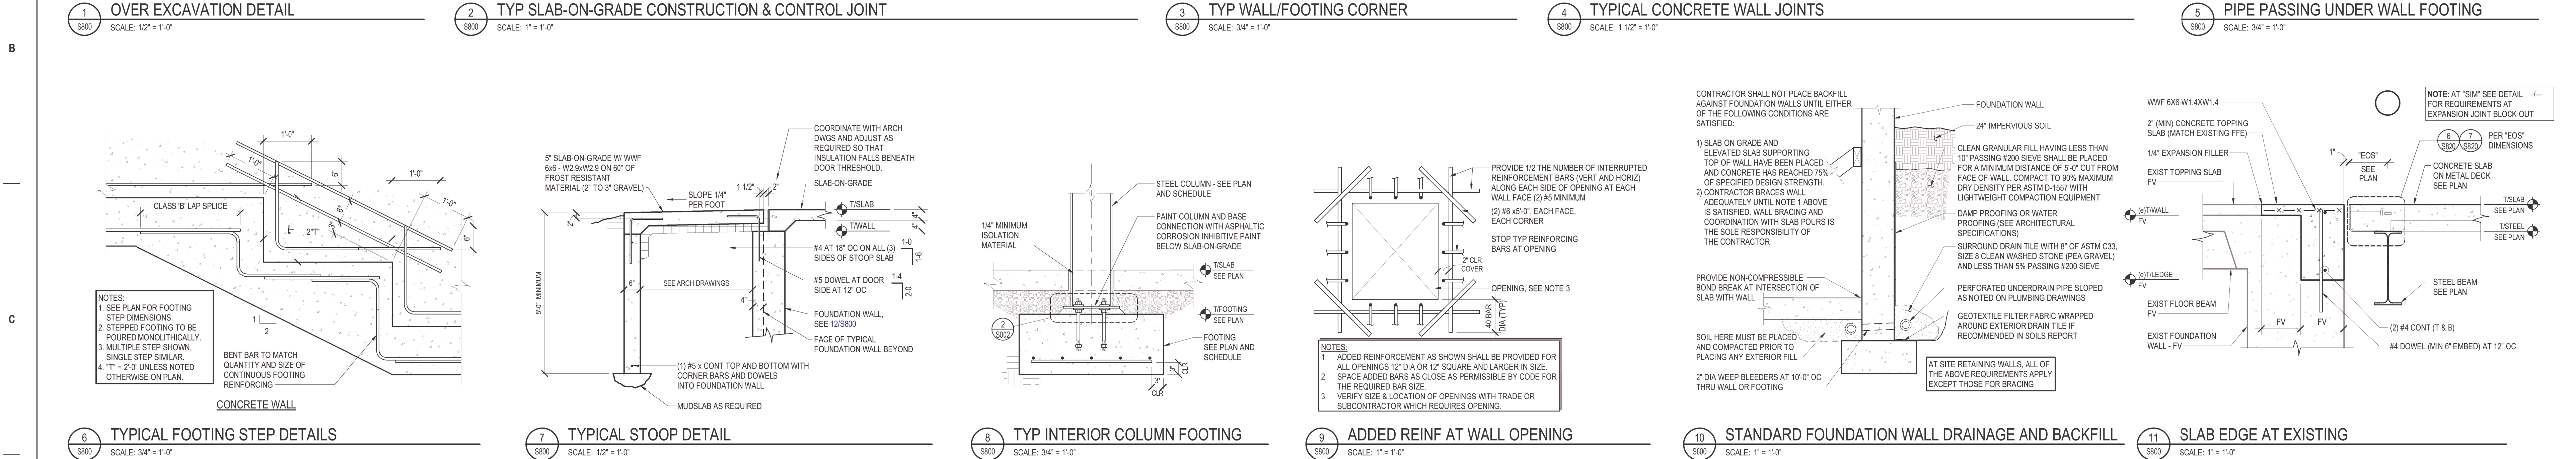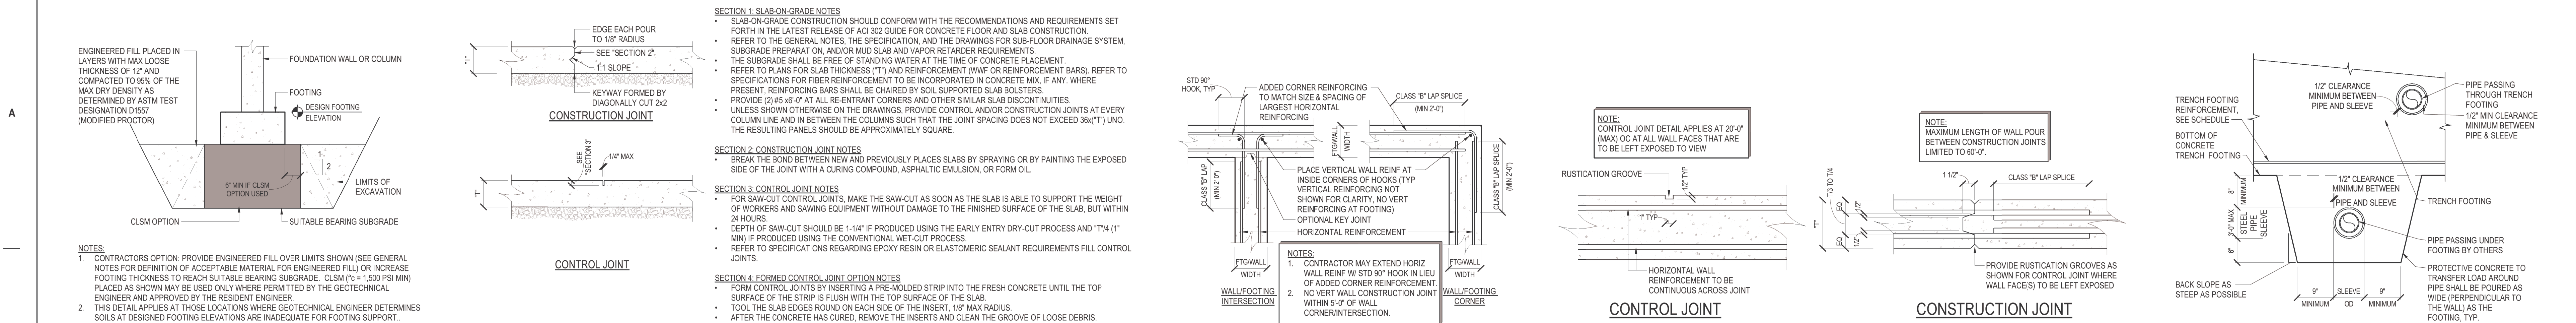ARCHITECT/ENGINEER OF RECORD

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Comm. Number: 6163.03
310 Pine Street | Green Bay, WI 54301
920-452-4865 | www.bernerschaber.com
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Drawing Title
FOUNDATION DETAILS

Approved:

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Project Title
EXPAND PHARMACY AND RADIOLOGY
OSCAR G. JOHNSON VA MEDICAL CENTER

Location
325 H STREET,
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585-337

Building Number
1

Drawing Number
S800
DWG. 52 OF 126

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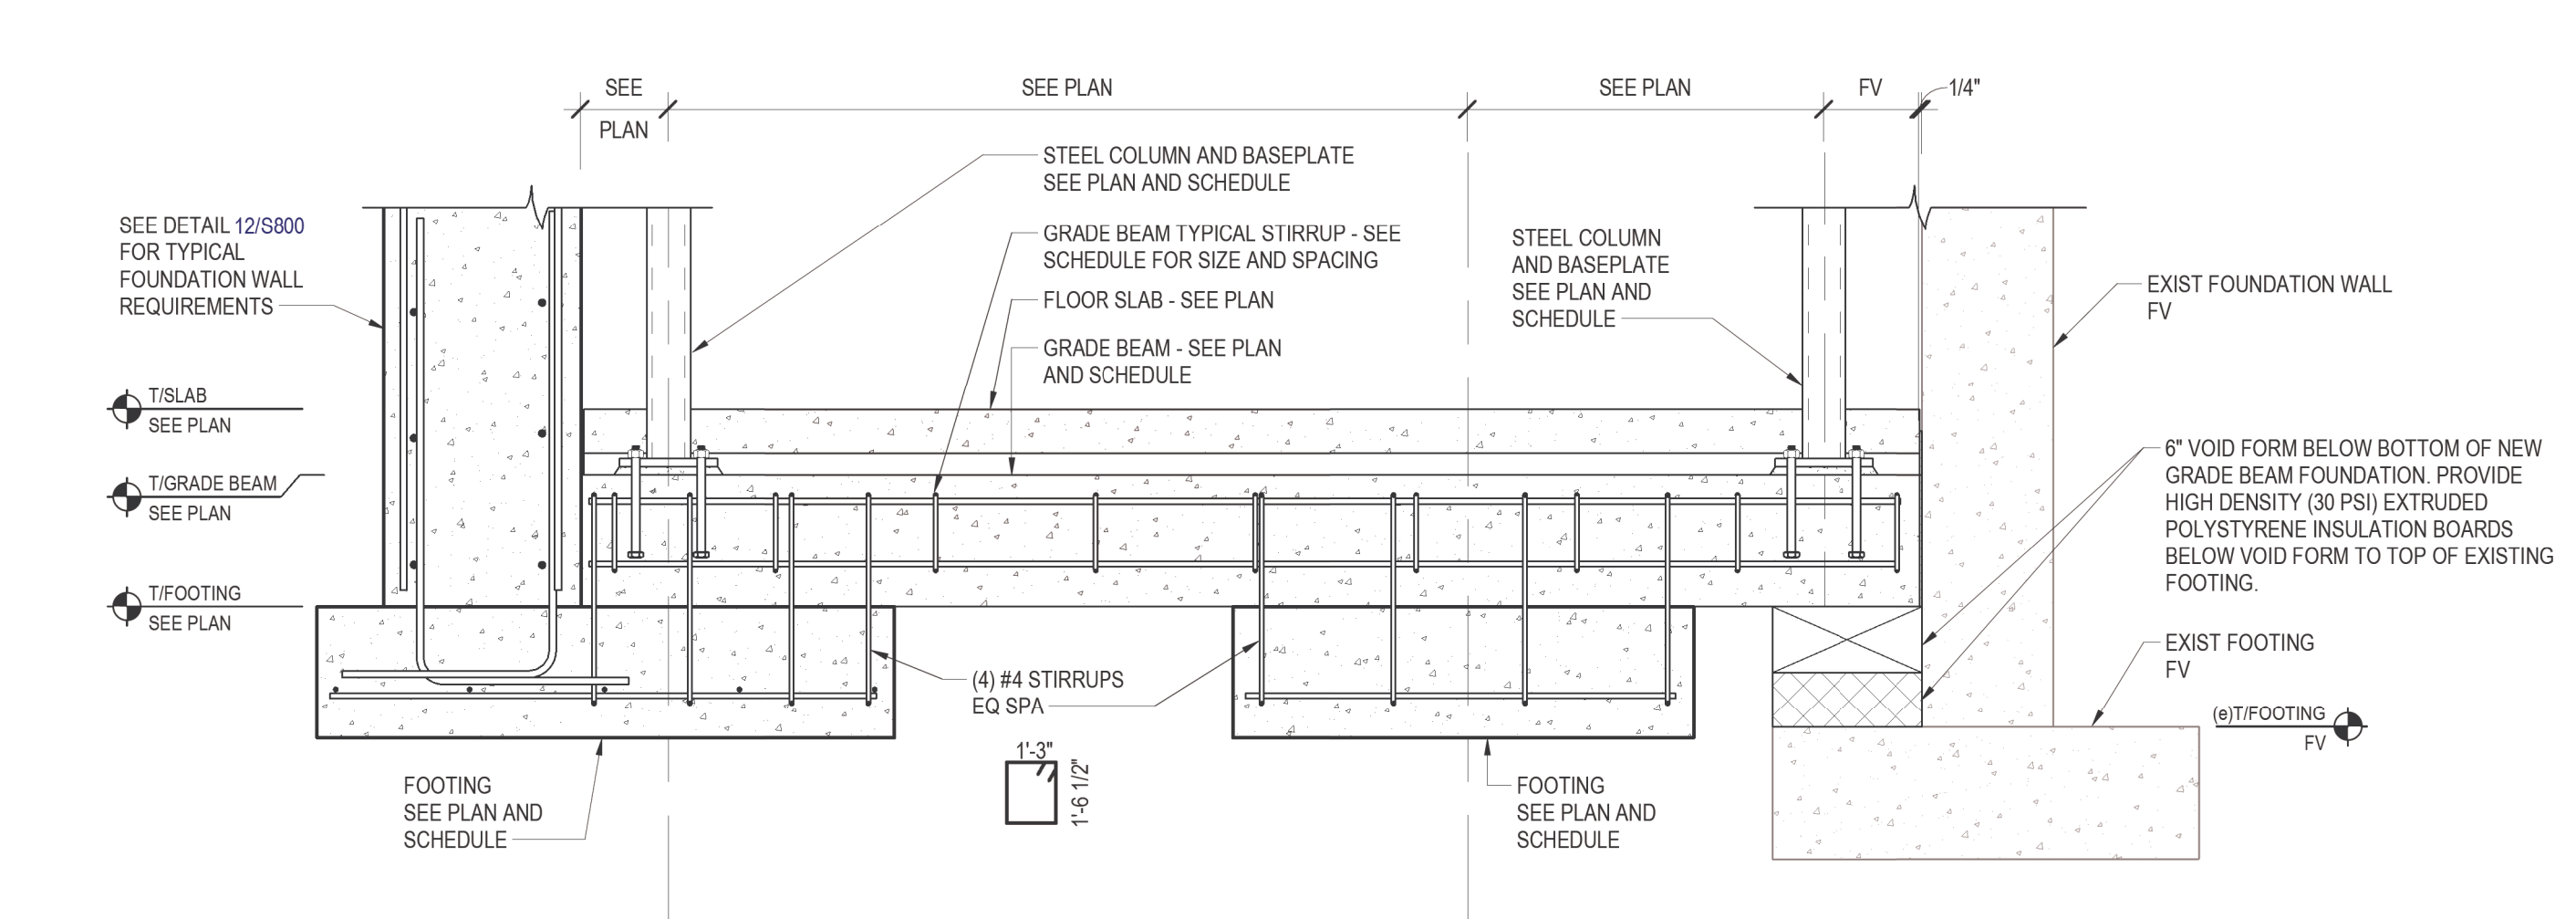
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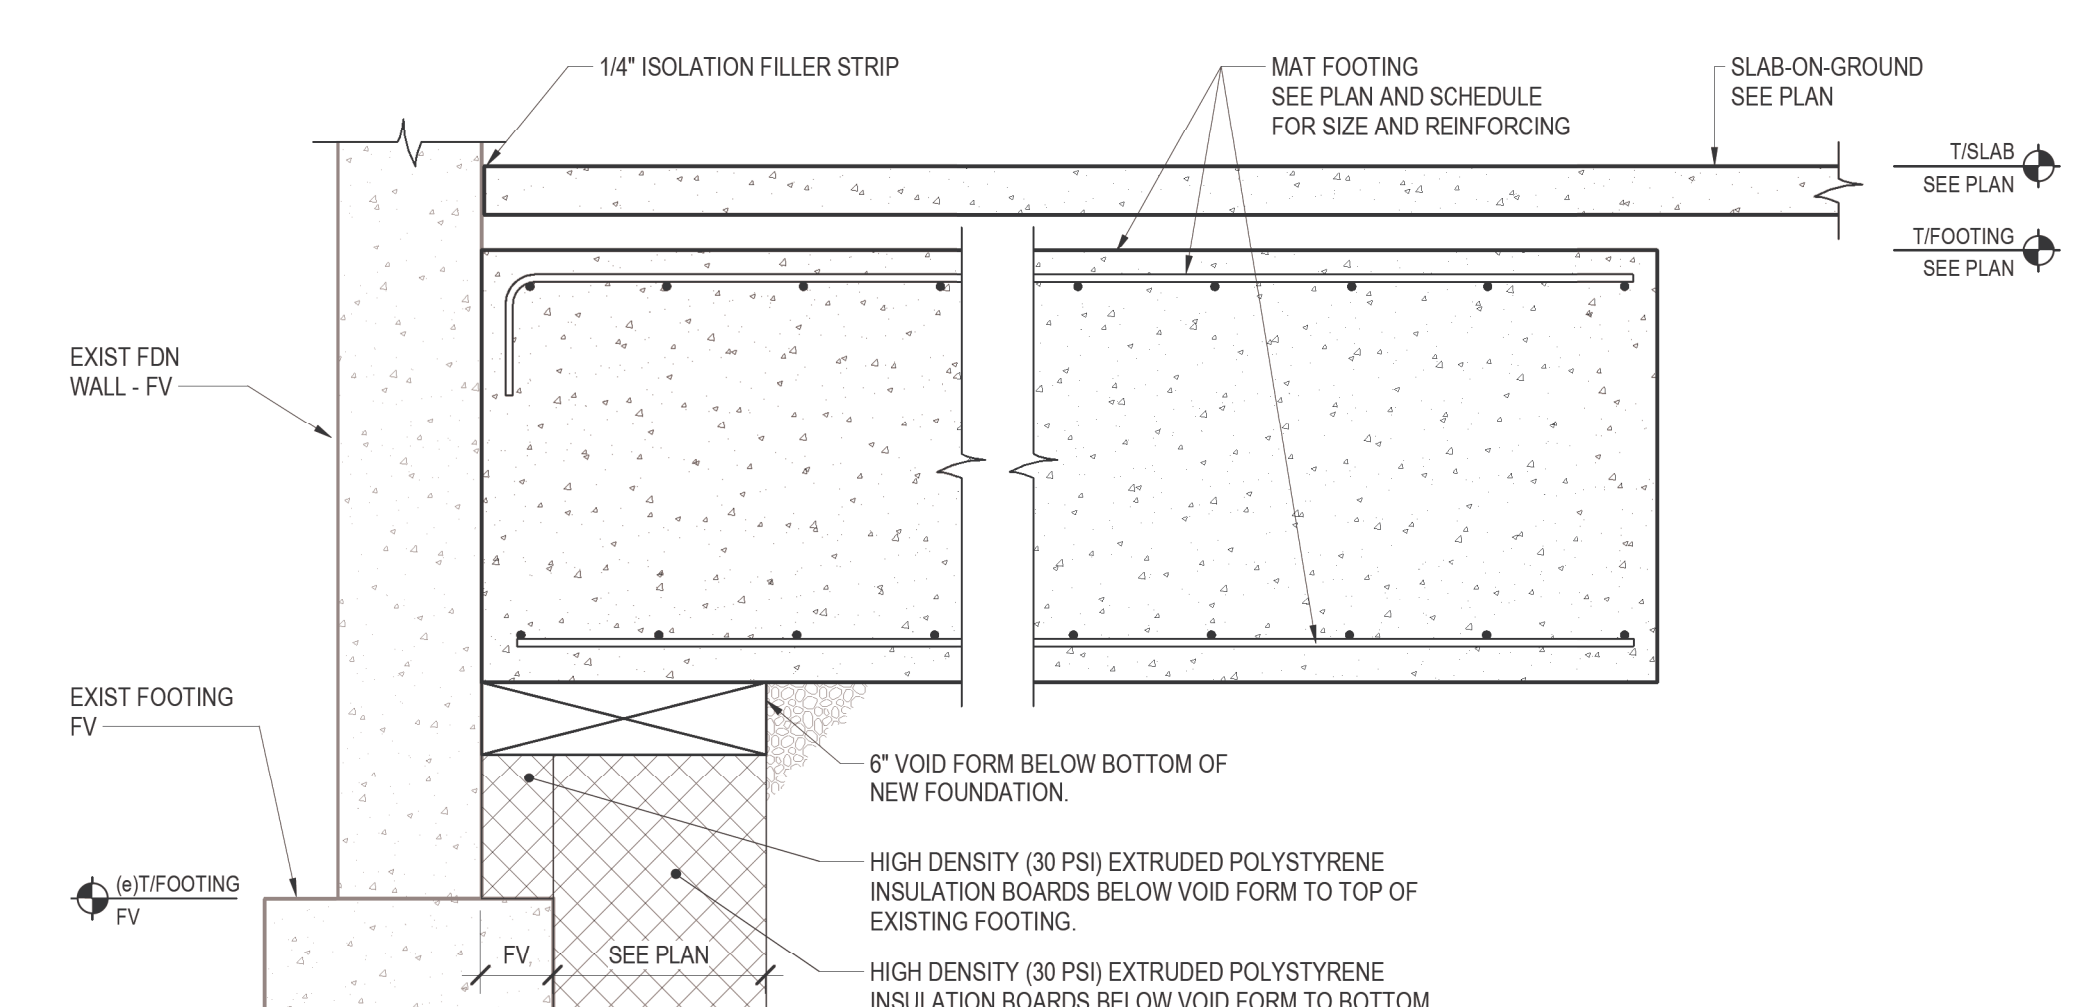
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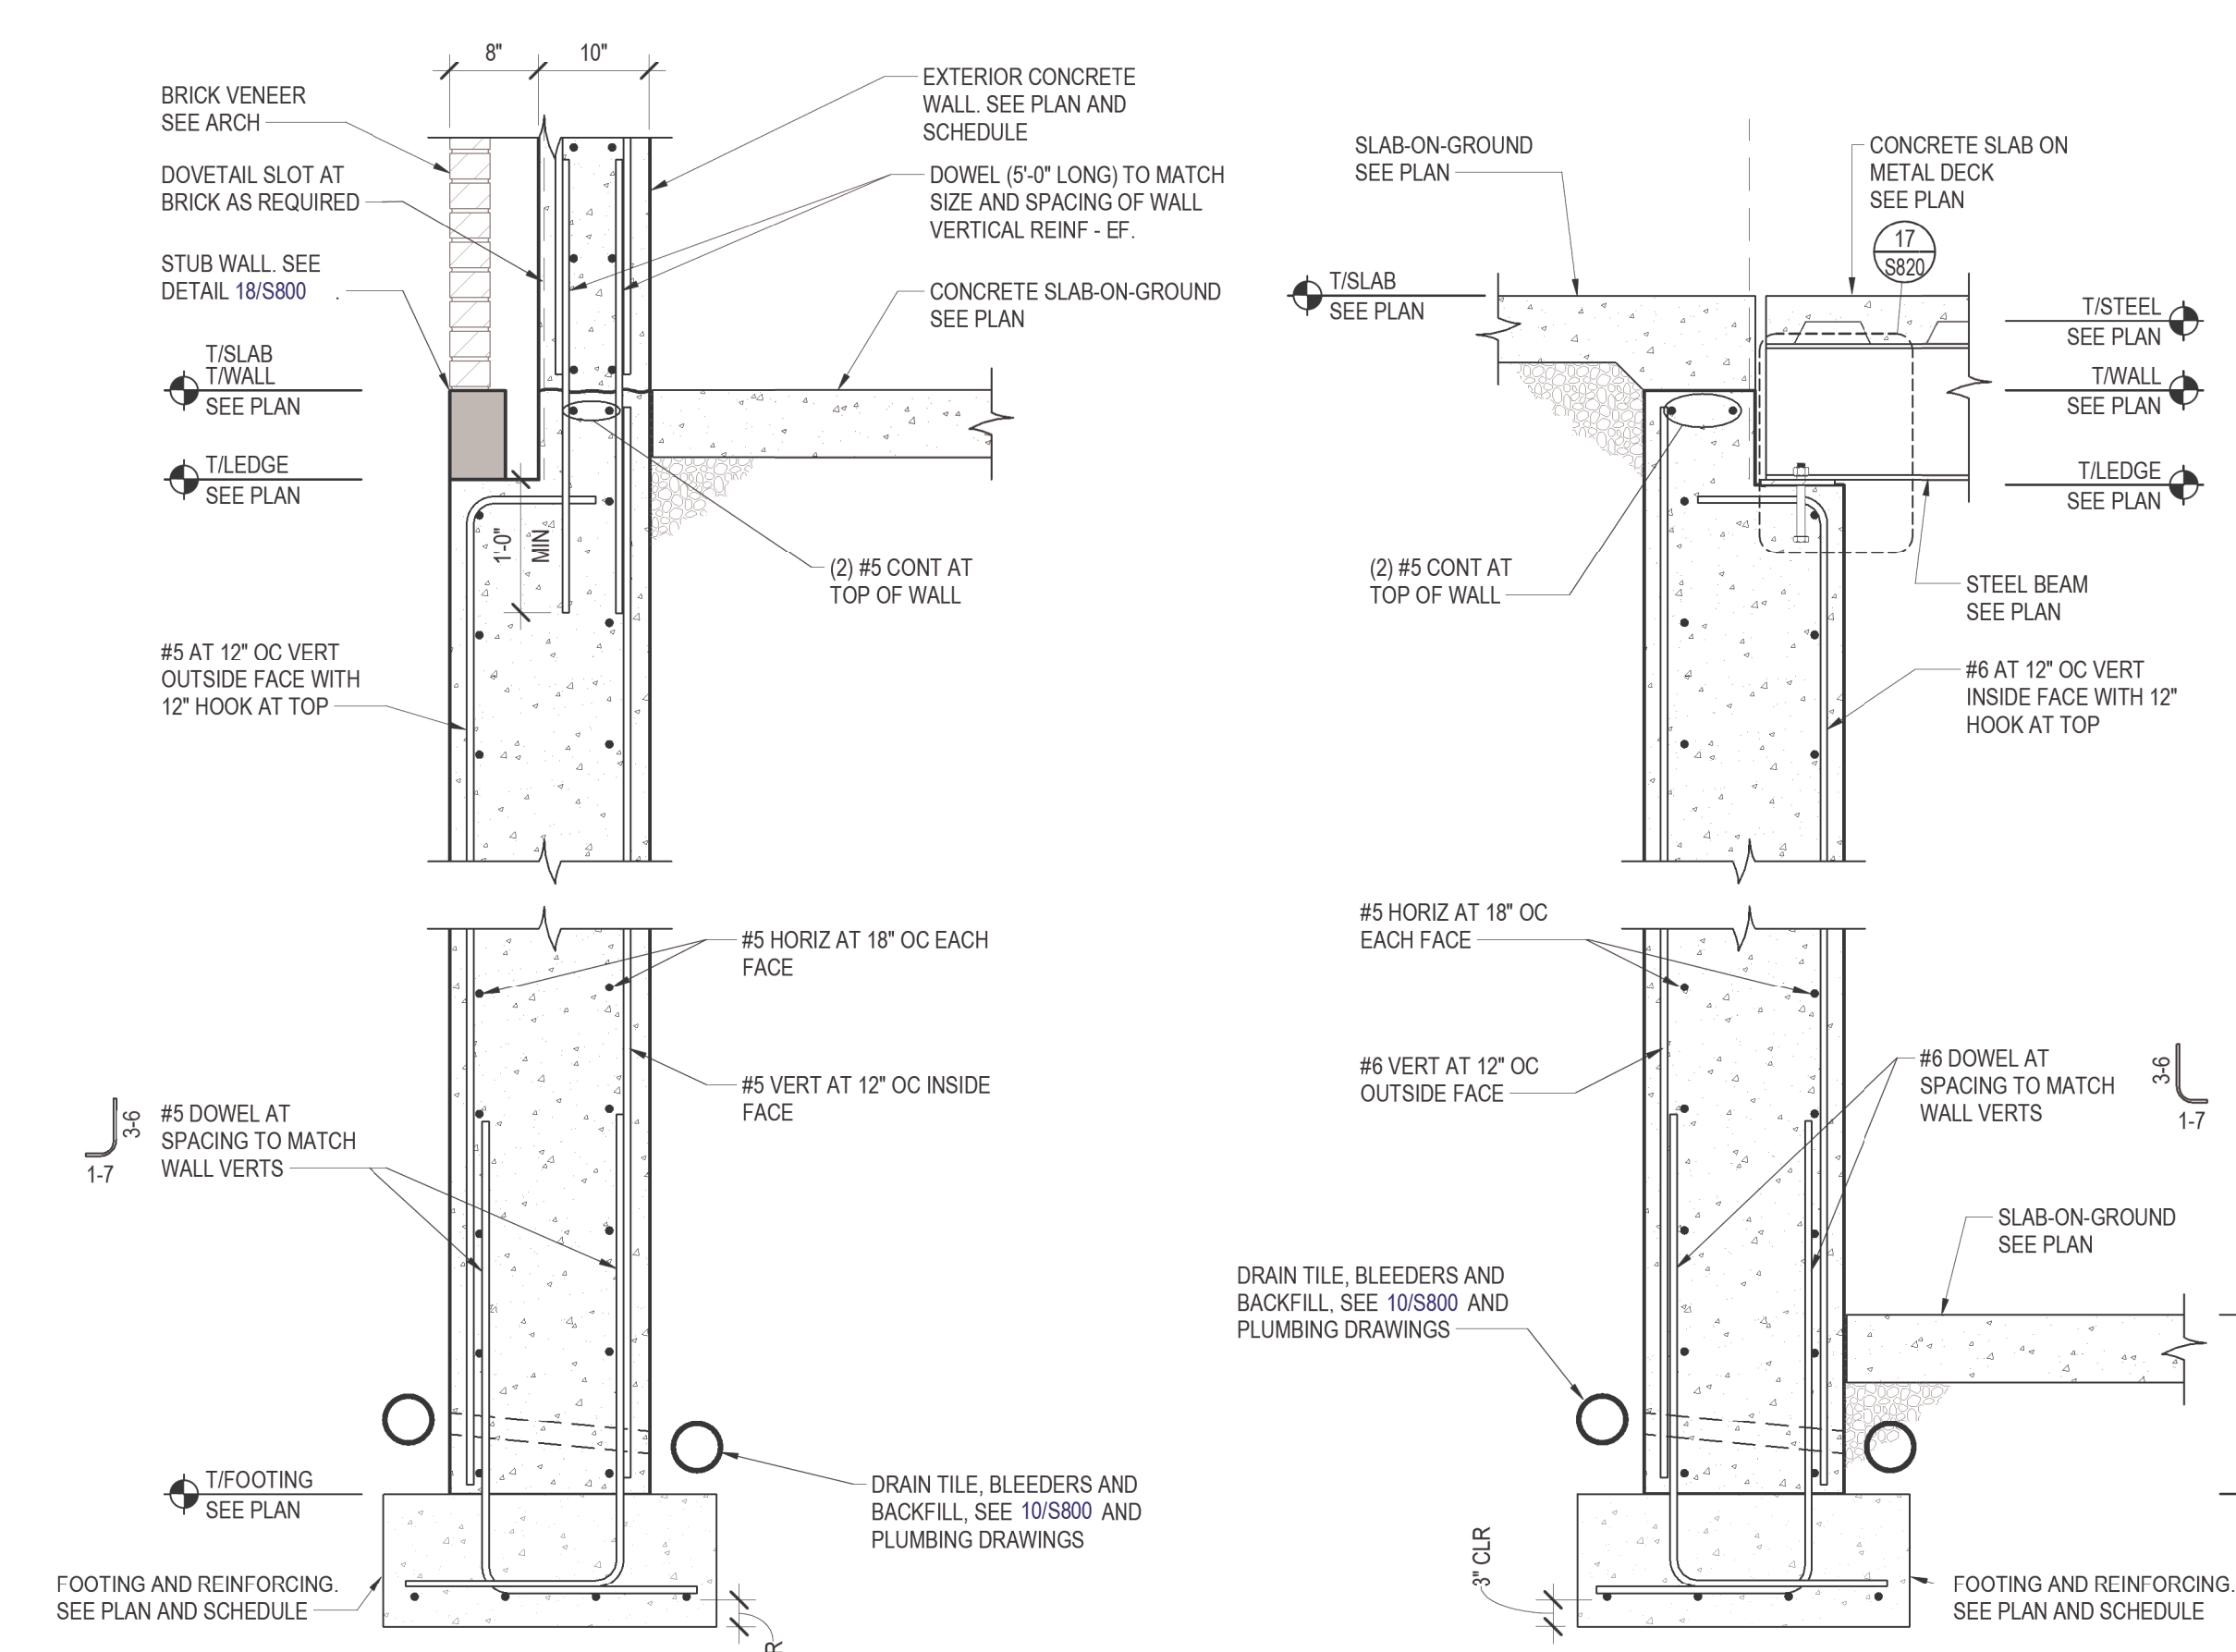
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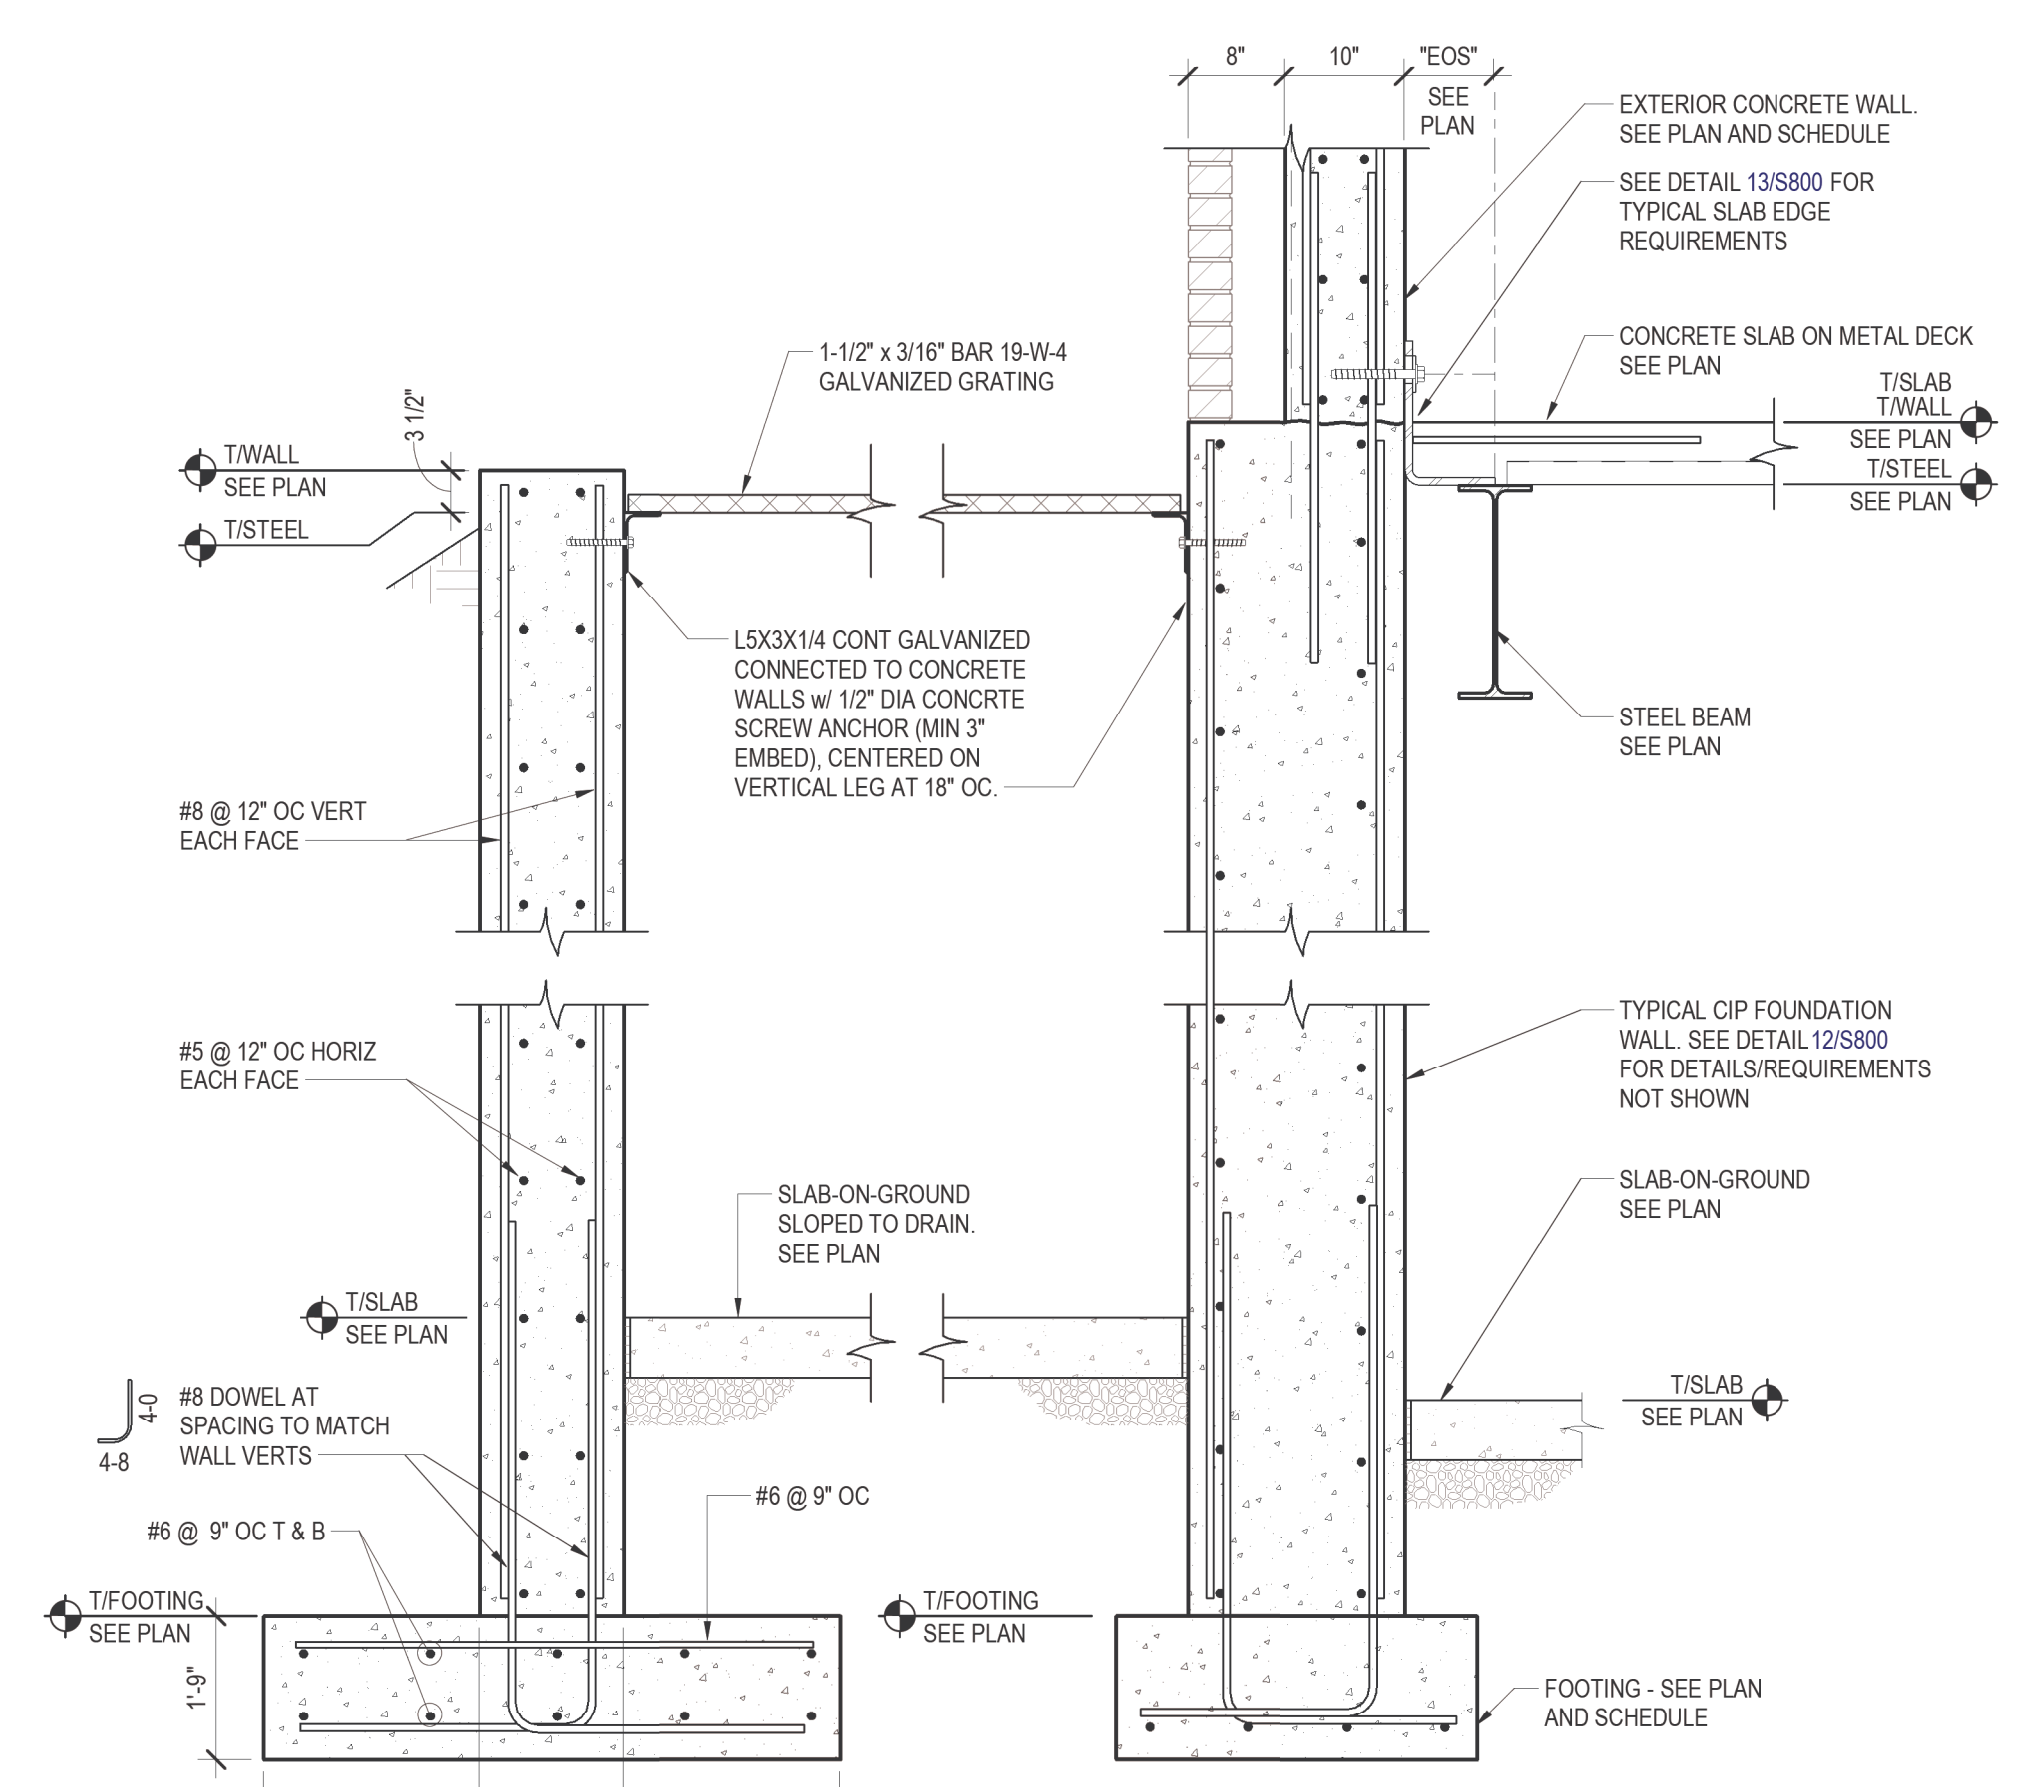
1 NEW GRADE BEAM FOUNDATION
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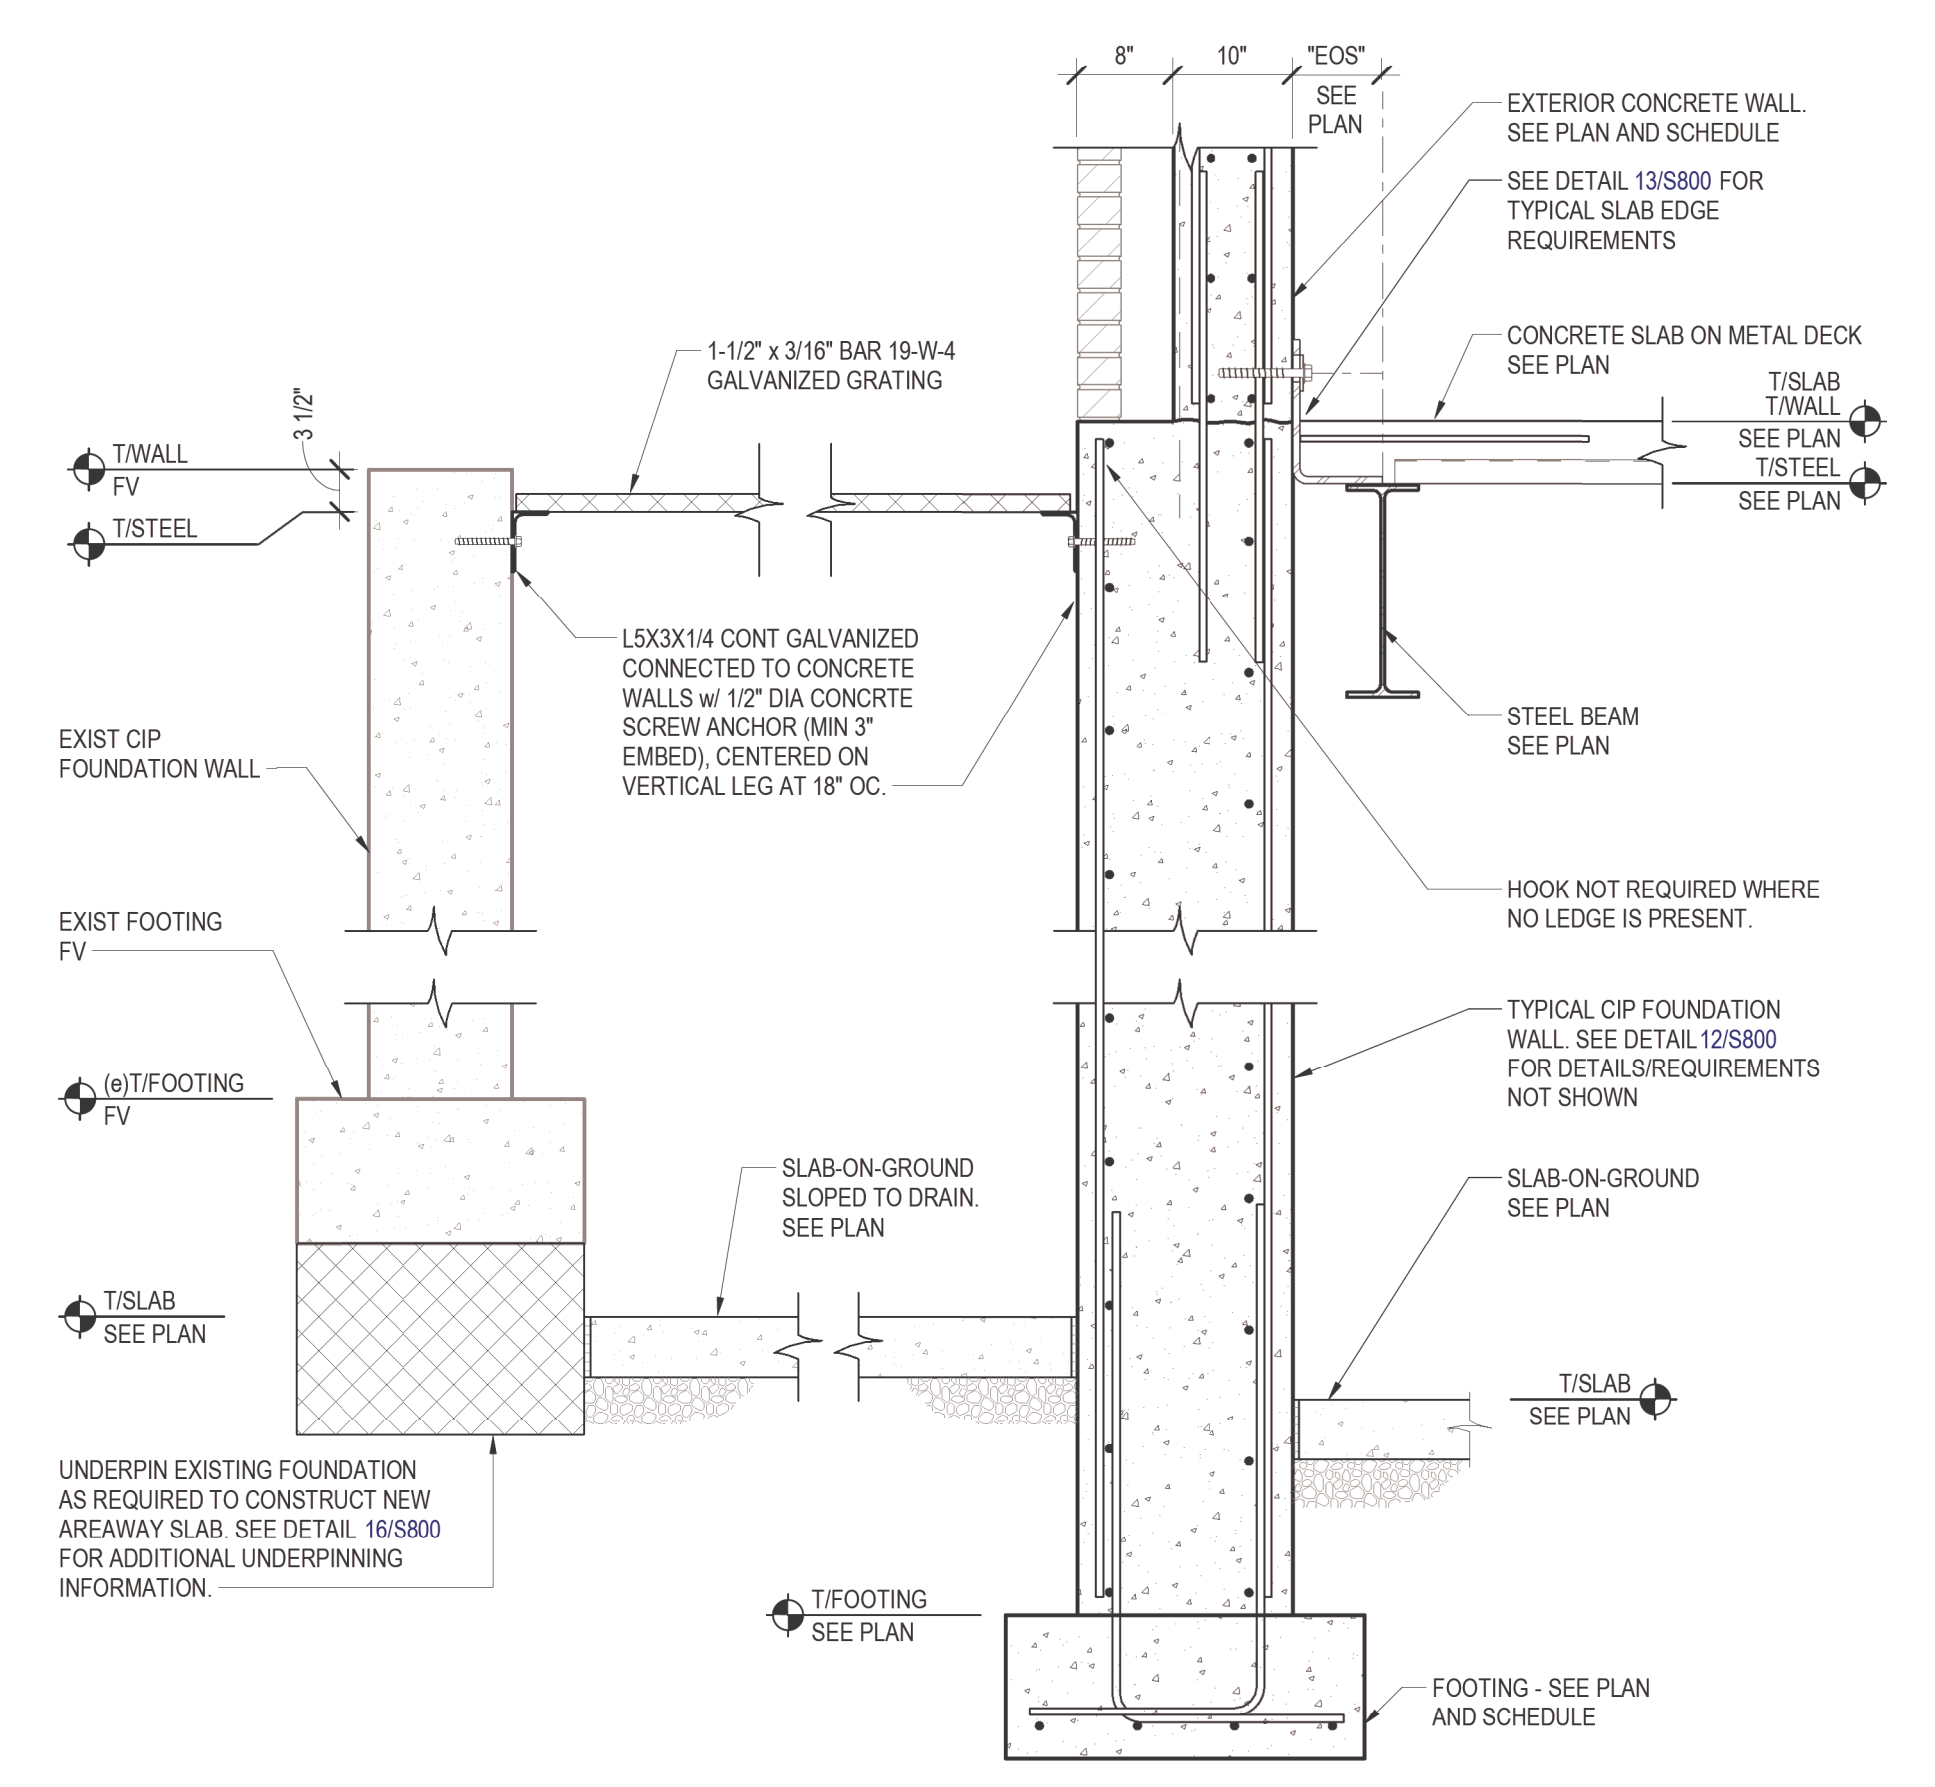
2 MAT SLAB AT EXIST FOUNDATION WALL
SCALE: 3/4" = 1'-0"




3 TYPICAL BASEMENT WALL SECTION
SCALE: 3/4" = 1'-0"




5 TYPICAL WALL SECTION AT AREAWAY
SCALE: 3/4" = 1'-0"



6 TYPICAL WALL SECTION AT AREAWAY AT EXISTING FOUNDATION
SCALE: 3/4" = 1'-0"

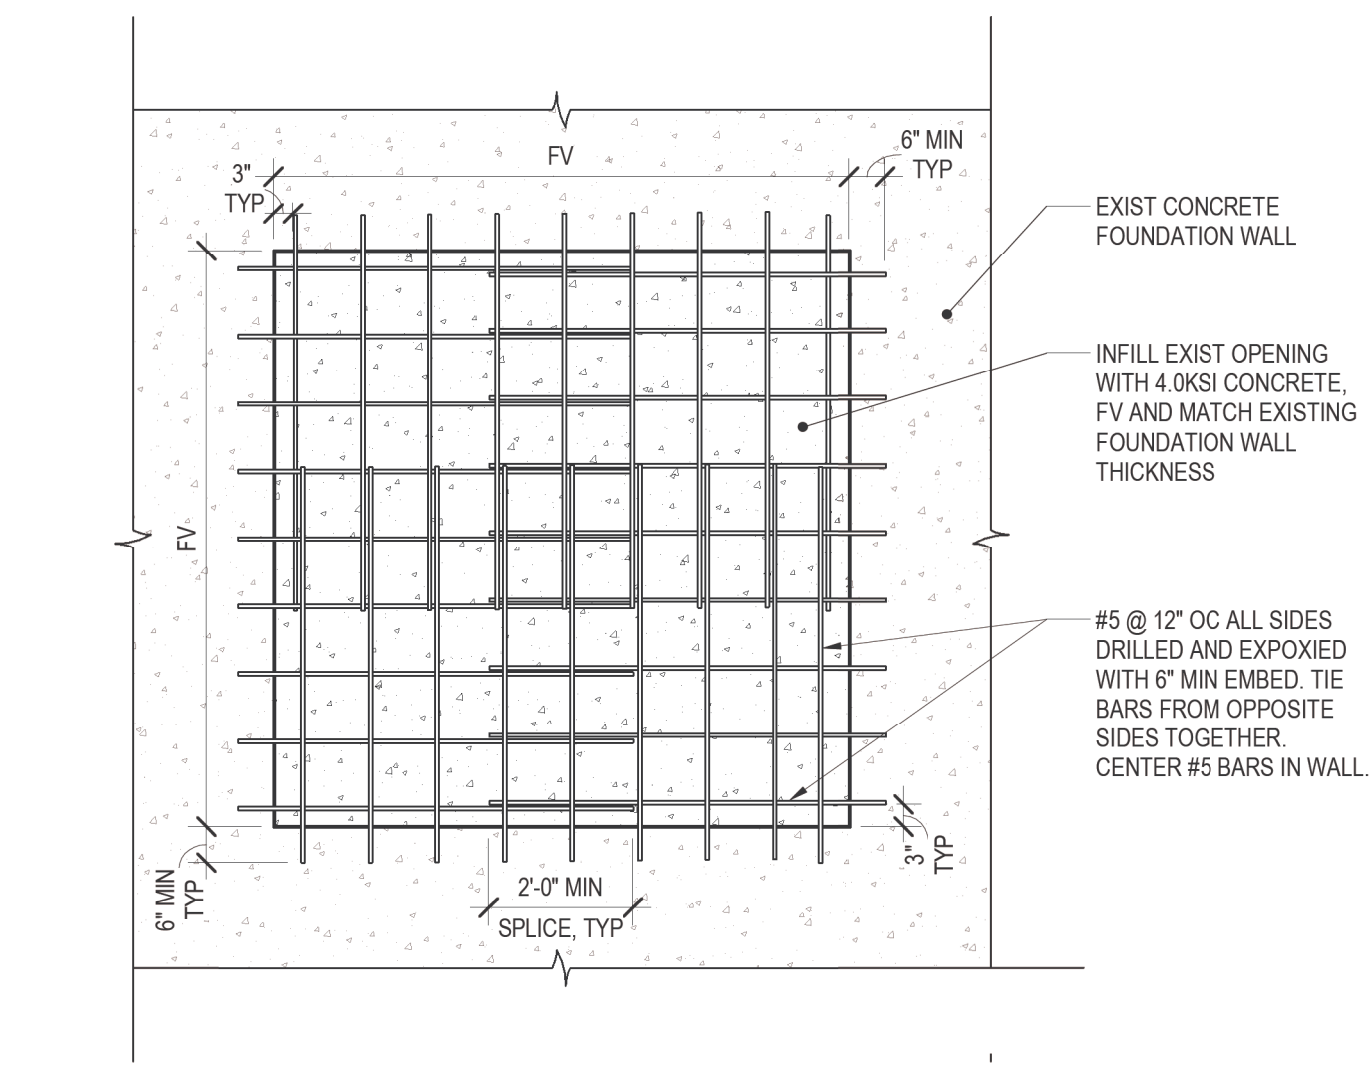

7 INFILL AT EXISTING FDN WALL
SCALE: 3/8" = 1'-0"

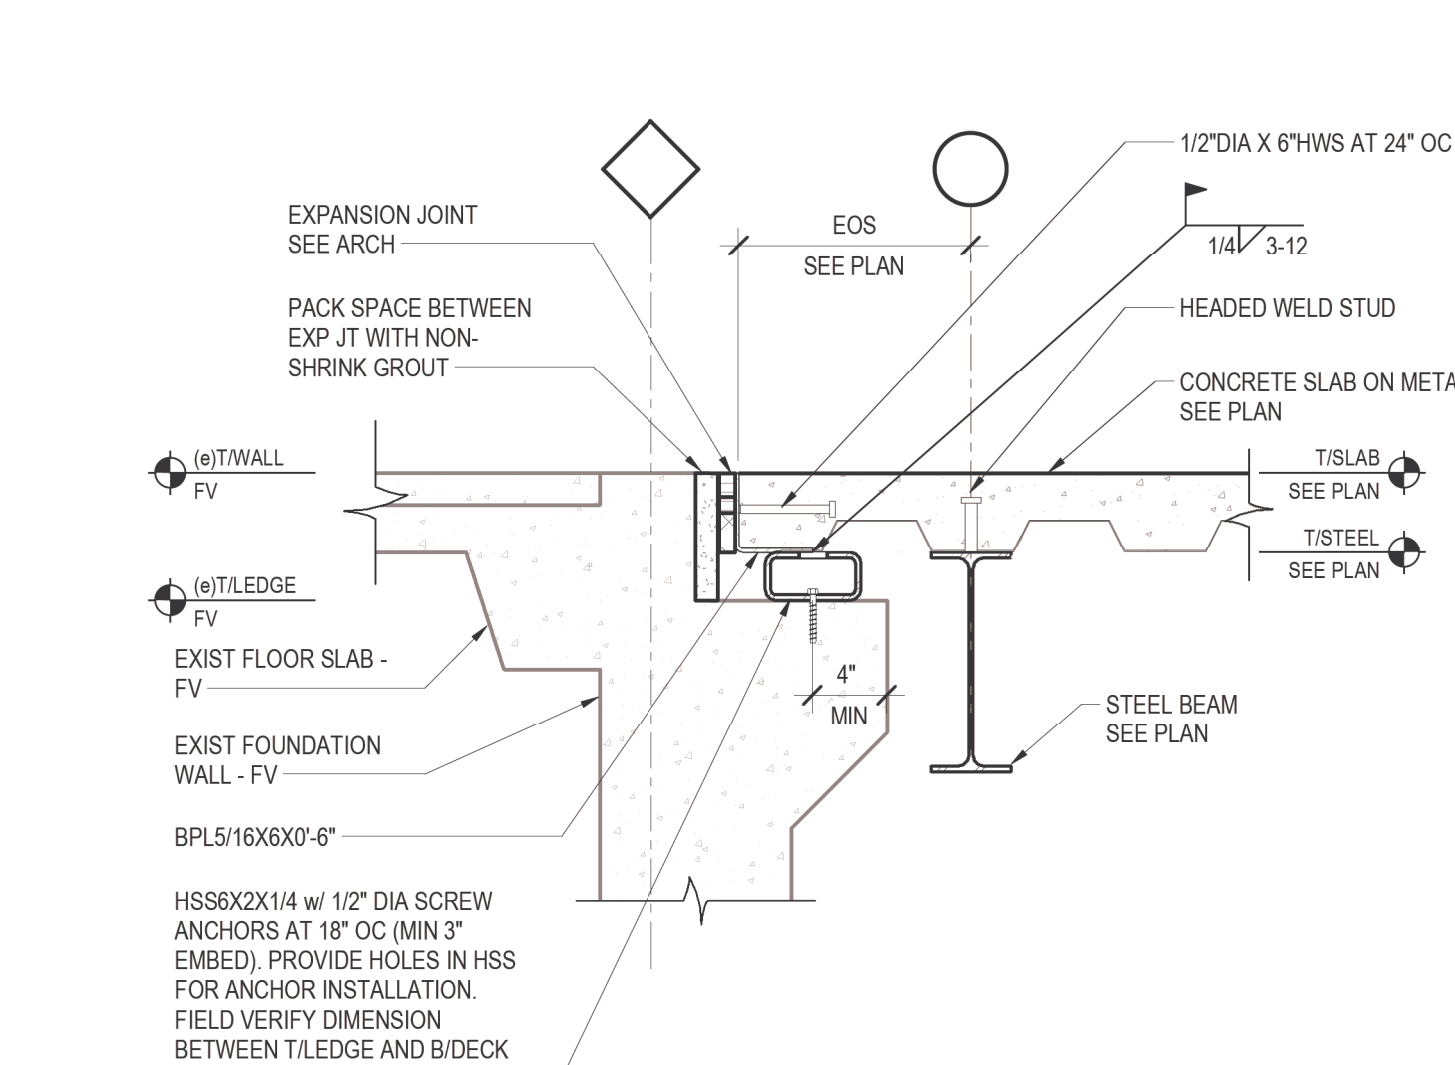

8 SLAB EDGE AT EXISTING FOUNDATION WALL HAUNCH
SCALE: 1" = 1'-0"

raSmith
CREATIVITY BEYOND ENGINEERING
16745 W. Bluemound Road
Brookfield, WI 53005-5938
(262) 781-1000
rasmith.com
raSmith Project Number: 1200712

CONSTRUCTION SET	05/08/2023
Revisions:	Date:

ARCHITECT/ENGINEER OF RECORD
bernerschaber
Comm. Number: 6163.03
310 Pine Street | Green Bay, WI 54301
920-432-4865 | www.bernerschaber.com
ARCHITECT/ENGINEER

Office of
Construction
and Facilities
Management
VA U.S. Department
of Veterans Affairs

Drawing Title
FOUNDATION DETAILS
Approved:

Phase
CONSTRUCTION SET
FULLY SPRINKLERED

Project Title
EXPAND PHARMACY AND RADIOLOGY
OSCAR G. JOHNSON VA MEDICAL CENTER
Location
325 H STREET,
IRON MOUNTAIN, MI 49801
Issue Date
MAY 8, 2023
Checked
NLD
Drawn
rpm

Project Number
585-337
Building Number
1
Drawing Number
S801
DWG. 53 OF 126

