







three inches = one foot  
one and one half inches = one foot  
one inch = one foot  
three quarters inch = one foot  
three eighths inch = one foot  
one quarter inch = one foot  
one eighth inch = one foot  
one eighth inch = one foot

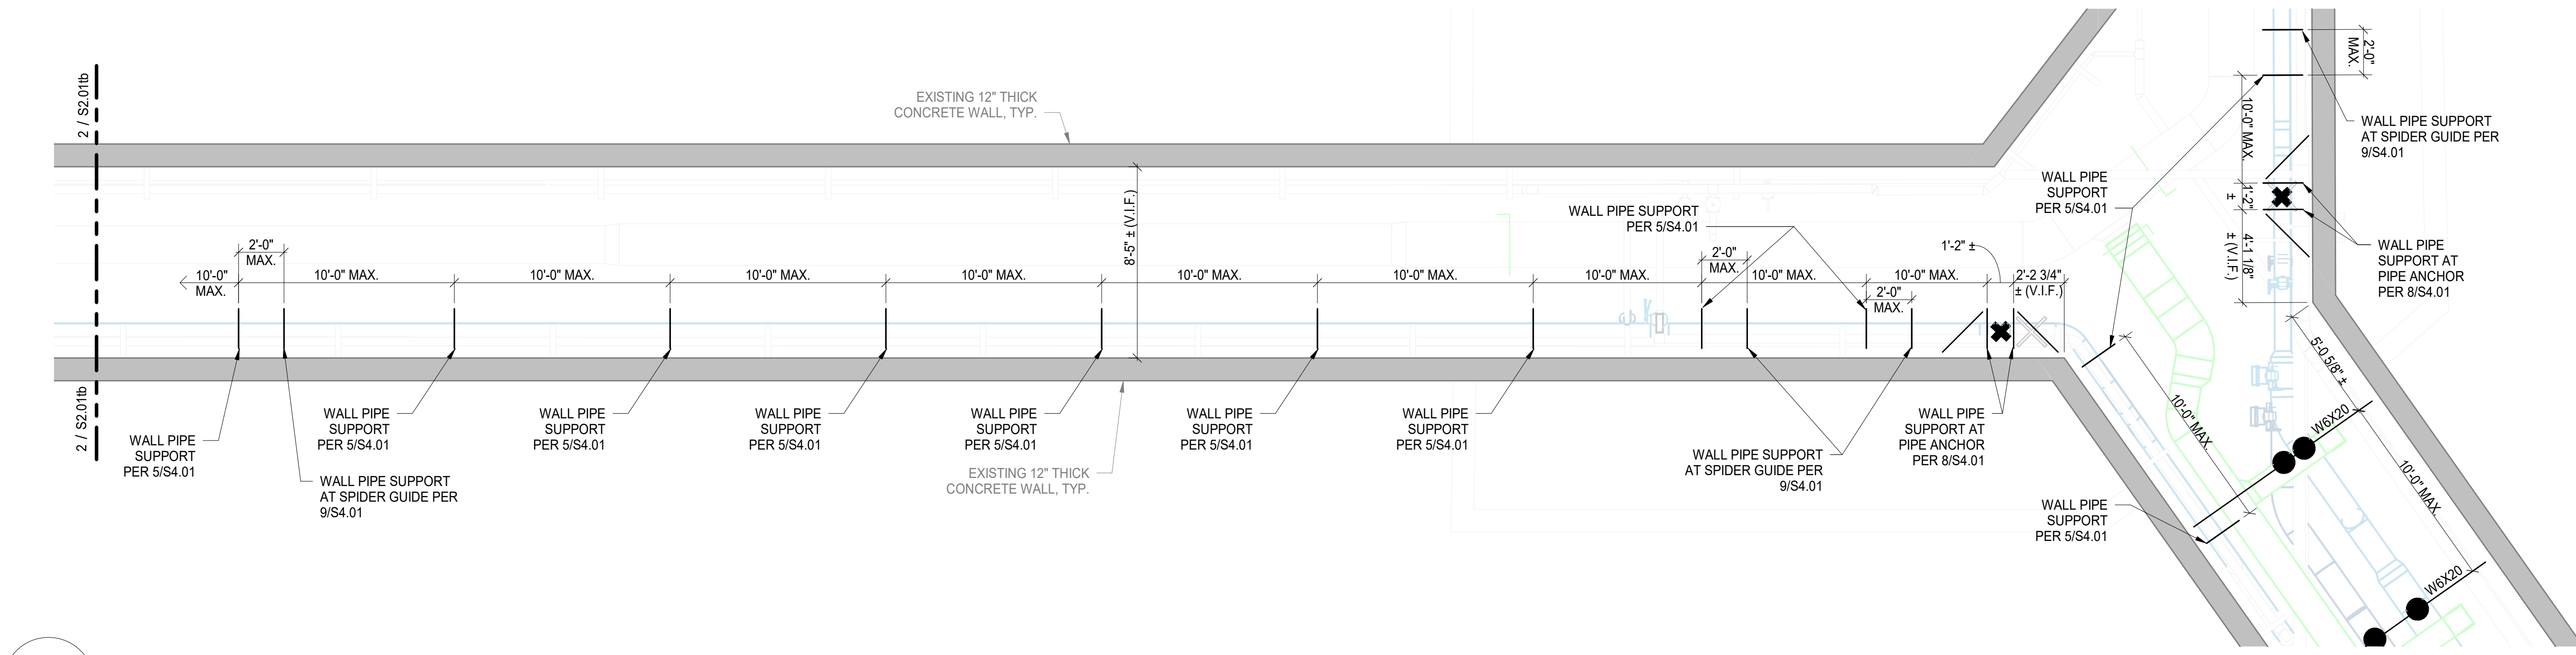

1 BASEMENT INTERSTITIAL FRAMING PLAN - TUNNEL (AREA B1)  
SCALE: 1/4" = 1'-0"

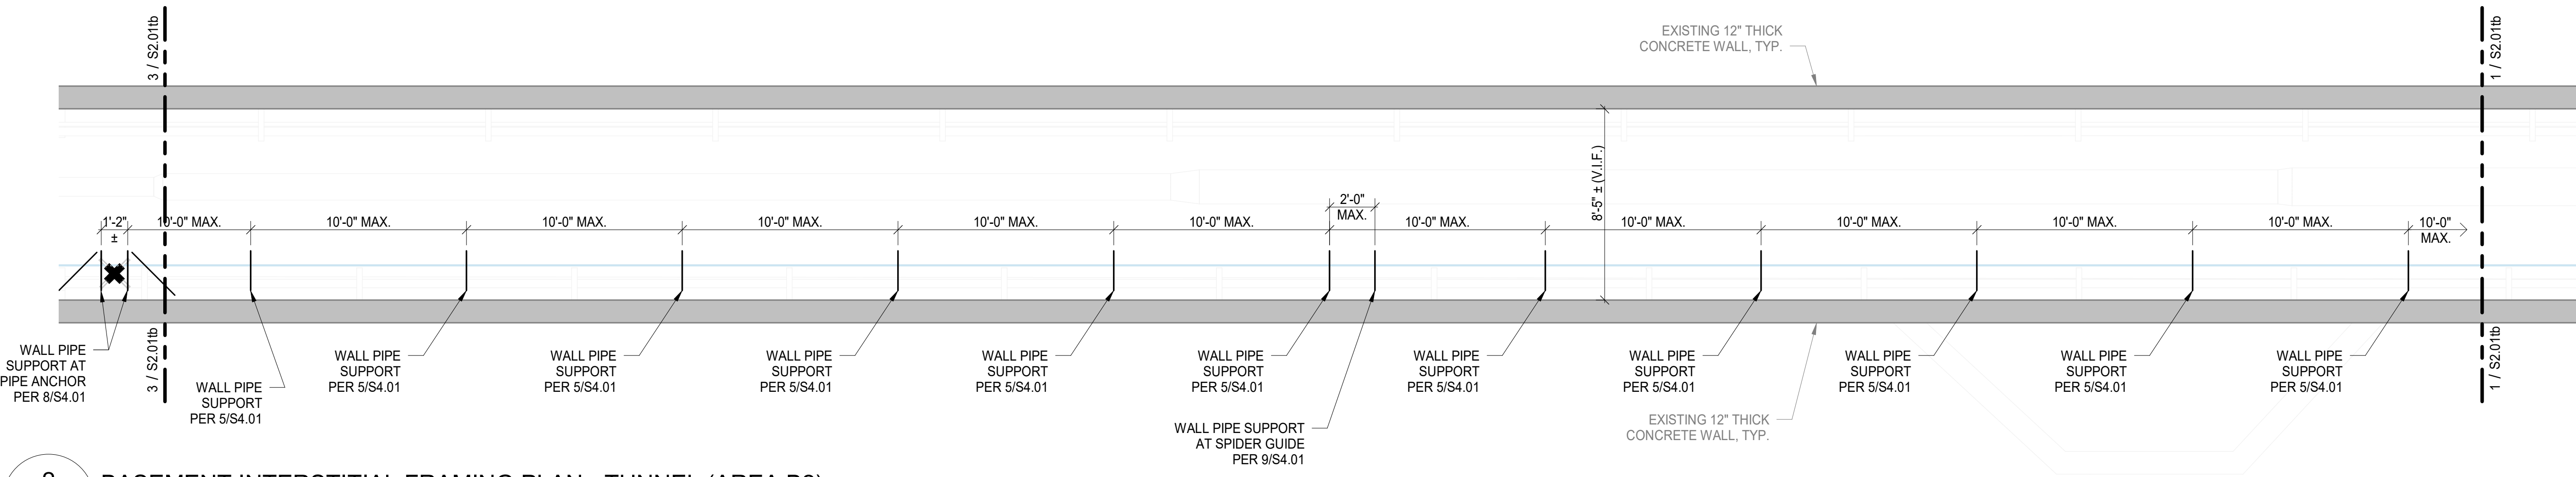


2 BASEMENT INTERSTITIAL FRAMING PLAN - TUNNEL (AREA B2)  
SCALE: 1/4" = 1'-0"




3 BASEMENT PLAN - TUNNEL - AREA b3  
SCALE: 1/4" = 1'-0"

- PLAN NOTES:
- INDICATES THREADED ROD / PIPE COLLAR PIPE SUPPORT SUSPENDED FROM FRAMING ABOVE. SEE MECHANICAL FOR THREADED ROD / PIPE COLLAR SIZE.
  - ✕ INDICATES PIPE ANCHOR SUPPORT. SEE MECHANICAL FOR LARGE PIPE ANCHOR SIZE.

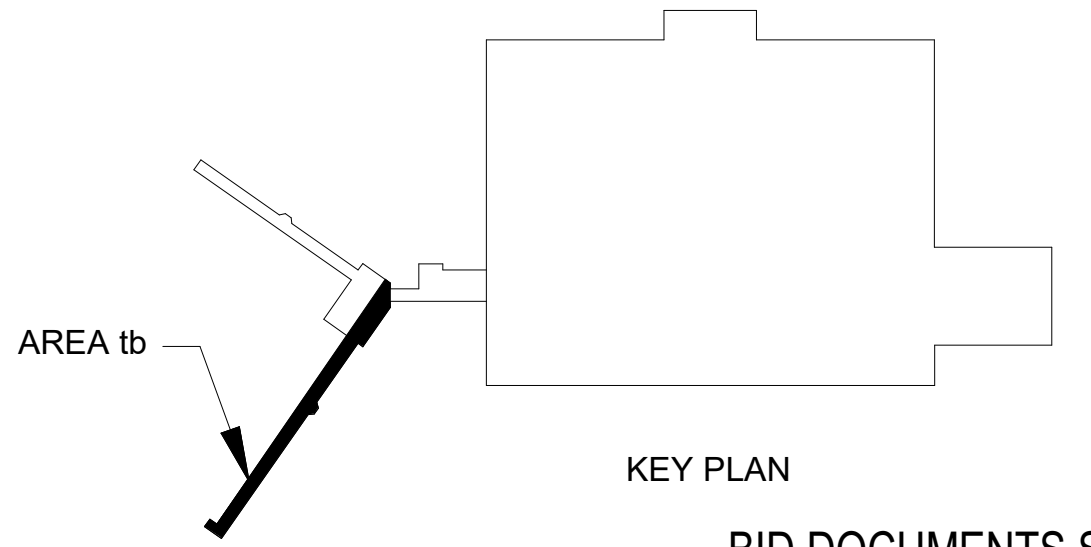


																																																																																																																																																																																																																																																																																																																																																																																																																																																																																																																																																																																																																																																																																																																																																																																																																																																																																																																																																																																																																																																																																																																																																																																																																																																																																				</	
--	--	----	--


three inches = one foot  
one and one half inches = one foot  
one inch = one foot  
three quarters inch = one foot  
one half inch = one foot  
three eighths inch = one foot  
one quarter inch = one foot  
one eighth inch = one foot

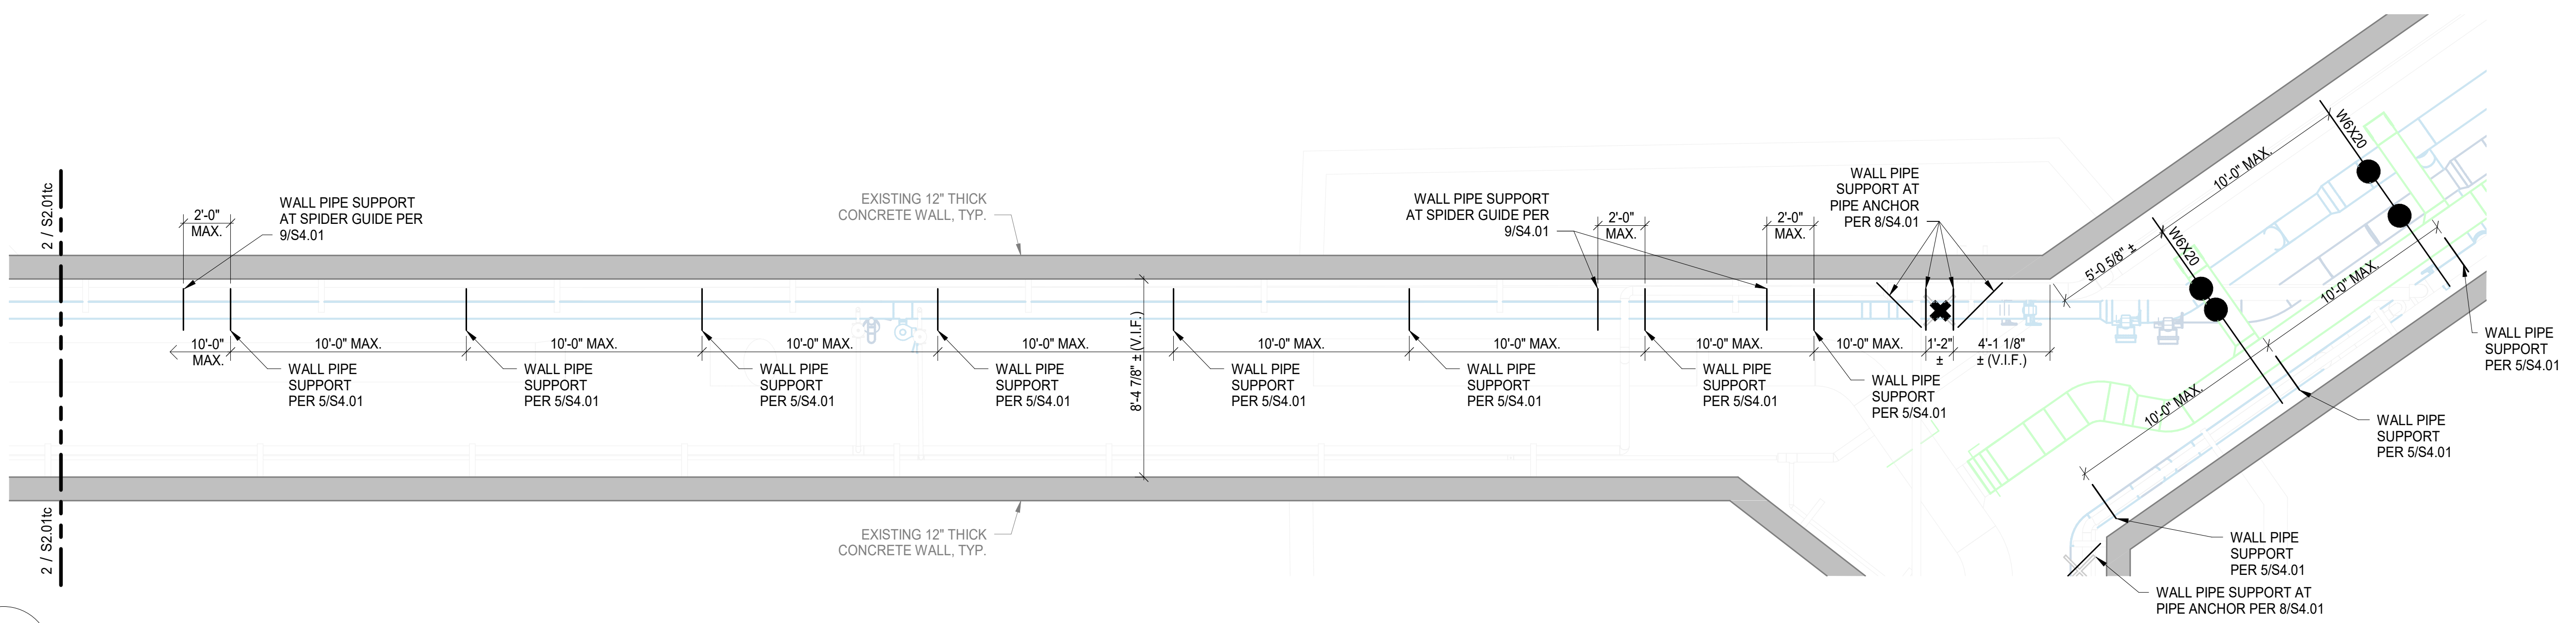

1 BASEMENT INTERSTITIAL FRAMING PLAN - TUNNEL (AREA C1)  
S2.01tc SCALE: 1/4" = 1'-0"

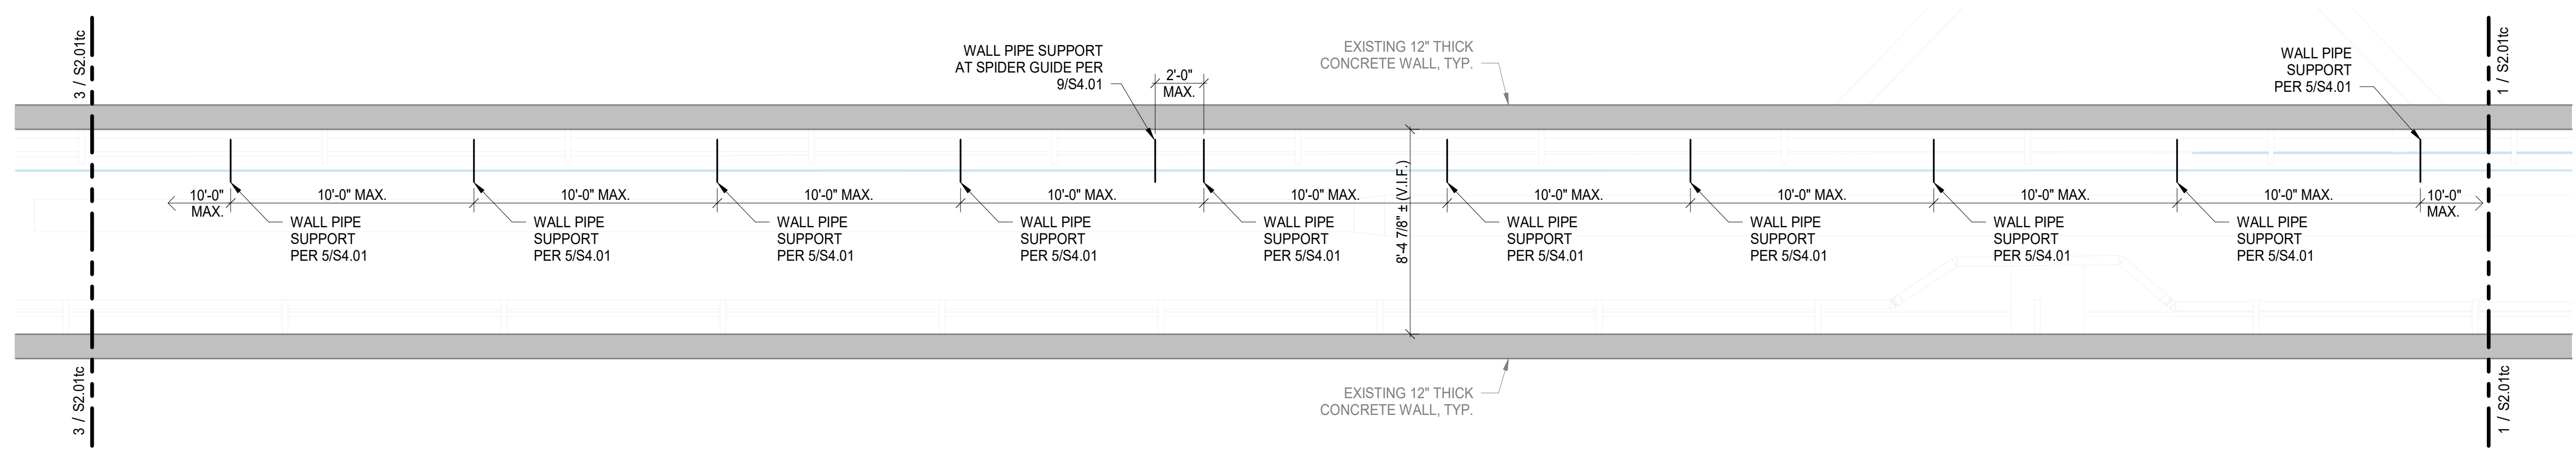


2 BASEMENT INTERSTITIAL FRAMING PLAN - TUNNEL (AREA C2)  
S2.01tc SCALE: 1/4" = 1'-0"

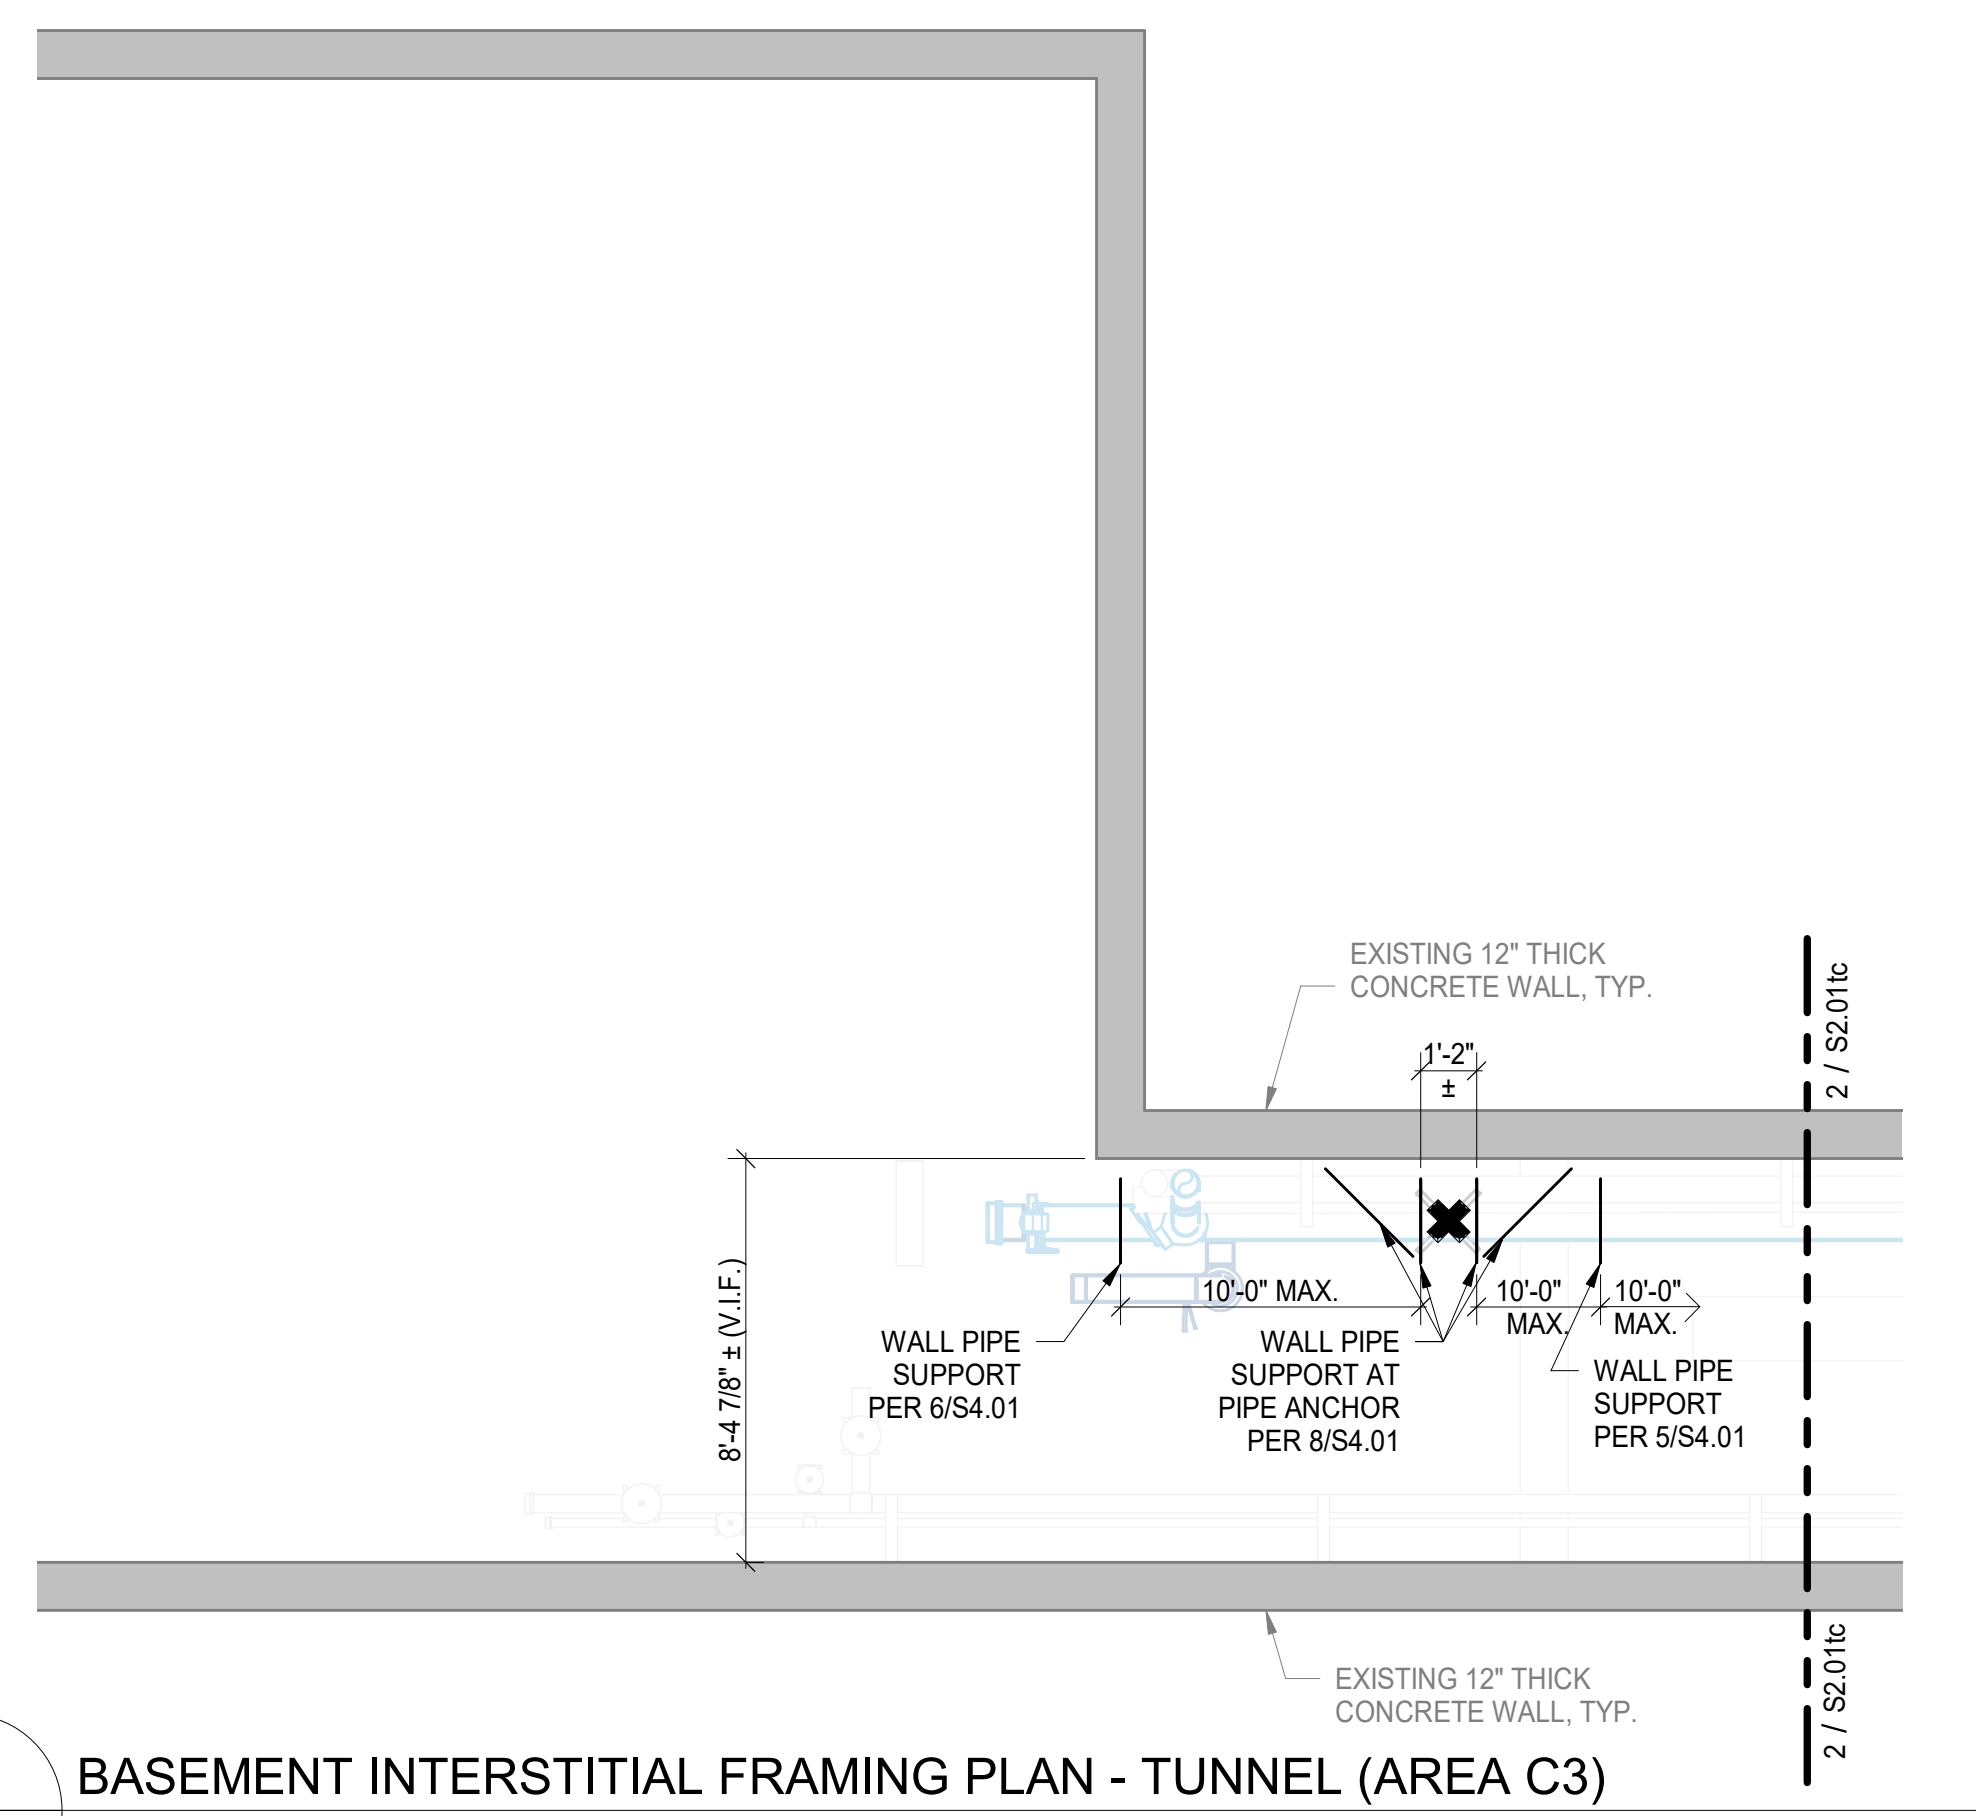


3 BASEMENT INTERSTITIAL FRAMING PLAN - TUNNEL (AREA C3)  
S2.01tc SCALE: 1/4" = 1'-0"

- PLAN NOTES:
- INDICATES THREADED ROD / PIPE COLLAR PIPE SUPPORT SUSPENDED FROM FRAMING ABOVE. SEE MECHANICAL FOR THREADED ROD / PIPE COLLAR SIZE.
  - ✱ INDICATES PIPE ANCHOR SUPPORT. SEE MECHANICAL FOR LARGE PIPE ANCHOR SIZE.

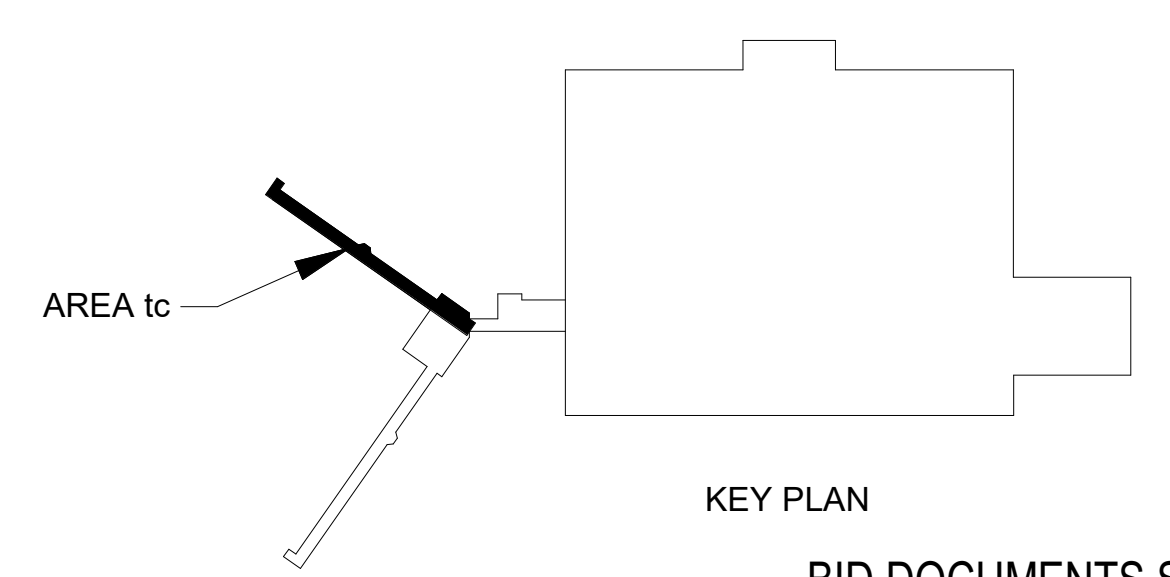


CONSULTANTS:		SEAL:	ARCHITECT/ENGINEERS:	Scale: AS NOTED	Drawing Title BASEMENT INTERSTITIAL FRAMING PLAN-TUNNEL - AREA c	Project Title CHILLED WATER LINE REPLACEMENT BLDG 500		Project Number 613-16-302		Office of Construction and Facilities Management  Department of Veterans Affairs
					Approved: Project Director	Location VAMC - Martinsburg, WV		Building Number 500		
Revisions:						Date 04/22/2022		Checked CJ		
Date						Drawn BB		Drawing Number S2.01tc		
								Dwg. 6 of 67		

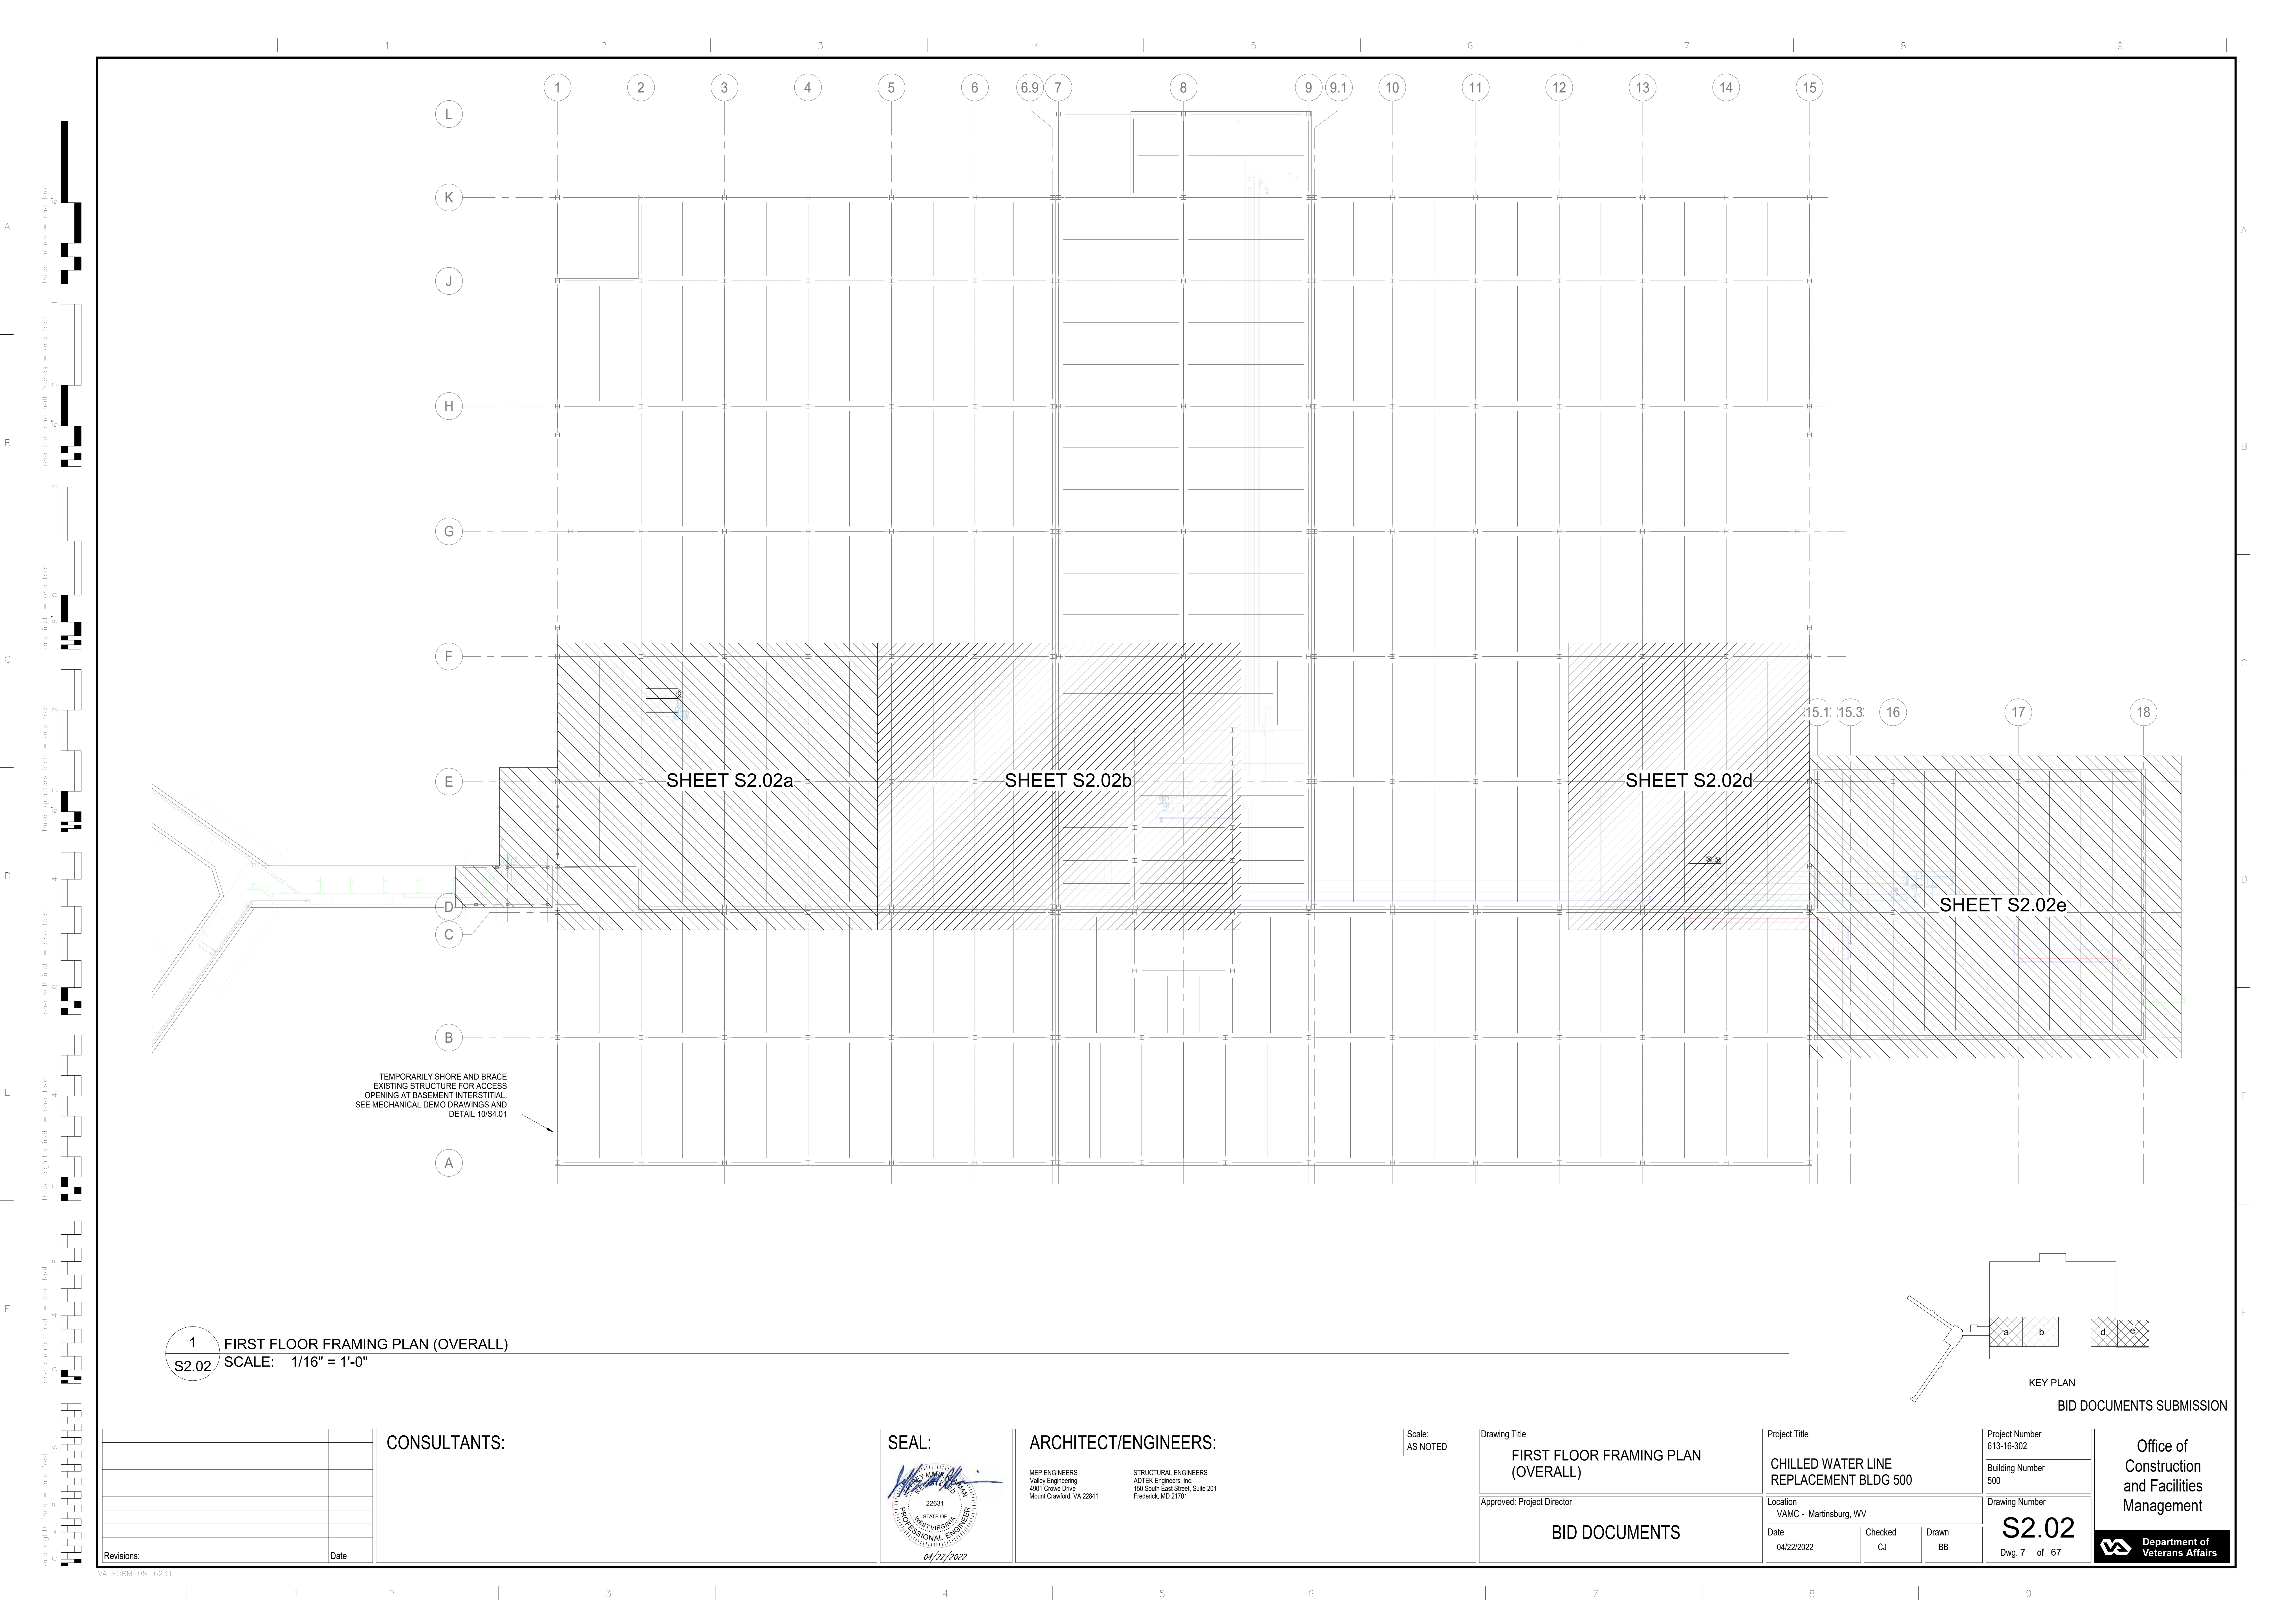


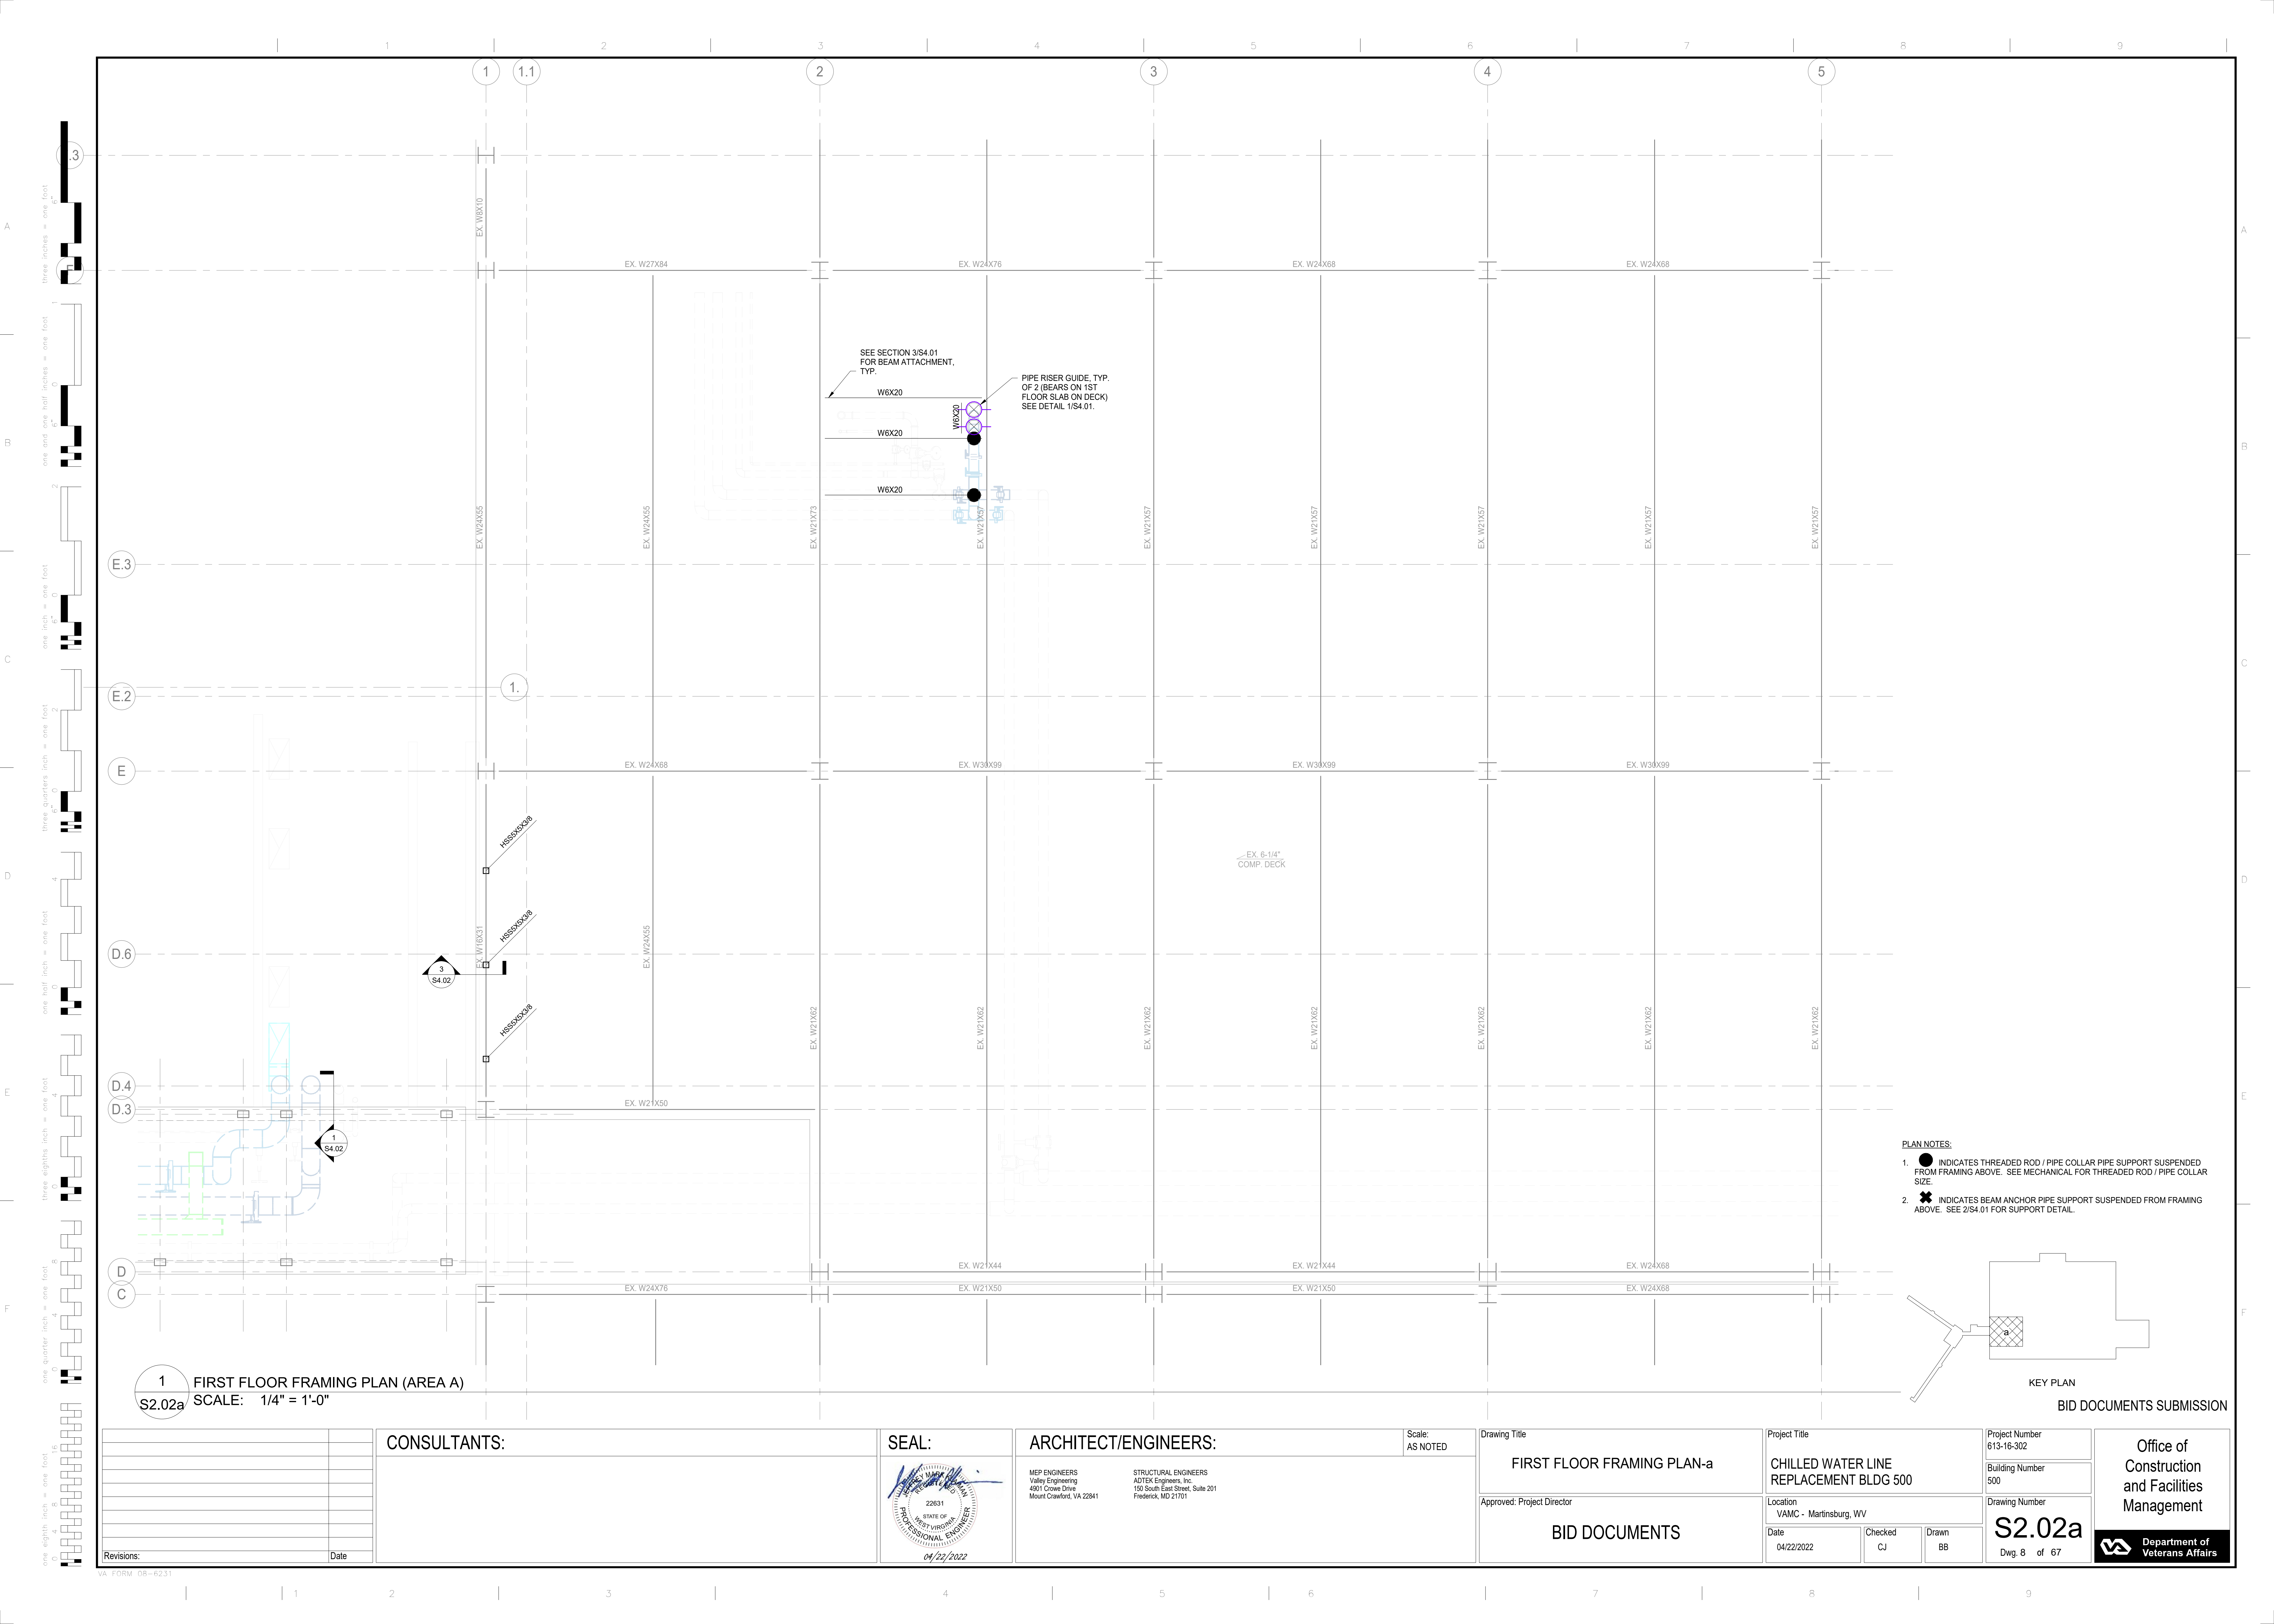


1 FIRST FLOOR FRAMING PLAN (OVERALL)  
S2.02 SCALE: 1/16" = 1'-0"

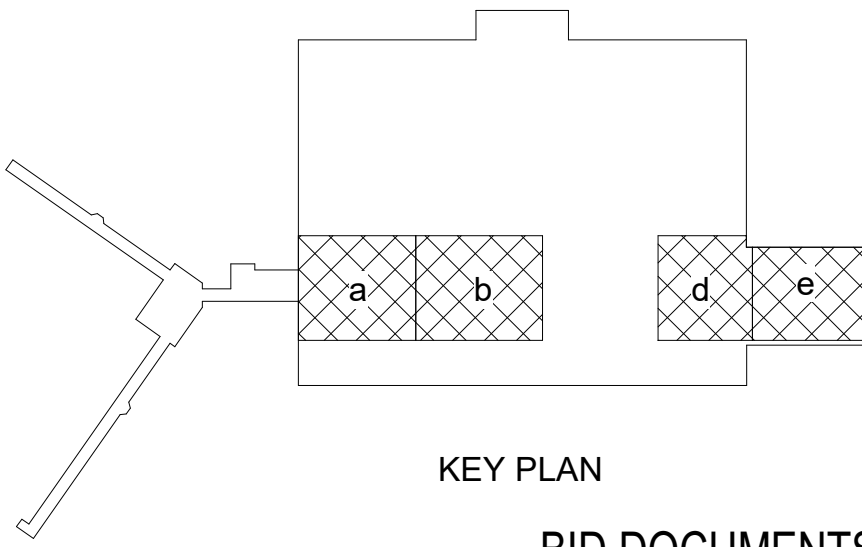

KEY PLAN  
BID DOCUMENTS SUBMISSION

CONSULTANTS:		SEAL:	ARCHITECT/ENGINEERS:		Scale: AS NOTED	Drawing Title FIRST FLOOR FRAMING PLAN (OVERALL)	Project Title CHILLED WATER LINE REPLACEMENT BLDG 500		Project Number 613-16-302	Office of Construction and Facilities Management 
						Approved: Project Director	Location VAMC - Martinsburg, WV		Building Number 500	
						BID DOCUMENTS	Date 04/22/2022	Checked CJ	Drawn BB	
Revisions:		Date							Drawing Number S2.02	
									Dwg. 7 of 67	













one eighth inch = one foot  
one quarter inch = one foot  
three eighths inch = one foot  
one half inch = one foot  
three quarters inch = one foot  
one inch = one foot  
one and one half inches = one foot  
two inches = one foot  
three inches = one foot

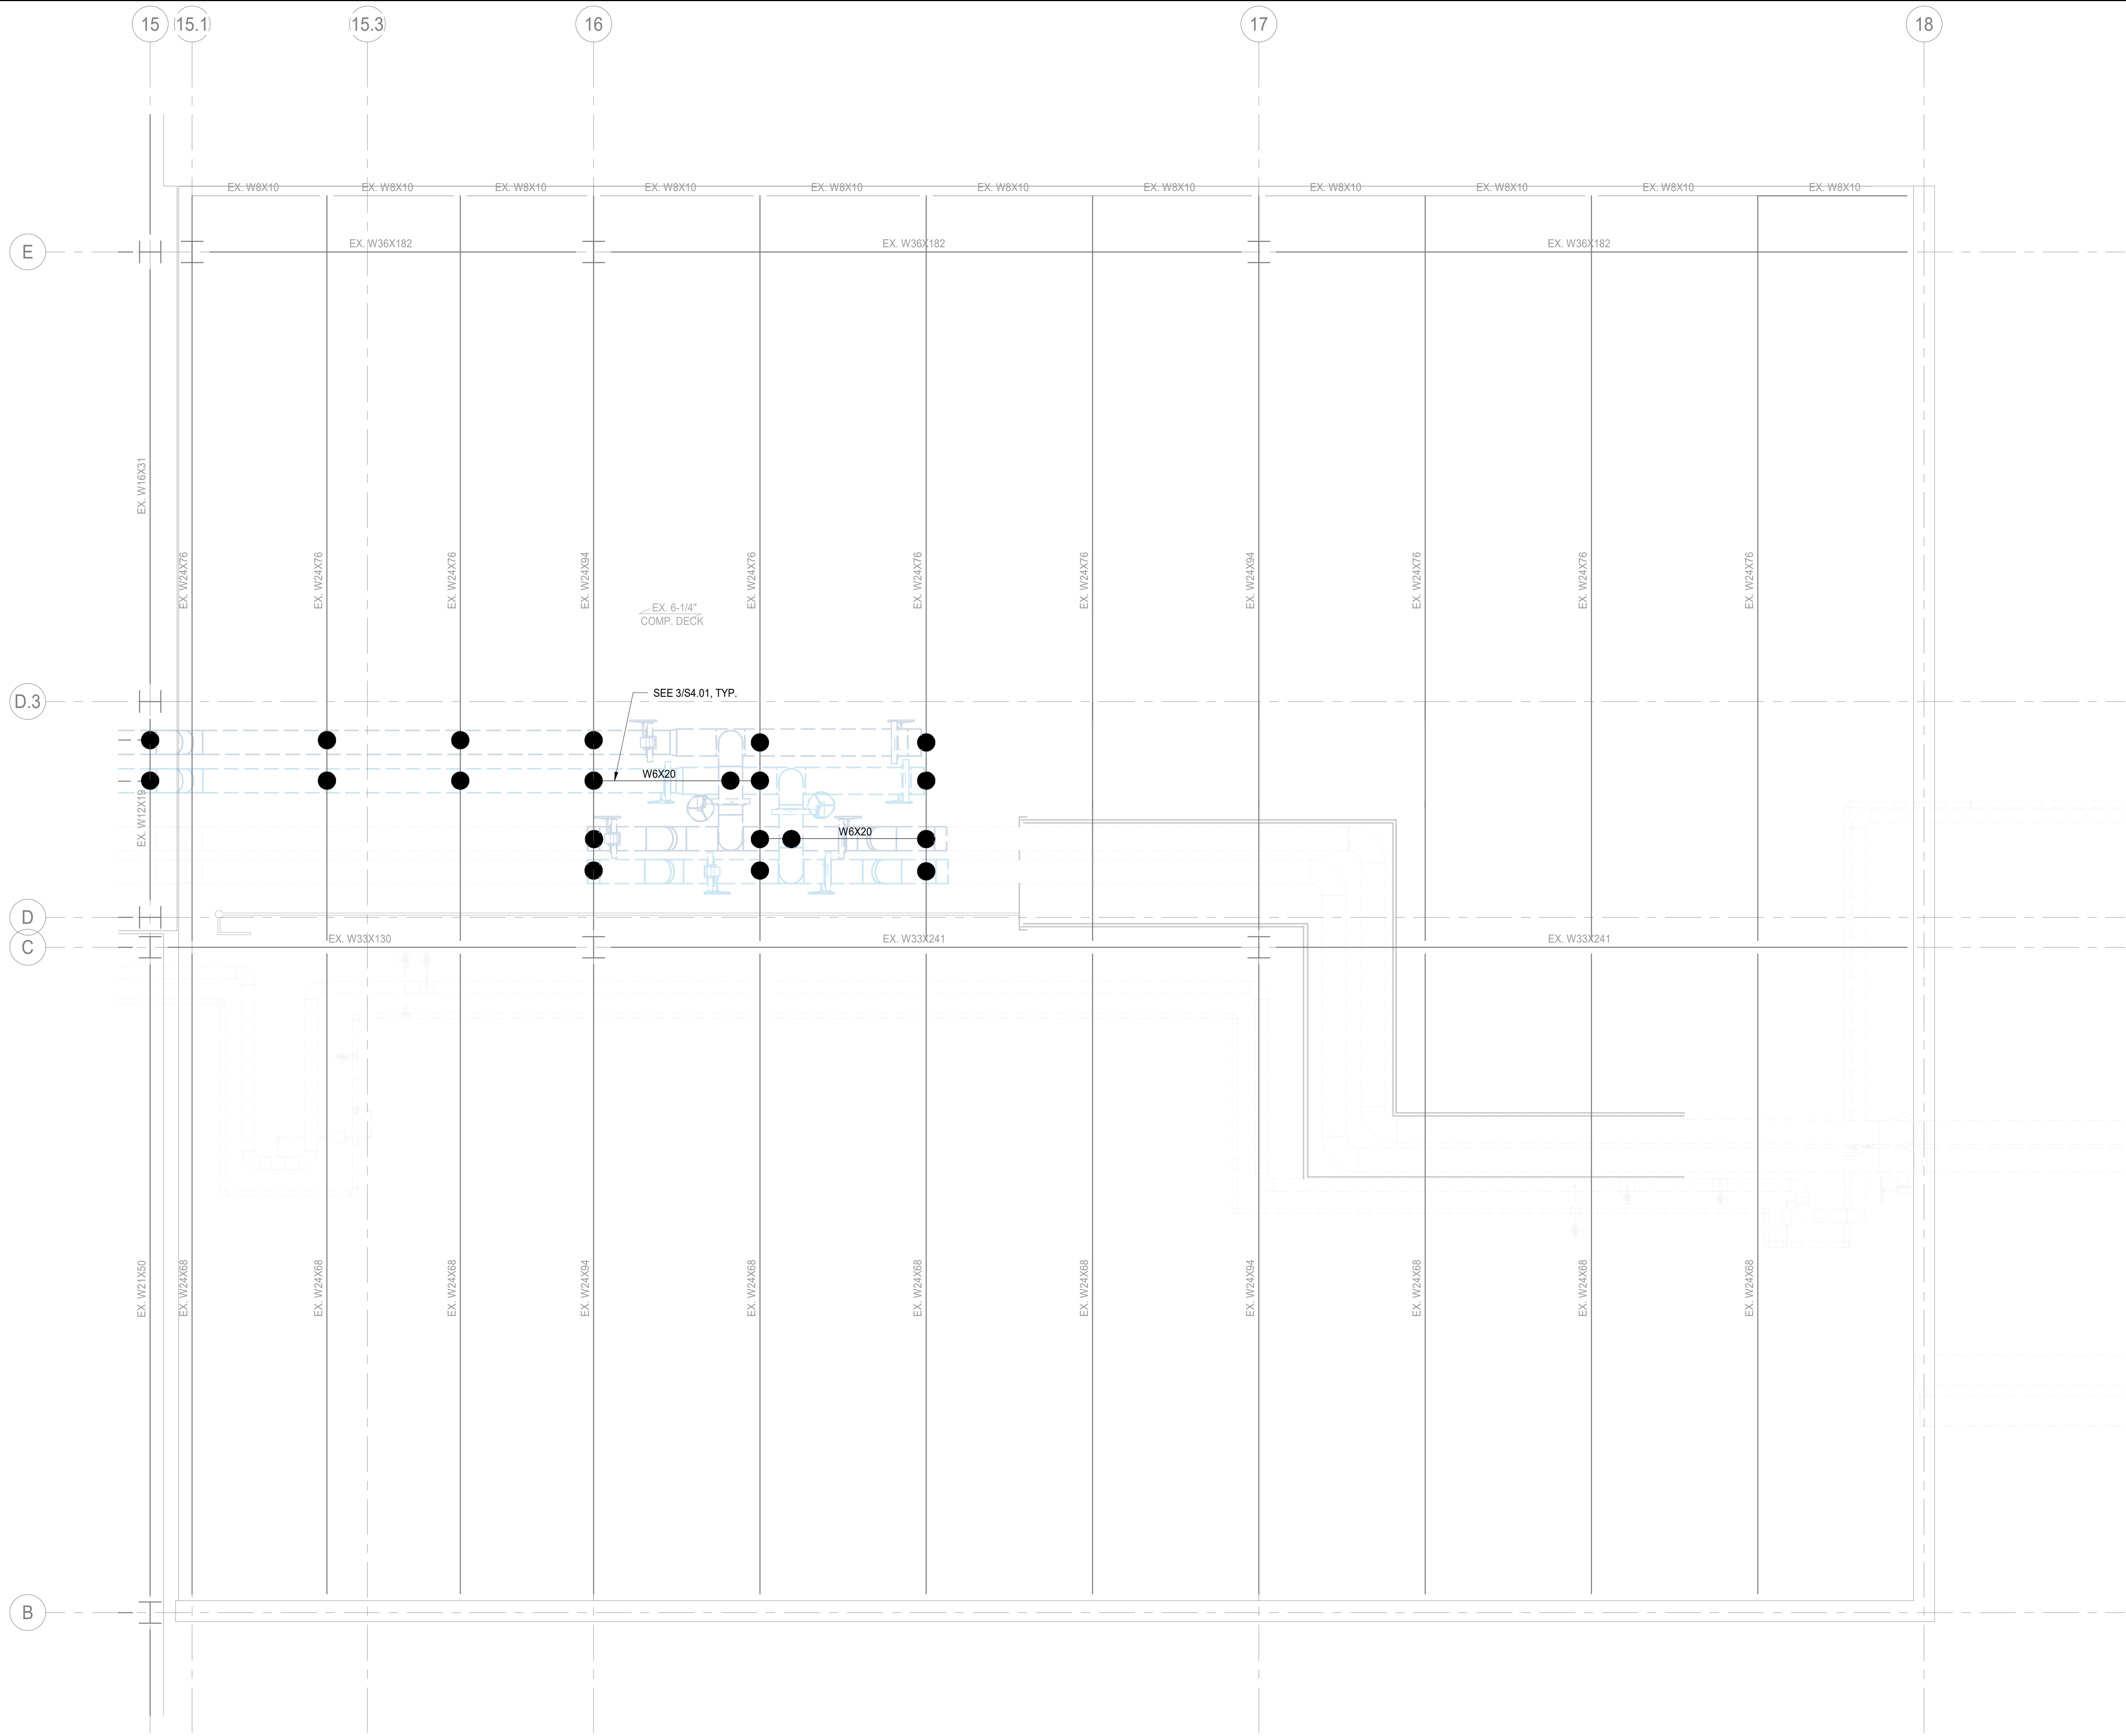


- PLAN NOTES:**
- INDICATES THREADED ROD / PIPE COLLAR PIPE SUPPORT SUSPENDED FROM FRAMING ABOVE. SEE MECHANICAL FOR THREADED ROD / PIPE COLLAR SIZE.
  - ✱ INDICATES BEAM ANCHOR PIPE SUPPORT SUSPENDED FROM FRAMING ABOVE. SEE 2/S4.01 FOR SUPPORT DETAIL.

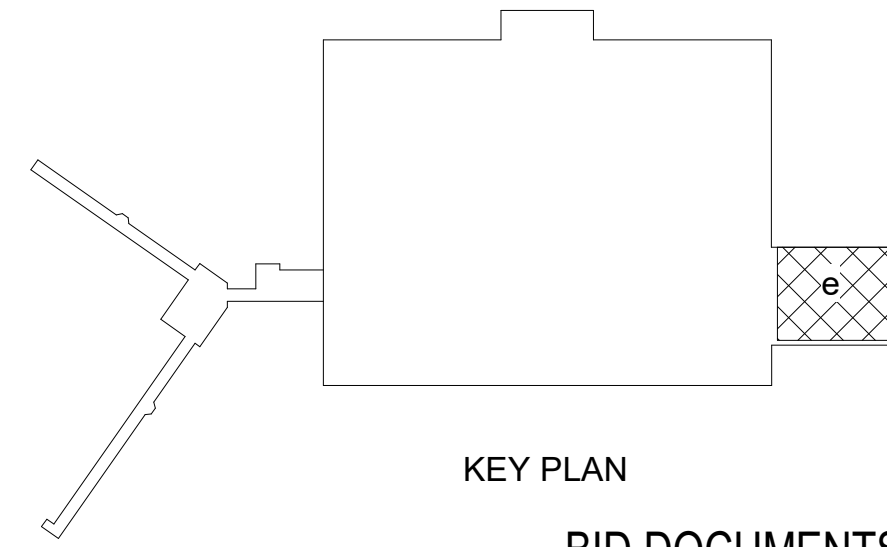


1 FIRST FLOOR FRAMING PLAN (AREA E)  
S2.02e SCALE: 1/4" = 1'-0"

Revisions:		Date:		CONSULTANTS:		SEAL:		ARCHITECT/ENGINEERS:		Scale: AS NOTED		Drawing Title FIRST FLOOR FRAMING PLAN-e		Project Title CHILLED WATER LINE REPLACEMENT BLDG 500		Project Number 613-16-302		Office of Construction and Facilities Management  Department of Veterans Affairs	
												Approved: Project Director		Location VAMC - Martinsburg, WV		Building Number 500			
												Date 04/22/2022		Checked CJ		Drawn BB			
														Dwg. 11 of 67					



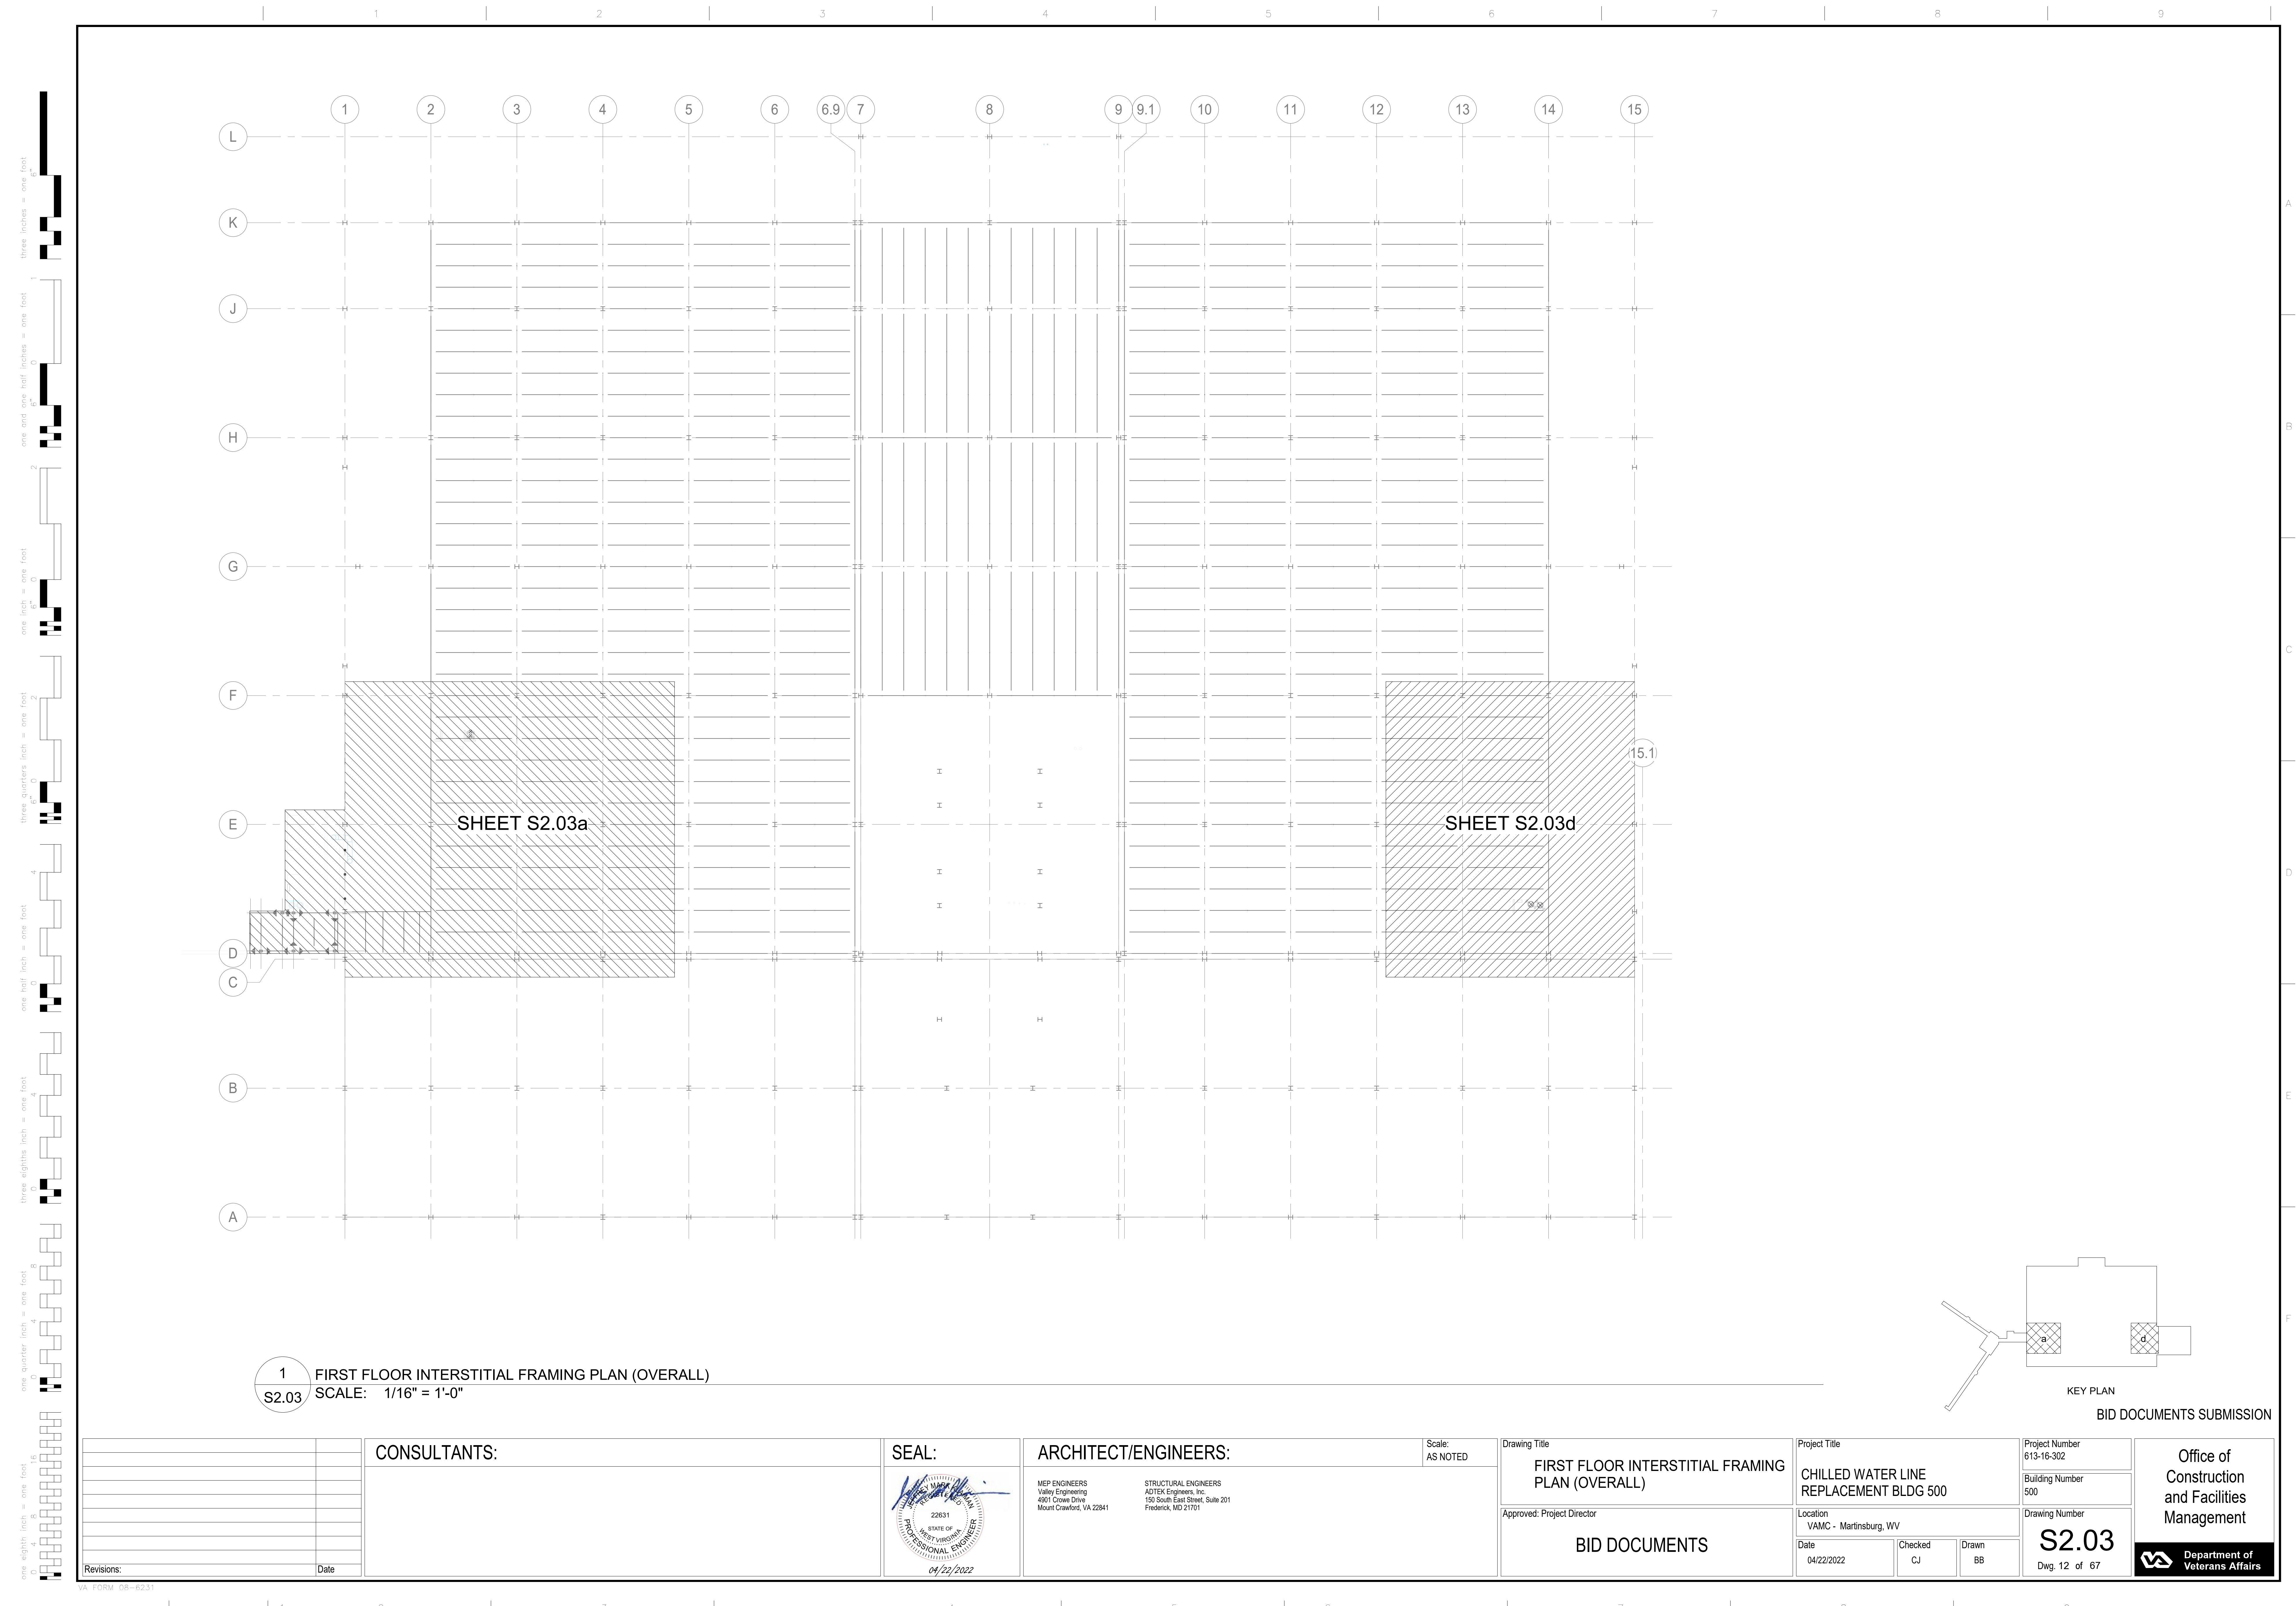

1  
S2.03 FIRST FLOOR INTERSTITIAL FRAMING PLAN (OVERALL)  
SCALE: 1/16" = 1'-0"

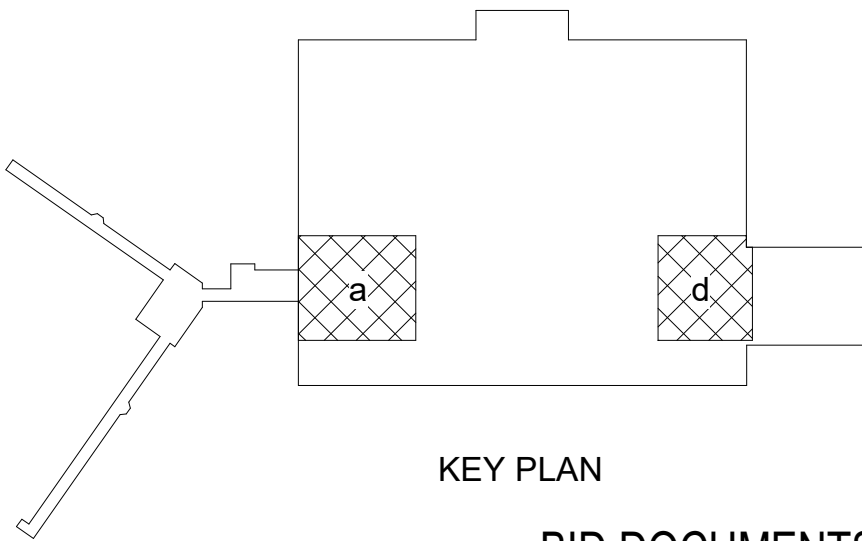

BID DOCUMENTS SUBMISSION

<div>Revisions:</div> <div>Date</div>		CONSULTANTS:	SEAL: <div><div>22831</div><div>STATE OF WEST VIRGINIA</div><div>PROFESSIONAL ENGINEER</div><div>04/22/2022</div></div>	ARCHITECT/ENGINEERS: <div><div>MEP ENGINEERS</div><div>Valley Engineering</div><div>4901 Crowe Drive</div><div>Mount Crawford, VA 22841</div><div>STRUCTURAL ENGINEERS</div><div>ADTEK Engineers, Inc.</div><div>190 South East Street, Suite 201</div><div>Frederick, MD 21701</div></div>	Scale: <div>AS NOTED</div>	Drawing Title <div>FIRST FLOOR INTERSTITIAL FRAMING PLAN (OVERALL)</div>	Project Title <div>CHILLED WATER LINE REPLACEMENT BLDG 500</div>	Project Number <div>613-16-302</div>	Office of Construction and Facilities Management Department of Veterans Affairs
					Approved: Project Director	Location <div>VAMC - Martinsburg, WV</div>	Building Number <div>500</div>	Location <div>VAMC - Martinsburg, WV</div>	
					BID DOCUMENTS	Date <div>04/22/2022</div>	Checked <div>CJ</div>	Drawn <div>BB</div>	

S2.03a SCALE: 1/4" = 1'-0"




	Office of
	Construction
	and Facilities
	Management



Department of  
Veterans Affairs

VA FORM 08-6231




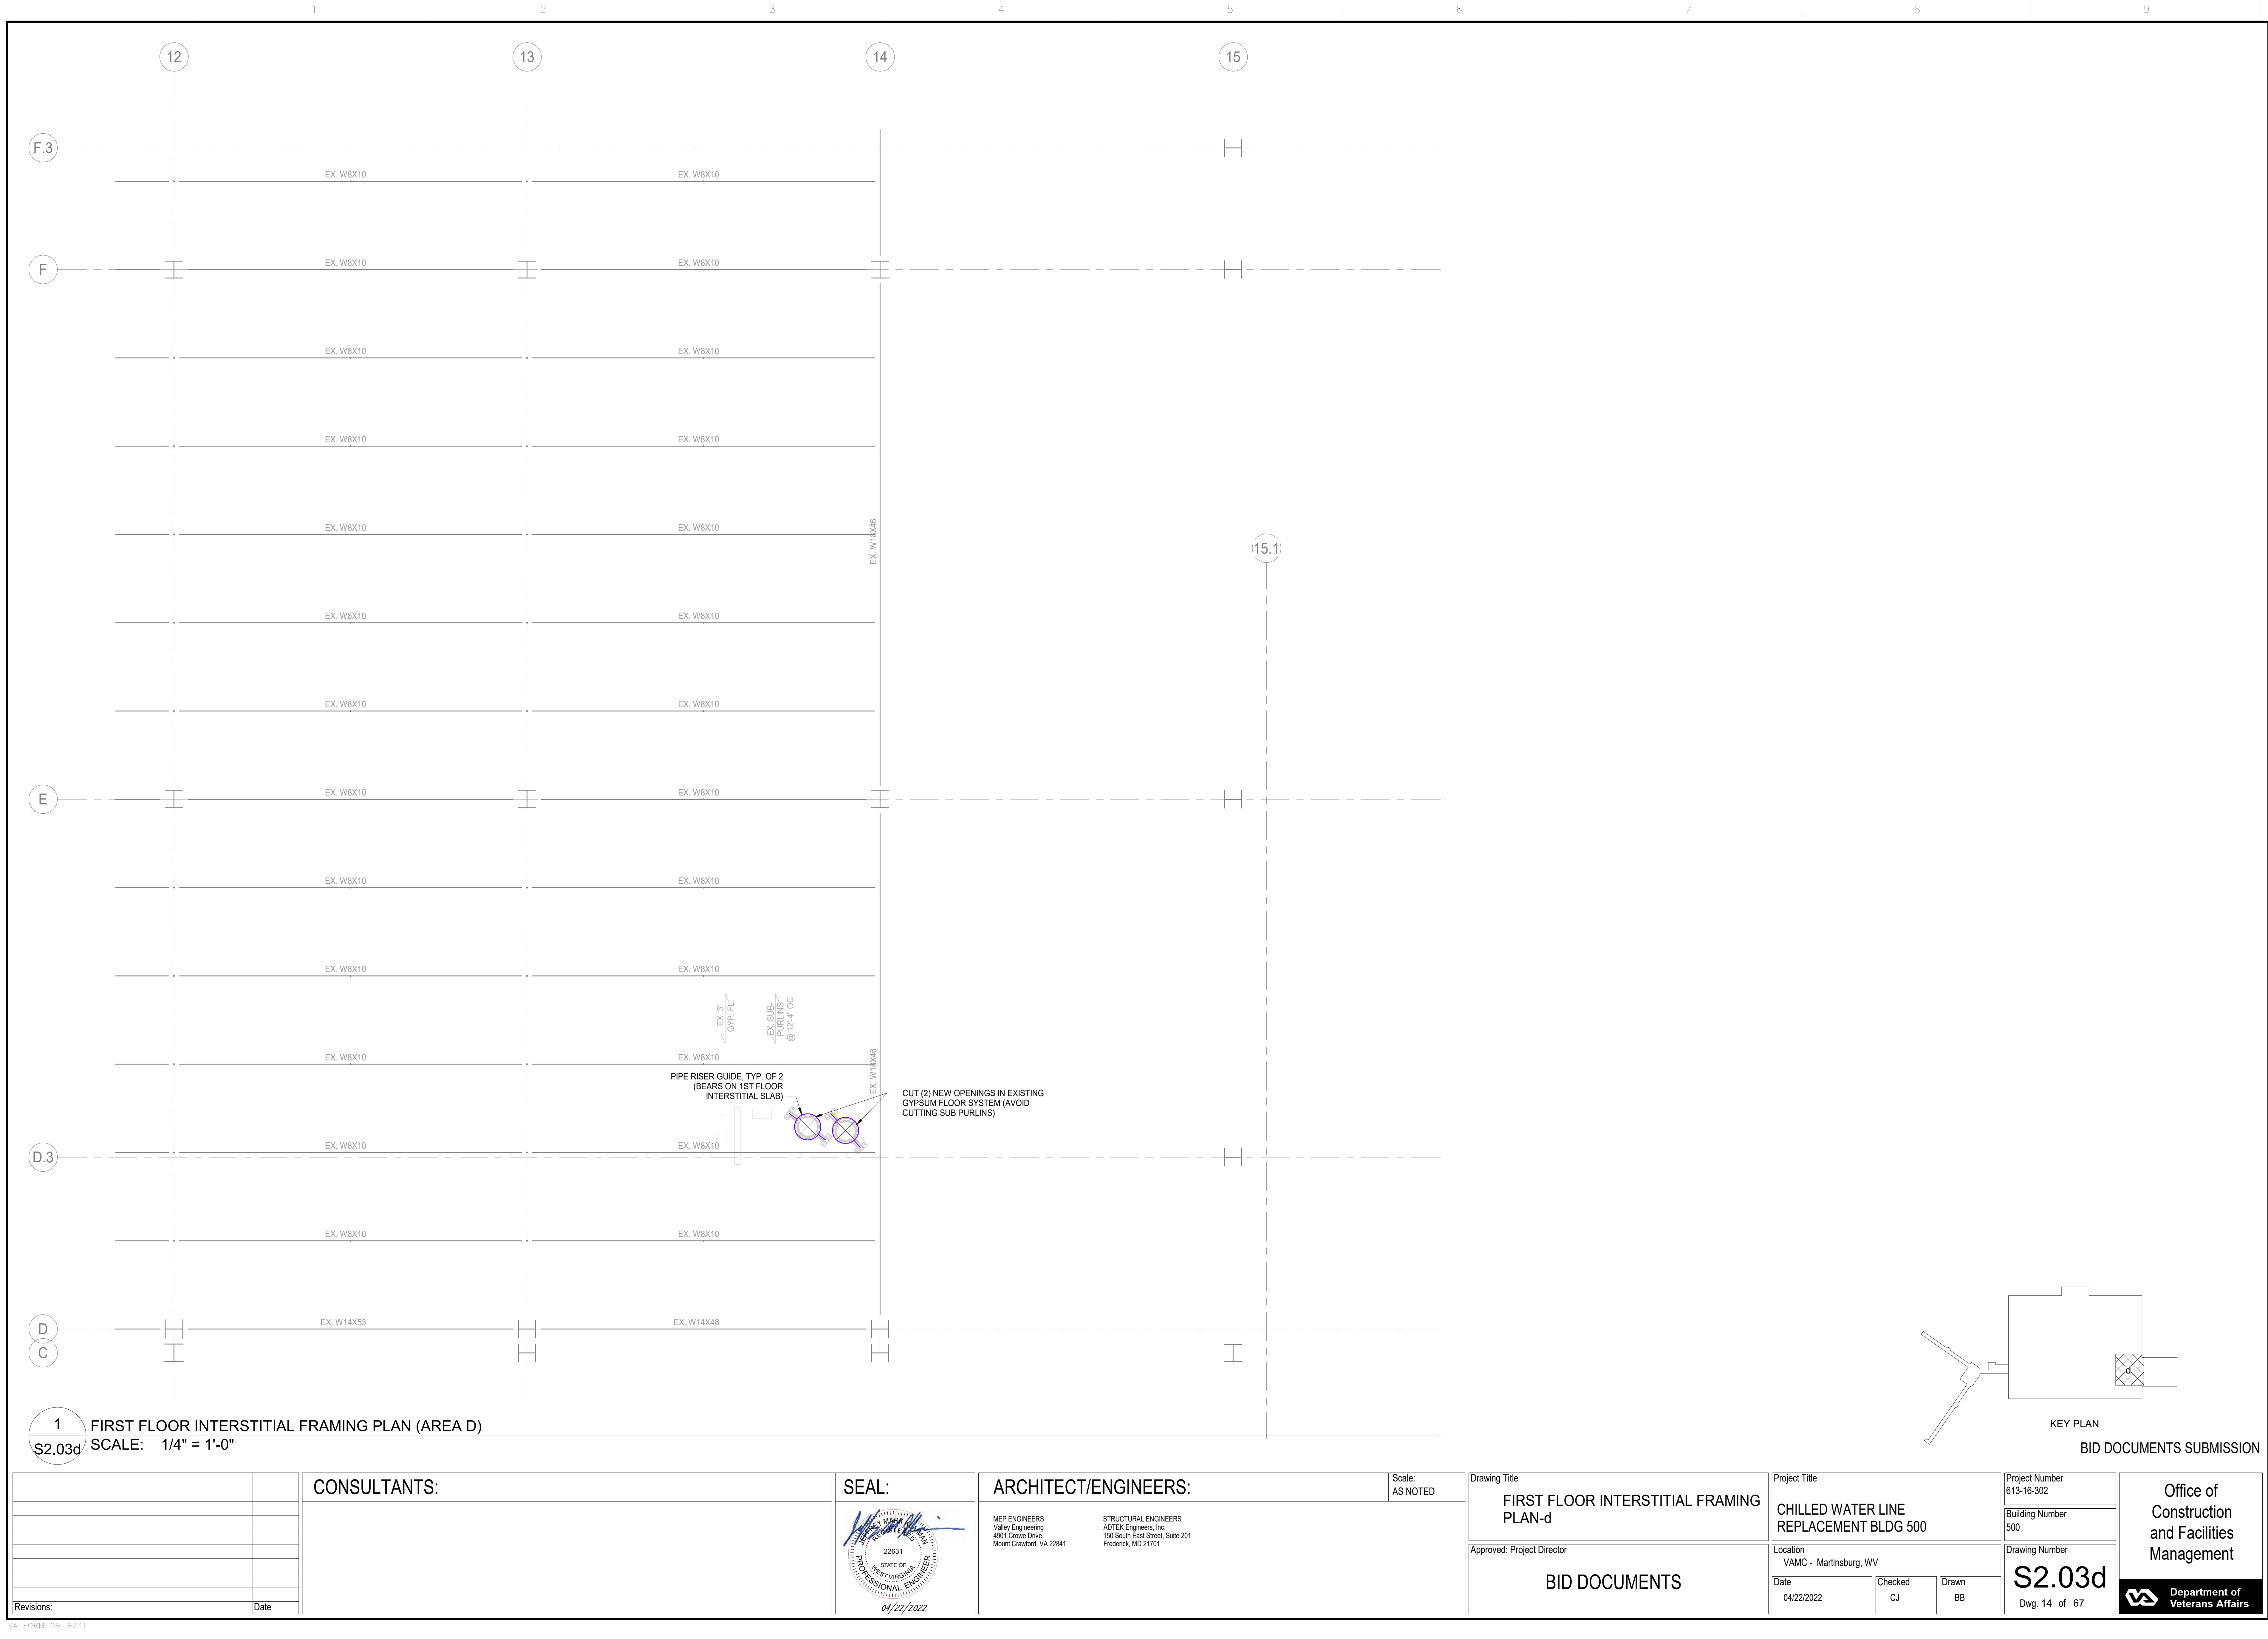


BID

BID DOCUMENTS SUBMISSION

[illegible]

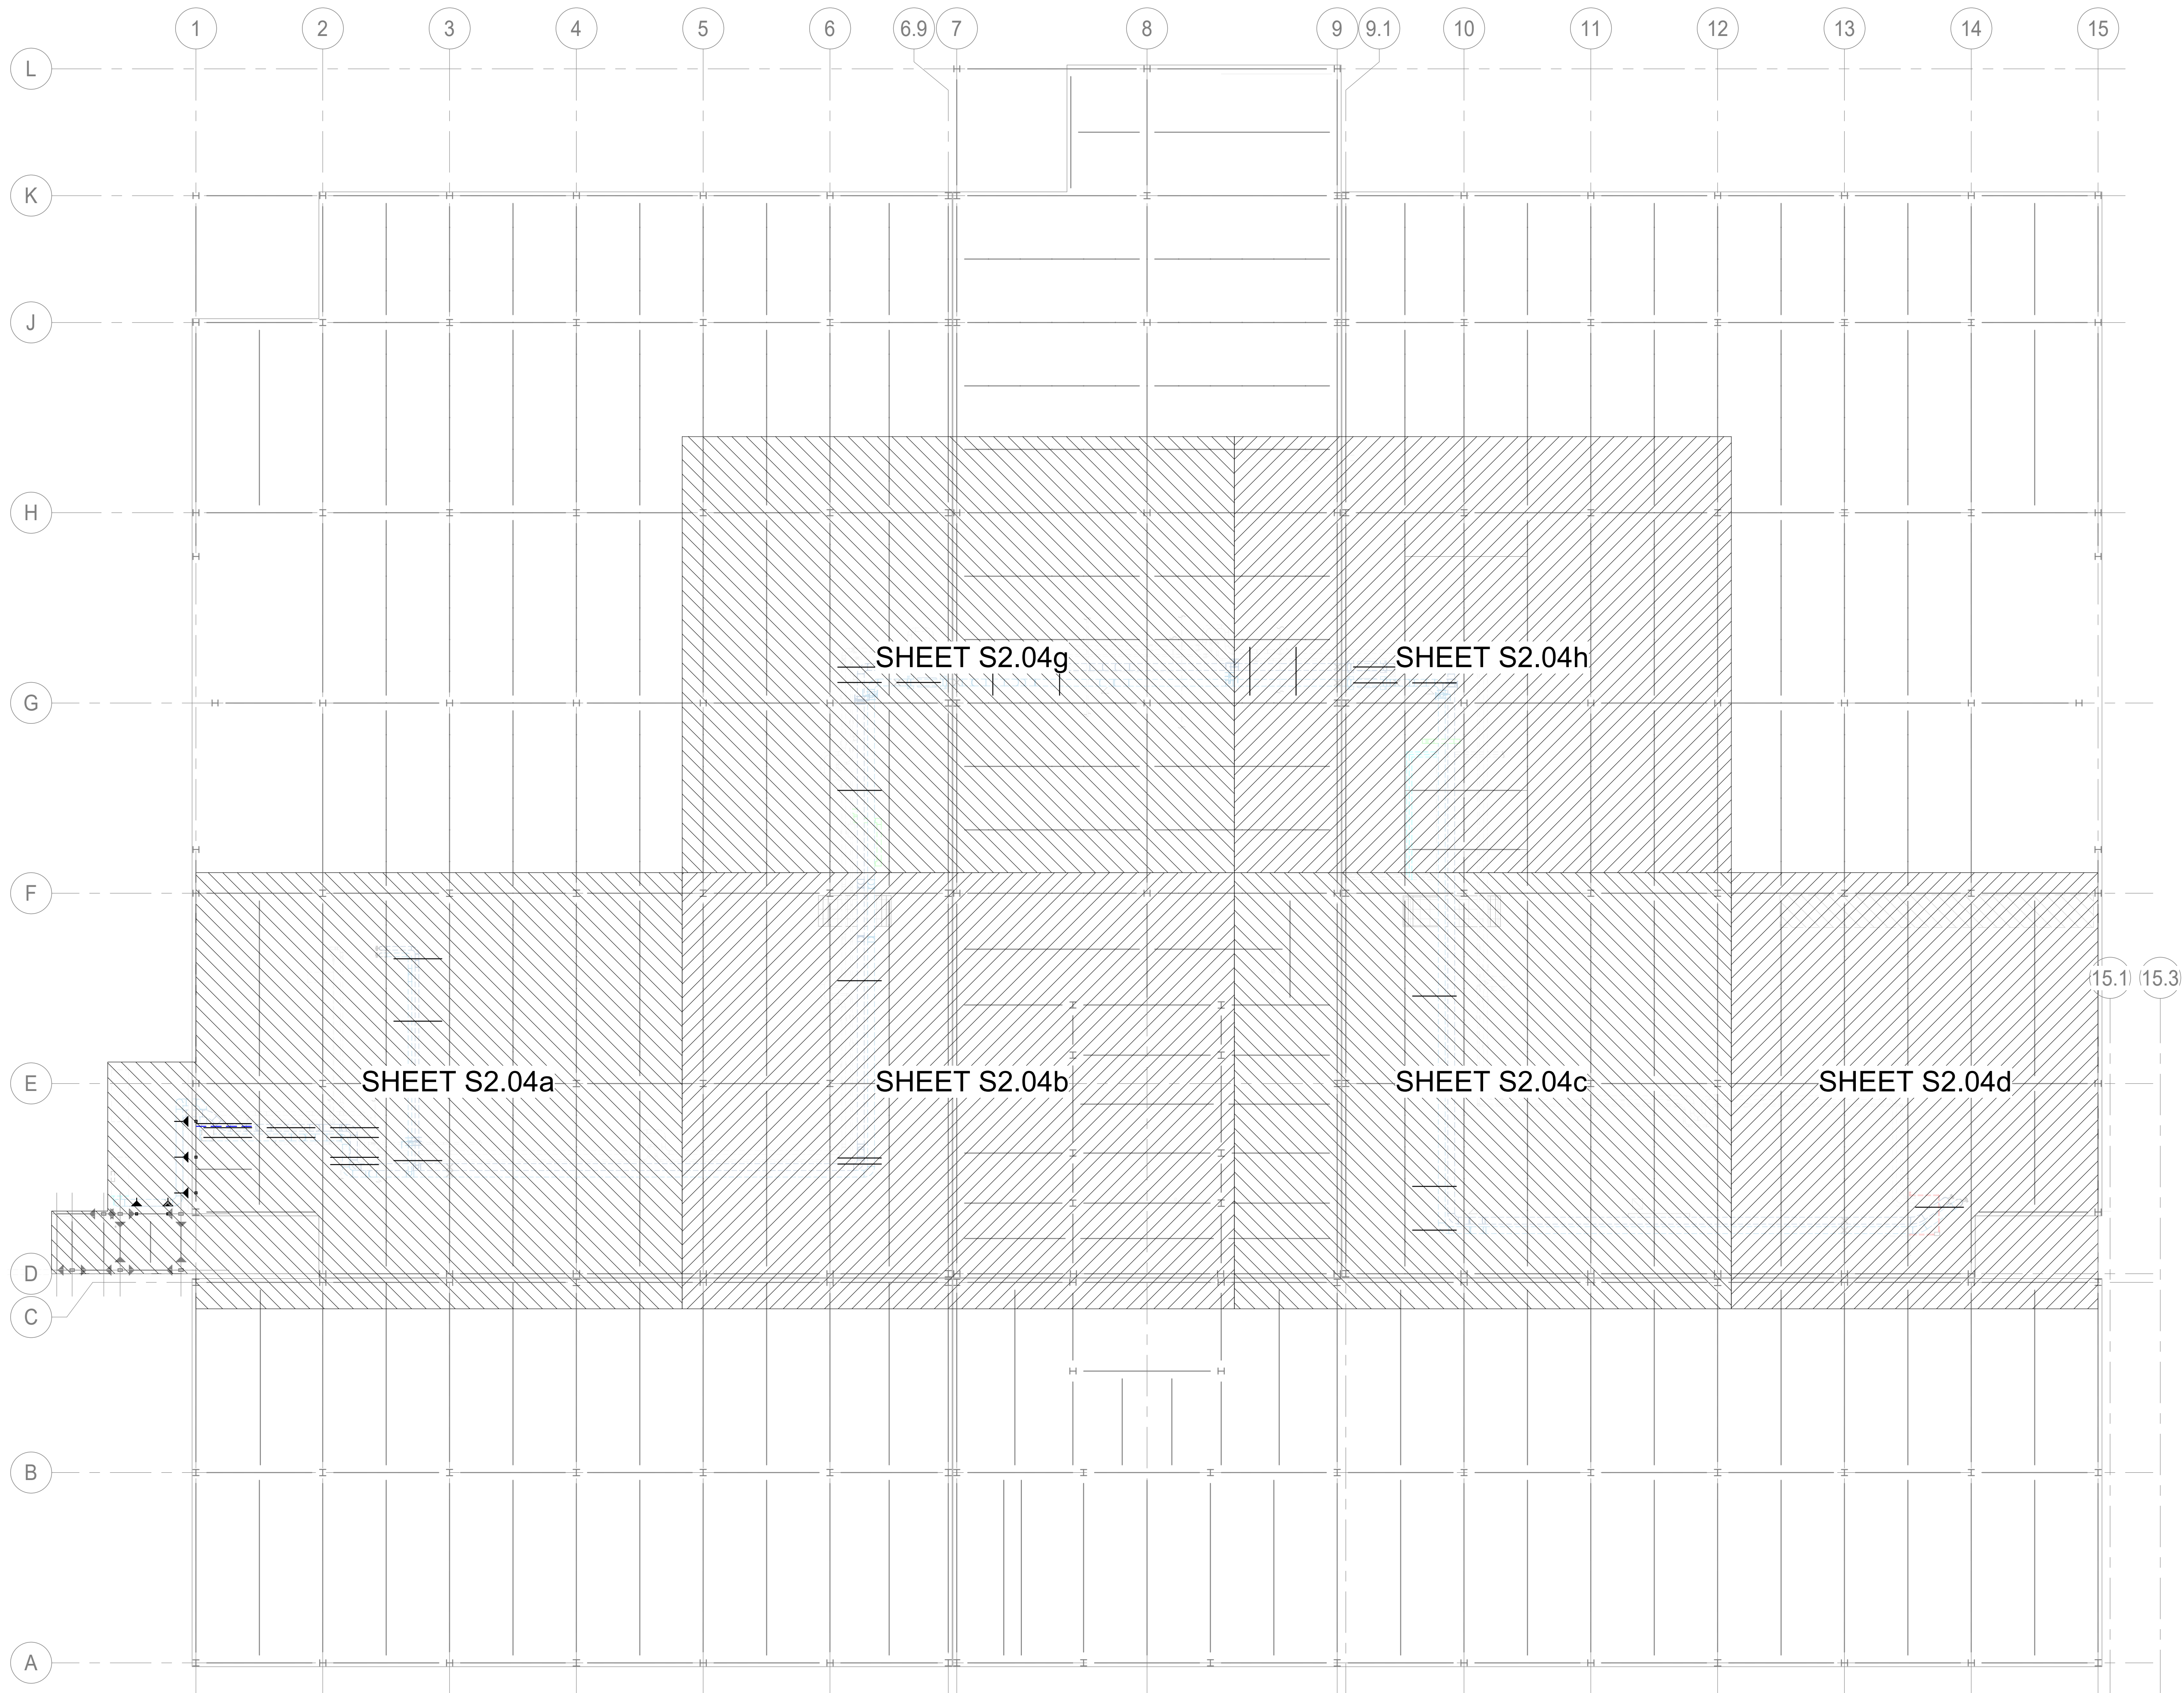

1 SECOND FLOOR FRAMING PLAN (OVERALL)  
S2.04 SCALE: 1/16" = 1'-0"

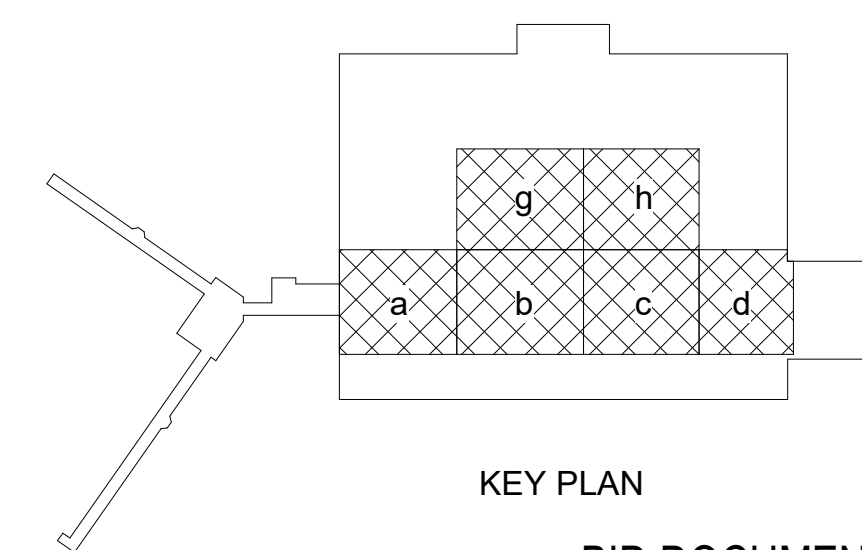


KEY PLAN


BID DOCUMENTS SUBMISSION

CONSULTANTS:		SEAL:	ARCHITECT/ENGINEERS:	Scale: AS NOTED	Drawing Title SECOND FLOOR FRAMING PLAN (OVERALL)	Project Title CHILLED WATER LINE REPLACEMENT BLDG 500	Project Number 613-16-302	Office of Construction and Facilities Management  Department of Veterans Affairs
			MEP ENGINEERS Valley Engineering 4901 Crowe Drive Mount Crawford, VA 22841  STRUCTURAL ENGINEERS ADTEK Engineers, Inc. 190 South East Street, Suite 201 Frederick, MD 21701	Approved: Project Director	Location VAMC - Martinsburg, WV	Building Number 500	Drawing Number S2.04	
Revisions:				Date	Date 04/22/2022	Date 04/22/2022	Checked CJ	



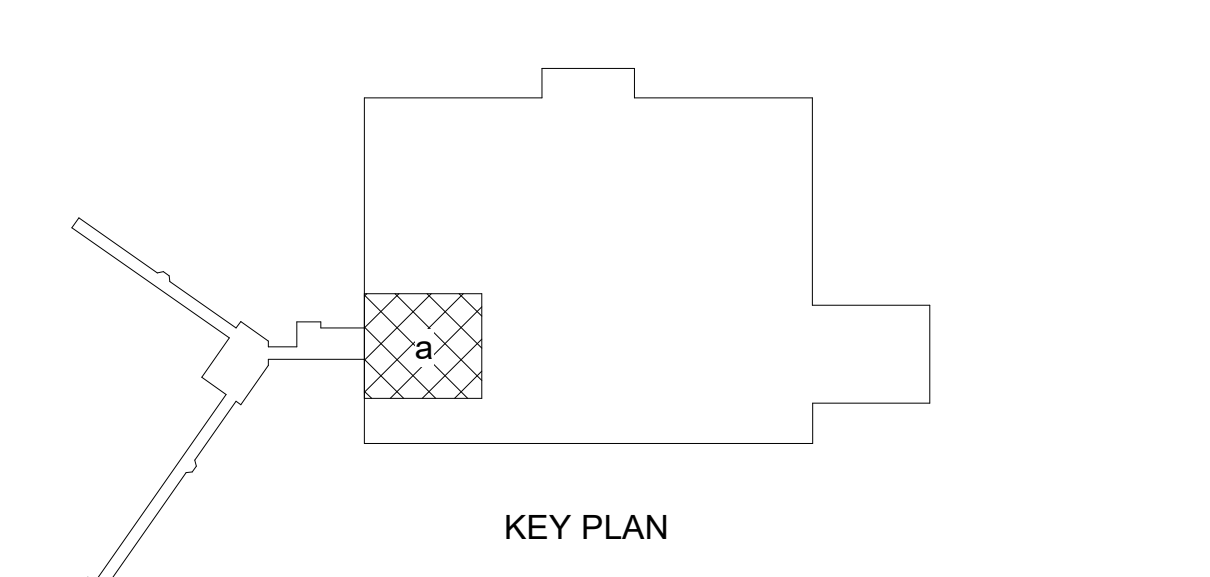


Department of  
Veterans Affairs

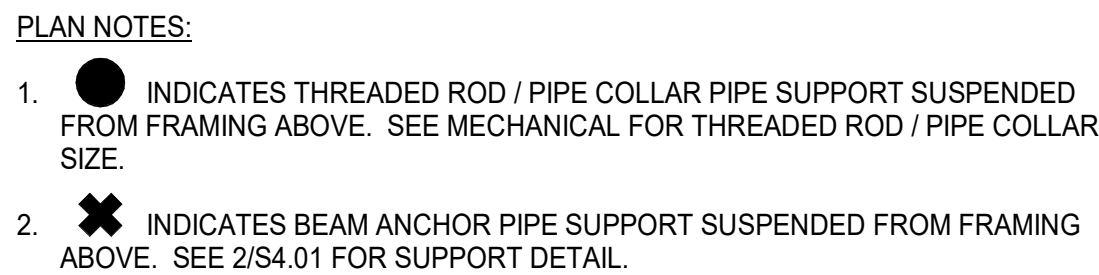



Department of  
Veterans Affairs

VA FORM 08-6231




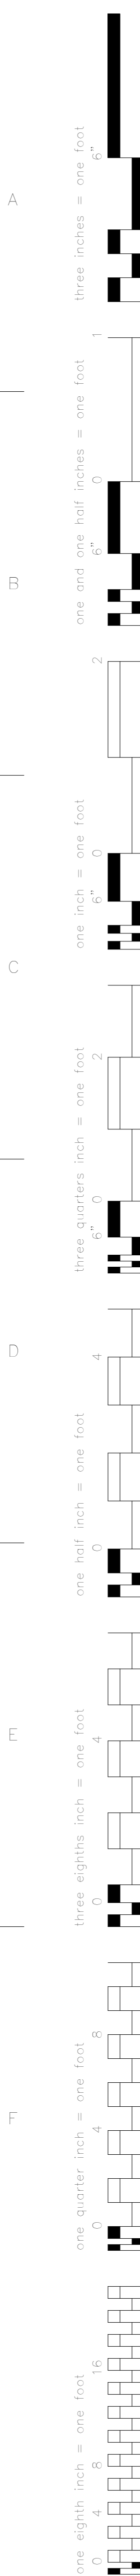

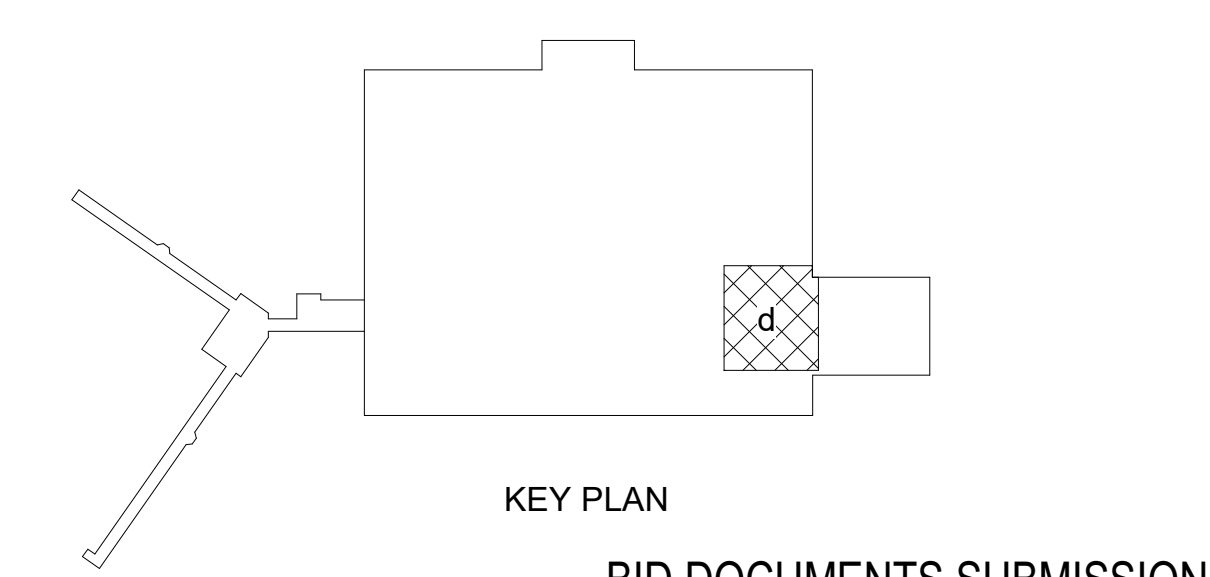

Project Title			Project Number 613-16-302		<div>Office of Construction and Facilities Management</div> <div>  <b>Department of Veterans Affairs</b> </div>
CHILLED WATER LINE REPLACEMENT BLDG 500			Building Number 500		
Location VAMC - Martinsburg, WV			Drawing Number		
Date 04/22/2022	Checked CJ	Drawn BB	<b>S2.04d</b> Dwg. 19 of 67		



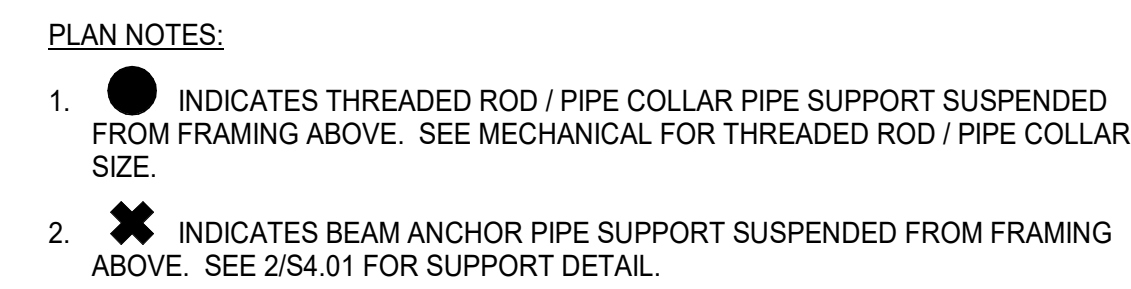

BID DOCUMENTS SUBMISSION




VA FORM 08-6231







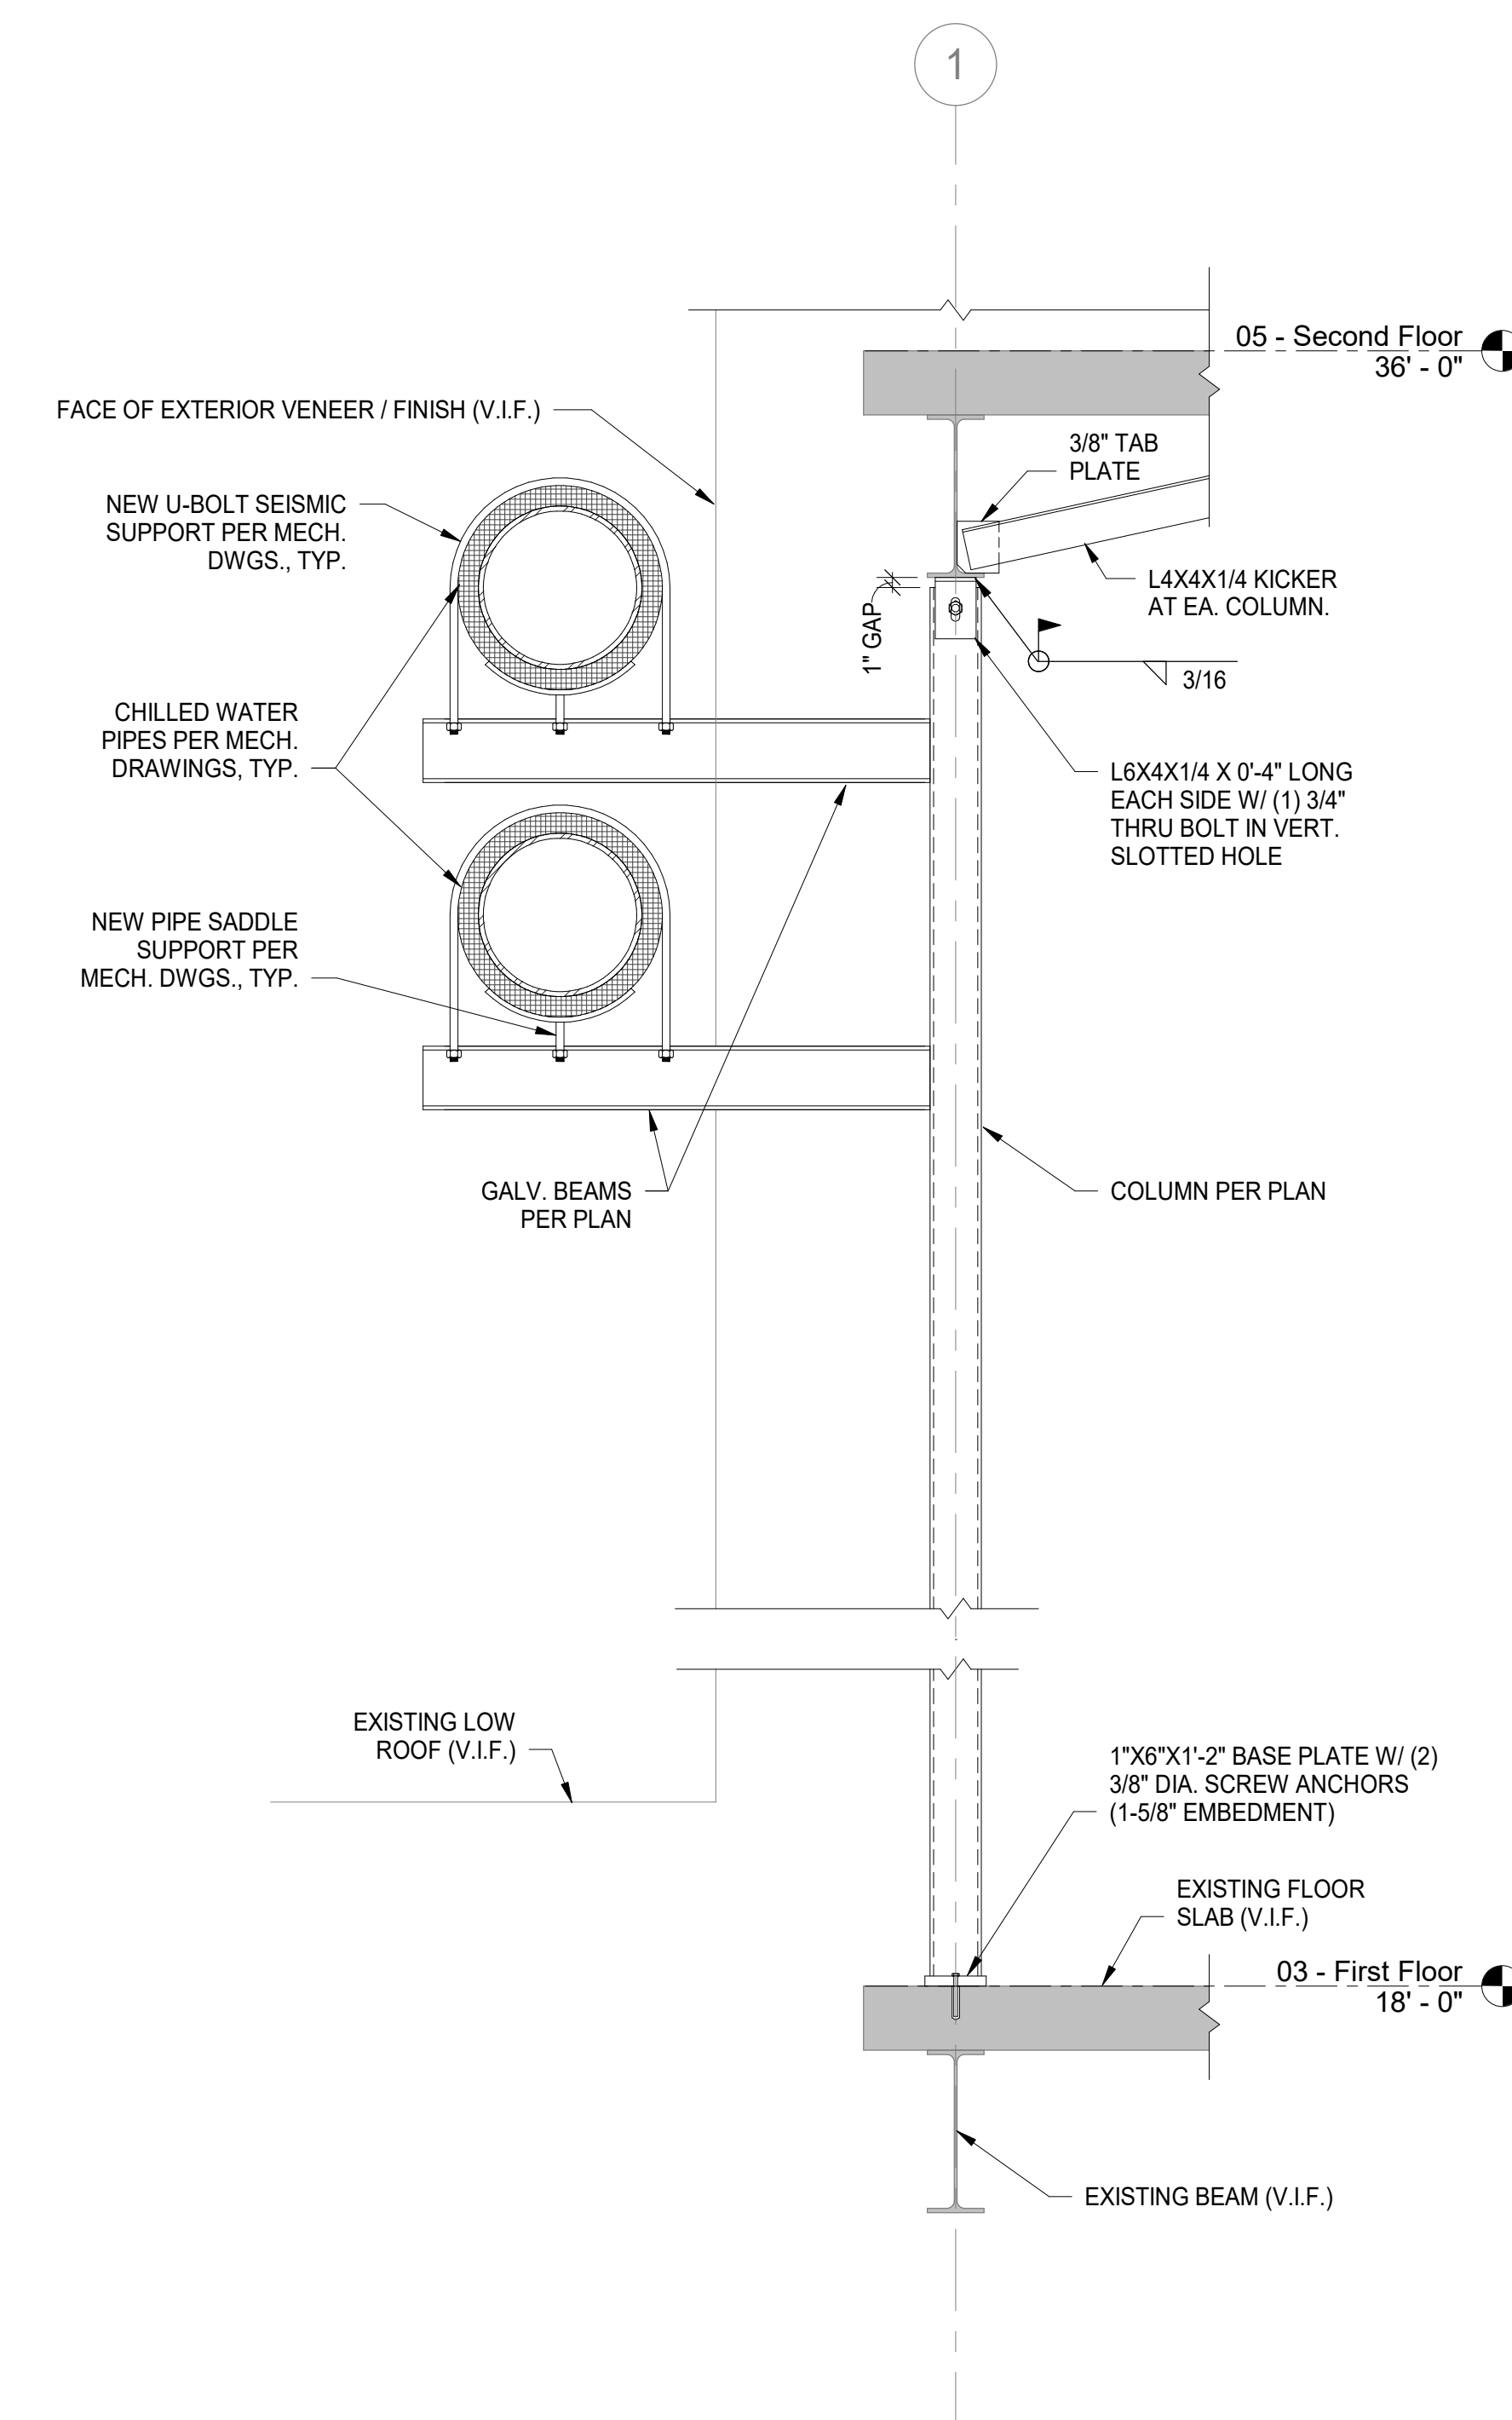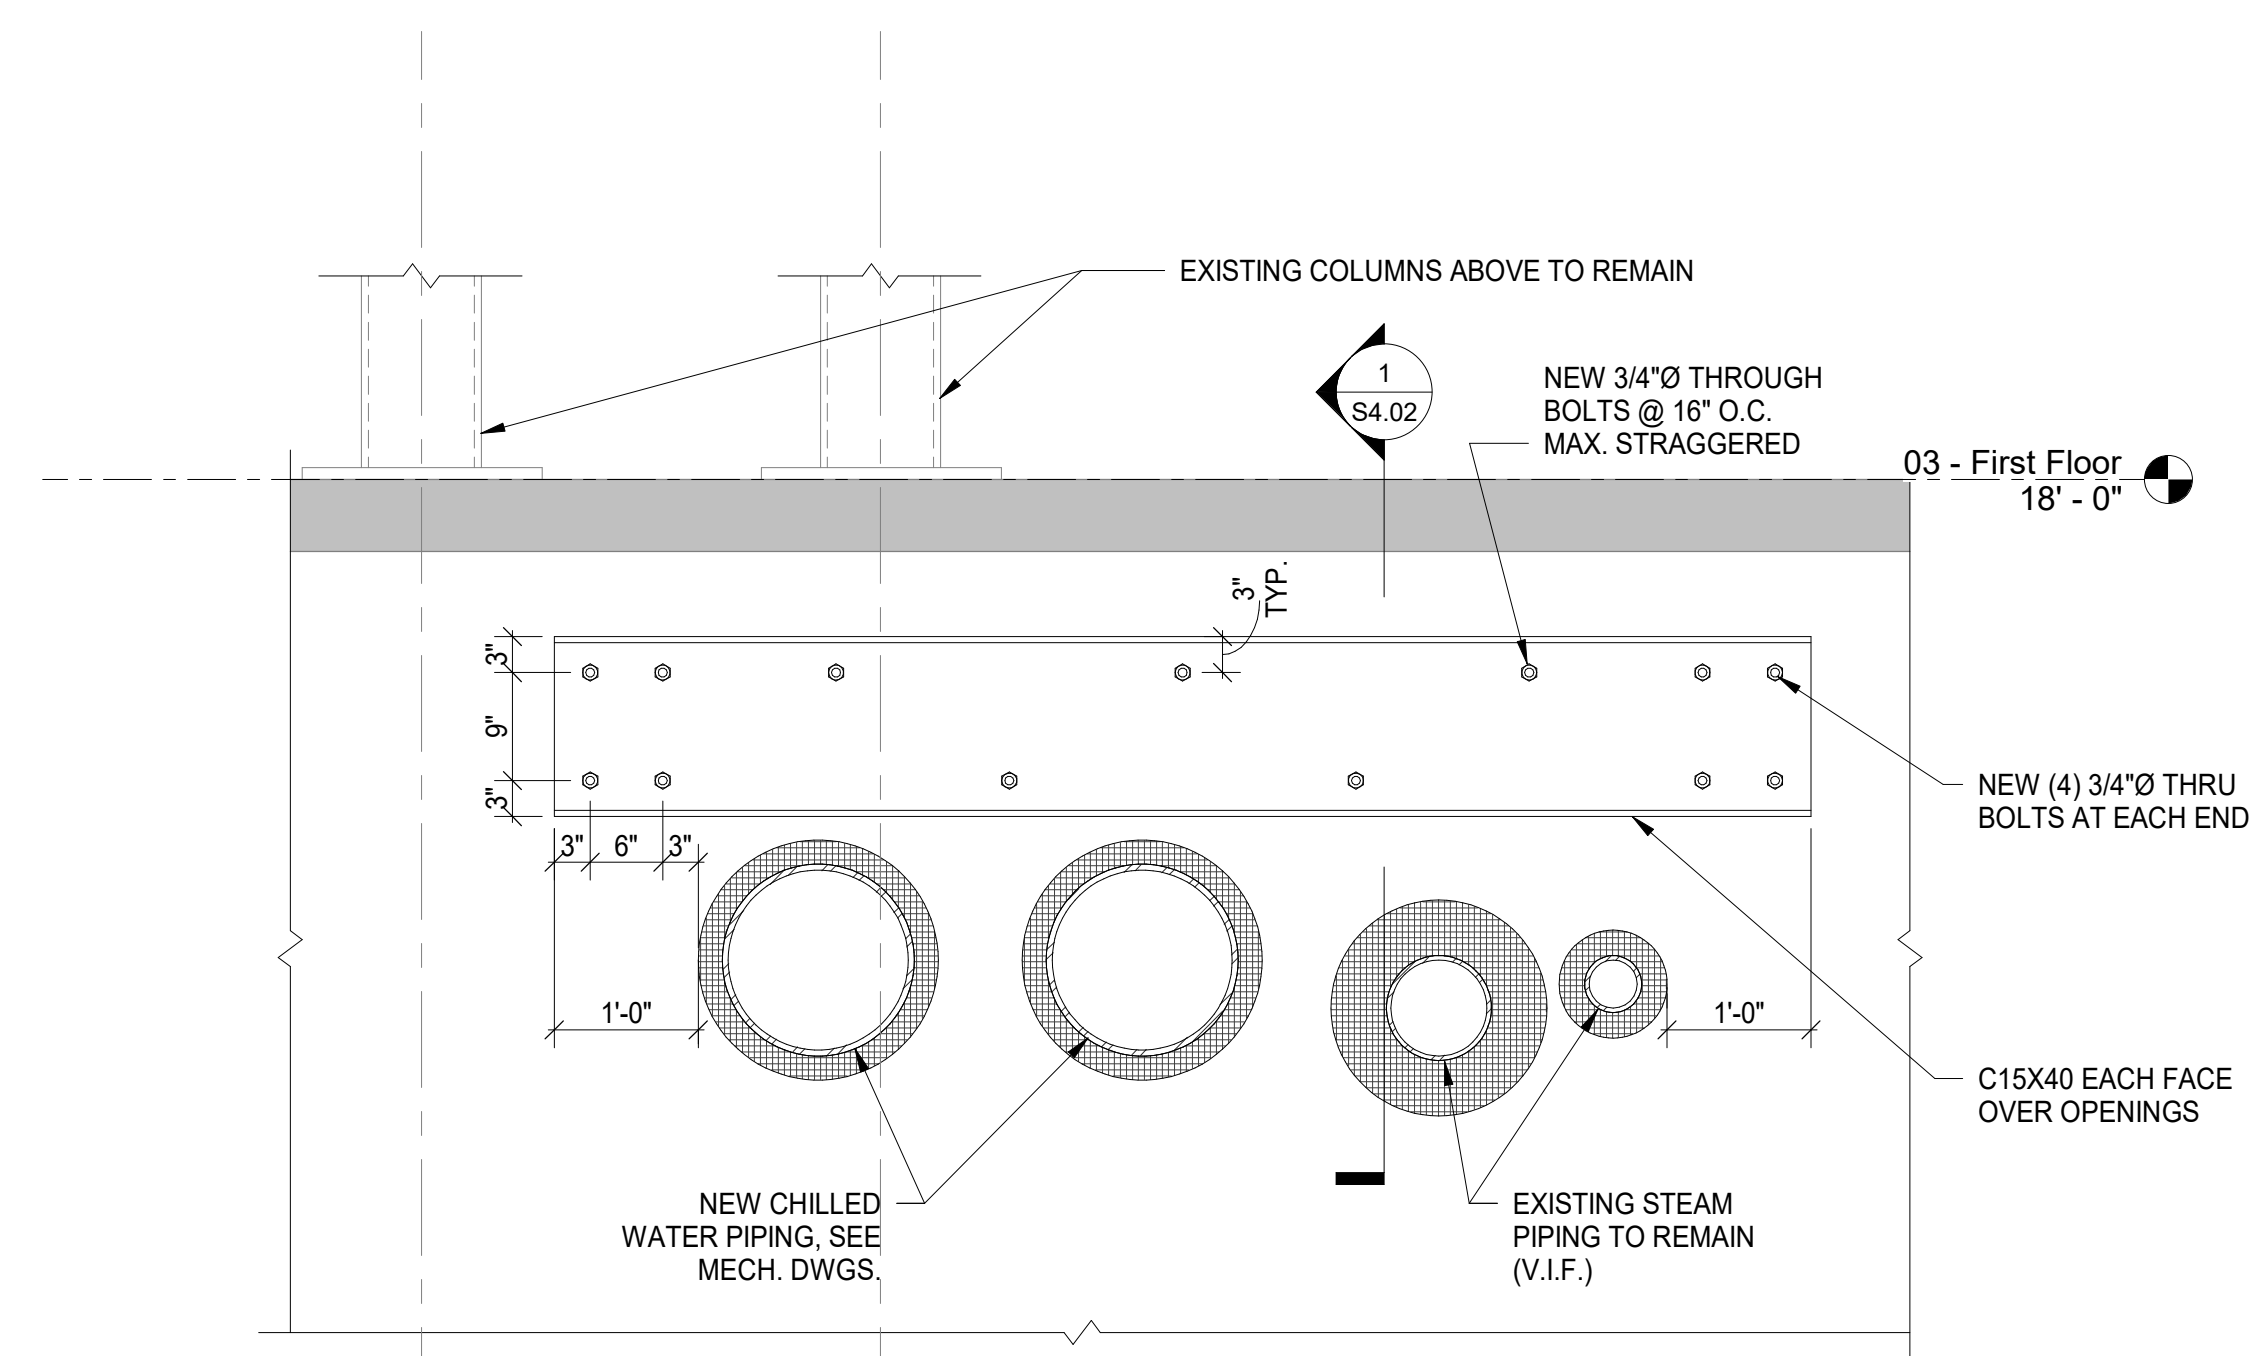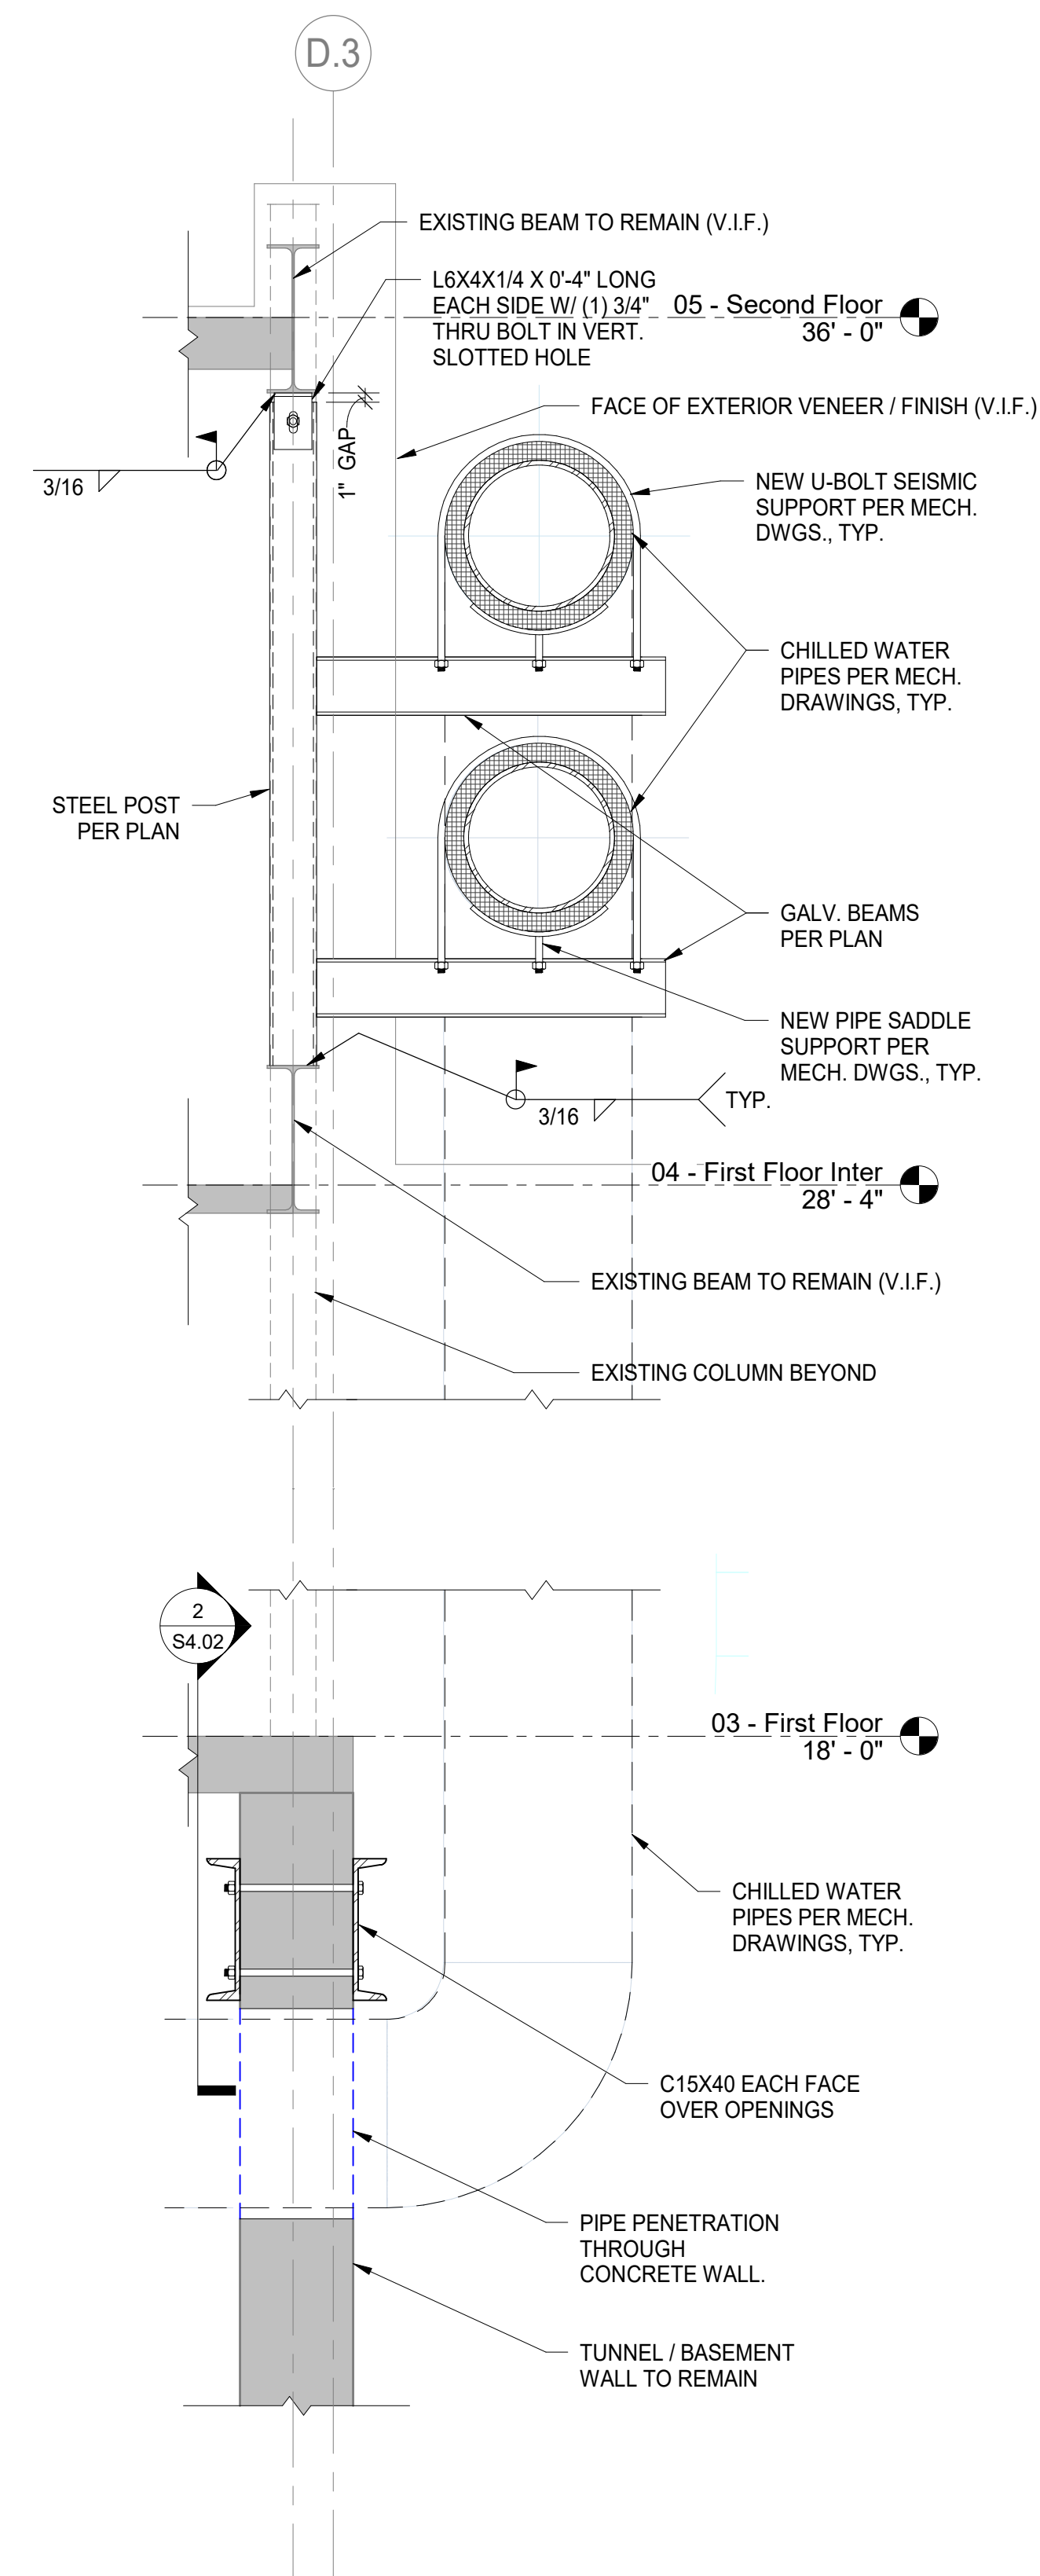

[illegible]

CONSULTANTS:

SEAL:



ARCHITECT/ENGINEERS:

MEP ENGINEERS  
Valley Engineering  
4901 Crowe Drive  
Mount Crawford, VA 22841

STRUCTURAL ENGINEERS  
ADTEK Engineers, Inc.  
150 South East Street, Suite 201  
Frederick, MD 21701

Scale:	AS NOTED
--------	----------

Drawing Title

SECTIONS & ELEVATIONS

Approved: Project Director

BID DOCUMENTS

Project Title	CHILLED WATER LINE REPLACEMENT BLDG 500
---------------	--------------------------------------------

Location	VAMC - Martinsburg, WV
----------	------------------------

Date  
04/22/2022

Checked	C.I
---------	-----

Drawn	BB
-------	----

Project Number	613-16-302
----------------	------------

Building Number  
500

Drawing Number

Dwg. 23 of 67

BID DOCUMENTS SUBMISSION

Office of  
Construction  
and Facilities  
Management

