


1

2

3


4

5

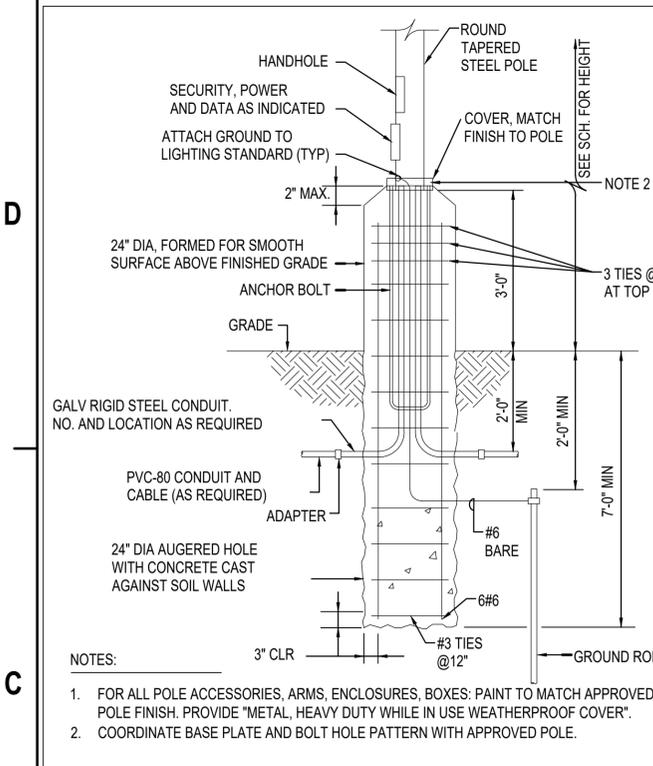


ELEVATED BASE ALUMINUM POLE

REVISED: MARCH 2013 LUMINAIRE PLATE: XL-27A

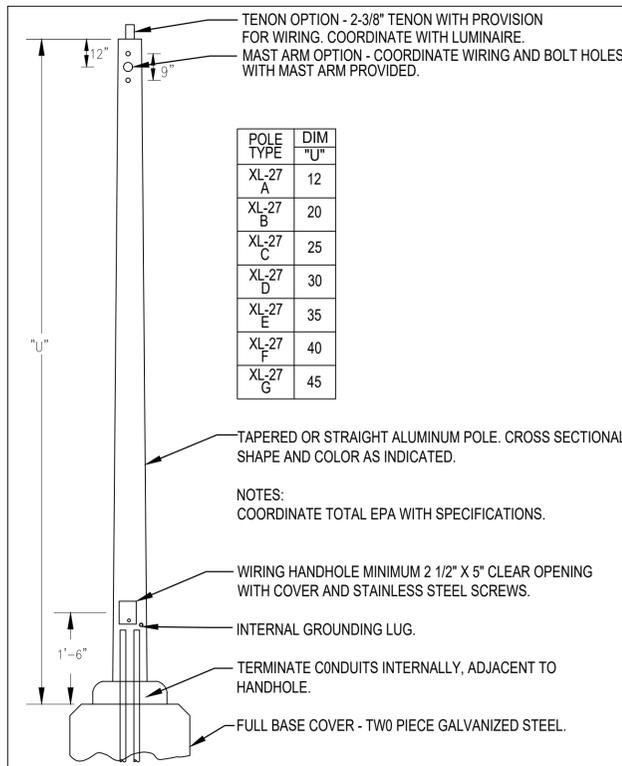


ANCHOR BASE ALUMINUM POLE

REVISED: MARCH 2013 LUMINAIRE PLATE: XL-27

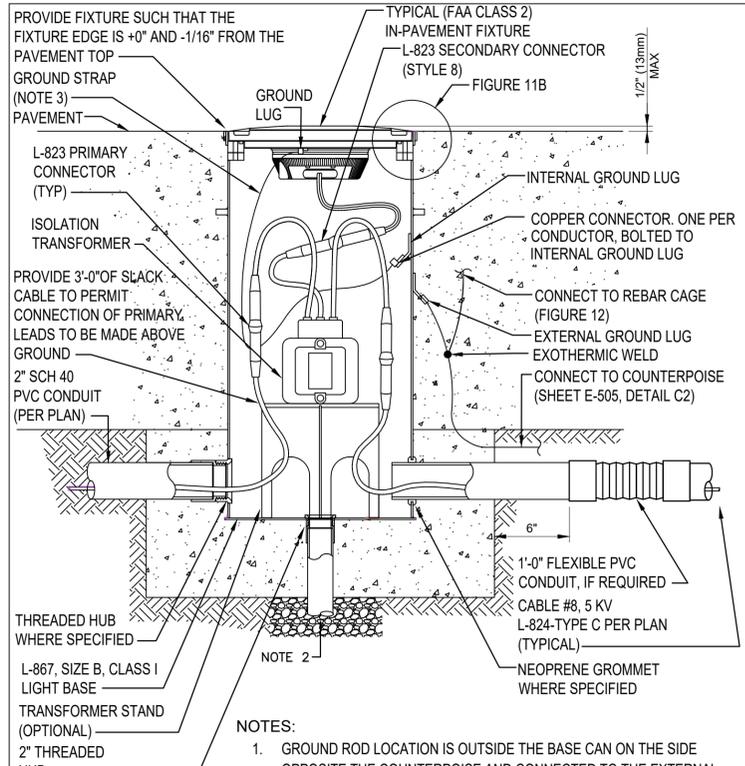

TYPICAL AIRFIELD IN-PAVEMENT LIGHTING

REVISED: MARCH 2013 LUMINAIRE PLATE: TYPE B

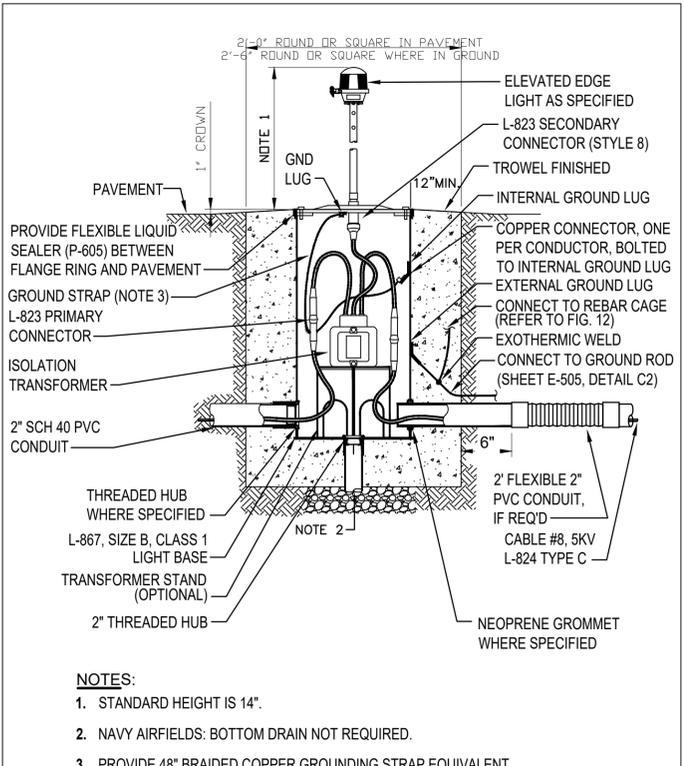

TYPICAL AIRFIELD ELEVATED LIGHTING

REVISED: MARCH 2013 LUMINAIRE PLATE: TYPE A

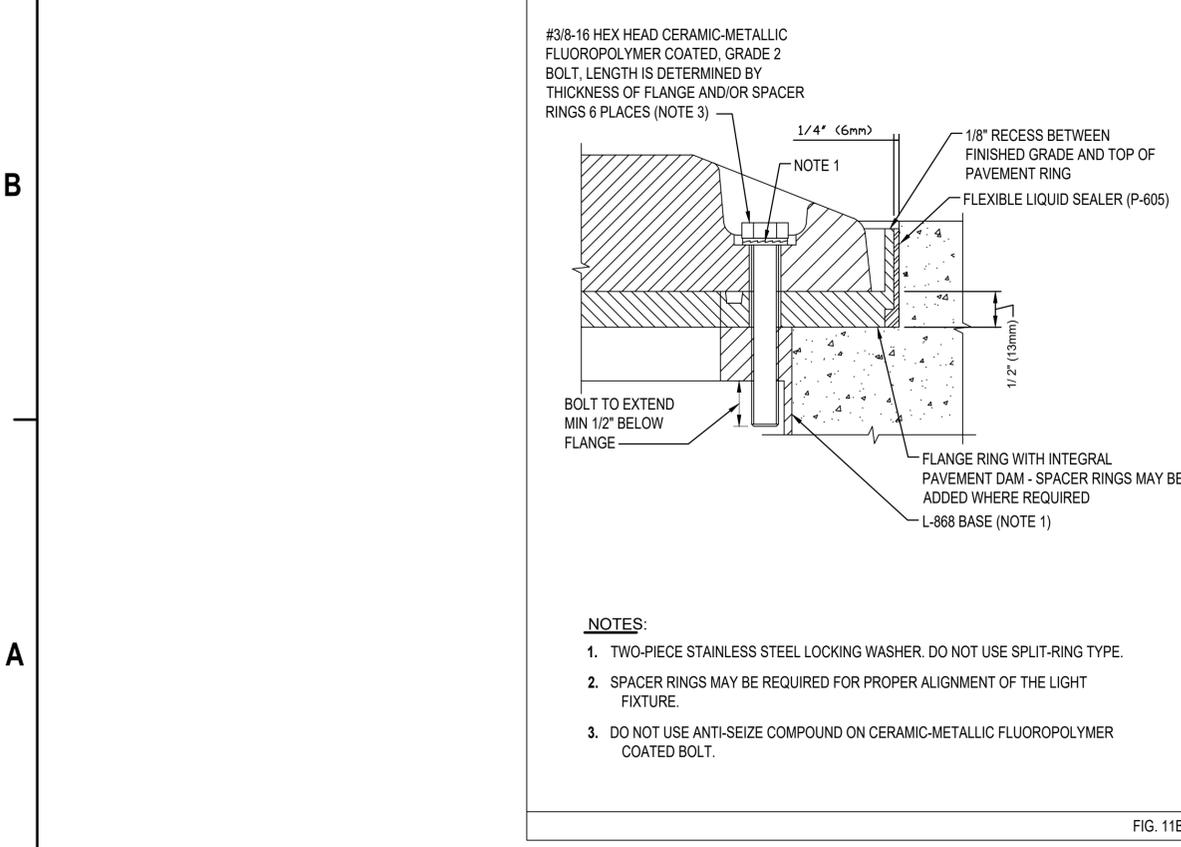


FIG. 11B

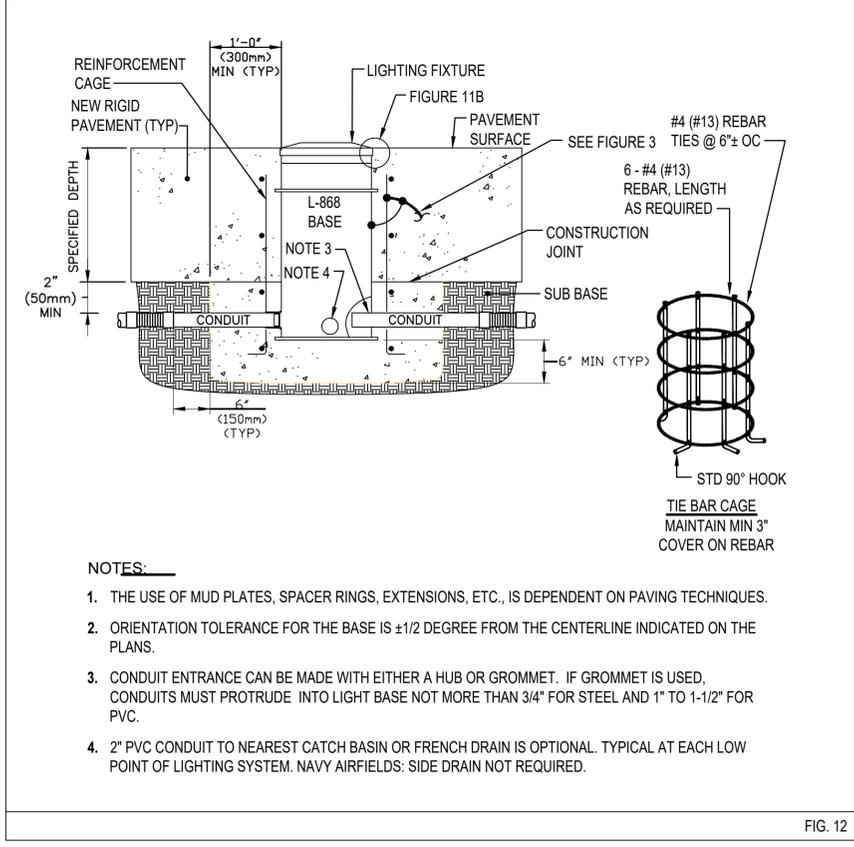


FIG. 12

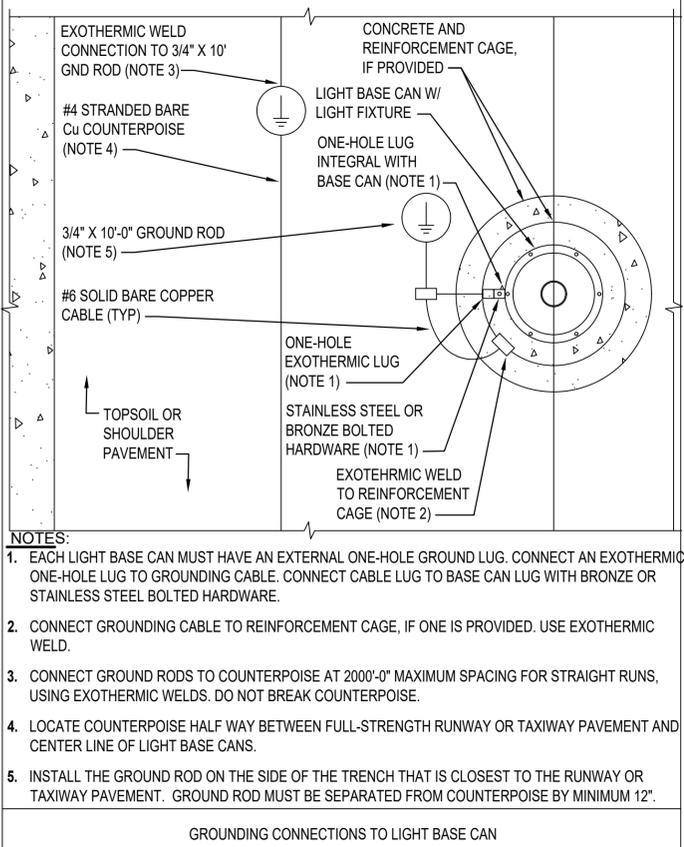


FIG. 3

DATE	04/15/2023	APPR
DATE	9/26/2022	APPD
SYM	DESCRIPTION	
0	ISSUE FOR CONSTRUCTION	
1	AMENDMENT 005	

COMMONWEALTH OF VIRGINIA  
JIMMY CLARK HIGGINS  
Lic. No. 0402057076  
9/26/2022  
PROFESSIONAL ENGINEER

WileyWilson | BURNS & MCDONNELL  
JOINT VENTURE

FOR COMMANDER NAVFAC

ACTIVITY

SAFETY TO DATE

DES: JCH DRW: JCH CHK: PO

PMCM

BRANCH MANAGER

CHIEF ENGINEER

FIRE PROTECTION

NAVAL FACILITIES ENGINEERING COMMAND  
WASHINGTON WASHINGTON DC

NAVAL FACILITIES ENGINEERING COMMAND - WASHINGTON WASHINGTON DC

JOINT BASE ANDREWS NAVAL AIR FACILITY CAMP SPRINGS, MD

P-3002 RELOCATE HAZARDOUS CARGO PAD AND EOD PROFICIENCY RANGE

ELECTRICAL DETAILS

SCALE: AS NOTED

EPROJCT NO: 1396650

CONSTR. CONTR. NO: N40080-15-D-0452

NAVFAC DRAWING NO: 13132531

SHEET 186 OF 212

E-500

DEPARTMENT OF THE NAVY

DRAWING REVISION: 06 APRIL 2017