


VA FORM 08-6231



NOTE: AT RETAINING WALL FOOTING DESIGNATION IS FOR ADDITION OF REBAR MAT ONLY.
AT MAT FOOTINGS, LONG WAY BARS SHALL HAVE TOP AND BOT PRIORITY.

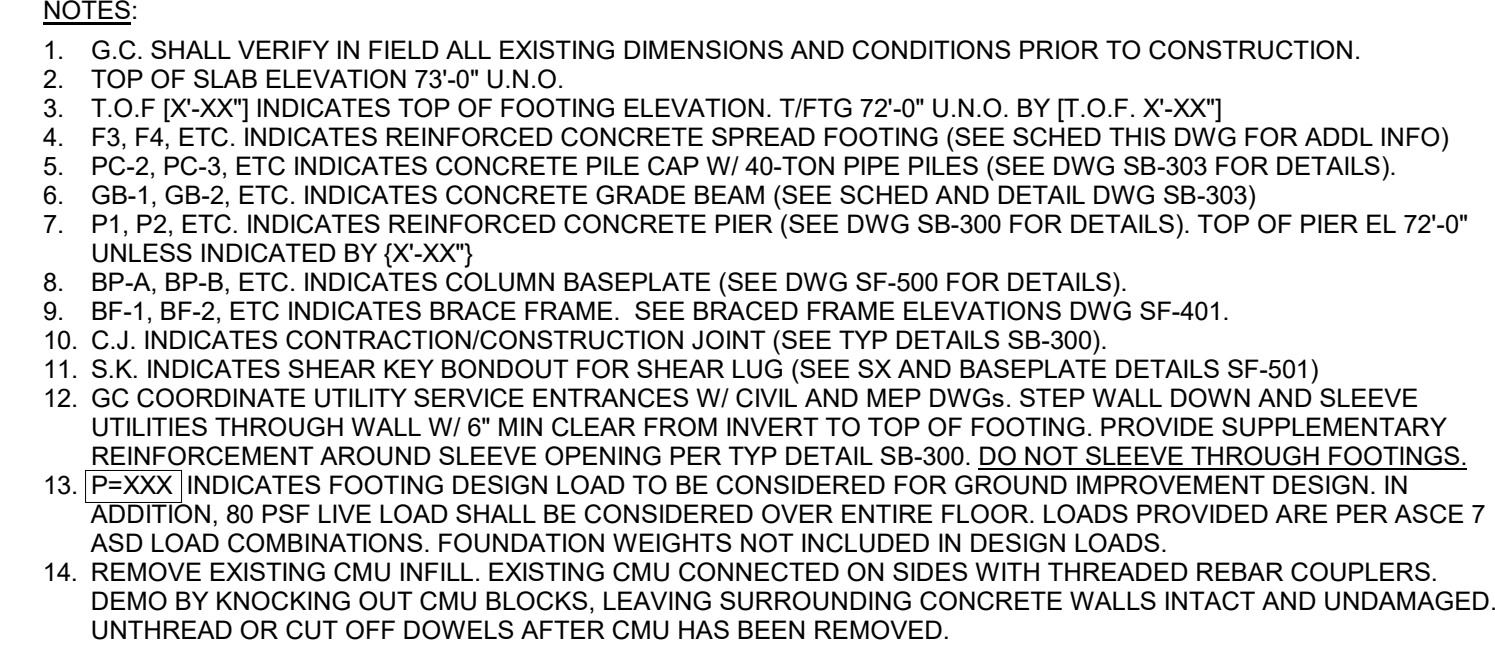

Revisions:	Revision Description	Date:
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Thornton Tomasetti

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BANGOR, MAINE 207-947-4511
PORTLAND, MAINE 207-828-4511
SARASOTA, FLORIDA 941-556-0757



VA U.S. Department
of Veterans Affairs

Approved: **VA RI FACILITIES MANAGEMENT SERVICE**

FULLY SPRINKLERED


Location	830 CHALKSTONE AVE PROVIDENCE, RI 02908
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Issue Date	Checked	Drawn
FEB 04 2022	EAR	CGW


SB-101

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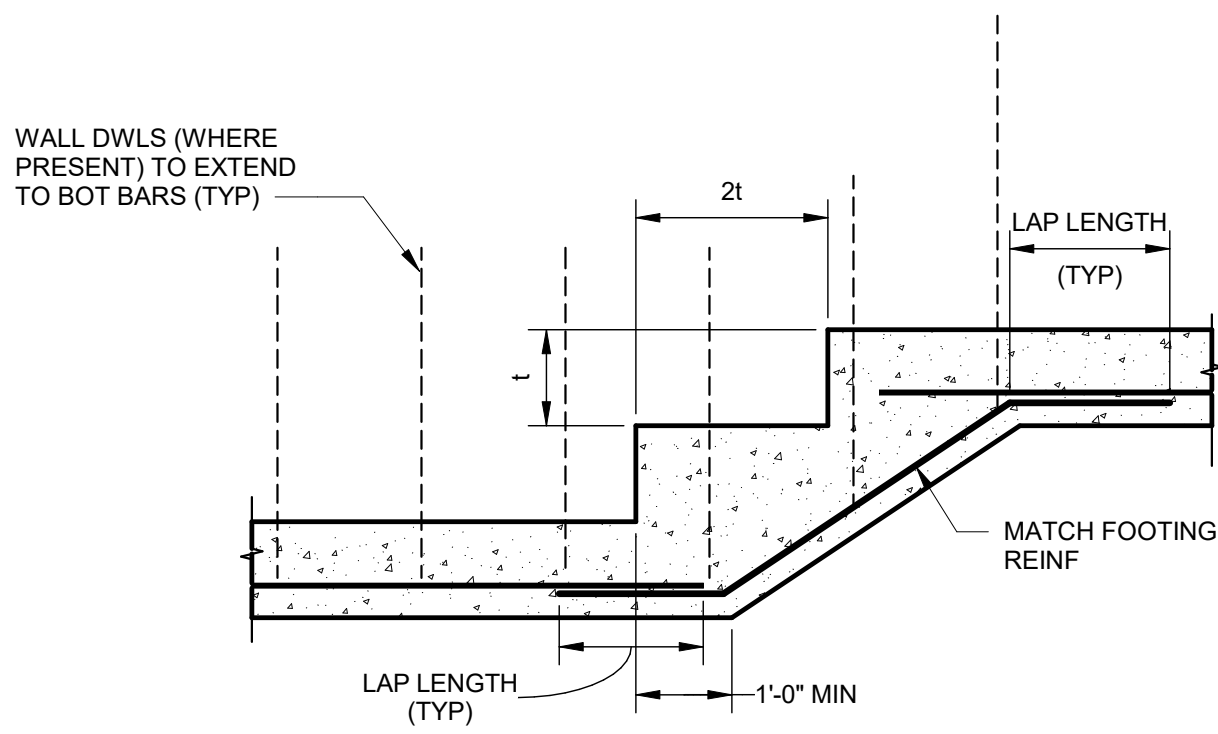
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VA FORM 08 - 6231




TYP SLAB DETAIL U.N.O.
N.T.S.

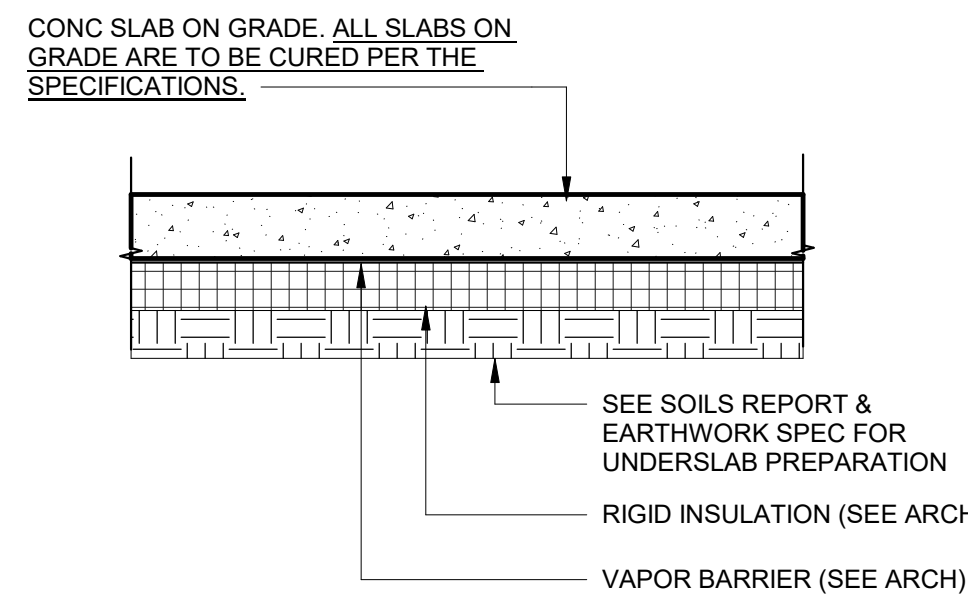

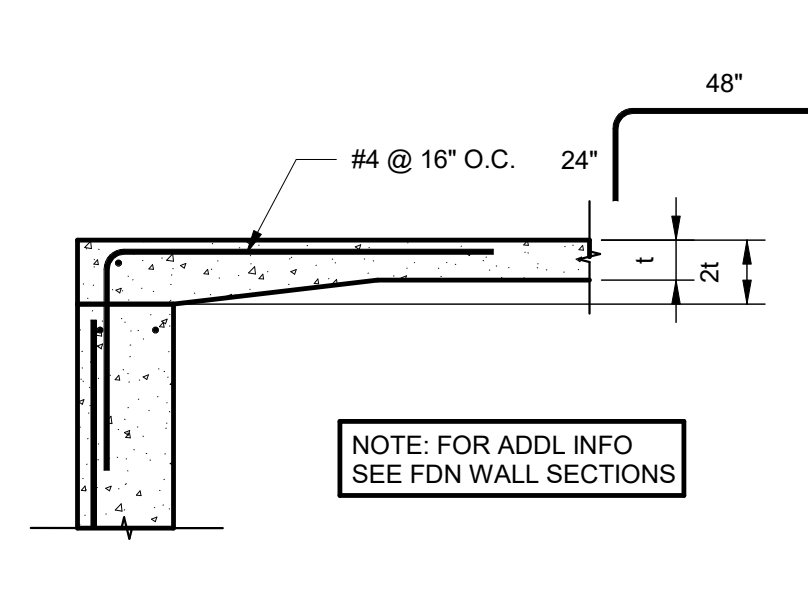
TYPICAL SLAB DETAIL AT DOOR
N.T.S.
t = SLAB THICKNESS




TYP STEP FOOTING DETAIL
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t = FOOTING THICKNESS

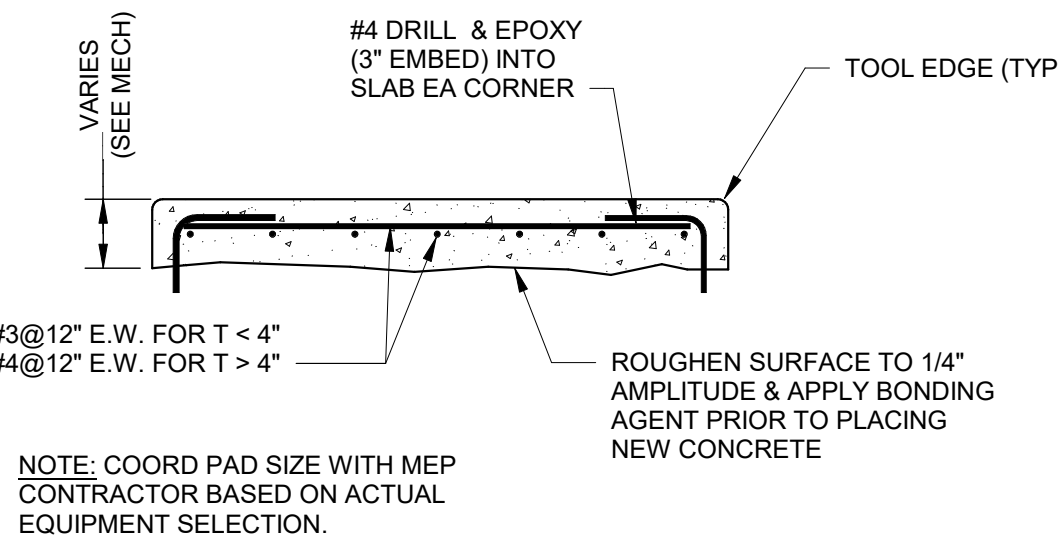


TYP EQUIPMENT HOUSEKEEPING PAD DETAIL
N.T.S.

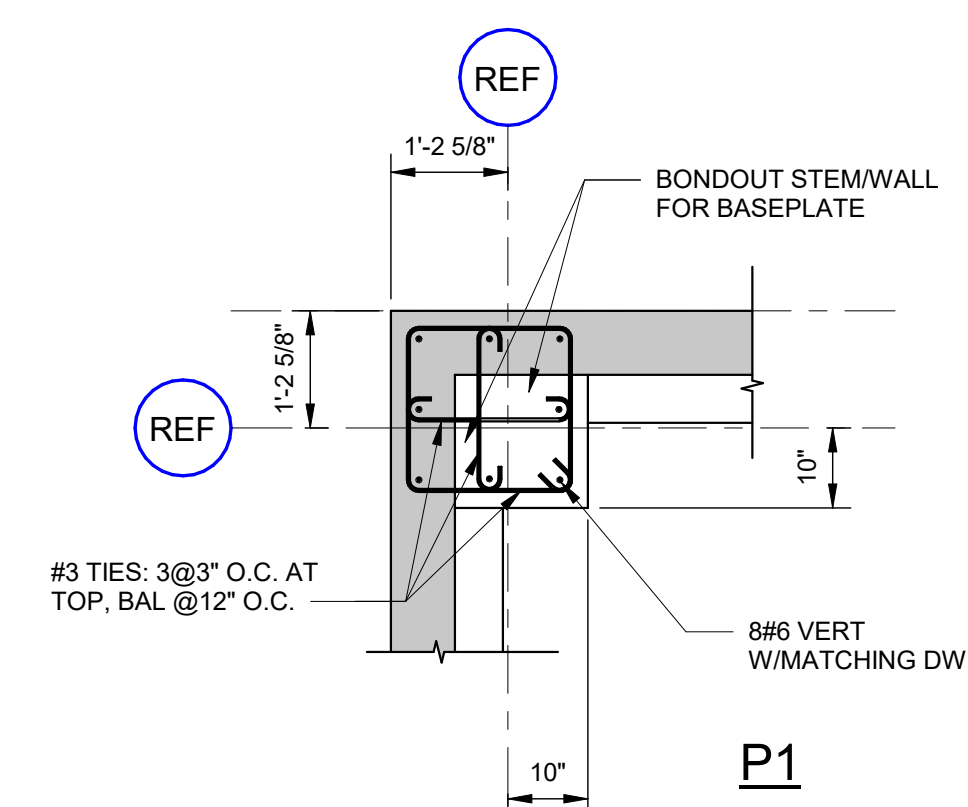


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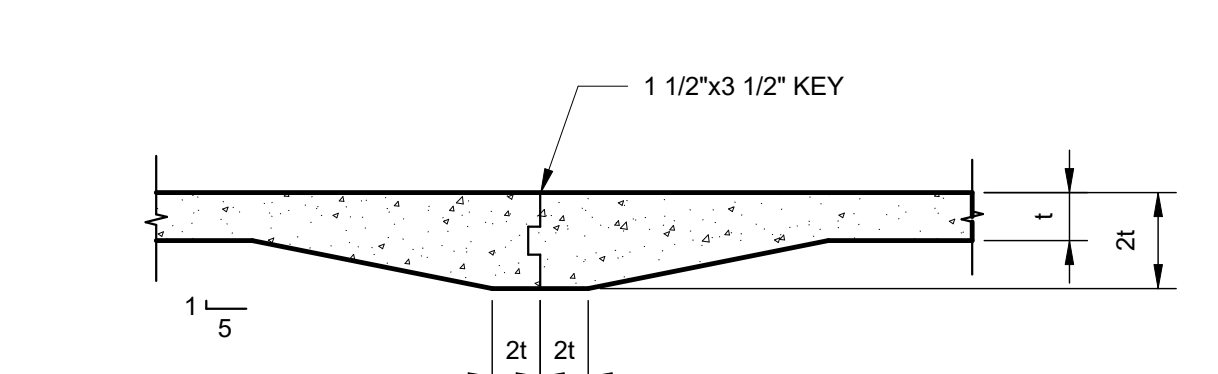
P2/P2A

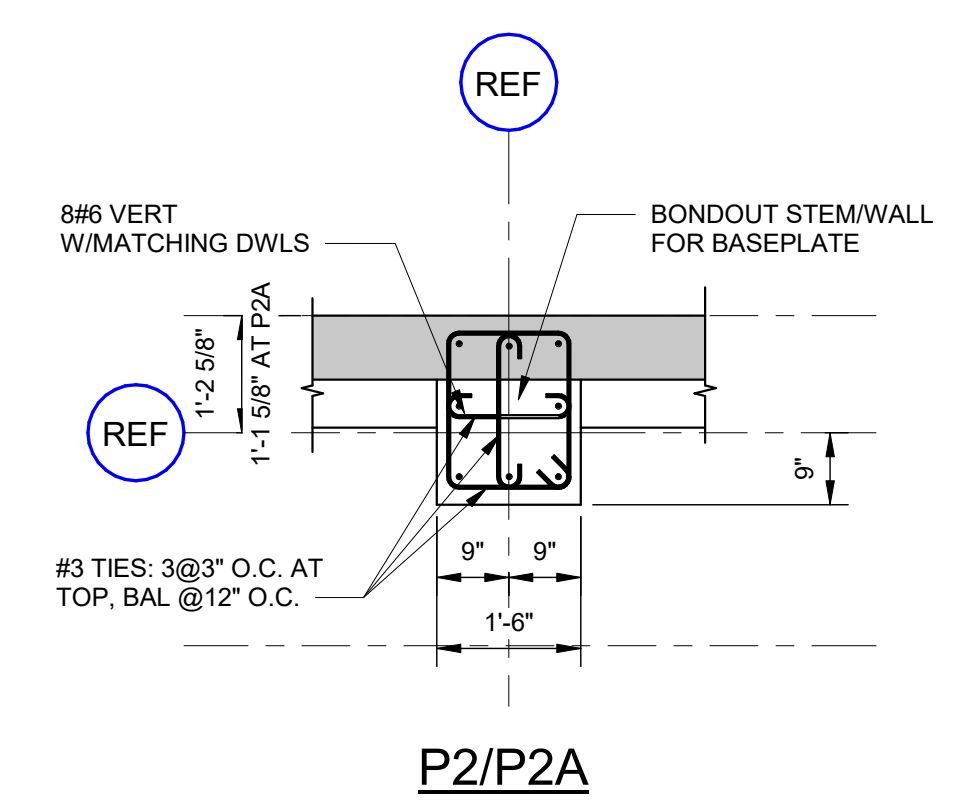


TYP CONTRACTION JOINT IN WALL
N.T.S.

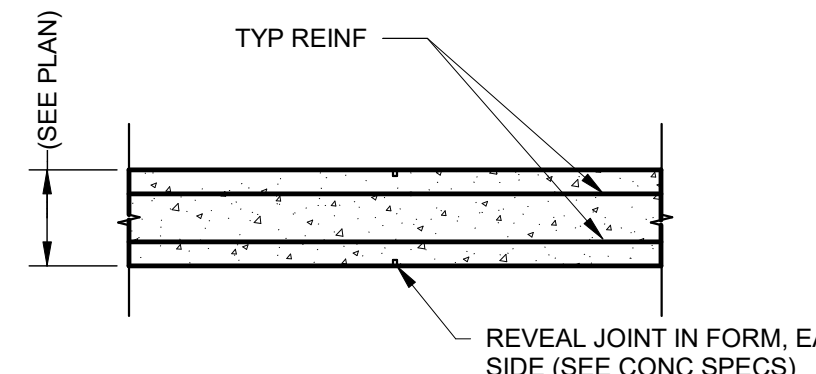


SLAB ON GRADE CONTRACTION JOINT DETAIL U.N.O.
N.T.S.

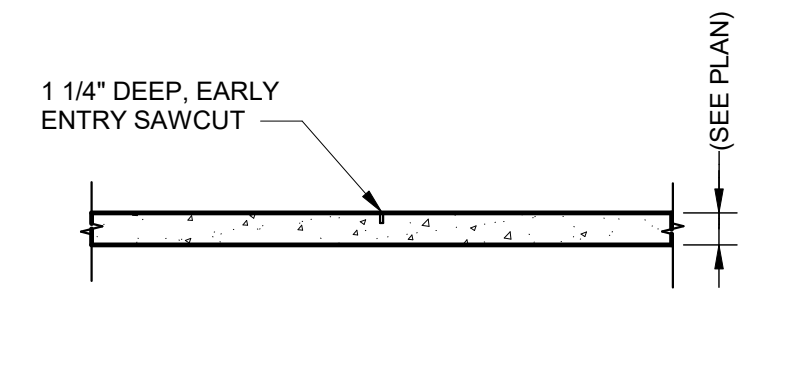


TYP SLAB ON GRADE CONST JOINT DETAIL
N.T.S.
t = SLAB THICKNESS

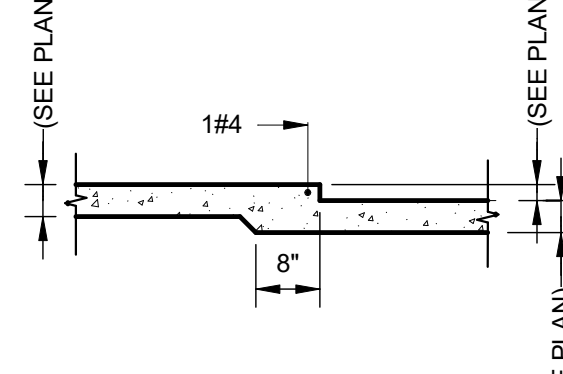


TYP SLAB ON GRADE DEPRESSION DETAIL
N.T.S.

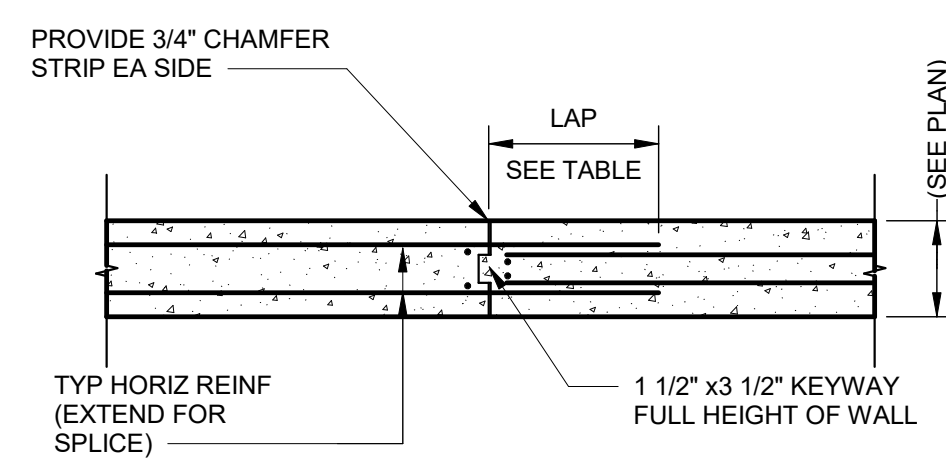

TYP CONSTRUCTION JOINT IN WALL
N.T.S.

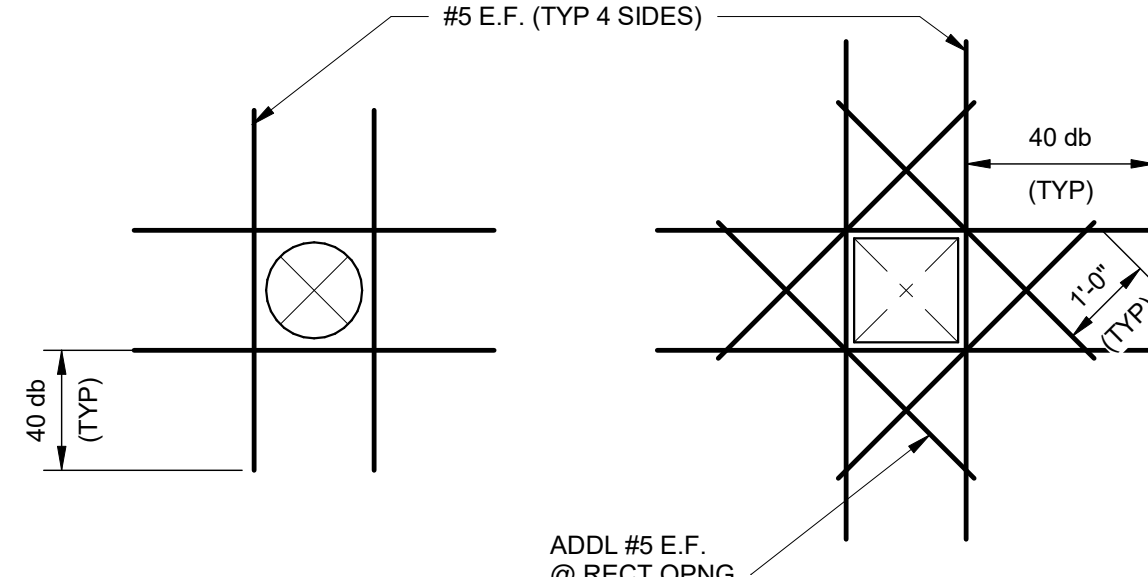


TYP OPENING IN WALL OR SLAB DETAIL
N.T.S.

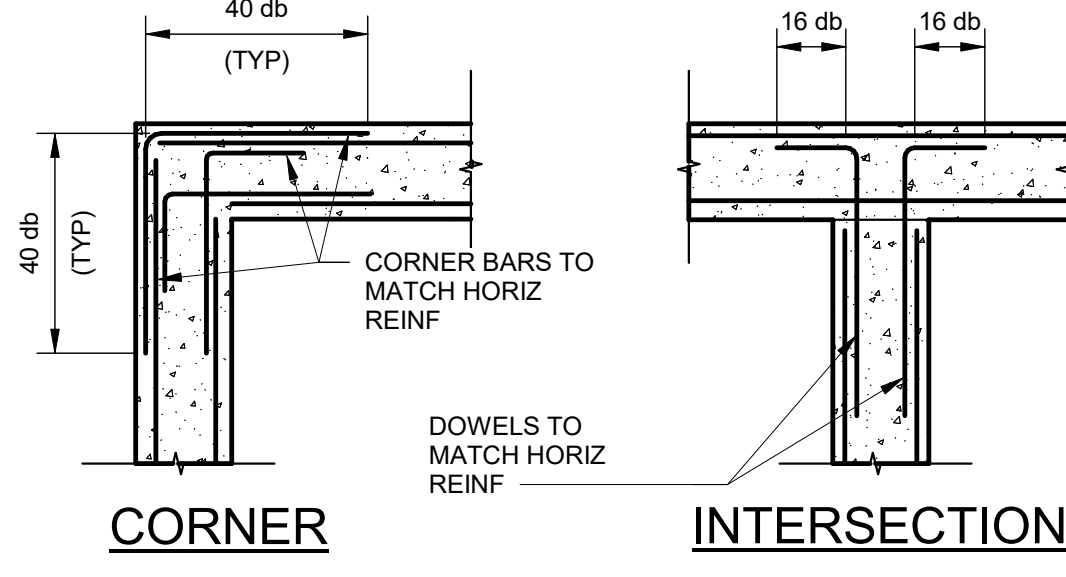


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INTERSECTION


BAR SIZE	LAP LENGTH	
	3,500 PSI	5,000 PSI
#3	30"	24"
#4	36"	32"
#5	48"	42"
#6	56"	48"
#7	81"	72"
#8	93"	80"

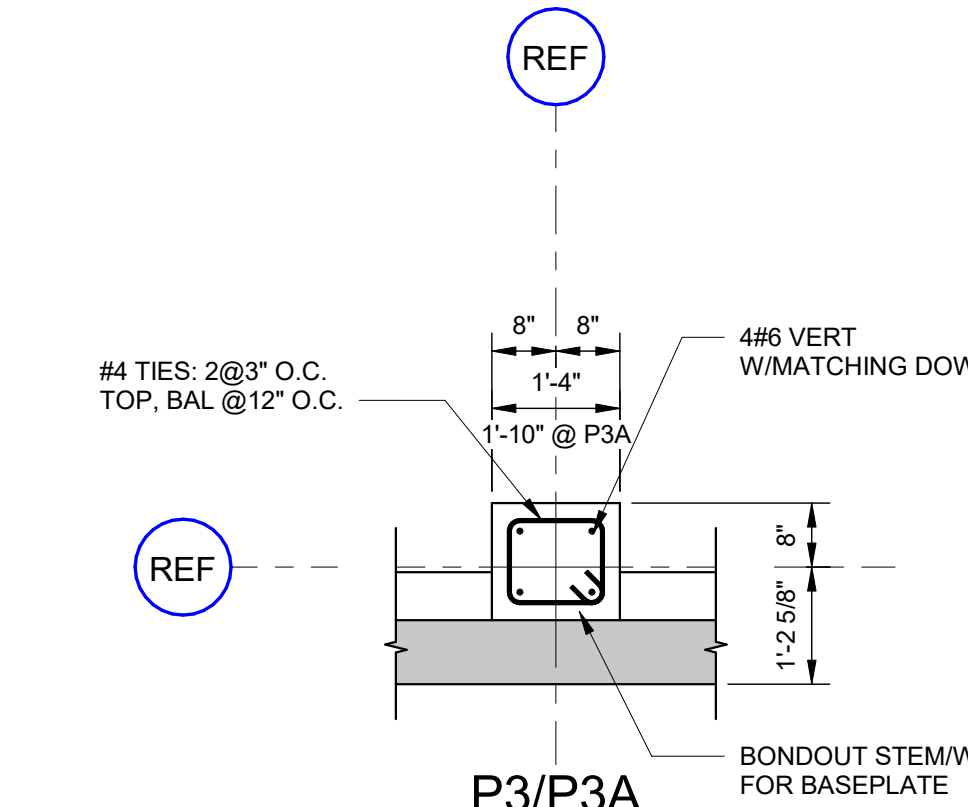

P3/P3A

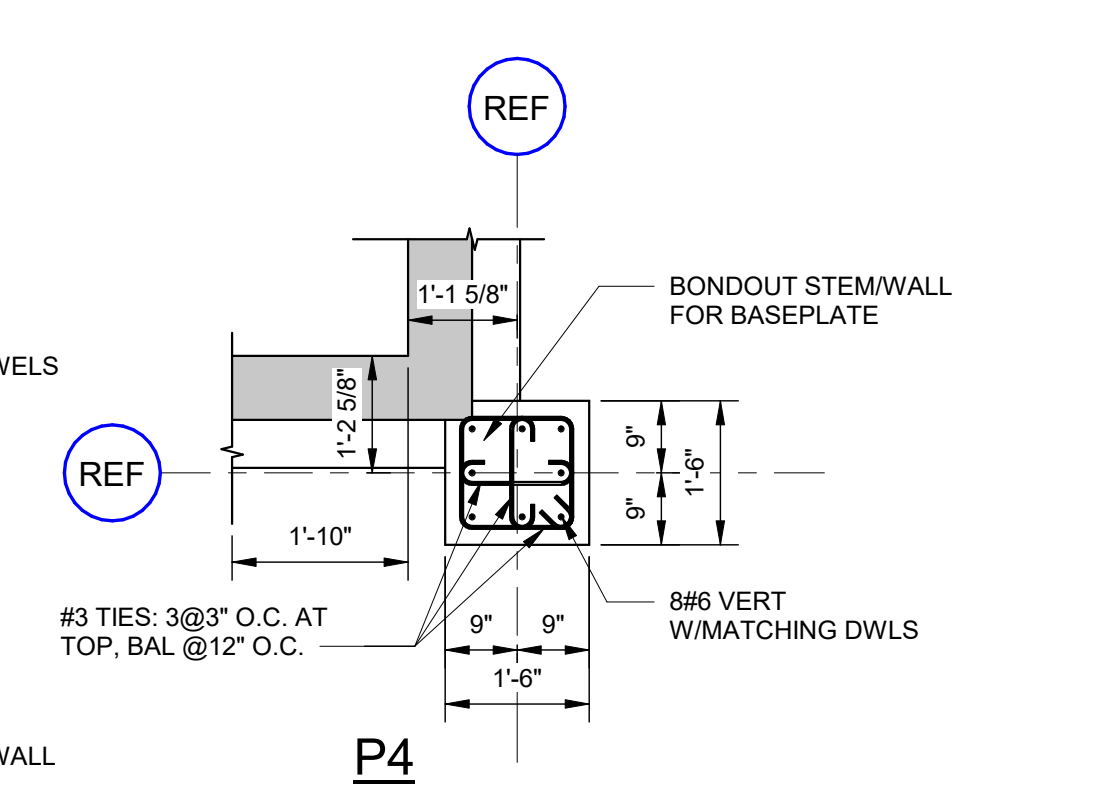

P4

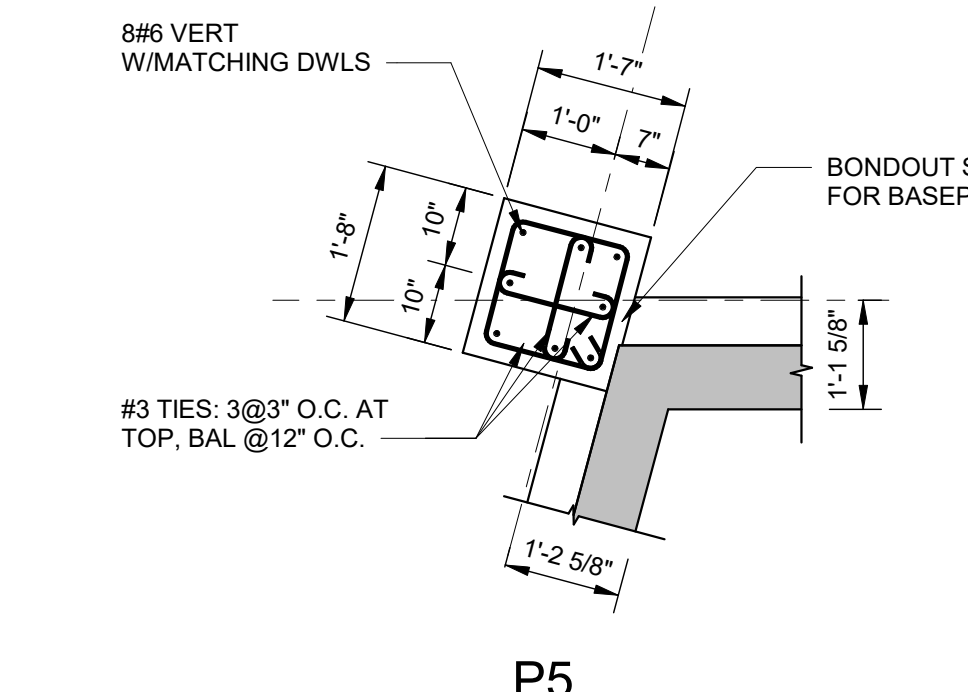


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PIER DETAILS


1/2" = 1'-0"

NOTES:


1. WALL REINF NOT SHOWN FOR CLARITY. U.N.O.
2. INDICATES FDN WALL SHELF. SEE PLANS AND WALL SECTIONS FOR ADDL INFO.
3. OMIT TOP CROSS TIES AT SHEAR KEYS. PERIMETER TIES TO REMAIN.

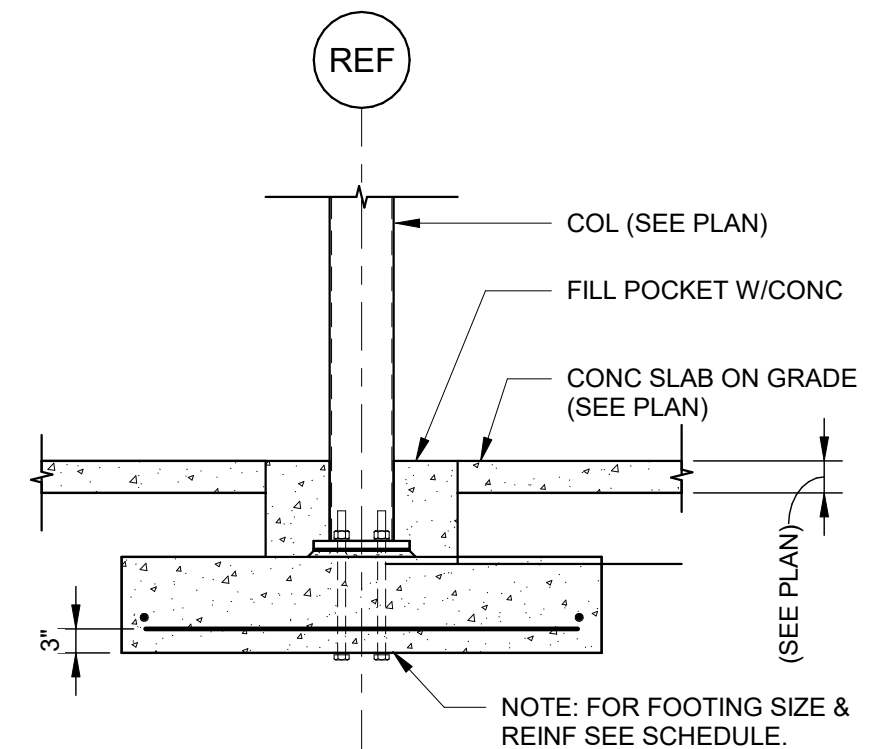


TYP INTERIOR FOOTING DETAIL U.N.O.
N.T.S.

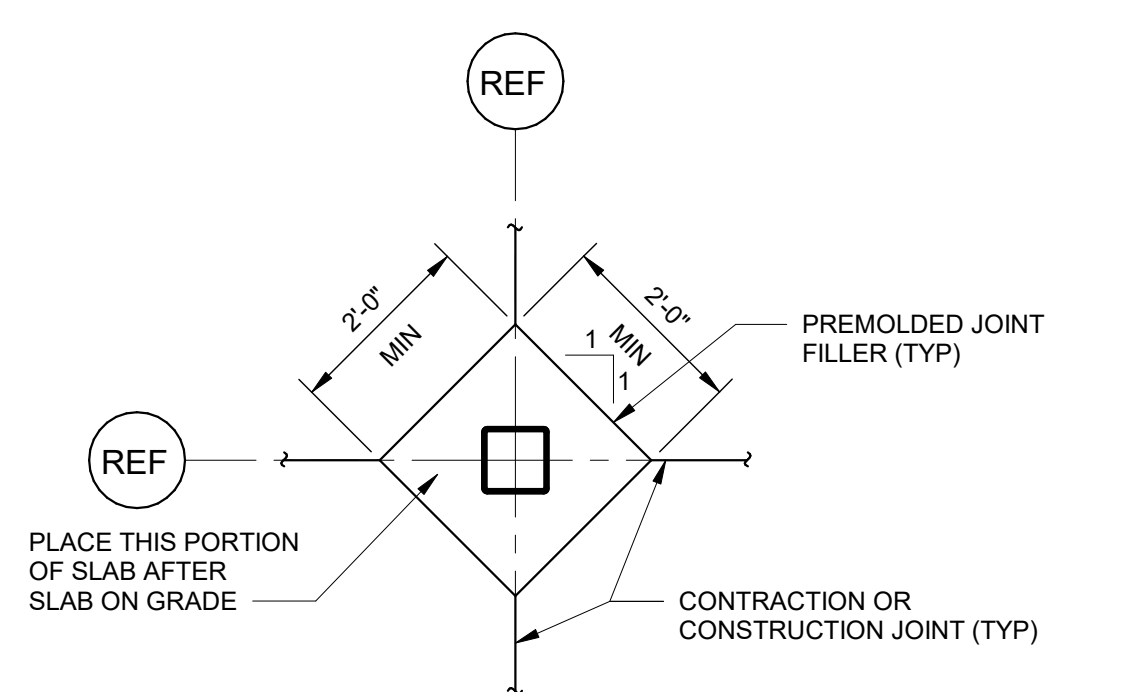

TYP INT COLUMN ISOLATION JOINT DETAIL
N.T.S.

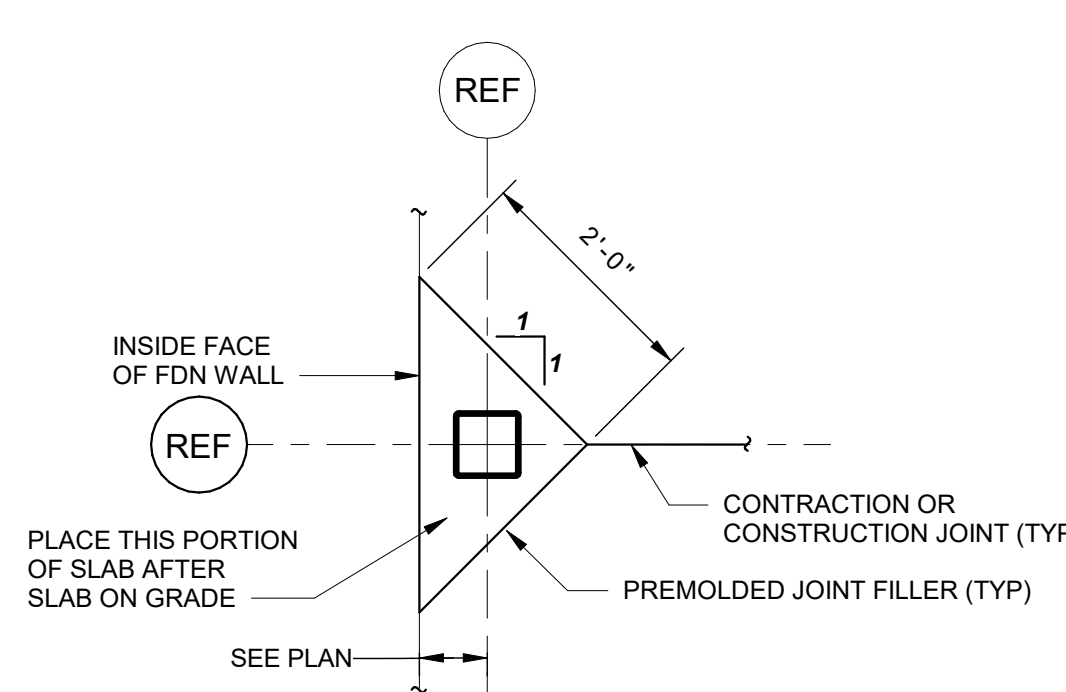


TYP EXT COLUMN ISOLATION JOINT DETAIL
N.T.S.

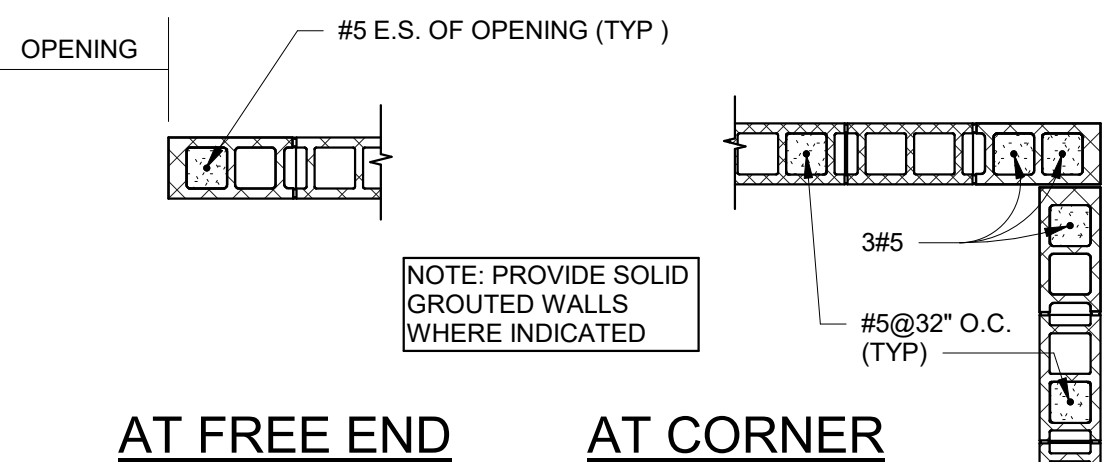


TYP PLAN DETAILS AT CMU WALLS
N.T.S.

- NOTES:
1. PROVIDE LADUR TIE HORIZ REINF @ 16" O.C. U.N.O.
 2. PROVIDE MATCHING CORNER & INTERSECTION DOWELS AT ALL BOND BEAMS.
 3. ALL REINFORCED CELLS ARE TO BE FULLY GROUTED.
 4. PROVIDE 30" MIN LAP SPLICES.
 5. PROVIDE LINTELS ABOVE ALL OPENINGS PER THE SCHEDULE. EXTEND BEYOND EDGE OF OPENING.

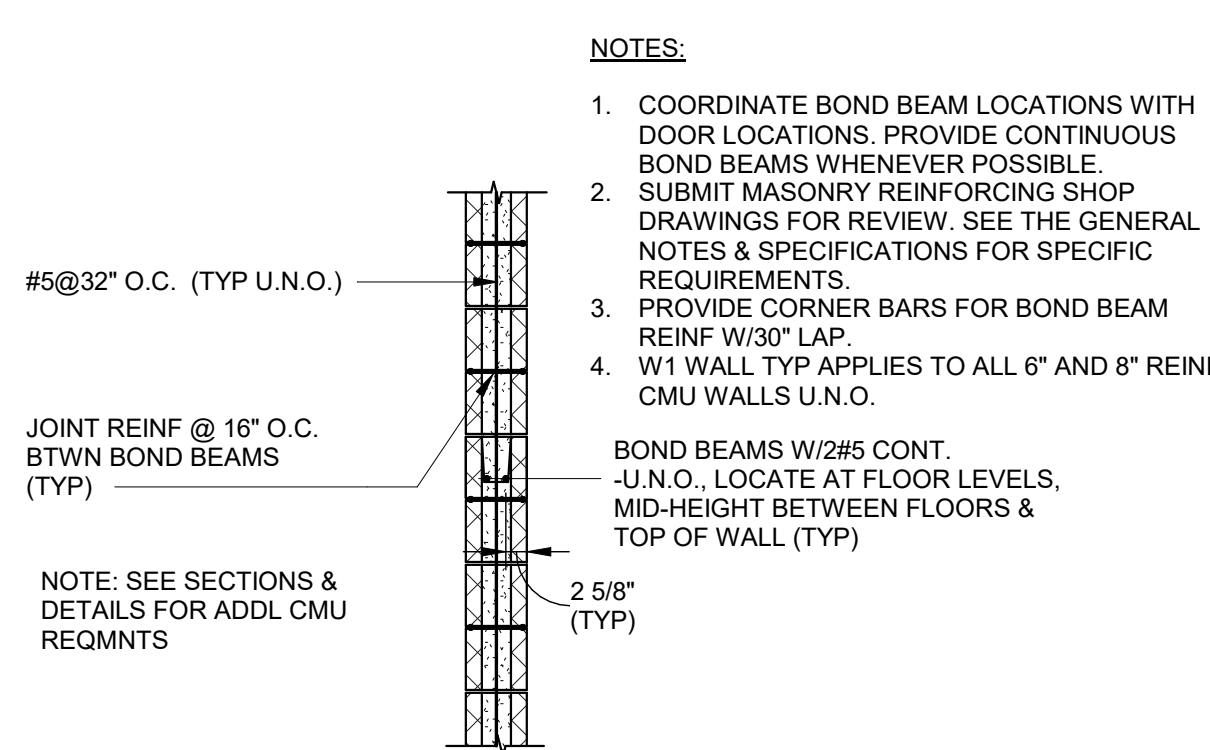


WALL TYPE W1 SECTION (TYP. U.N.O.)
N.T.S.

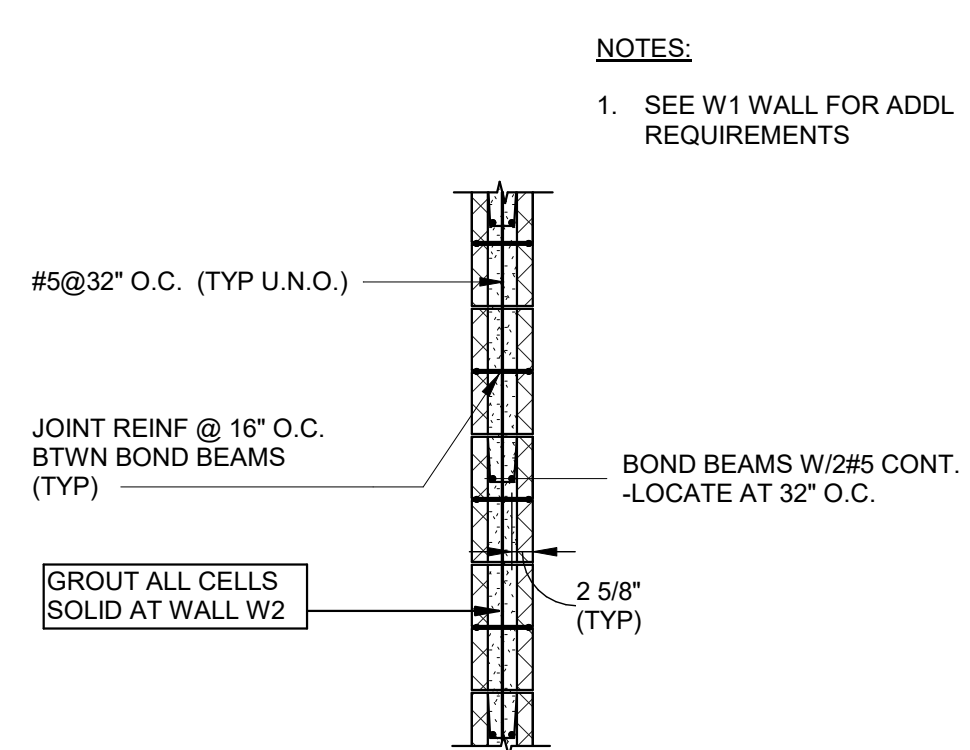

WALL TYPE W2 SECTION
N.T.S.

CMU LINTEL SCHEDULE (U.N.O.)				
CLEAR SPAN	WIDTH	DEPTH	REINF	BEARING LENGTH AT ENDS
< 3'-6"	8"	8"	2#5 CONT	8"
3'-6" - 6'-0"	8"	8"	2#5 CONT	16"
6'-0" - 12'-0"	8"	16"	2#5 CONT	16"

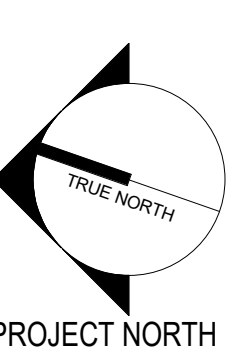

Revisions:	Revision Description	Date:

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Office of
Construction
and Facilities
Management
VA U.S. Department
of Veterans Affairs

Drawing Title
TYPICAL FOUNDATION DETAILS
Approved:
VA RI FACILITIES MANAGEMENT
SERVICE

Phase
CONSTRUCTION
DOCUMENTS
FULLY SPRINKLERED

Project Title
NEW MENTAL HEALTH BUILDING -
PHASE 2
Location
830 CHALKSTONE AVE PROVIDENCE, RI 02908
Issue Date
FEB 04 2022
Checked
CGW
Drawn
ATS

Project Number
650-347
Building Number
39
Drawing Number
SB-300

A

B

C

D

E

F

A

B


C

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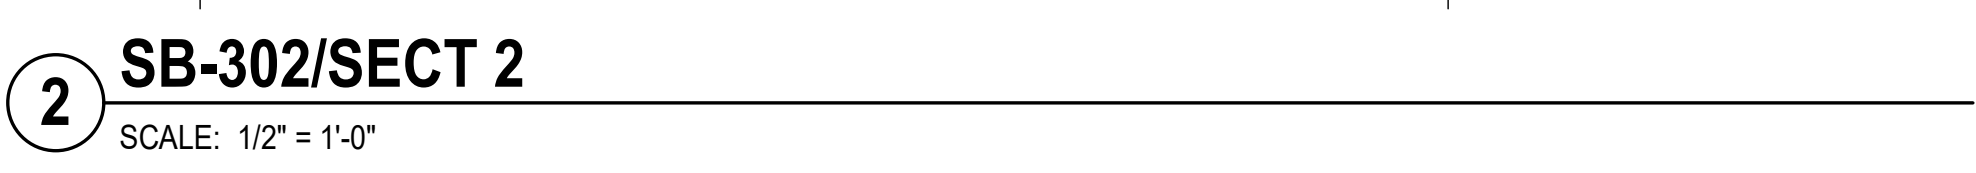
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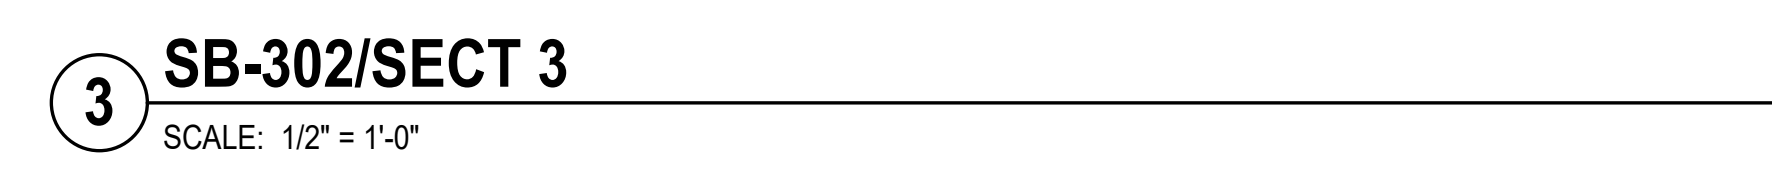
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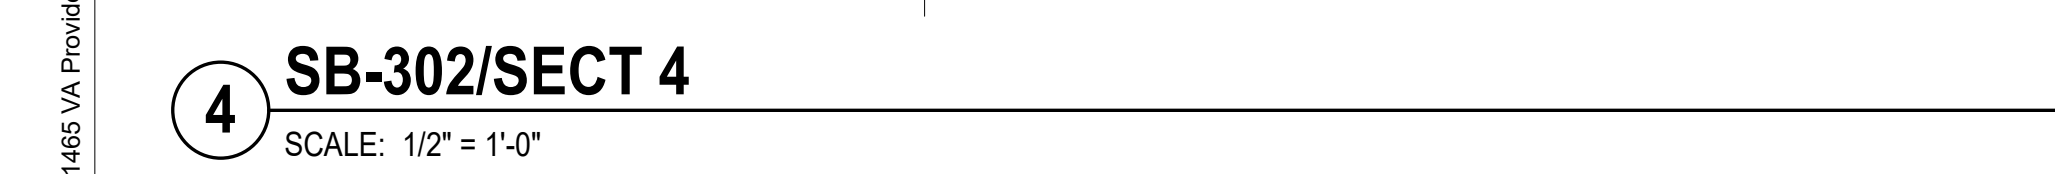
2 SB-302/SECT 2
SCALE: 1/2" = 1'-0"




3 SB-302/SECT 3
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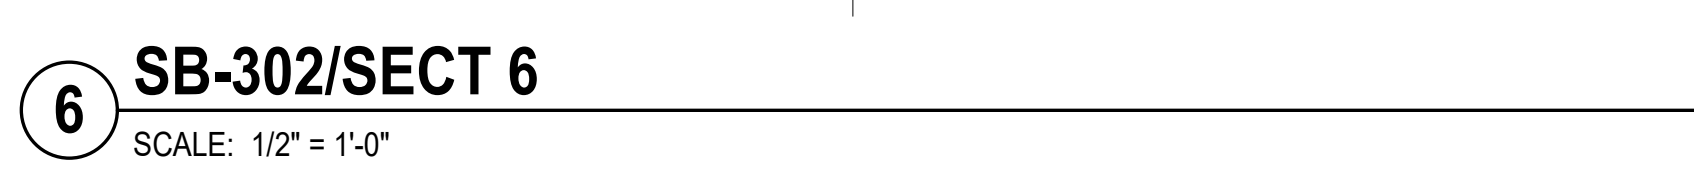
4 SB-302/SECT 4
SCALE: 1/2" = 1'-0"

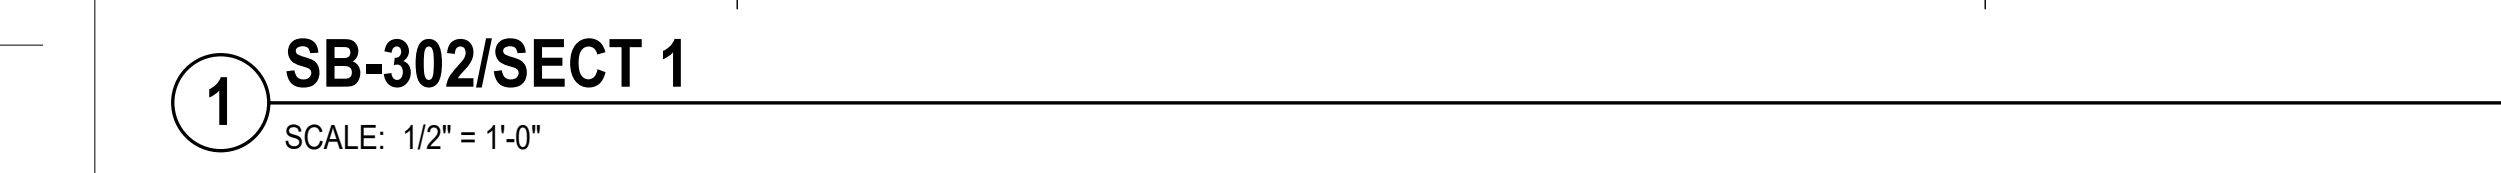


5 SB-302/SECT 5
SCALE: 1/2" = 1'-0"



6 SB-302/SECT 6
SCALE: 1/2" = 1'-0"

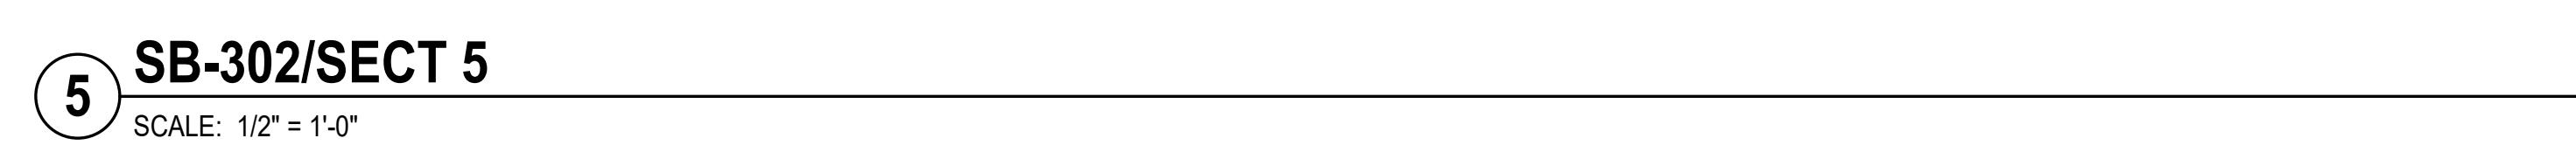

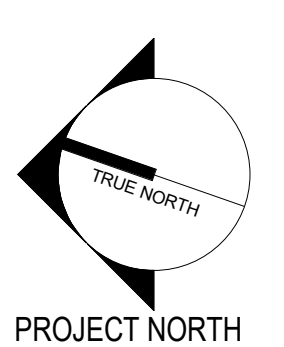


PROJECT NORTH

Revisions:	Revision Description	Date:

CONSULTANT
Thornton Tomasetti

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Office of Construction and Facilities Management
VA U.S. Department of Veterans Affairs

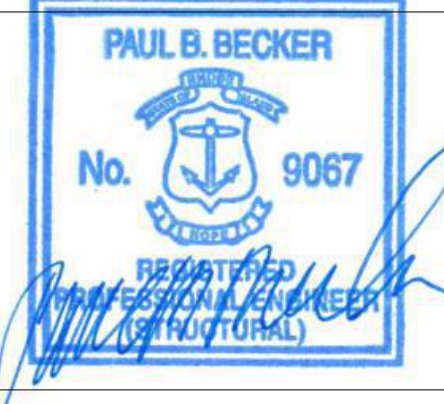
Drawing Title
FOUNDATION SECTIONS & DETAILS
Approved: VA RI FACILITIES MANAGEMENT SERVICE


Phase
CONSTRUCTION DOCUMENTS
FULLY SPRINKLERED


Project Title
NEW MENTAL HEALTH BUILDING - PHASE 2
Location
830 CHALKSTONE AVE PROVIDENCE, RI 02908
Issue Date
FEB 04 2022
Checked
CGW
Drawn
ATS

Project Number
650-347
Building Number
39
Drawing Number
SB-302

VA FORM 08 - 6231 1 2 3 4 5 6 7 8 9 10

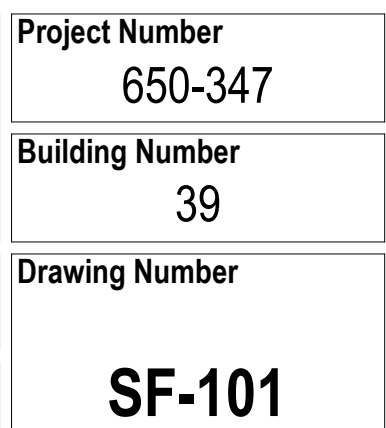

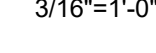

- 

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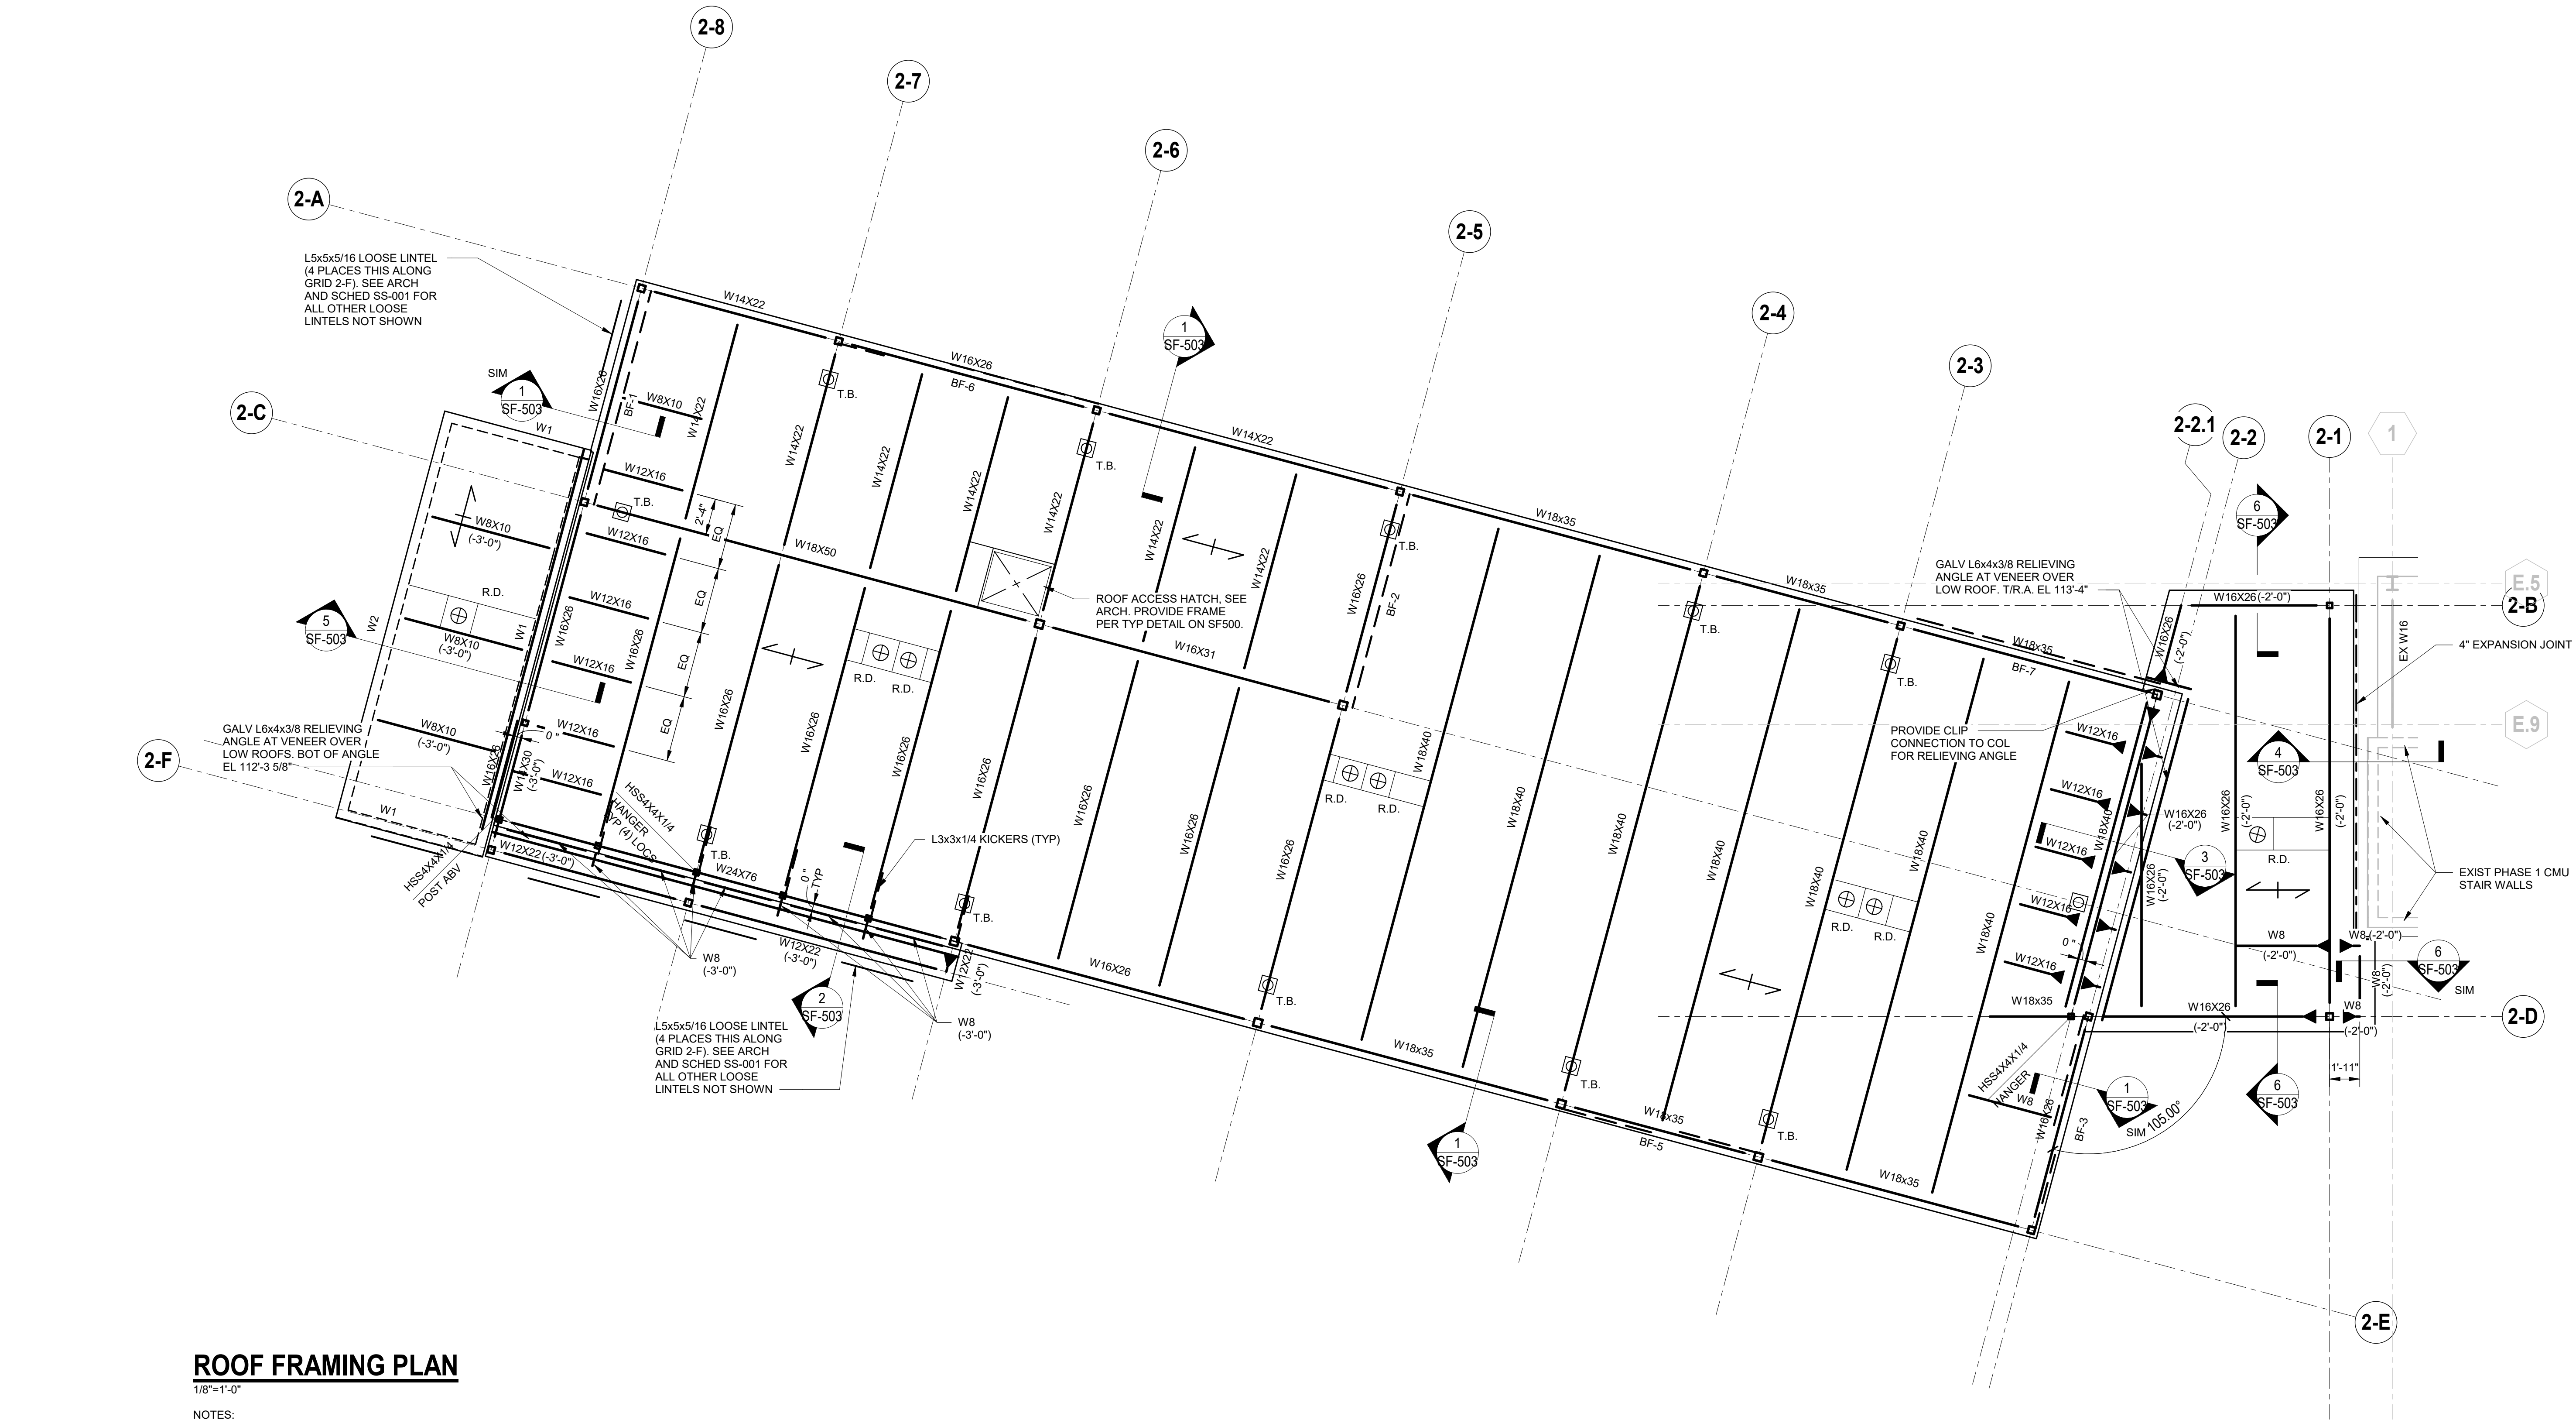
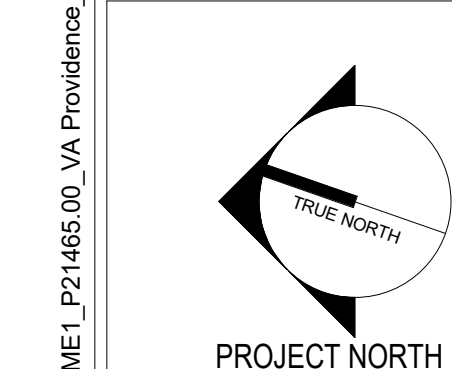
PAUL B. BECKER

No. 9067

REGISTERED
PROFESSIONAL ENGINEER
(STRUCTURAL)

VA

SF-102



ROOF FRAMING PLAN

1/8"=1'-0"

NOTES:

1. INDICATES SPAN DIRECTION OF 1.5820 ROOF DECK (3 SPAN MIN).
2. TOP OF STEEL UNDERSIDE OF DECK EL 113'-8" U.N.O. BY (X-X'X').
3. BF-1, BF-2, ETC INDICATES BRACE FRAME. SEE BRACED FRAME ELEVATIONS DWG SF-401.
4. INDICATES MOMENT CONN. SEE TYP DETAIL DWG SF-500.
5. BEAMS/JOISTS TO BE PLACED AT EQUAL SPACES BETWEEN COLUMN LINES U.N.O.
6. W8 INDICATES W8X10 U.N.O.
7. R.D. INDICATES ROOF DRAIN (COORDINATE LOCATION W/ ARCH AND MEP). PROVIDE ANGLE FRAME AROUND PERIMETER OF DRAIN FOR SUPPORT OF METAL ROOF DECK PER TYPICAL DETAIL ON SF500.
8. T.B. INDICATES PROPOSED LOCATION OF ROOF FALL PROTECTION TIE-BACK. REFER TO ARCH FOR FINAL LOCATIONS AND ALL ADDL INFO.
9. W1, W2, ETC INDICATES CMU WALL TYPE AND REINFORCEMENT (SEE DETAILS SB-300)

CONSULTANT

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and Facilities
Management



U.S. Department
of Veterans Affairs

Drawing Title

ROOF FRAMING PLAN

Approved:

VA RI FACILITIES MANAGEMENT
SERVICE

Phase

CONSTRUCTION
DOCUMENTS

FULLY SPRINKLERED

Project Title

NEW MENTAL HEALTH BUILDING -
PHASE 2

Location

830 CHALKSTONE AVE PROVIDENCE, RI 02908

Issue Date
FEB 04 2022

Checked
EAR

Drawn
CGW

Project Number

650-347

Building Number

39

Drawing Number

SF-103

A

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A


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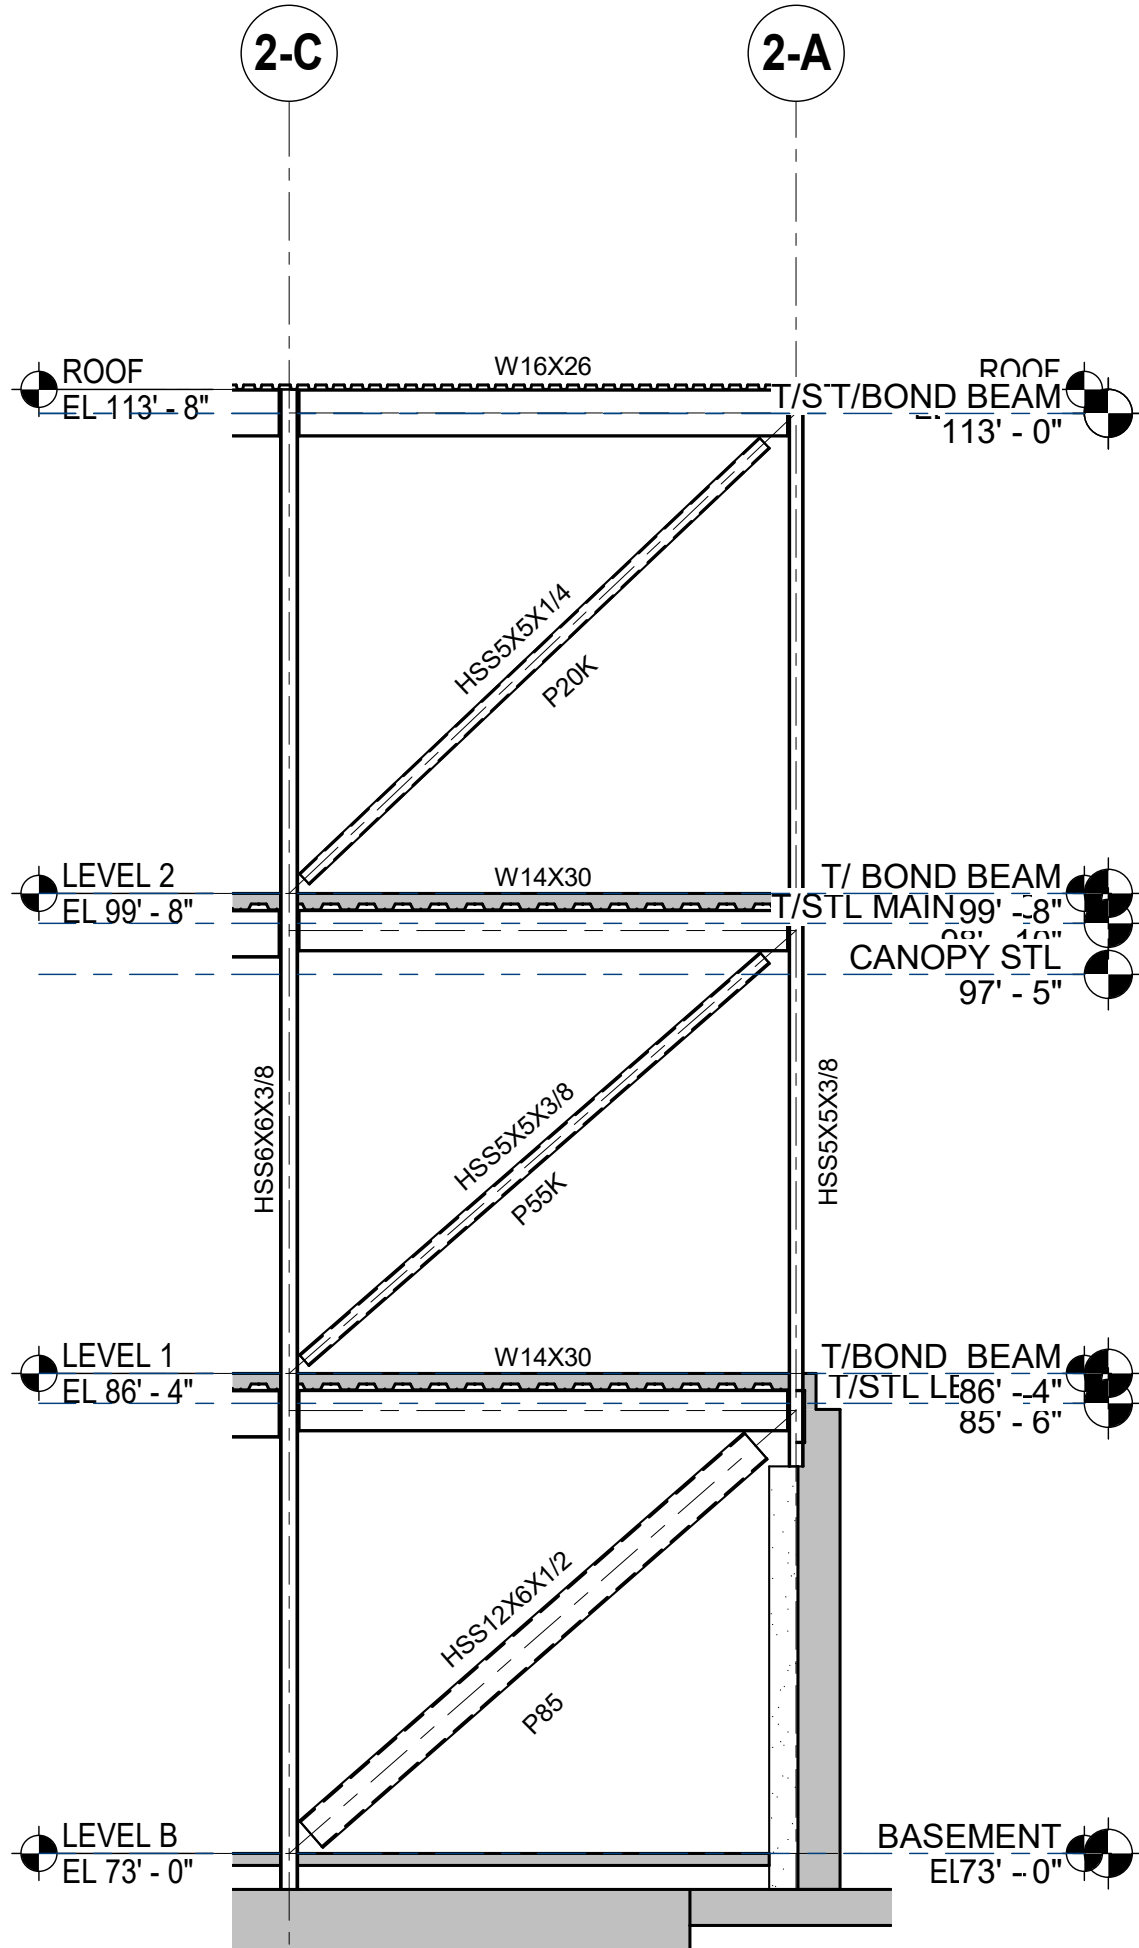
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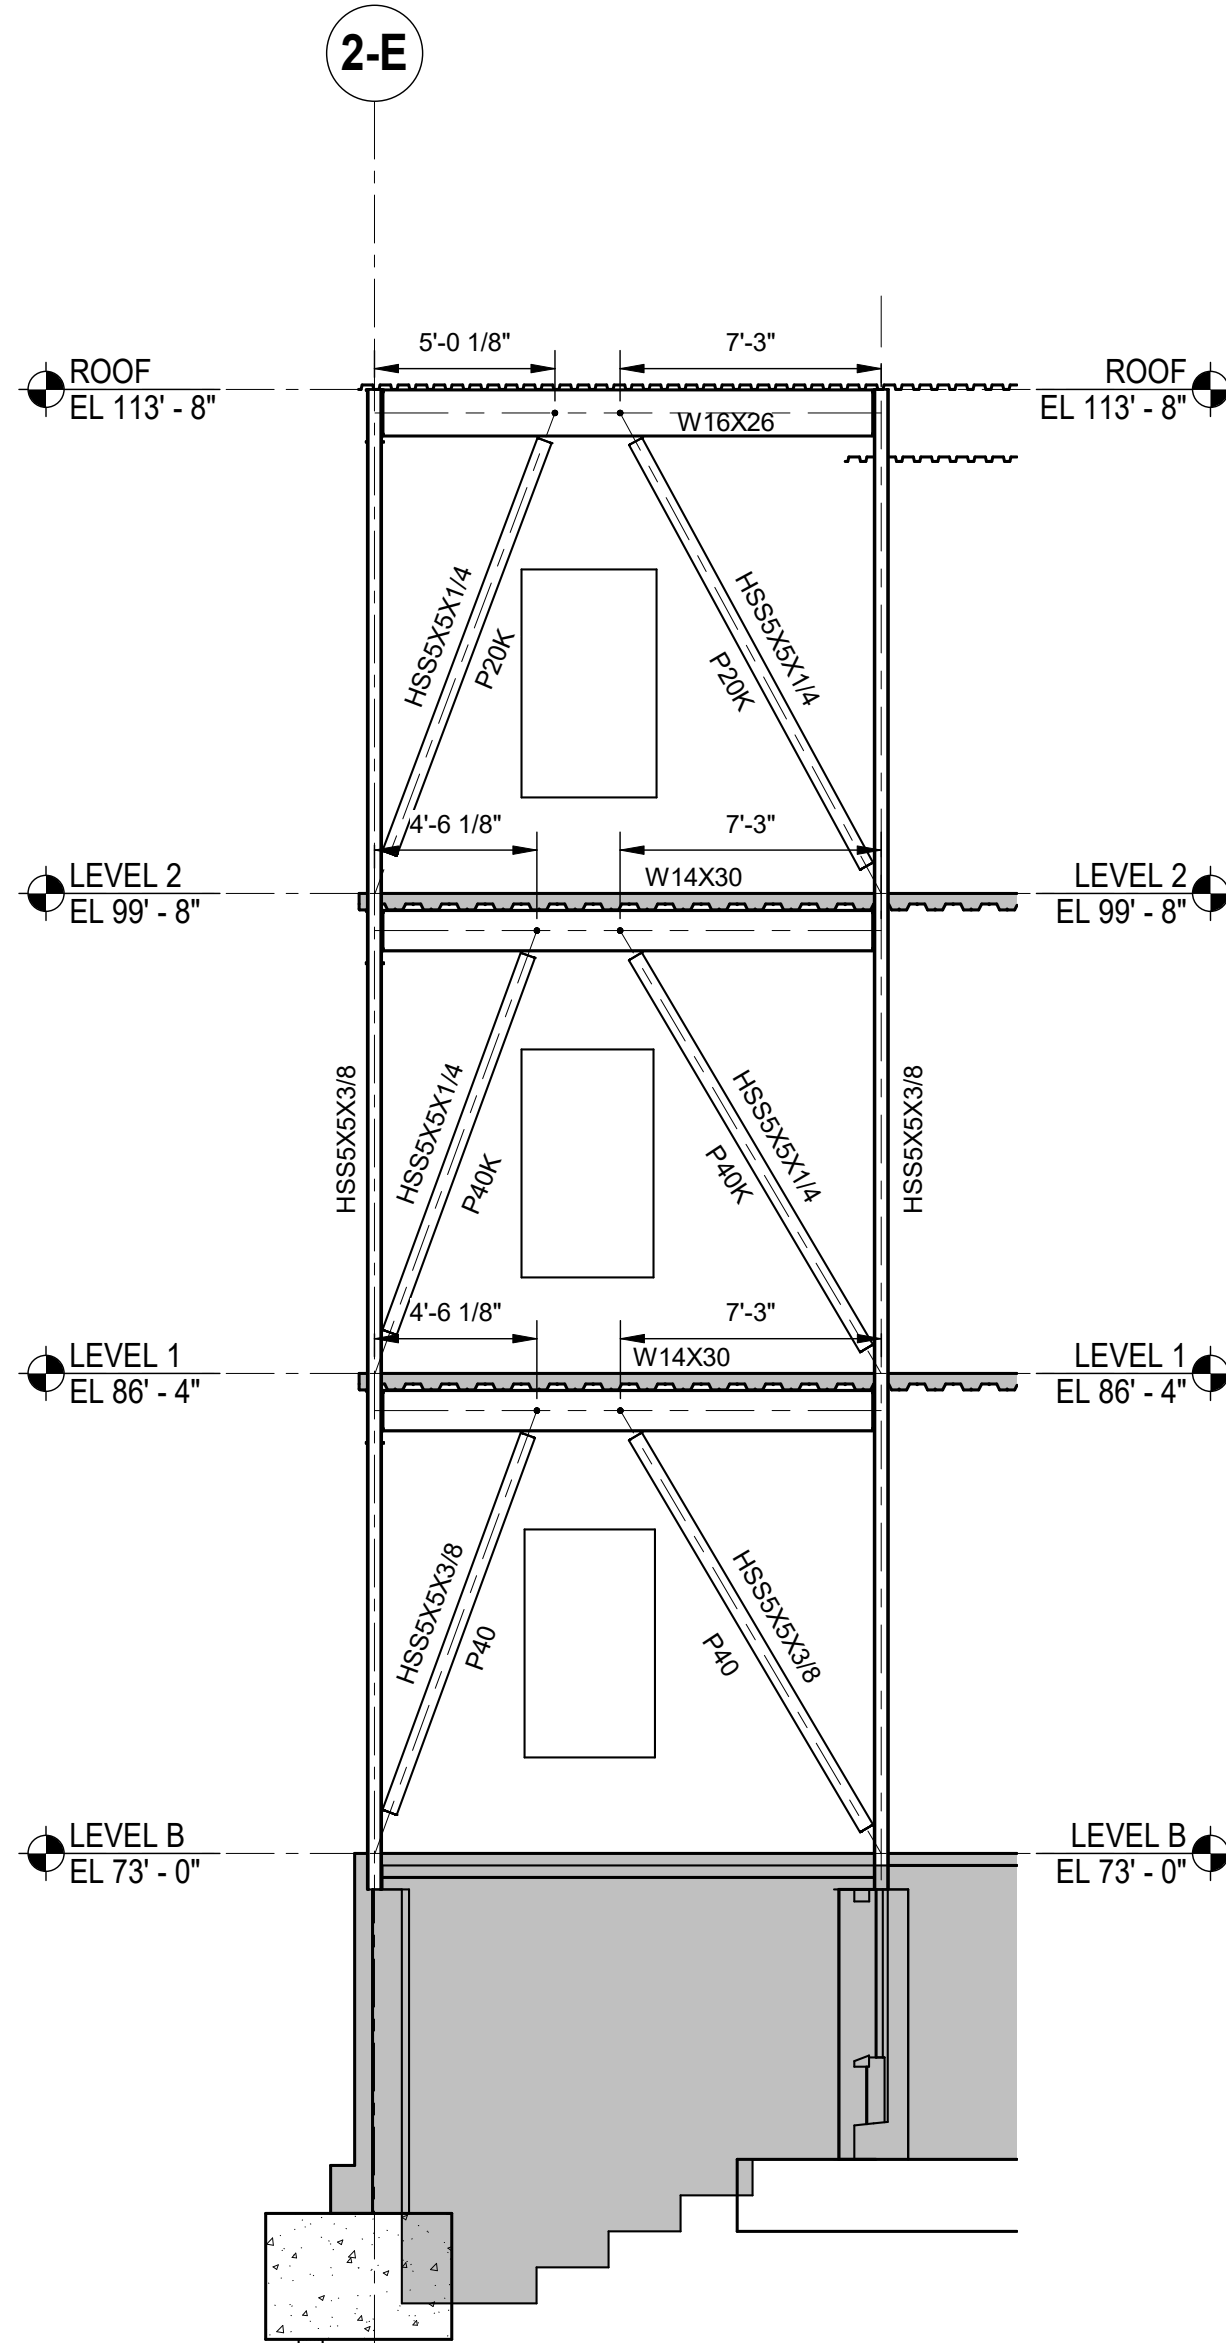
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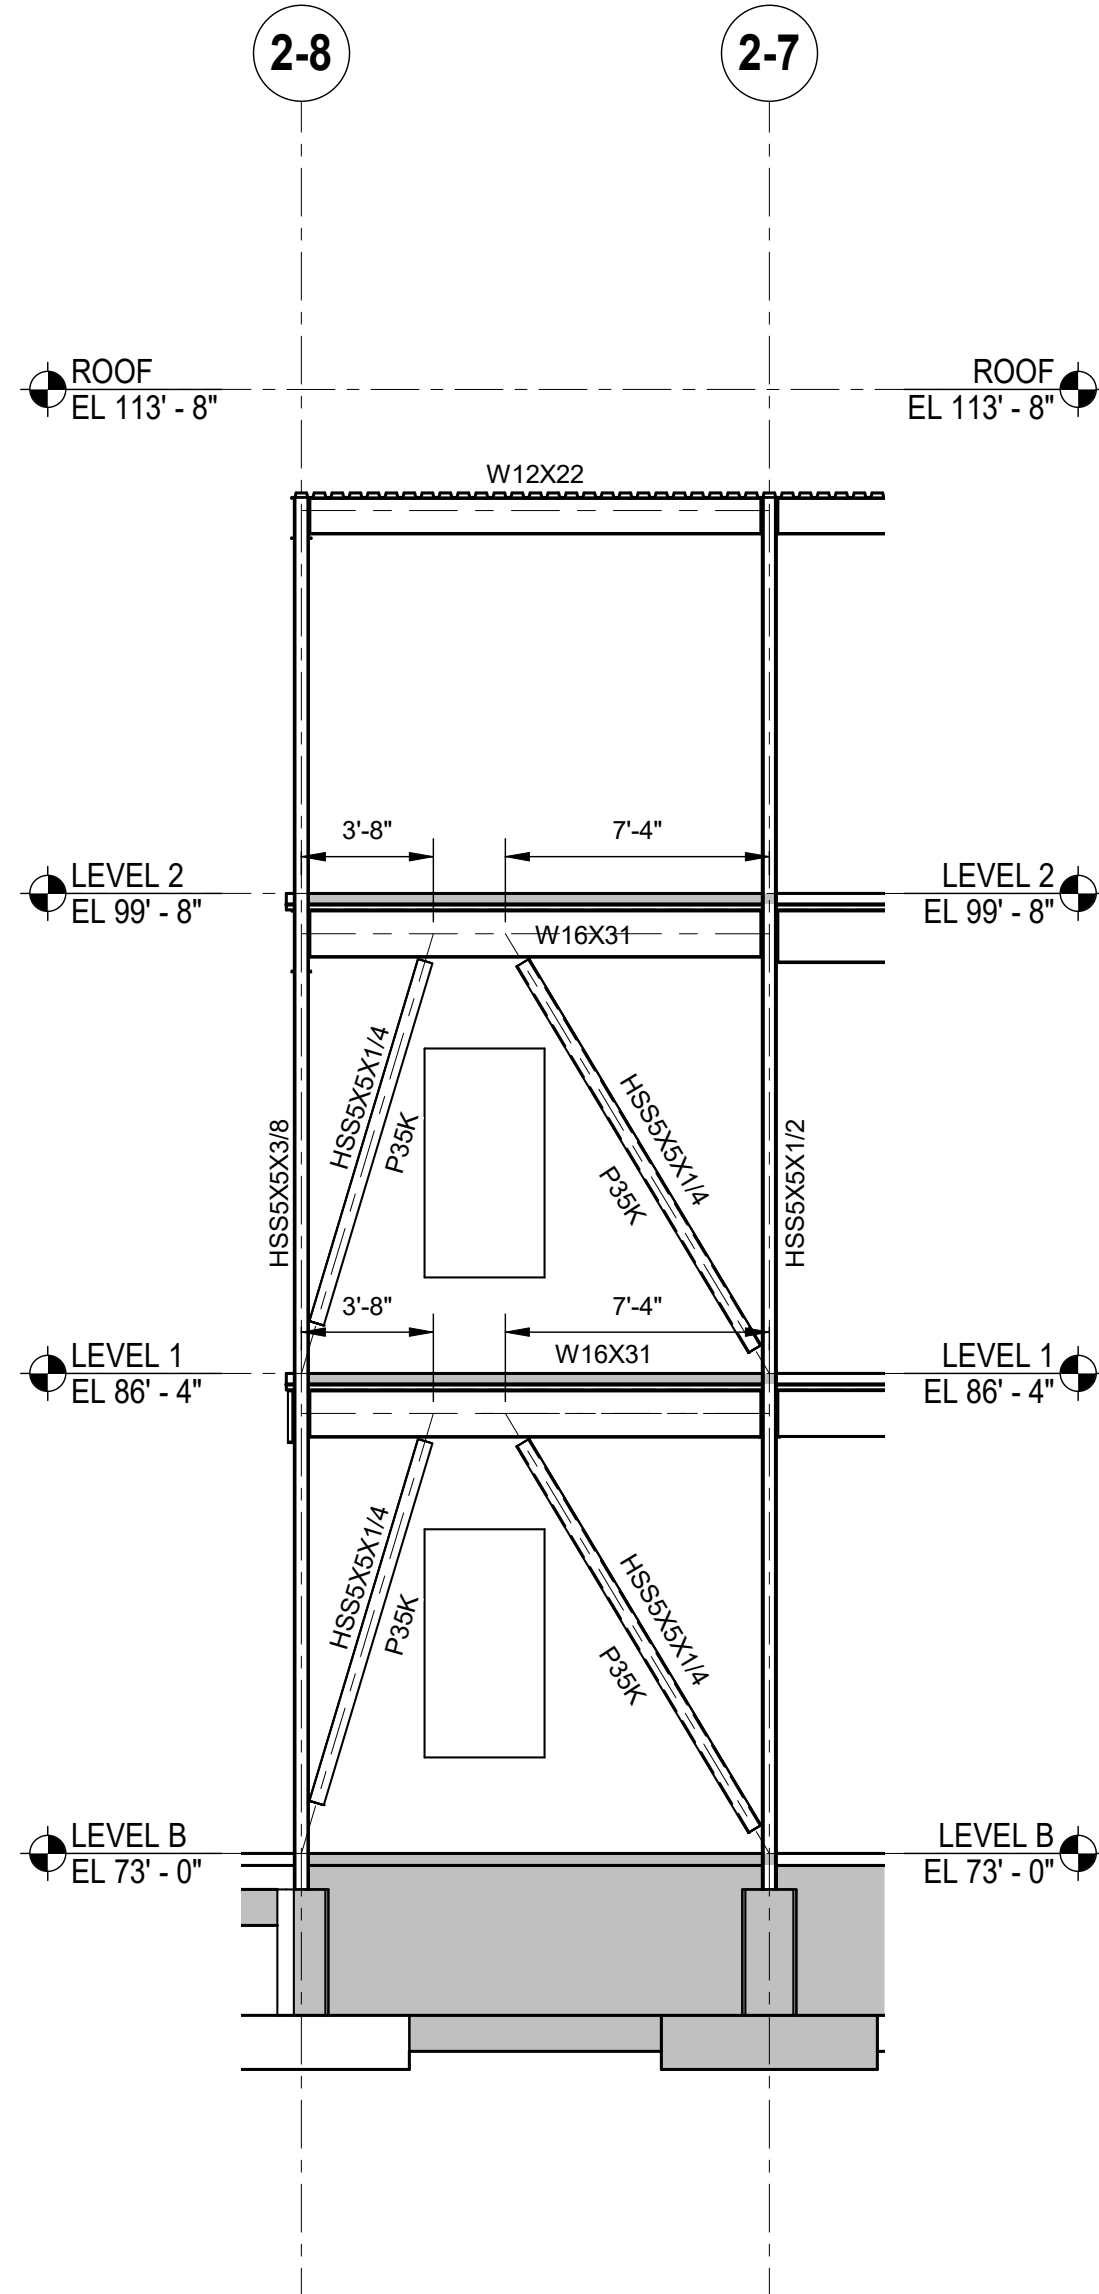
1 BF-1 AT 2-8 LINE
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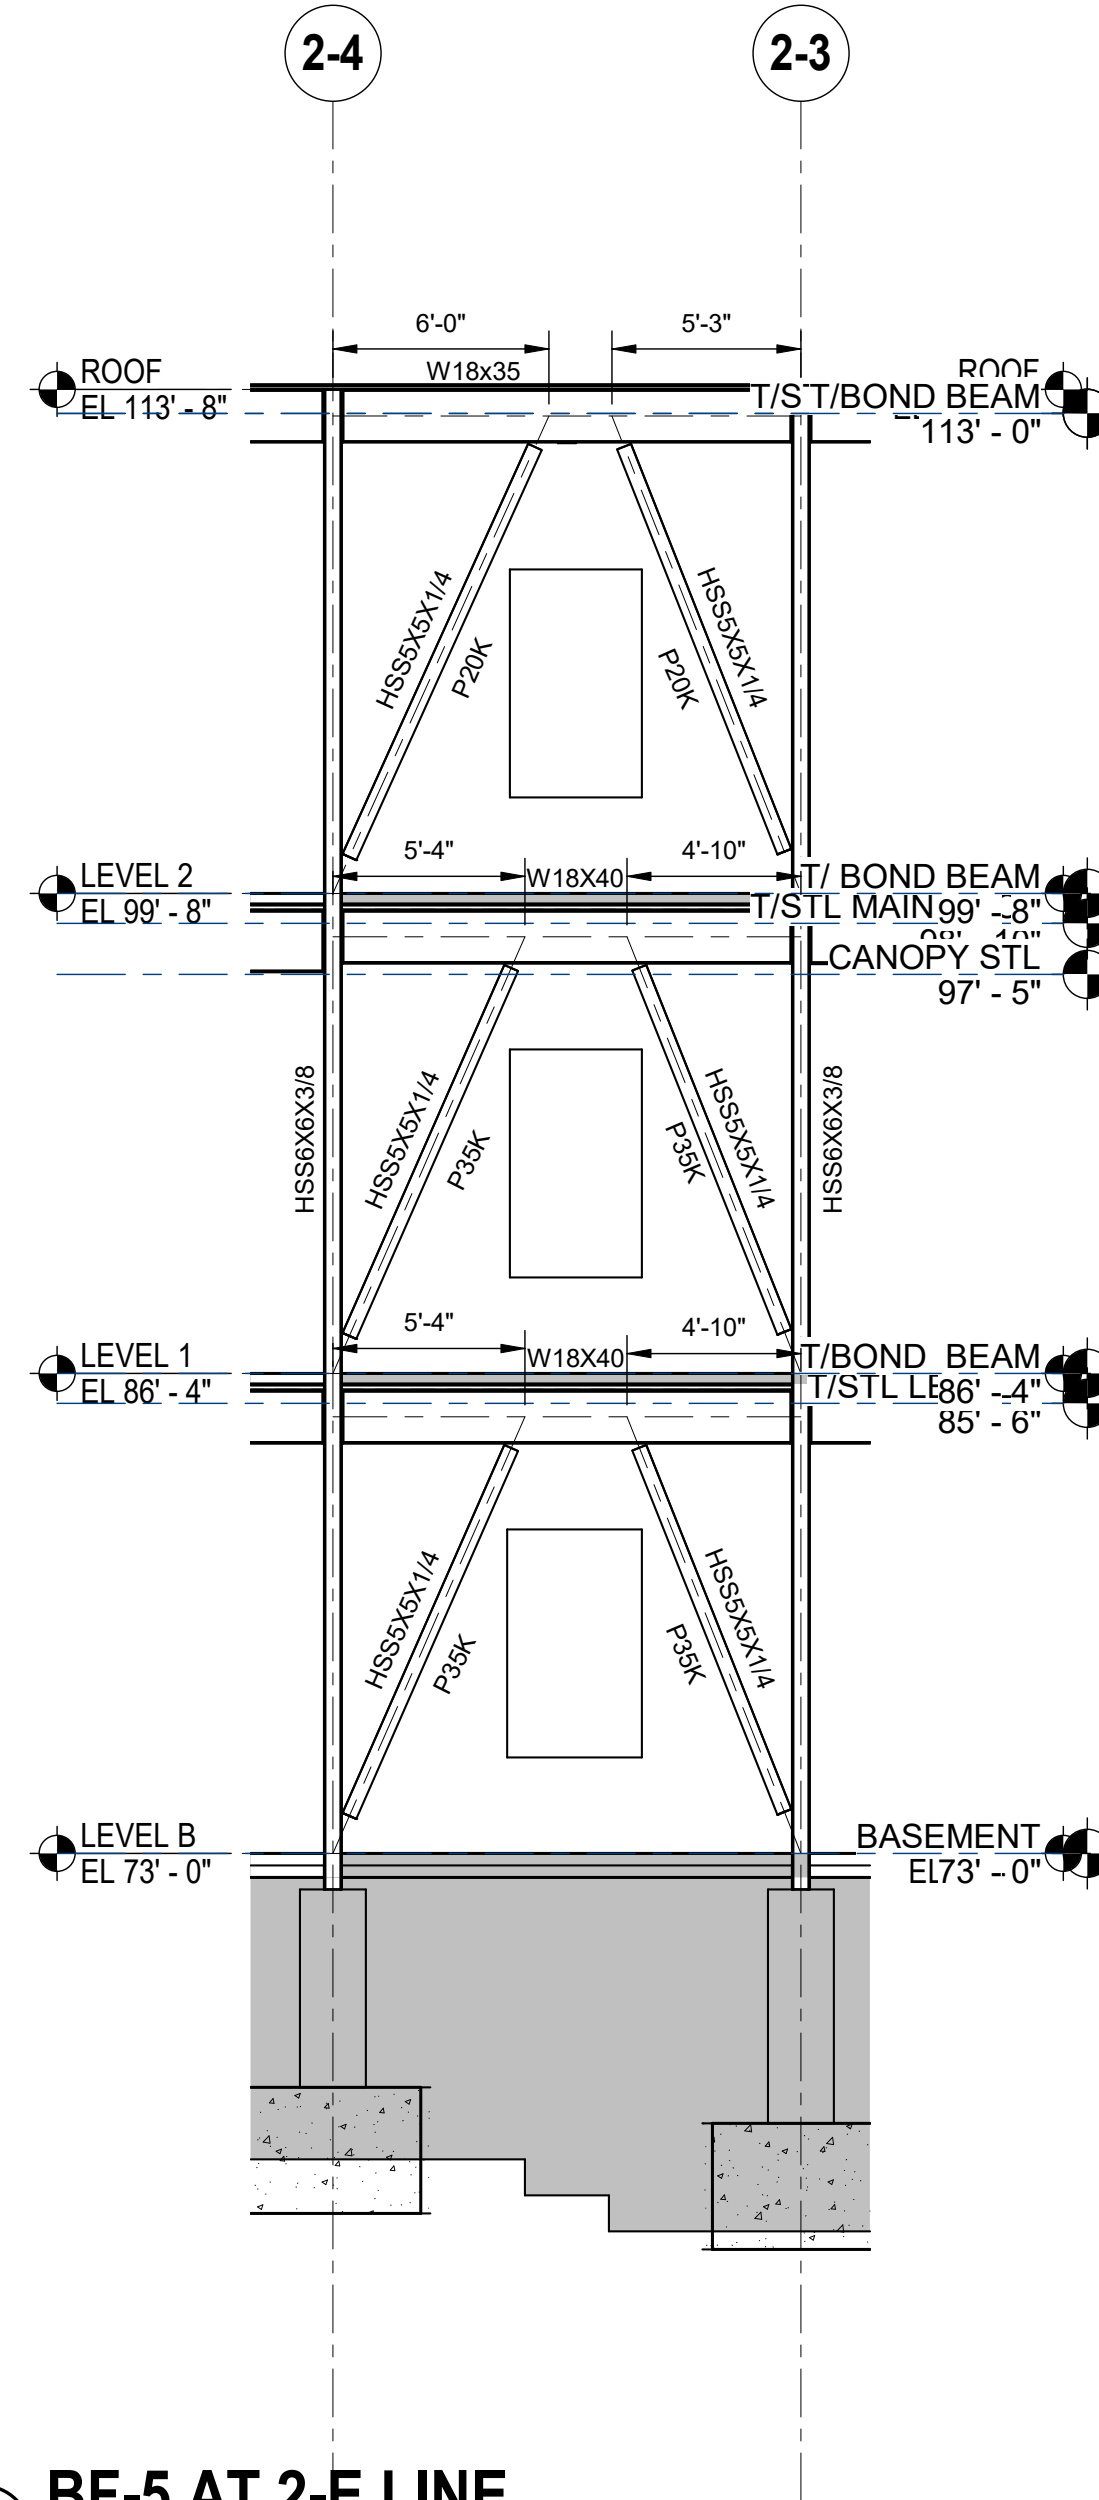
2 BF-2 AT 2-5 LINE
SCALE: 3/16" = 1'-0"




3 BF-3 AT 2-2 LINE
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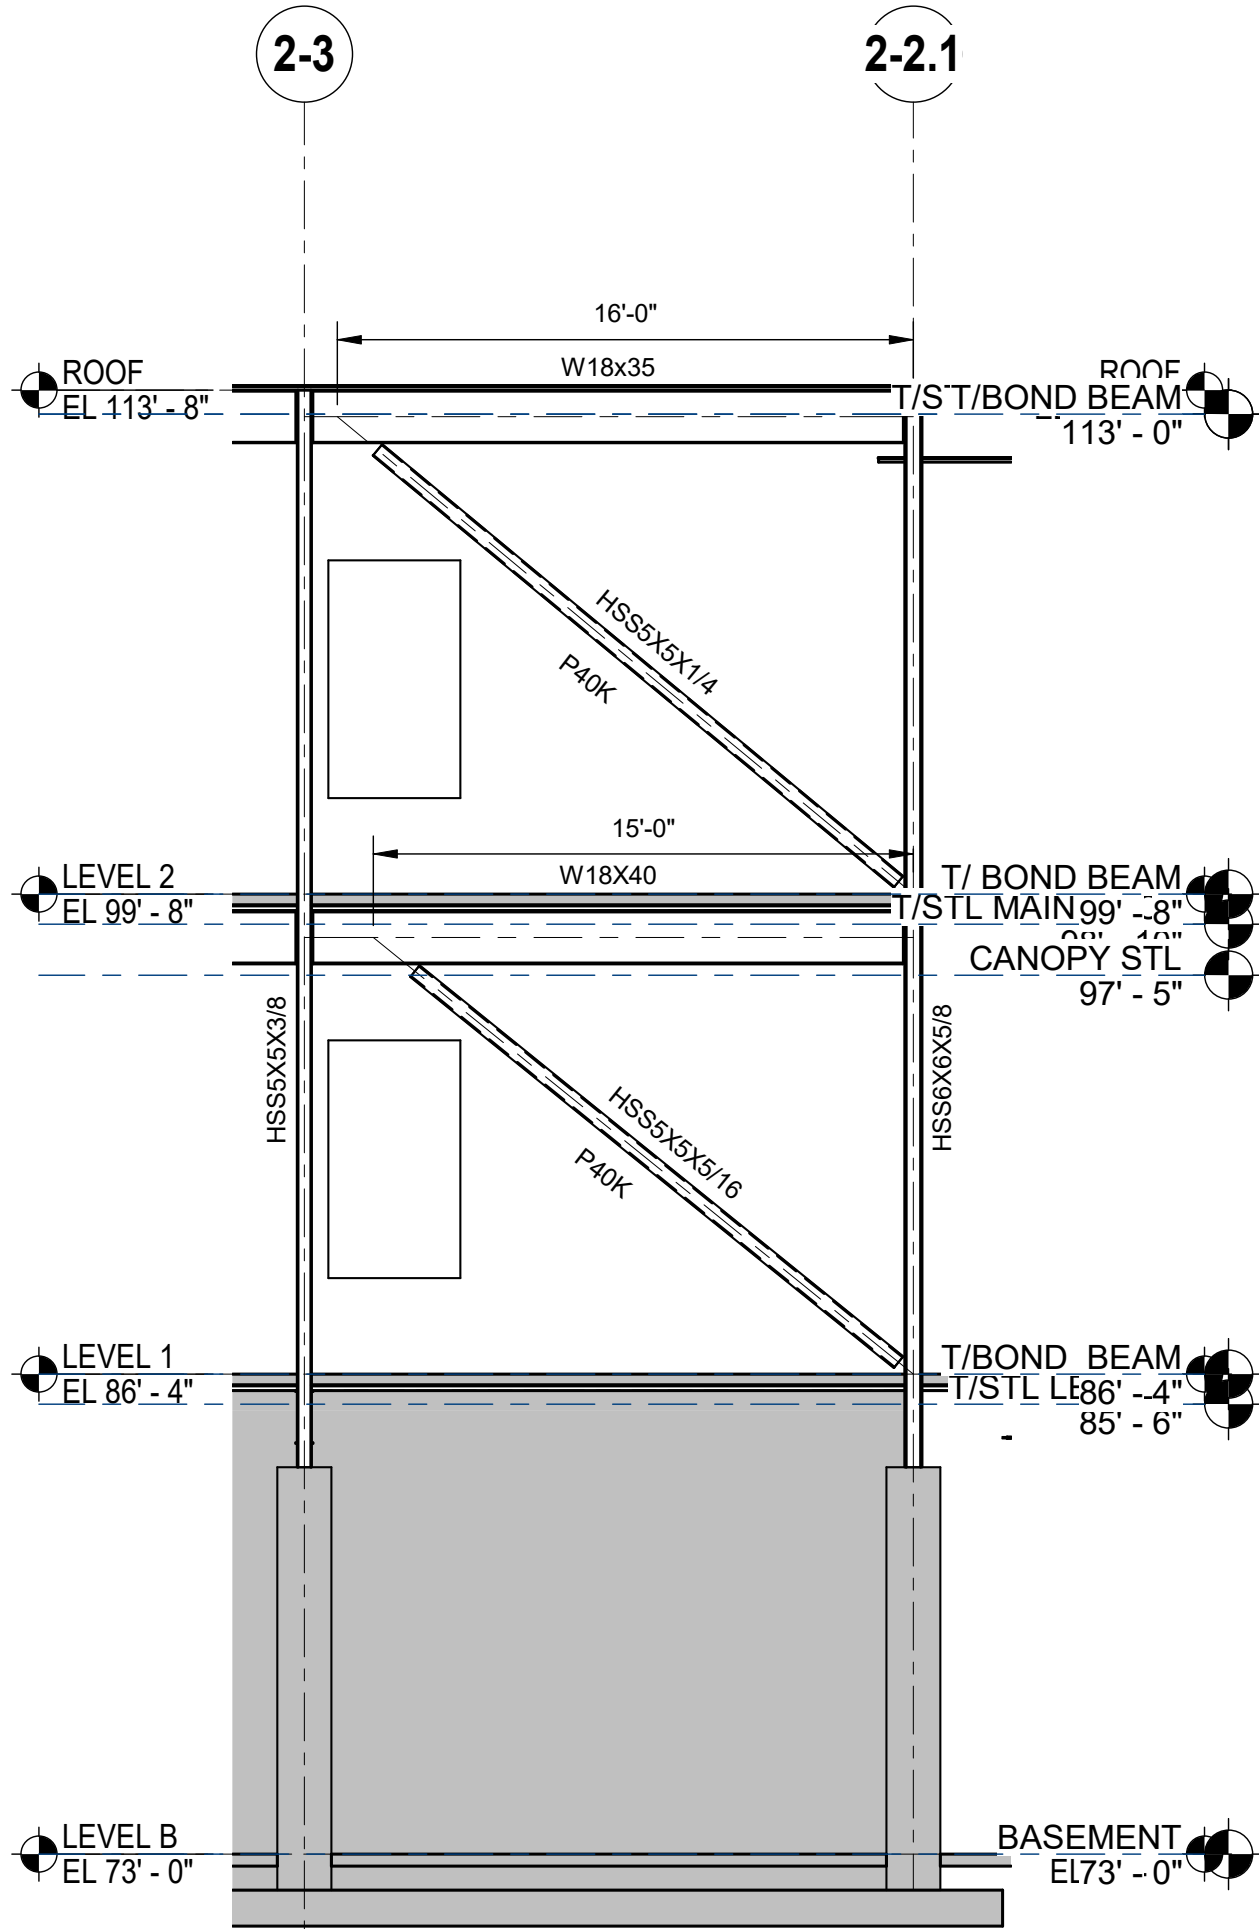
4 BF-4 AT 2-F LINE
SCALE: 3/16" = 1'-0"



5 BF-5 AT 2-E LINE
SCALE: 3/16" = 1'-0"

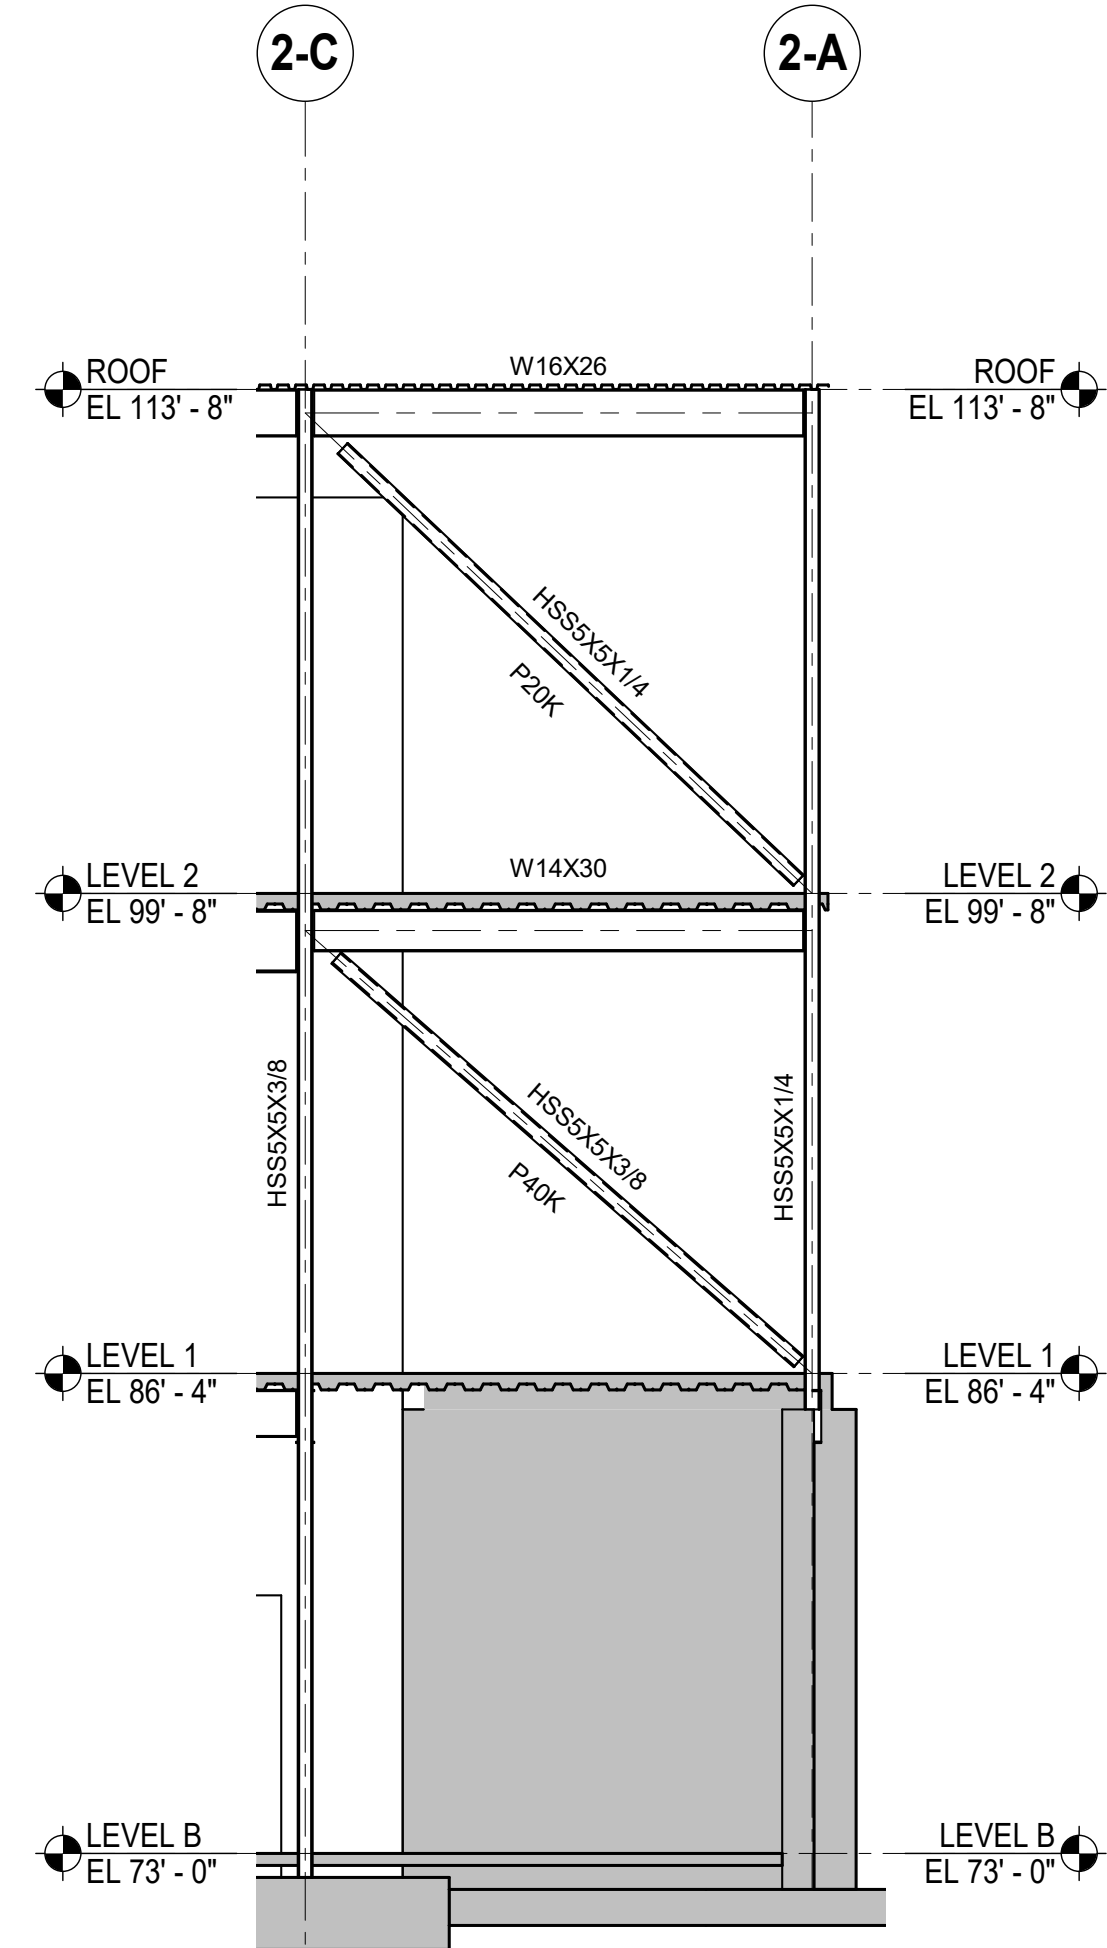

6 BF-6 AT 2-A LINE
SCALE: 3/16" = 1'-0"

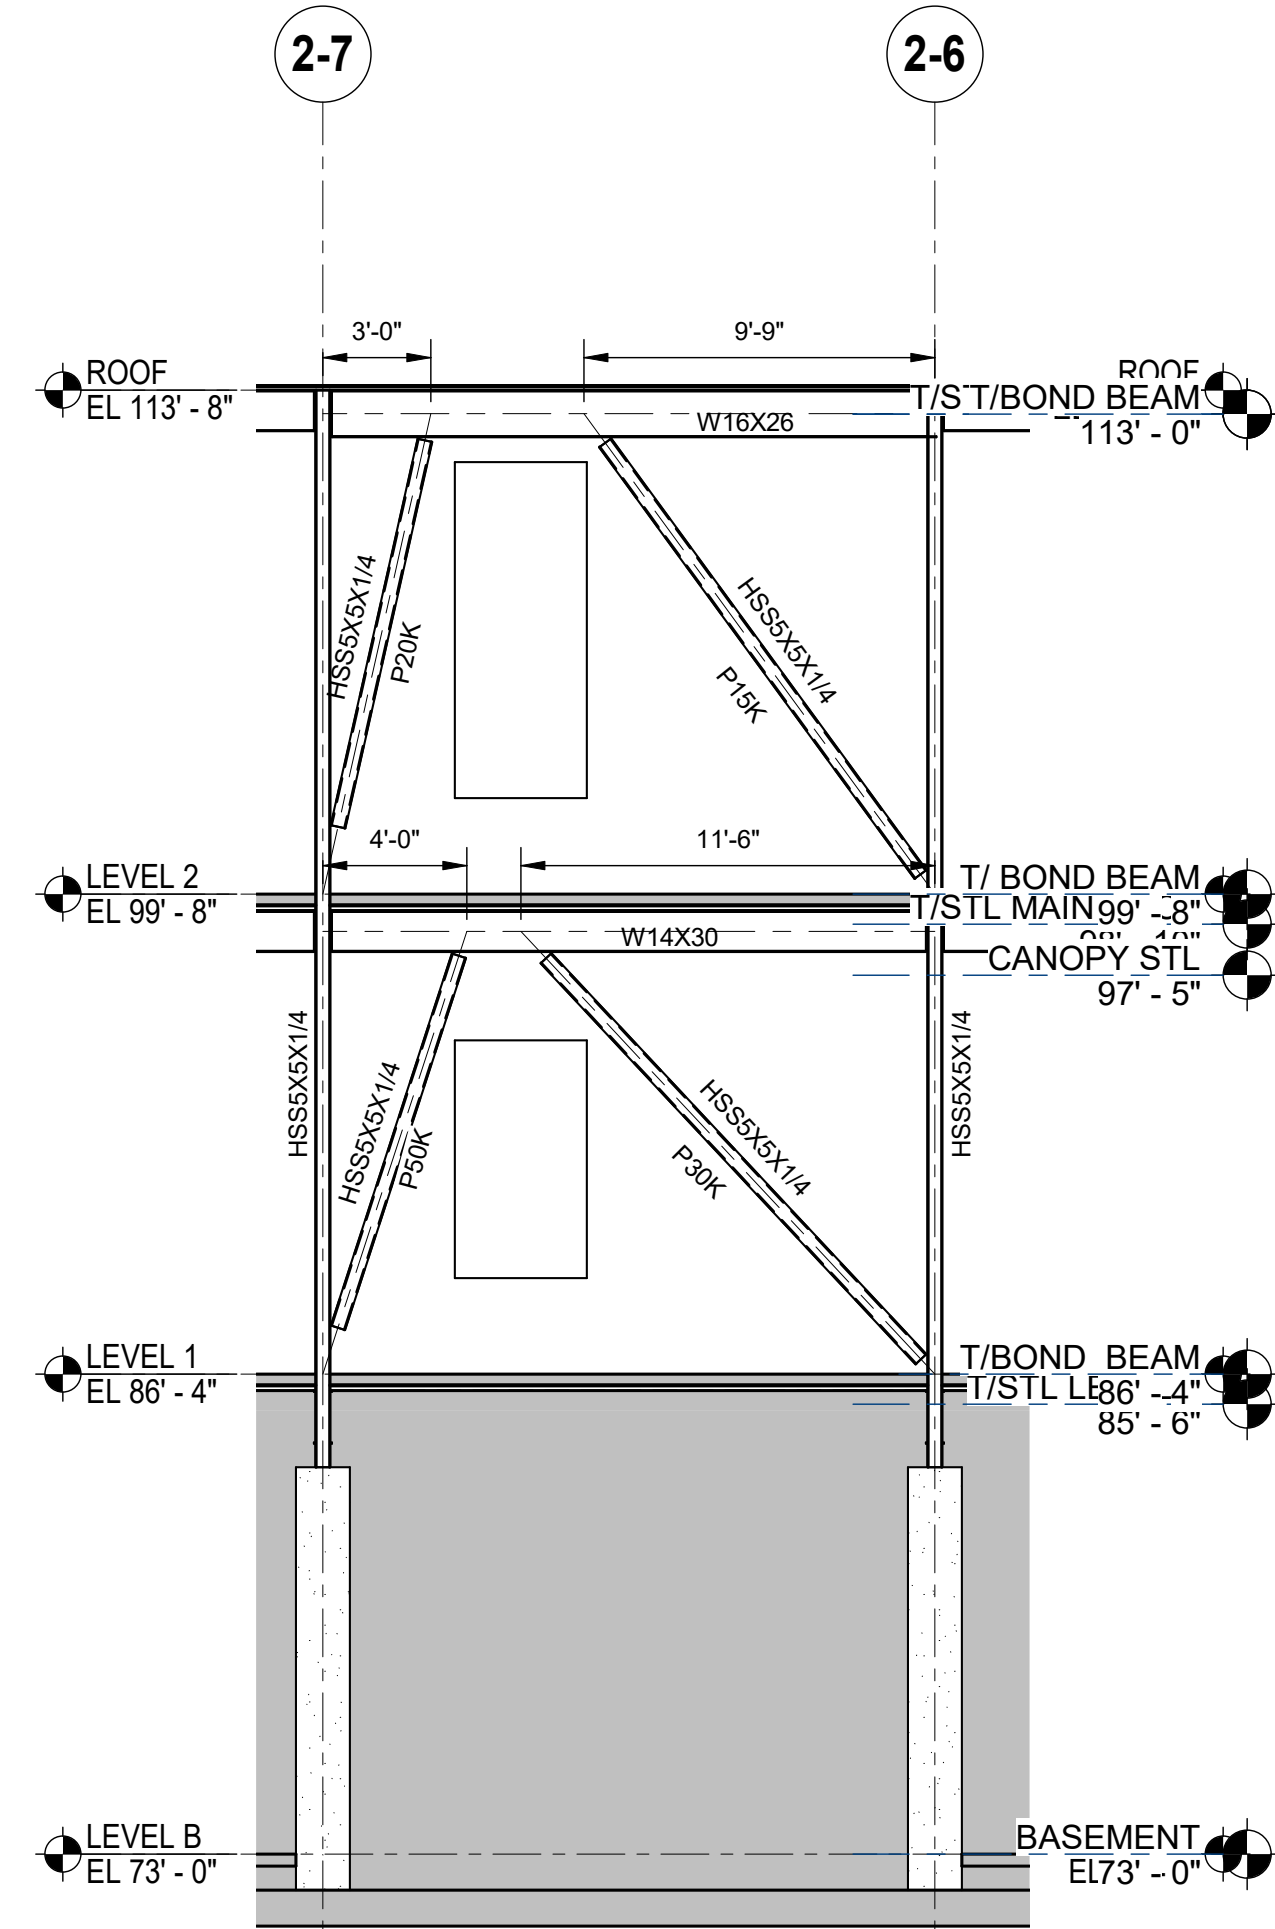


7 BF-7 AT 2-A LINE
SCALE: 3/16" = 1'-0"

BRACED FRAME NOTES:

- REFER TO PLANS FOR TOP STEEL ELEVATIONS AND FOR GRIDLINE DIMENSIONS
- ALL FORCES (KIPS) ARE UNFACTORED AND ARE TO BE CONSIDERED FULLY REVERSIBLE UNLESS OTHERWISE NOTED
- SEE TYPICAL BRACE CONNECTION DETAILS SF-501 FOR ADDL INFO.
- ALL BRACE AND BEAM MEMBERS ARE ORIENTED WEB VERTICAL UNLESS OTHERWISE NOTED ON ELEVATION AS FOLLOWS:
(H) INDICATES MEMBER WITH WEB ORIENTED HORIZONTAL
- SEE PLAN FOR COLUMN ORIENTATION
- SEE STEEL BEAM SHEAR CONNECTION SCHEDULE FOR CONNECTION LOADS NOT SHOWN
- ALL BRACED FRAME LINE DIAGRAMS DENOTE CENTERLINES FOR BEAMS AND COLUMNS AND WORKING LINES FOR BRACES (SEE BRACE DETAILS)
- MINIMIZE UNBRACED LENGTH OF GUSSET AT BRACE TO GUSSET CONNECTIONS

LEGEND:

PXX INDICATES UNFACTORED MEMBER AXIAL FORCE IN KIPS

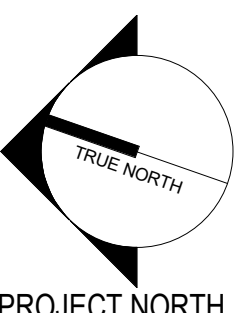

Revisions:	Revision Description	Date:

CONSULTANT

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U.S. Department
of Veterans Affairs

Drawing Title

BRACED FRAME ELEVATIONS

Approved:

VA RI FACILITIES MANAGEMENT
SERVICE

Phase

CONSTRUCTION
DOCUMENTS

FULLY SPRINKLERED

Project Title

NEW MENTAL HEALTH BUILDING -
PHASE 2

Location

830 CHALKSTONE AVE PROVIDENCE, RI 02908

Issue Date

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Checked

EAR

Drawn

CGW

Project Number


650-347

Building Number

39

Drawing Number


SF-401

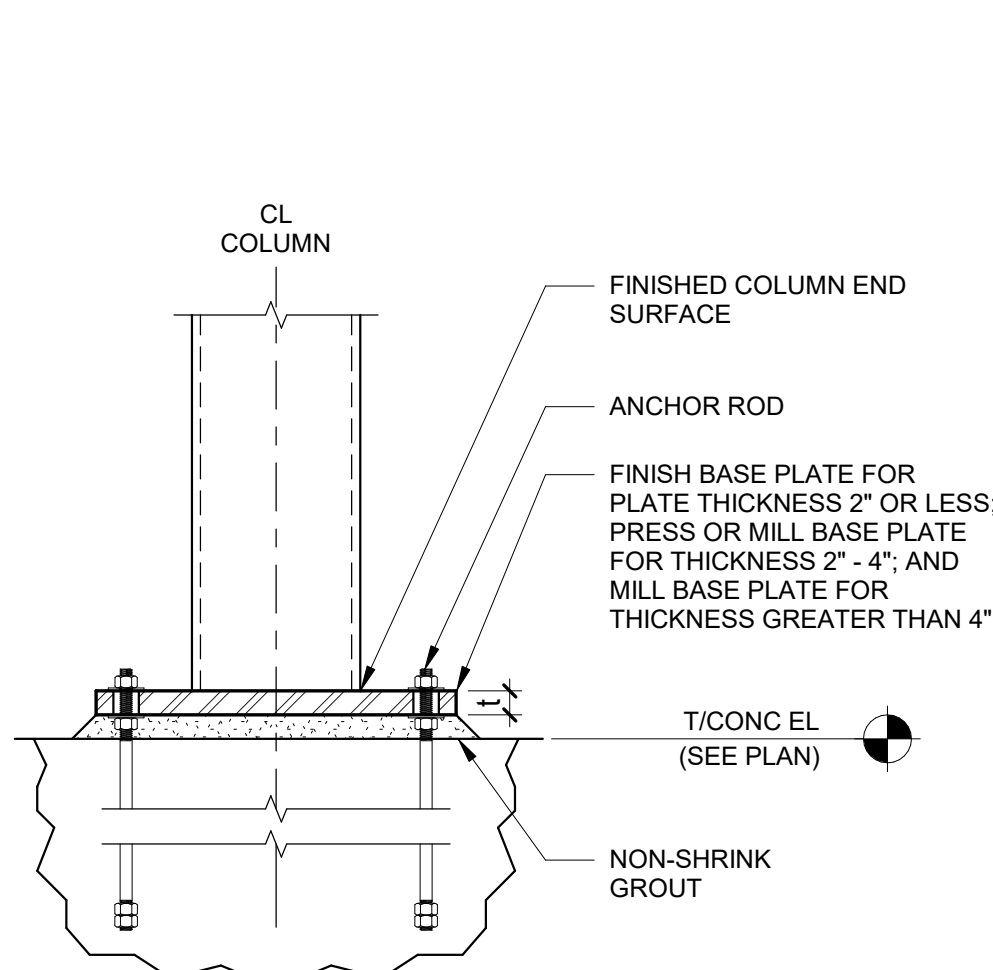

1 ELEVATION

NOTES:

- SEE COLUMN SCHEDULE FOR BASE PLATE SIZE, ORIENTATION AND THICKNESS
- BASE PLATE THICKNESS SHOWN ON SCHEDULE IS A MINIMUM. DIMENSION AFTER ALL MILLING IS COMPLETED
- COLUMN STABILITY DURING ERECTION IS RESPONSIBILITY OF CONTRACTOR
- SEE ANCHOR ROD SCHEDULE AND TYPICAL ANCHOR ROD DETAIL FOR ADDITIONAL INFORMATION
- CONTRACTOR'S OPTION TO FIELD WELD COLUMNS TO BASEPLATES FOR HEAVY BASEPLATES
- ANCHOR ROD CONFIGURATION IS TO USE SQUARE PATTERN OUTSIDE COLUMN. IF SPECIFIED BASE PLATE SIZE DOES NOT PERMIT OUTSIDE PLACEMENT USE SQUARE PATTERN INSIDE COLUMN. USE RECTANGULAR ANCHOR ROD CONFIGURATION WHERE NOTED

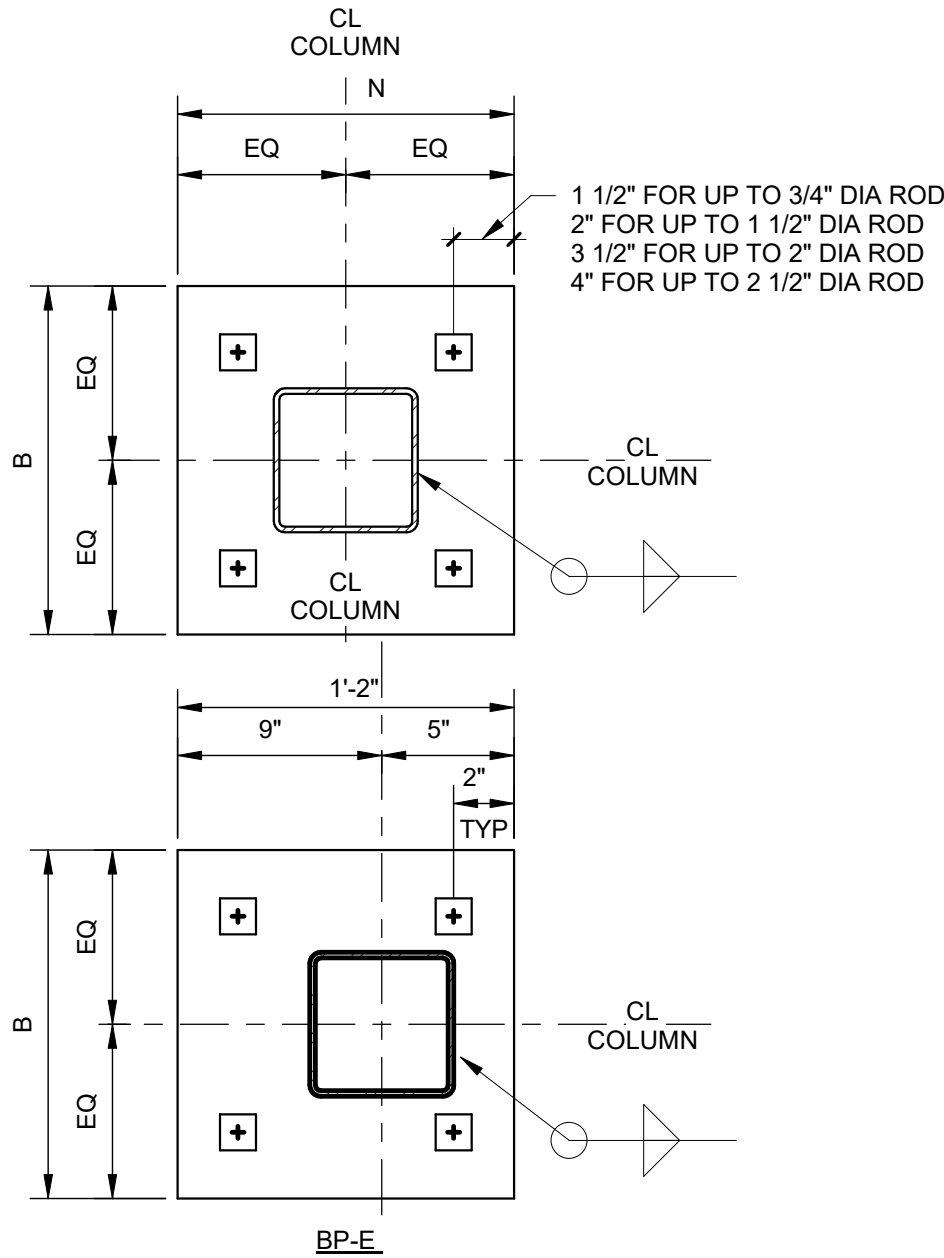

2 ROUND OR RECTANGULAR HSS PLAN

BP-A: PL 1/4x12x1'-0" W/ (4)-1 5/16"Ø HOLES FOR (4)-3/4"Ø x 18" LG F1554 GR 55 ANCHOR RODS W/12" EMBED & 6" PROJ.

BP-A1: PL 1/4x12x1'-0" W/ (4)-1 5/16"Ø HOLES FOR (4)-3/4"Ø x 42" LG F1554 GR 55 ANCHOR RODS W/36" EMBED & 6" PROJ.


BP-B: PL 1/4x14x1'-2" W/ (4)-1 13/16"Ø HOLES FOR (4)-1"Ø x 18" LG F1554 GR 36 ANCHOR RODS W/12" EMBED & 6" PROJ.

BP-B1: PL 1/4x14x1'-2" W/ (4)-1 13/16"Ø HOLES FOR (4)-1"Ø x 42" LG F1554 GR 36 ANCHOR RODS W/36" EMBED & 6" PROJ.

BP-C: PL 1/2x16x1'-4" W/ (4)-2 1/16"Ø HOLES FOR (4)-1 1/4"Ø x 22" LG F1554 GR 36 ANCHOR RODS W/16" EMBED & 6" PROJ.

BP-D: PL 3/4x10x0'-10" W/ (4)-1 5/16"Ø HOLES FOR (4)-3/4"Ø x 18" LG F1554 GR 36 ANCHOR RODS W/12" EMBED & 6" PROJ.

BP-E: PL 1/4x14x1'-0" W/ (4)-1 13/16"Ø HOLES FOR (4)-1"Ø x 42" LG F1554 GR 36 ANCHOR RODS W/36" EMBED & 6" PROJ.

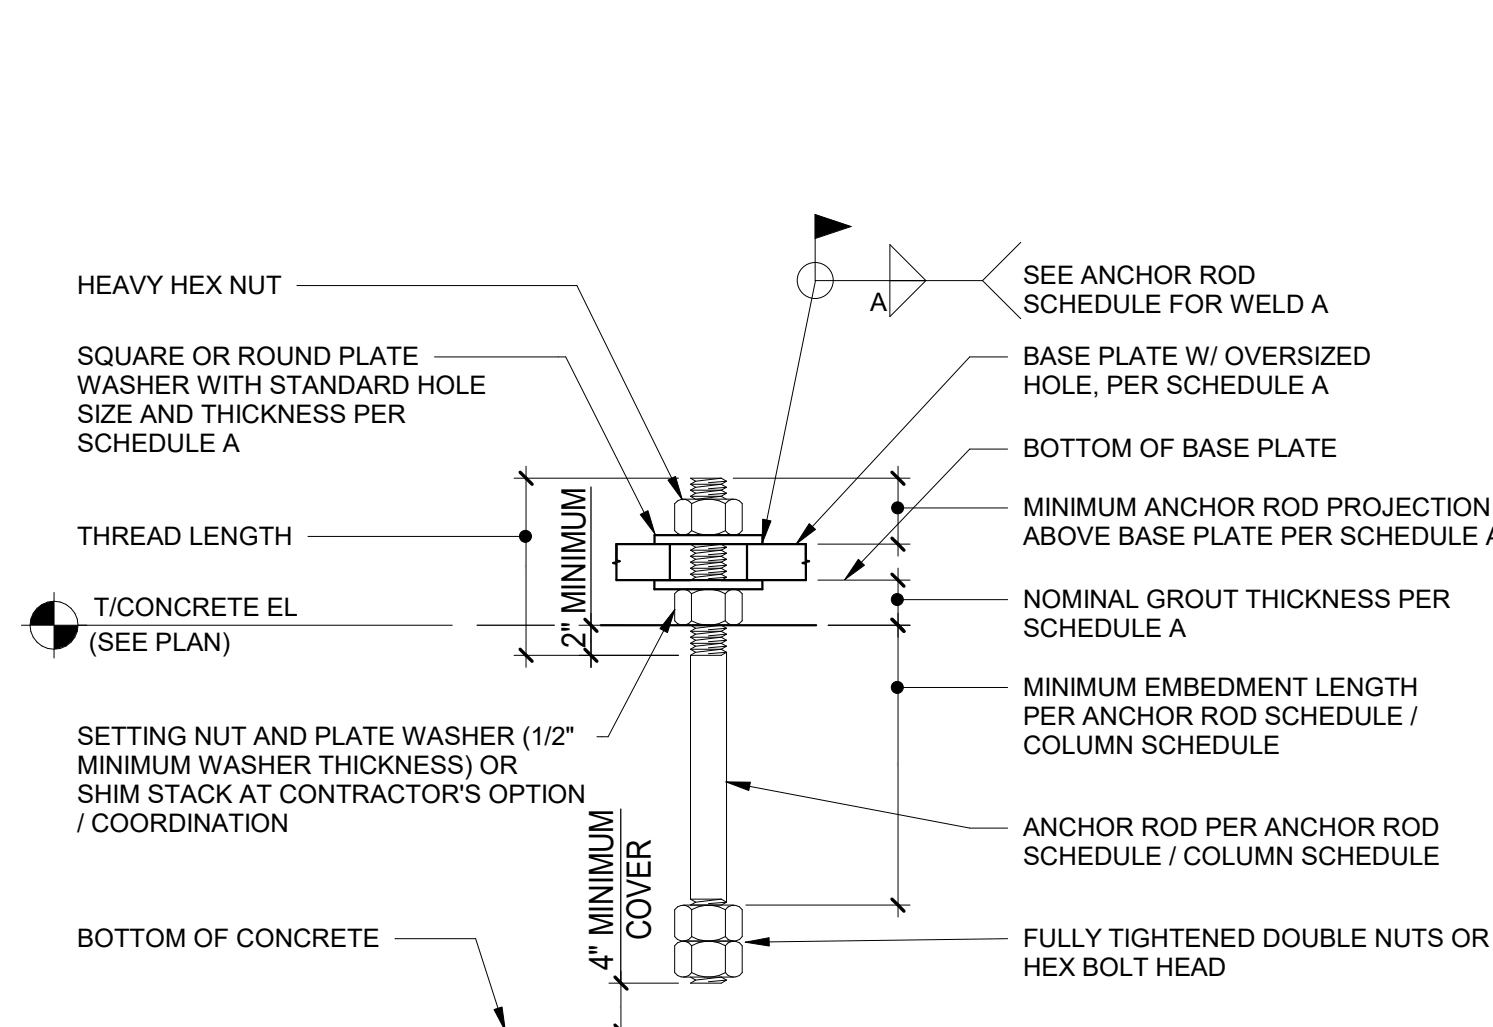



2 TYPICAL ANCHOR ROD DETAIL

SCALE: 3/4" = 1'-0"

SCHEDULE A					
ANCHOR ROD DIAMETER	BASE PL HOLE DIA	MIN WASHER SIZE	MIN WASHER t	MIN PROJ ABOVE BASE PL	NOMINAL GROUT THICKNESS
3/4"	1-5/16"	2"	1/4"	3"	2"
1"	1-13/16"	3"	3/8"	3-1/2"	2"
1-1/4"	2-1/16"	3"	1/2"	4"	3"
1-1/2"	2-5/16"	3-1/2"	1/2"	4"	3"

3 TYP BEAM BEARING AT CMU

SCALE: 3/4" = 1'-0"

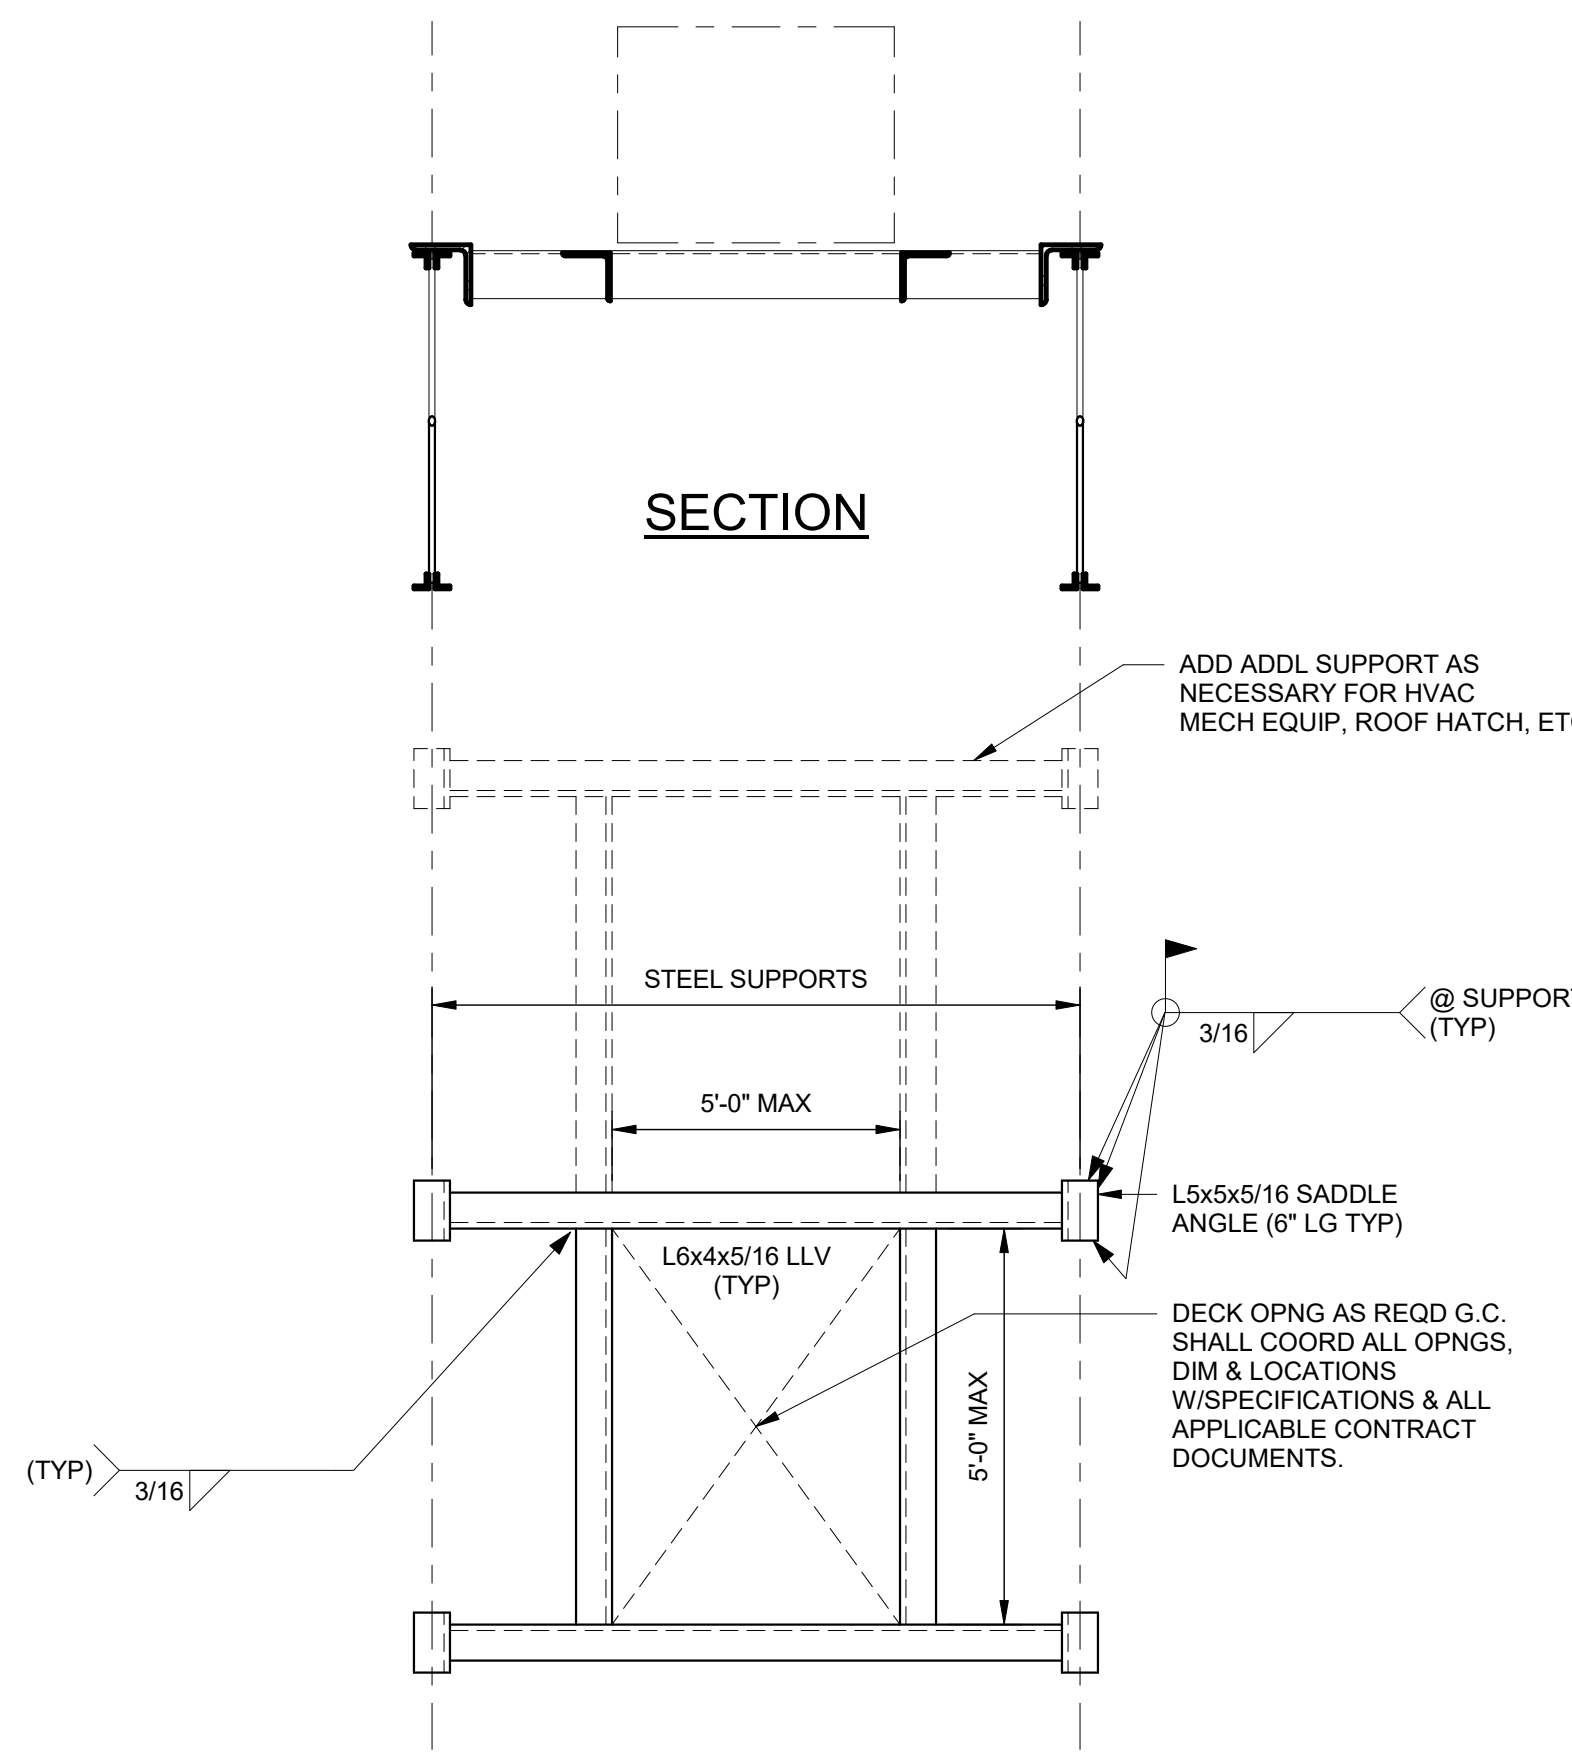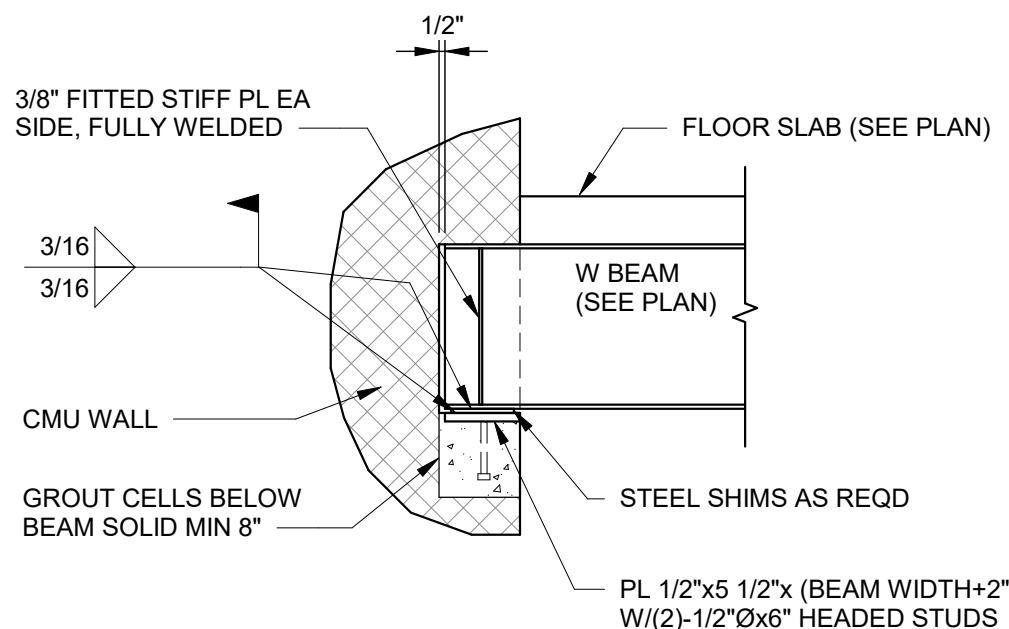


PLAN VIEW

N.T.S. (TYPICAL @ FANS & OTHER MECH & HVAC EQUIP U.N.O.)

NOTE: DETAIL TYPICAL AT ROOF DRAINS, EXHAUST FANS AND OTHER MECH AND HVAC EQUIP IF OPENING IS LARGER THAN 12"Ø OR CUTS MORE THAN 1" DECK RIB. FOR OPENINGS LESS THAN 12", REINF OPNG W/16GA MIN PL MIN PL LENGTH SHALL BE "D"+4". EXTEND AS REQD FOR 2" MIN BRG ON DECK RIB.

4 TYP OPENING IN ROOF DECK

SCALE: 3/4" = 1'-0"

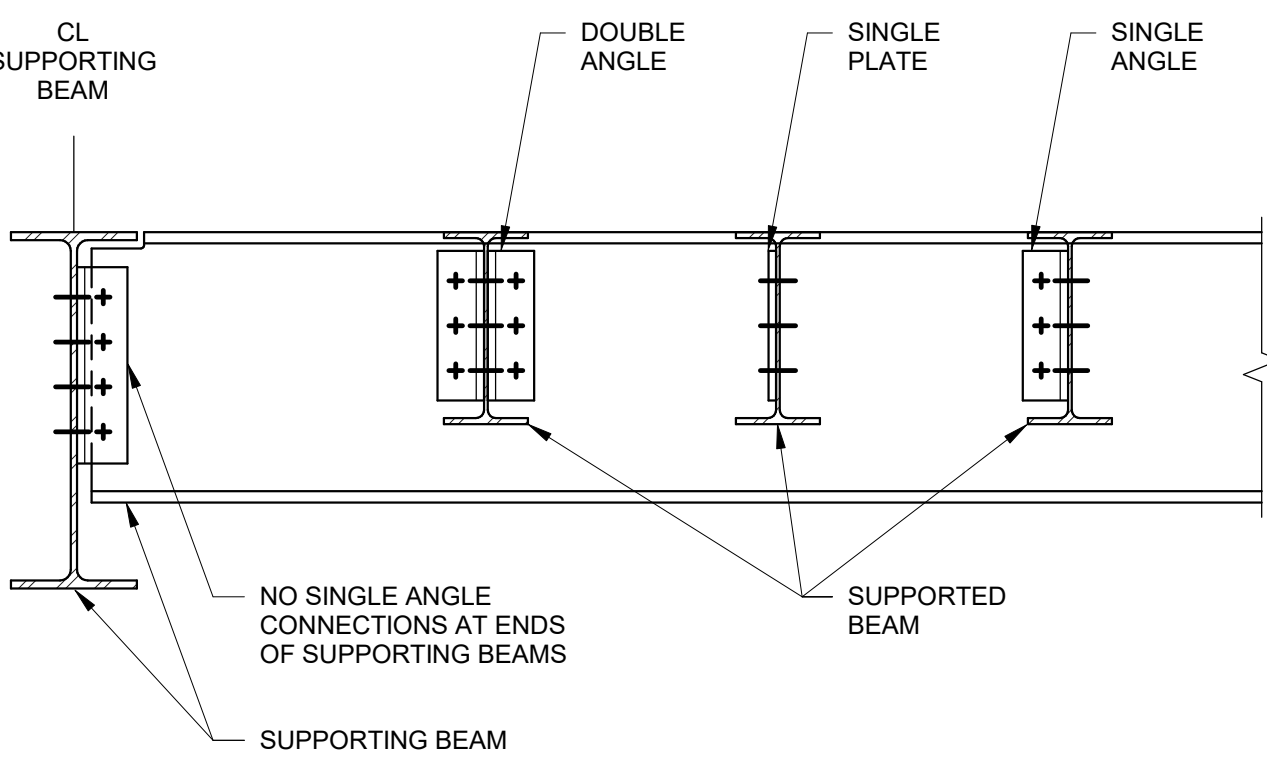

NOTES:

- SUPPORTED BEAMS PRIMARILY SUPPORT DISTRIBUTED LOADS FROM SLABS OR DECKING
- FROM SUPPORTING BEAMS SUPPORT SIGNIFICANT POINT LOADS FROM ONE OR MORE SUPPORTED BEAMS OR FROM COLUMNS BEING TRANSFERRED. SUPPORTING BEAMS MAY BE SUPPORTED BY COLUMNS OR BY OTHER SUPPORTING BEAMS
- FOR SHEAR CONNECTIONS AT SUPPORTED BEAM ENDS, DOUBLE ANGLE, SINGLE PLATE OR SINGLE ANGLE MAY BE USED UNLESS OTHERWISE NOTED
- SEE TYPICAL STEEL BEAM SHEAR CONNECTION SCHEDULE FOR INFORMATION NOT SHOWN


5 TYPICAL BEAM TO BEAM SHEAR CONNECTION

SCALE: 3/4" = 1'-0"

SIMPLE SHEAR BEAM CONNECTION SCHEDULE			
BEAM SIZE	DESIGN REACTION	MIN No. BOLTS - ONE SIDED CONNECTION	MIN No. BOLTS - TWO SIDED CONNECTION
W8/W10	15 K	2	2
W12/W14	25 K	3	3
W16	25 K	4	3
W18	30 K	4	3
W21	35 K	5	4
W24	40 K	6	5


SIMPLE SHEAR CONNECTIONS NOTES:

- SIMPLE SHEAR CONNECTIONS SHALL BE SELECTED FROM THE LATEST EDITION OF THE AISC "MANUAL OF STEEL CONSTRUCTION" USING THE ABOVE REFERENCED REACTIONS AND CRITERIA. REACTIONS INDICATED ARE UNFACTORED (SERVICE LEVEL LOADS). MORE BOLTS THAN REFERENCED IN THE "MINIMUM" SECTIONS ABOVE MAY BE REQUIRED FOR LOAD REQUIREMENTS.
- CONNECTIONS ARE SUBJECT TO REVIEW ON THE STEEL SHOP DRAWINGS.
- ALL BOLTS SHALL BE A325 OR A490 FOR SIMPLE SHEAR CONNECTIONS, MIN 3/4"Ø. MINIMUM WELD SIZE SHALL BE 5/16". MINIMUM ANGLE/PLATE THICKNESS SHALL BE 3/8".
- ONE SIDED CONNECTIONS INCLUDE SINGLE PLATES AND SINGLE ANGLE CONNECTIONS.
- TWO SIDED CONNECTIONS INCLUDE DOUBLE ANGLE AND END PLATE CONNECTIONS.

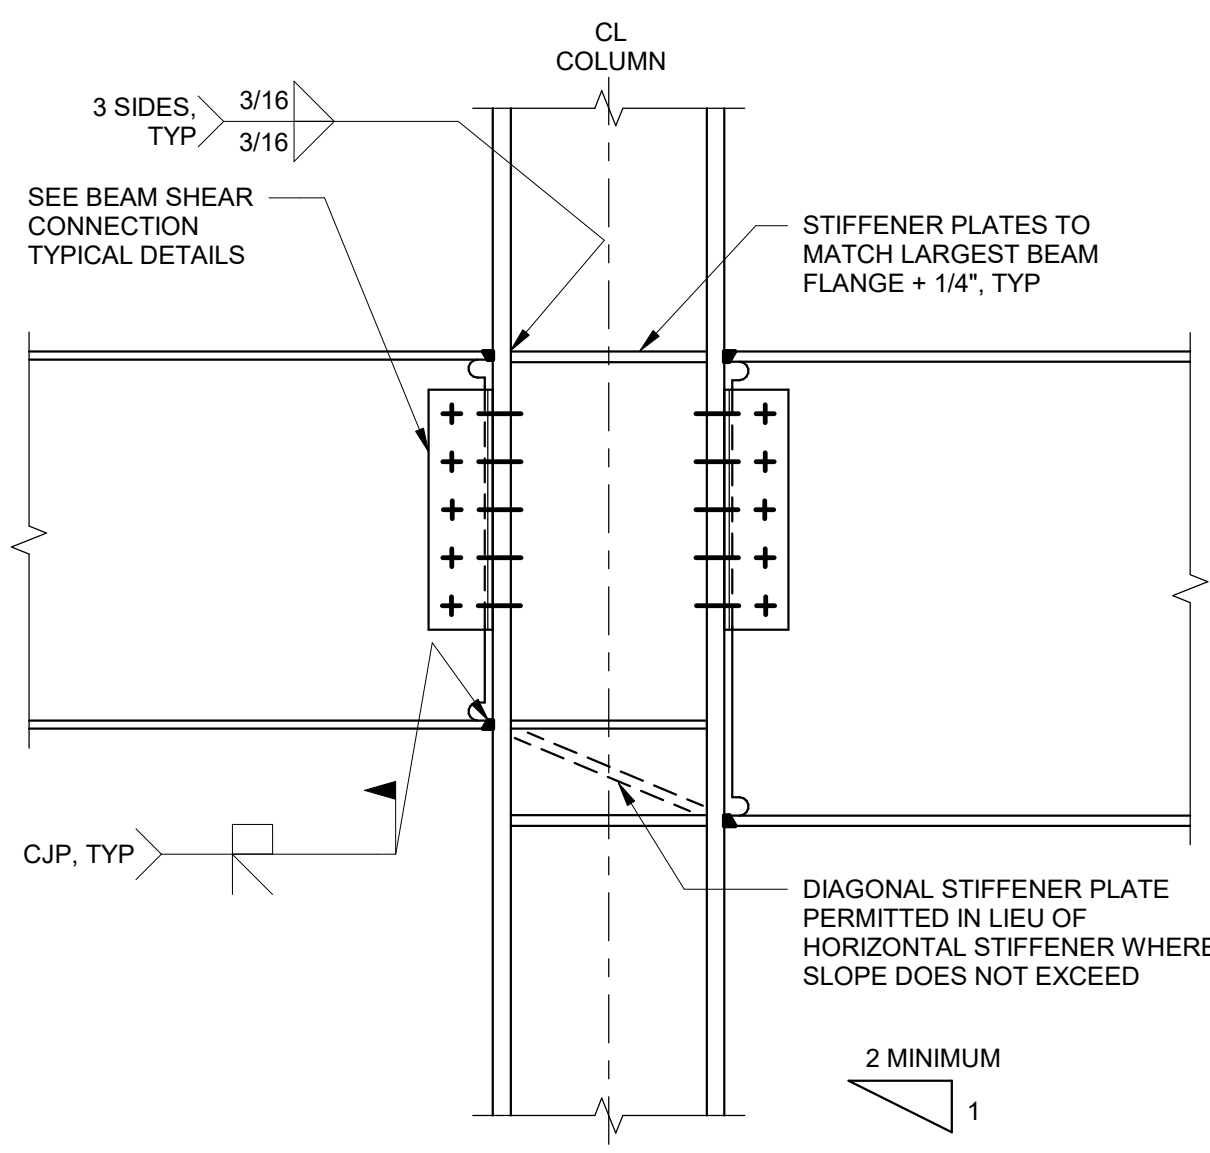

6 TYPICAL BEAM TO COLUMN FLANGE MOMENT CONNECTION U.N.O.


SCALE: NOT TO SCALE

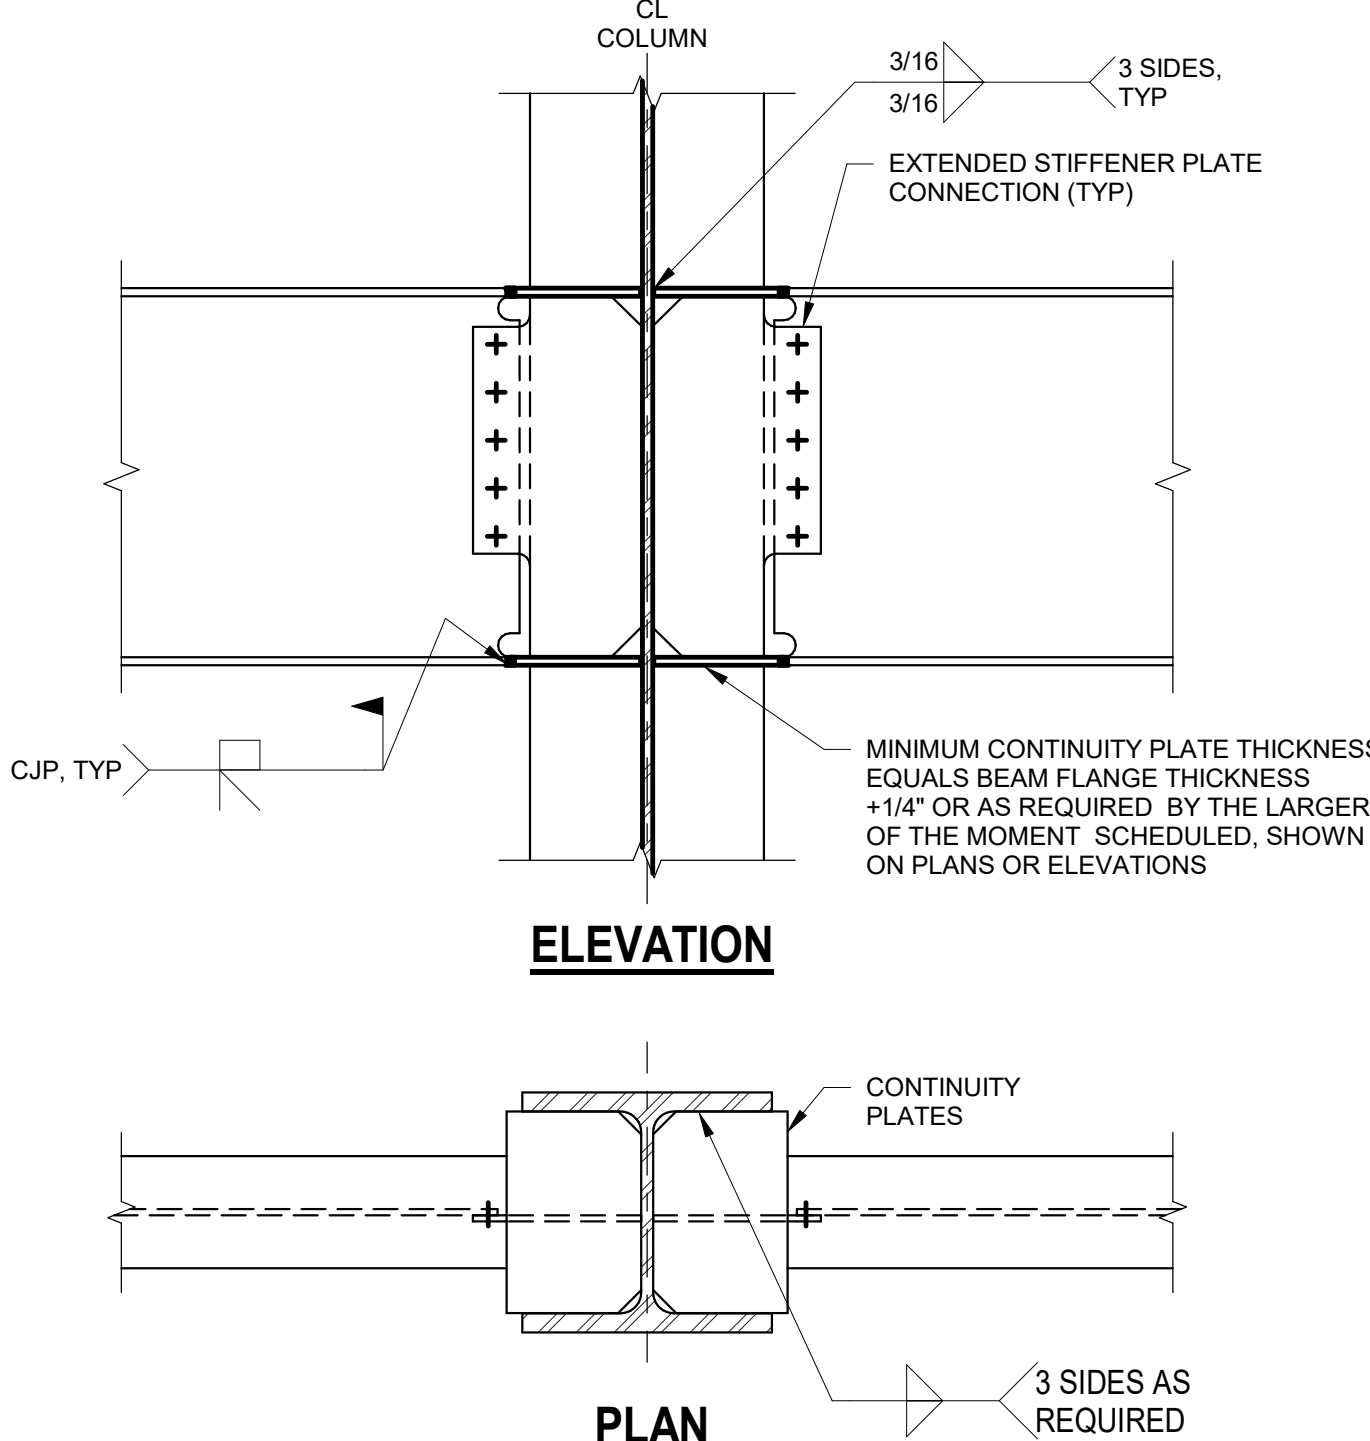

7 TYPICAL BEAM TO COLUMN WEB MOMENT CONNECTION U.N.O.

SCALE: NOT TO SCALE

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Revisions:	Revision Description	Date:
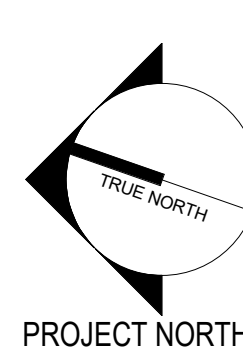
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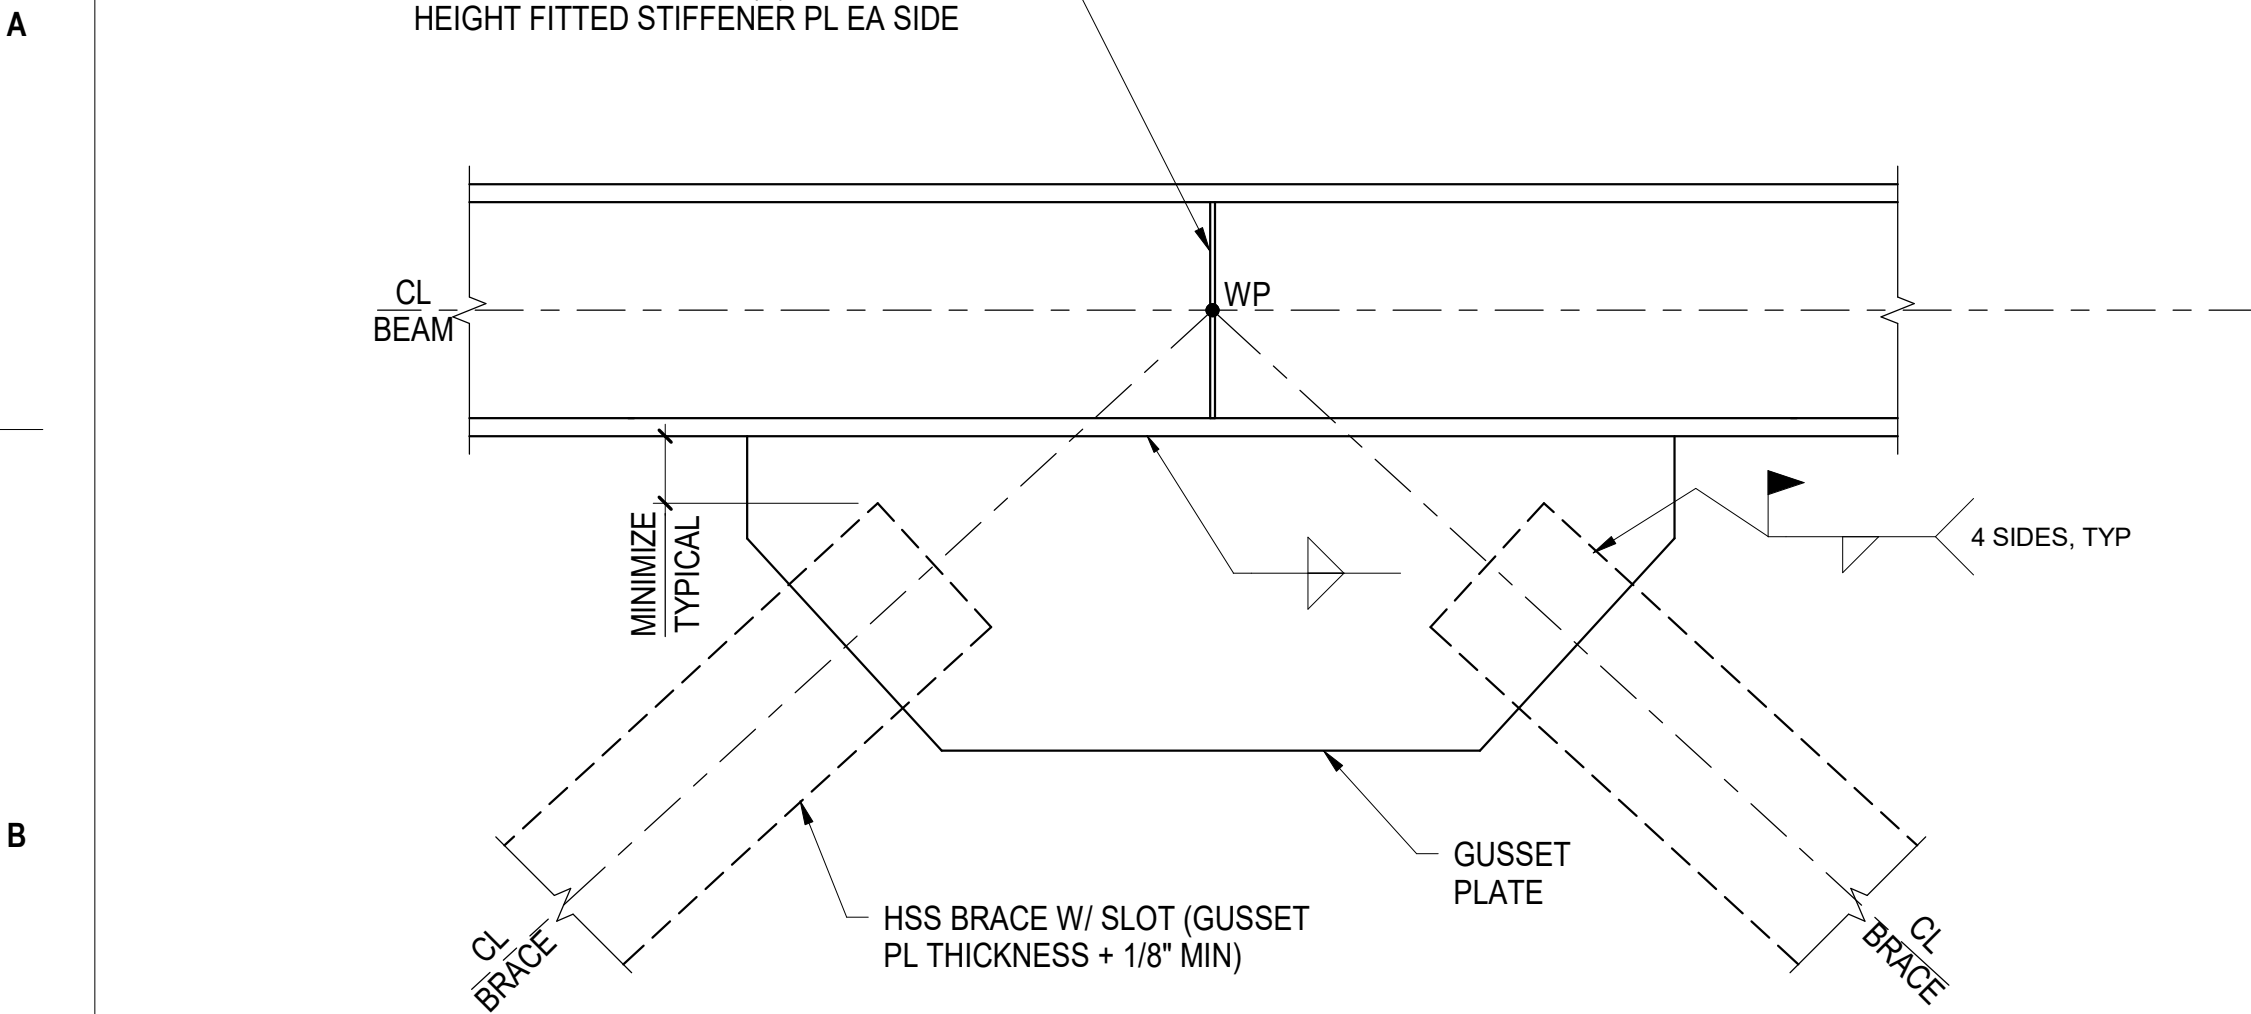
Office of
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Management
VA U.S. Department
of Veterans Affairs

Drawing Title
TYPICAL FRAMING DETAILS
Approved:
VA RI FACILITIES MANAGEMENT
SERVICE

Phase
CONSTRUCTION
DOCUMENTS
FULLY SPRINKLERED


Project Title
NEW MENTAL HEALTH BUILDING -
PHASE 2
Location
830 CHALKSTONE AVE PROVIDENCE, RI 02908
Issue Date
FEB 04 2022
Checked
CGW
Drawn
BSE

Project Number
650-347
Building Number
39
Drawing Number
SF-500




NOTES:
1. BRACE WORK POINTS ARE ECCENTRIC AT SIMILAR CONDITION


1 TYPICAL CONCENTRIC BRACE CONNECTION TO BEAM
NOT TO SCALE

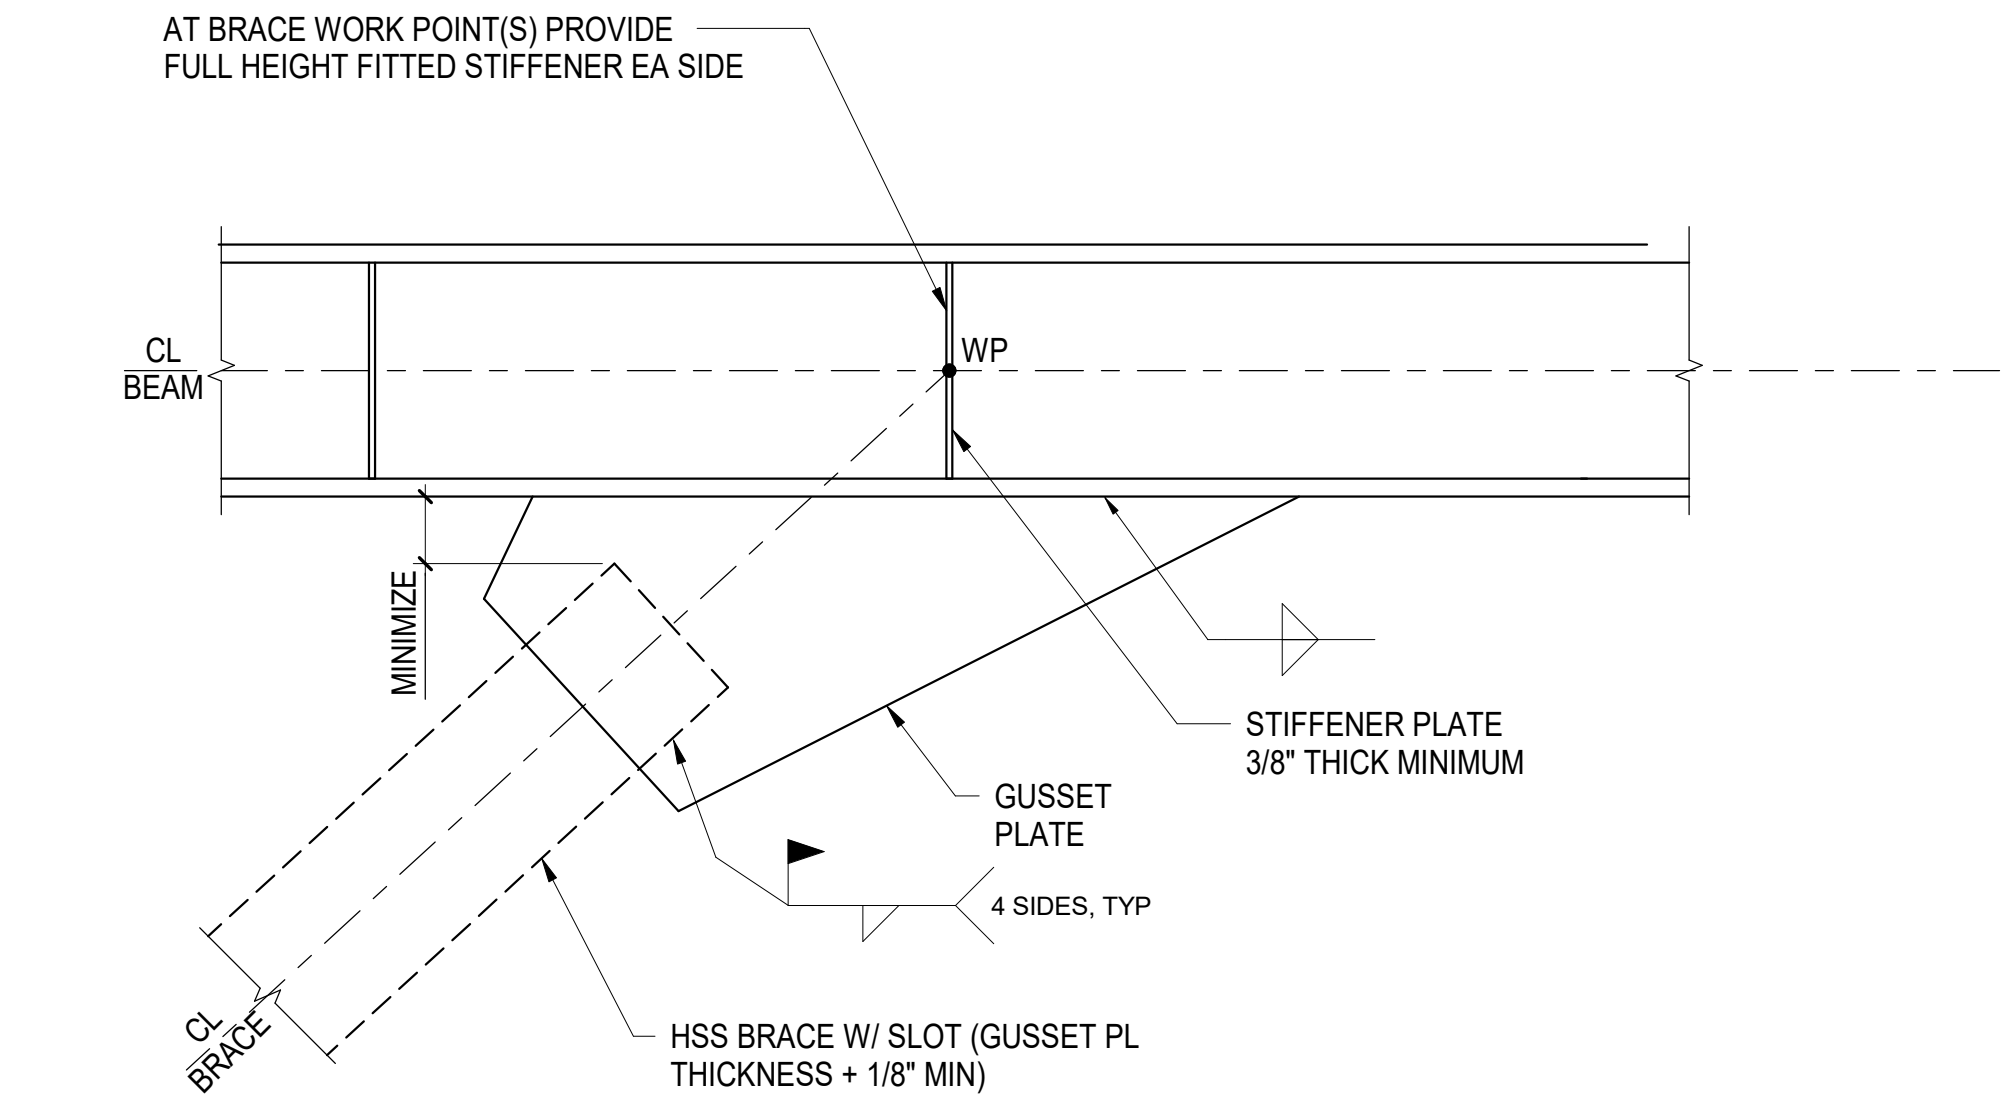

2 TYPICAL ECCENTRIC BRACE CONNECTION TO BEAM
NOT TO SCALE

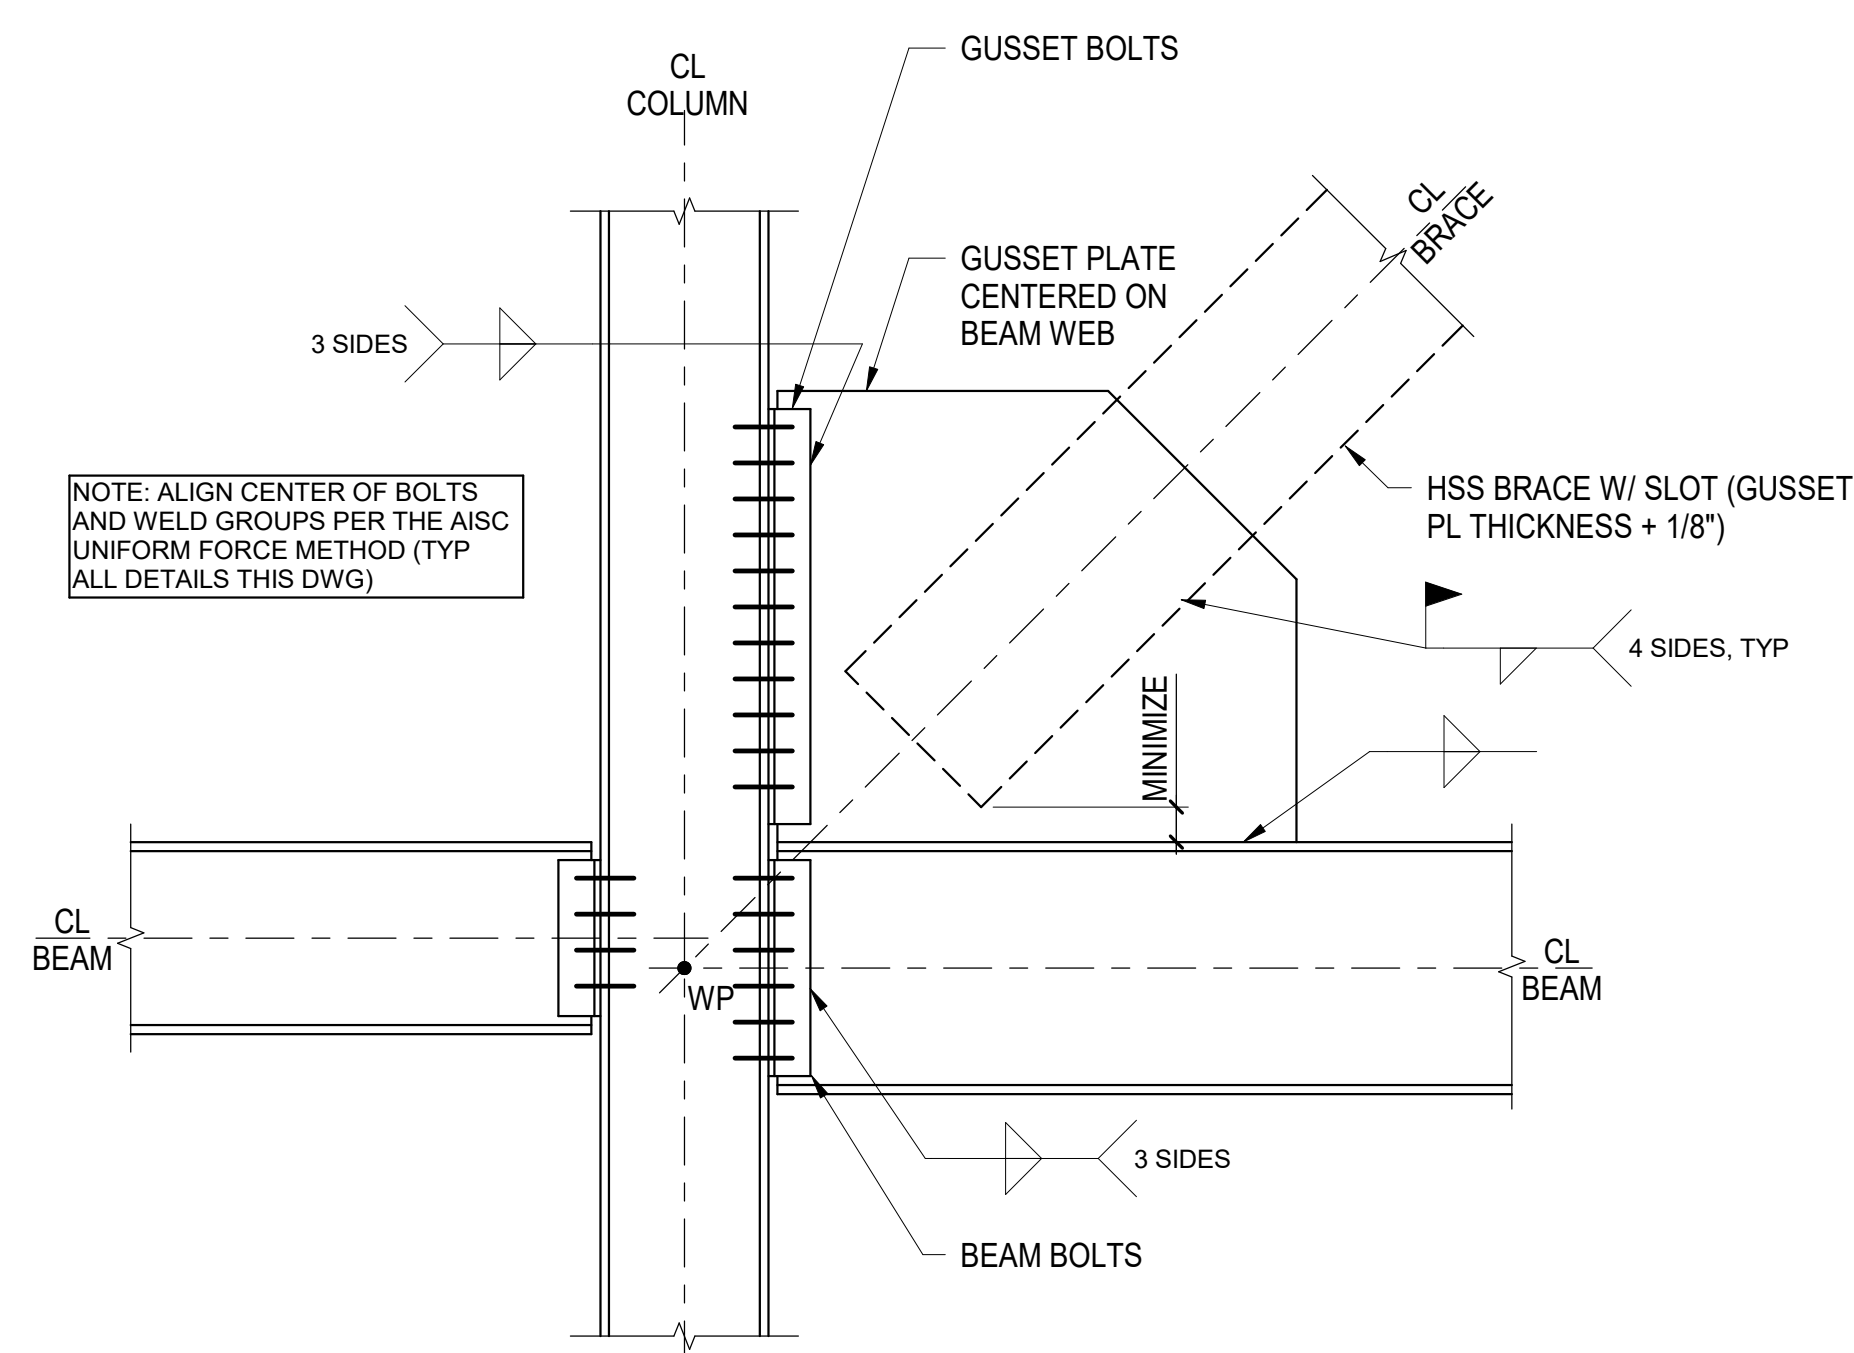

3 TYPICAL BRACE CONNECTION TO COLUMN FLANGE AND BEAM
NOT TO SCALE

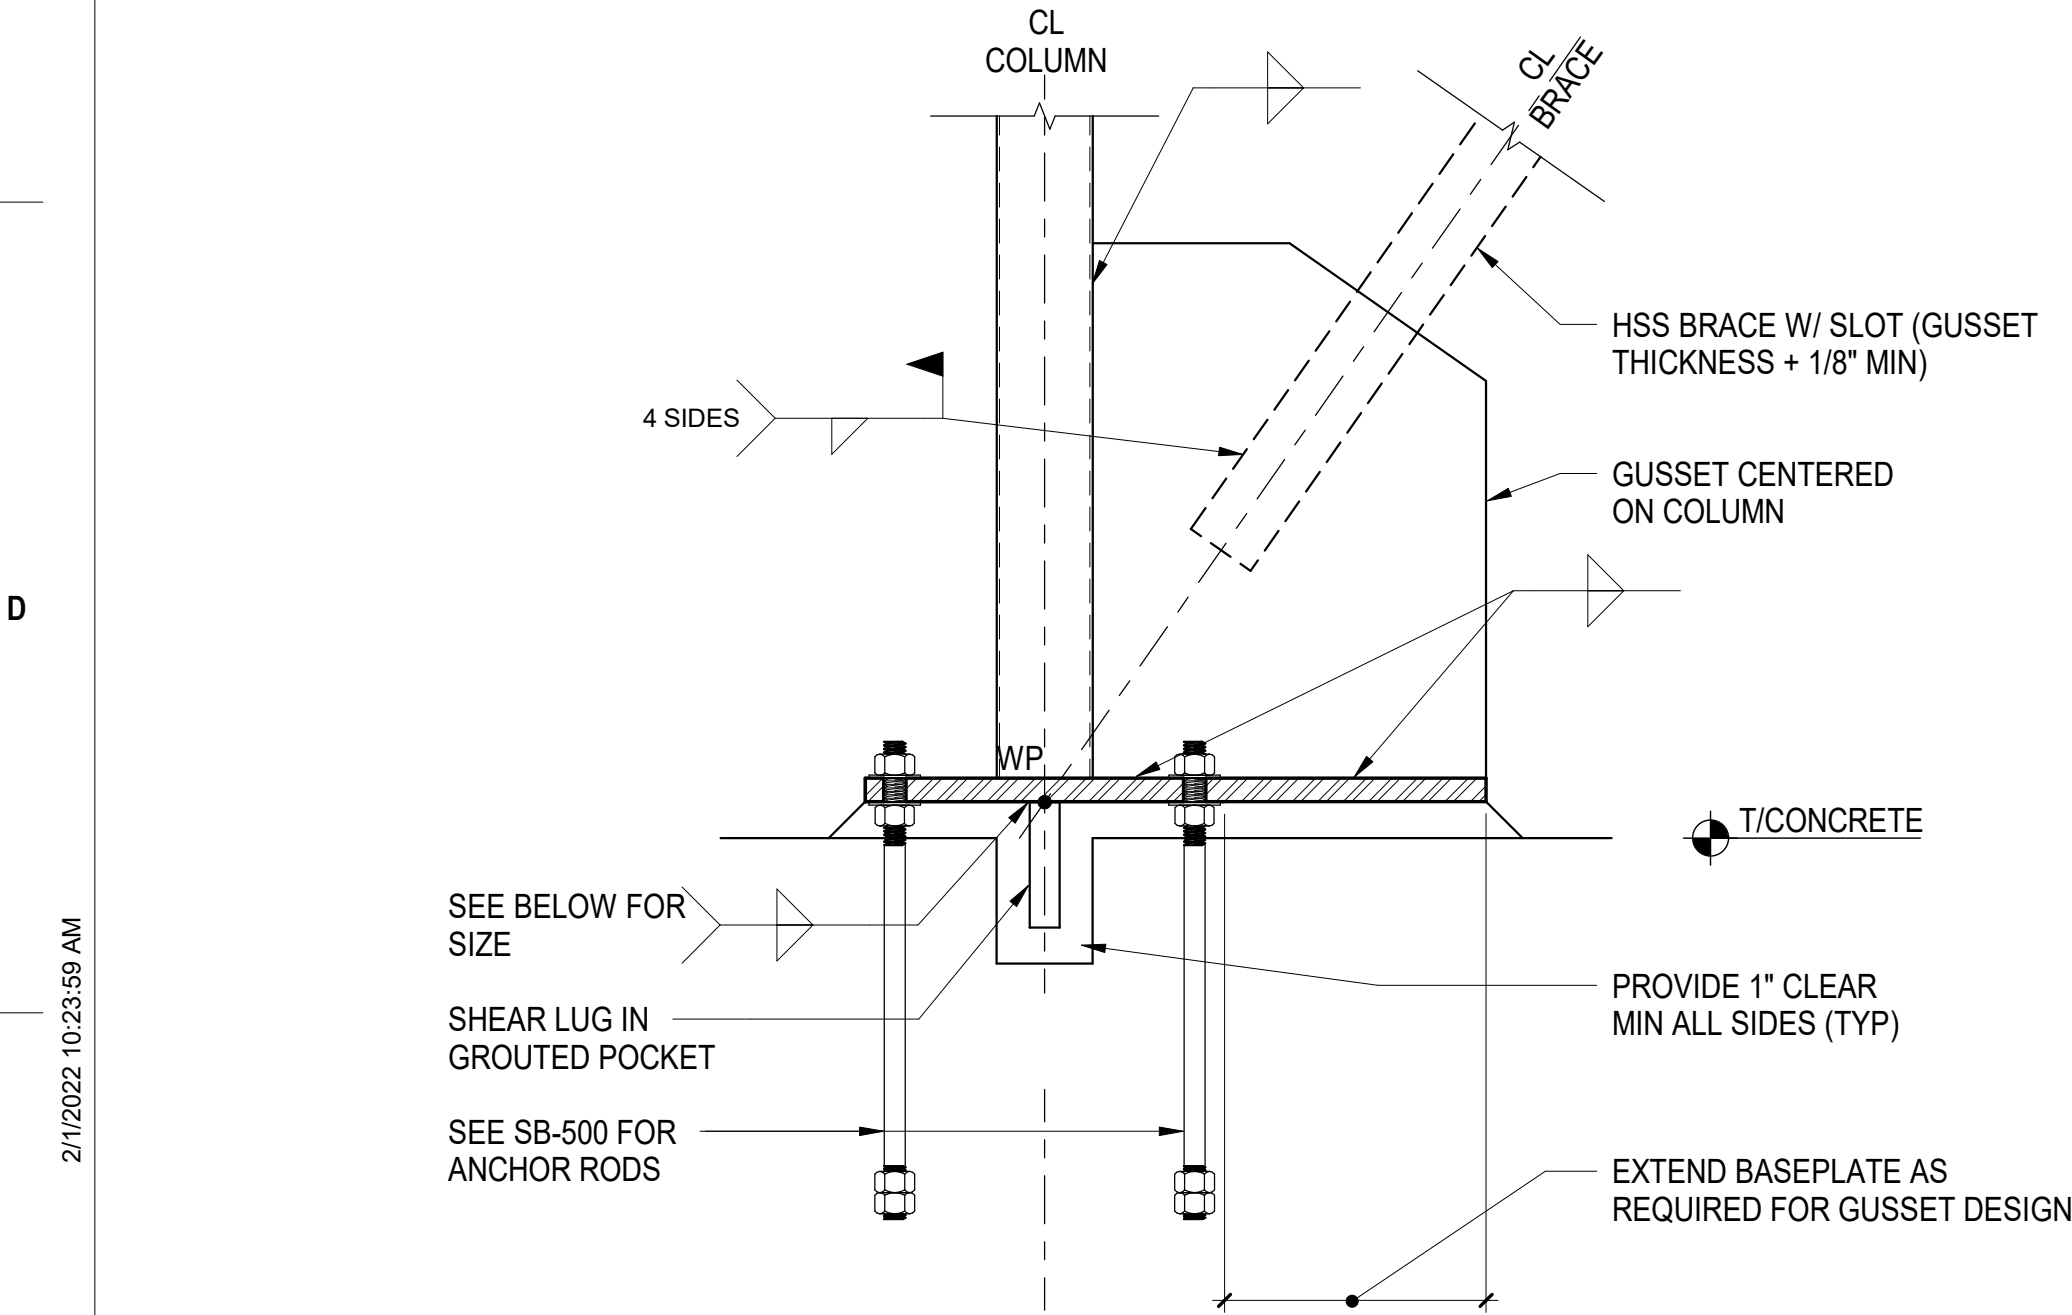

NOTES:
1. SEE COLUMN SCHEDULE FOR BASE PLATE SIZE AND ANCHOR ROD MARK

SL-1: PL1 1/4x6x0'-10" W/1/2" WELD
SL-2: CRUCIFORM PLs1 1/4x8x1'-0"x1'-0" W/3/4" WELD
SL-2: PL2x8x1'-0" W/3/4" WELD

4 TYPICAL BRACE TO SHEAR LUG CONNECTION
NOT TO SCALE

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Office of Construction and Facilities Management
VA U.S. Department of Veterans Affairs

Drawing Title
TYPICAL BRACED FRAME CONNECTION DETAILS
Approved:
VA RI FACILITIES MANAGEMENT SERVICE

Phase
CONSTRUCTION DOCUMENTS
FULLY SPRINKLERED

Project Title
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Checker
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Author

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SF-501

VA FORM 08 - 6231

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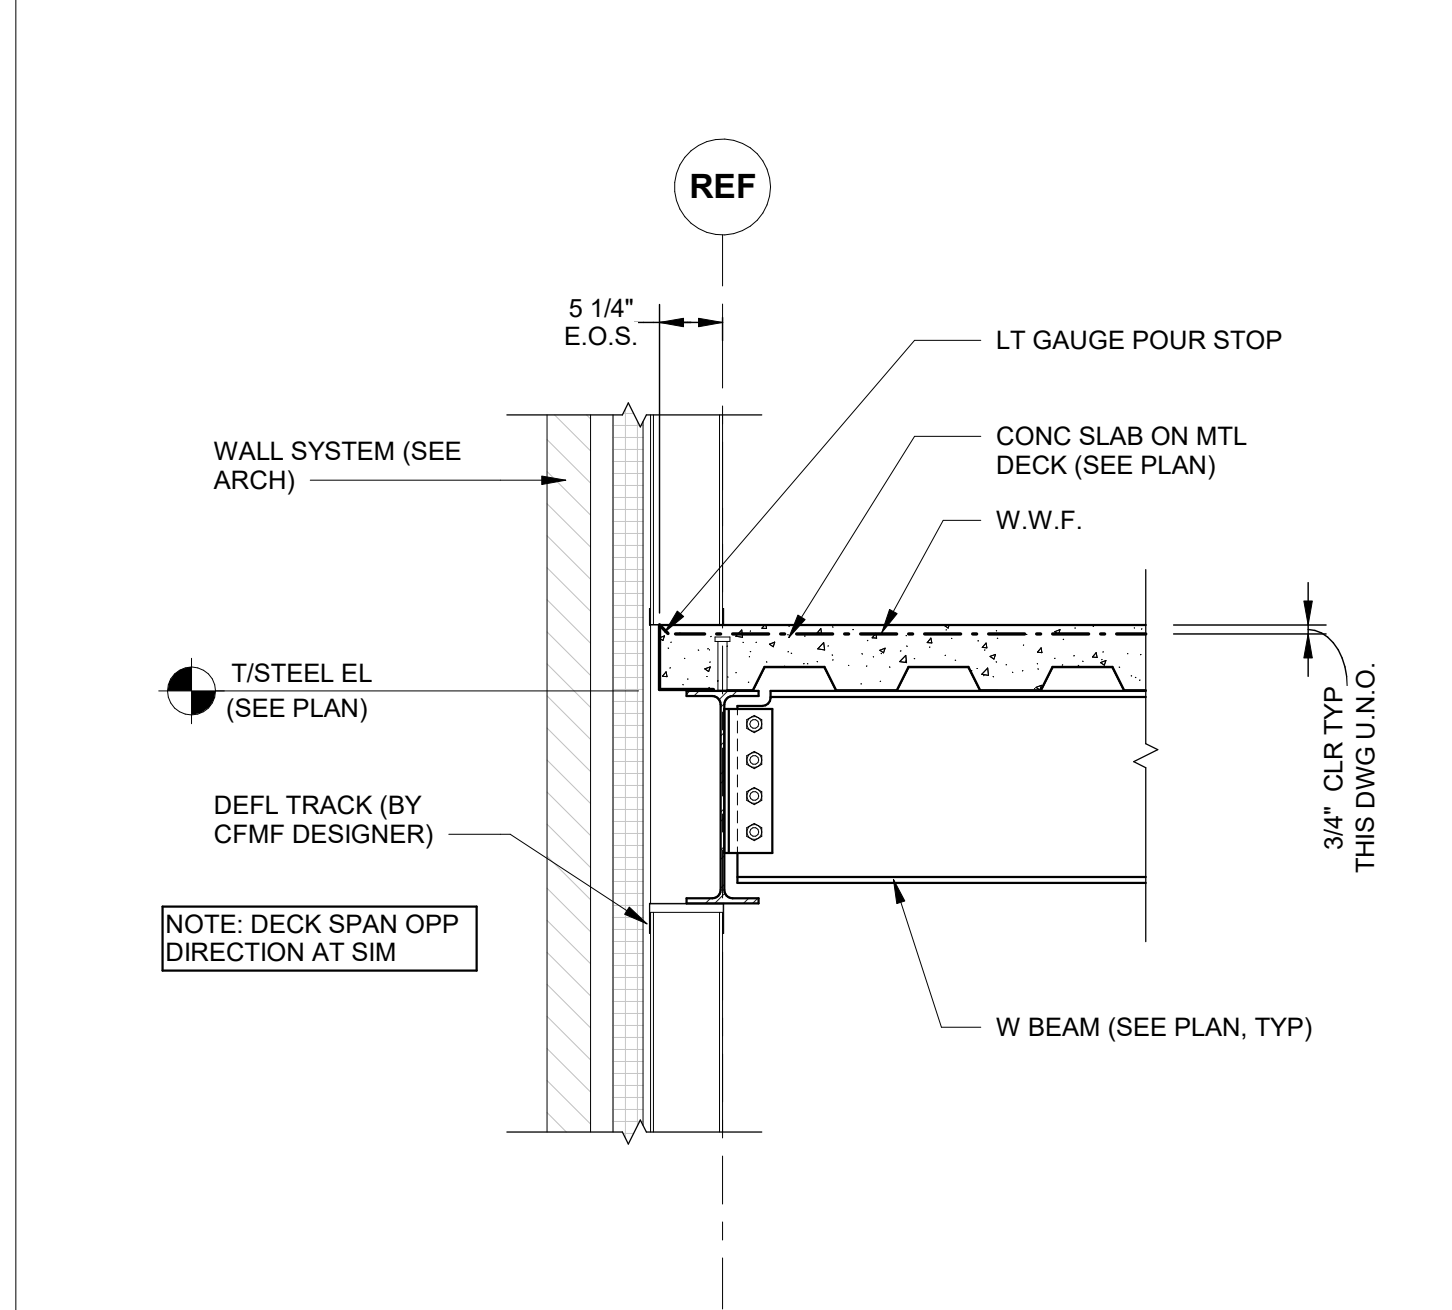
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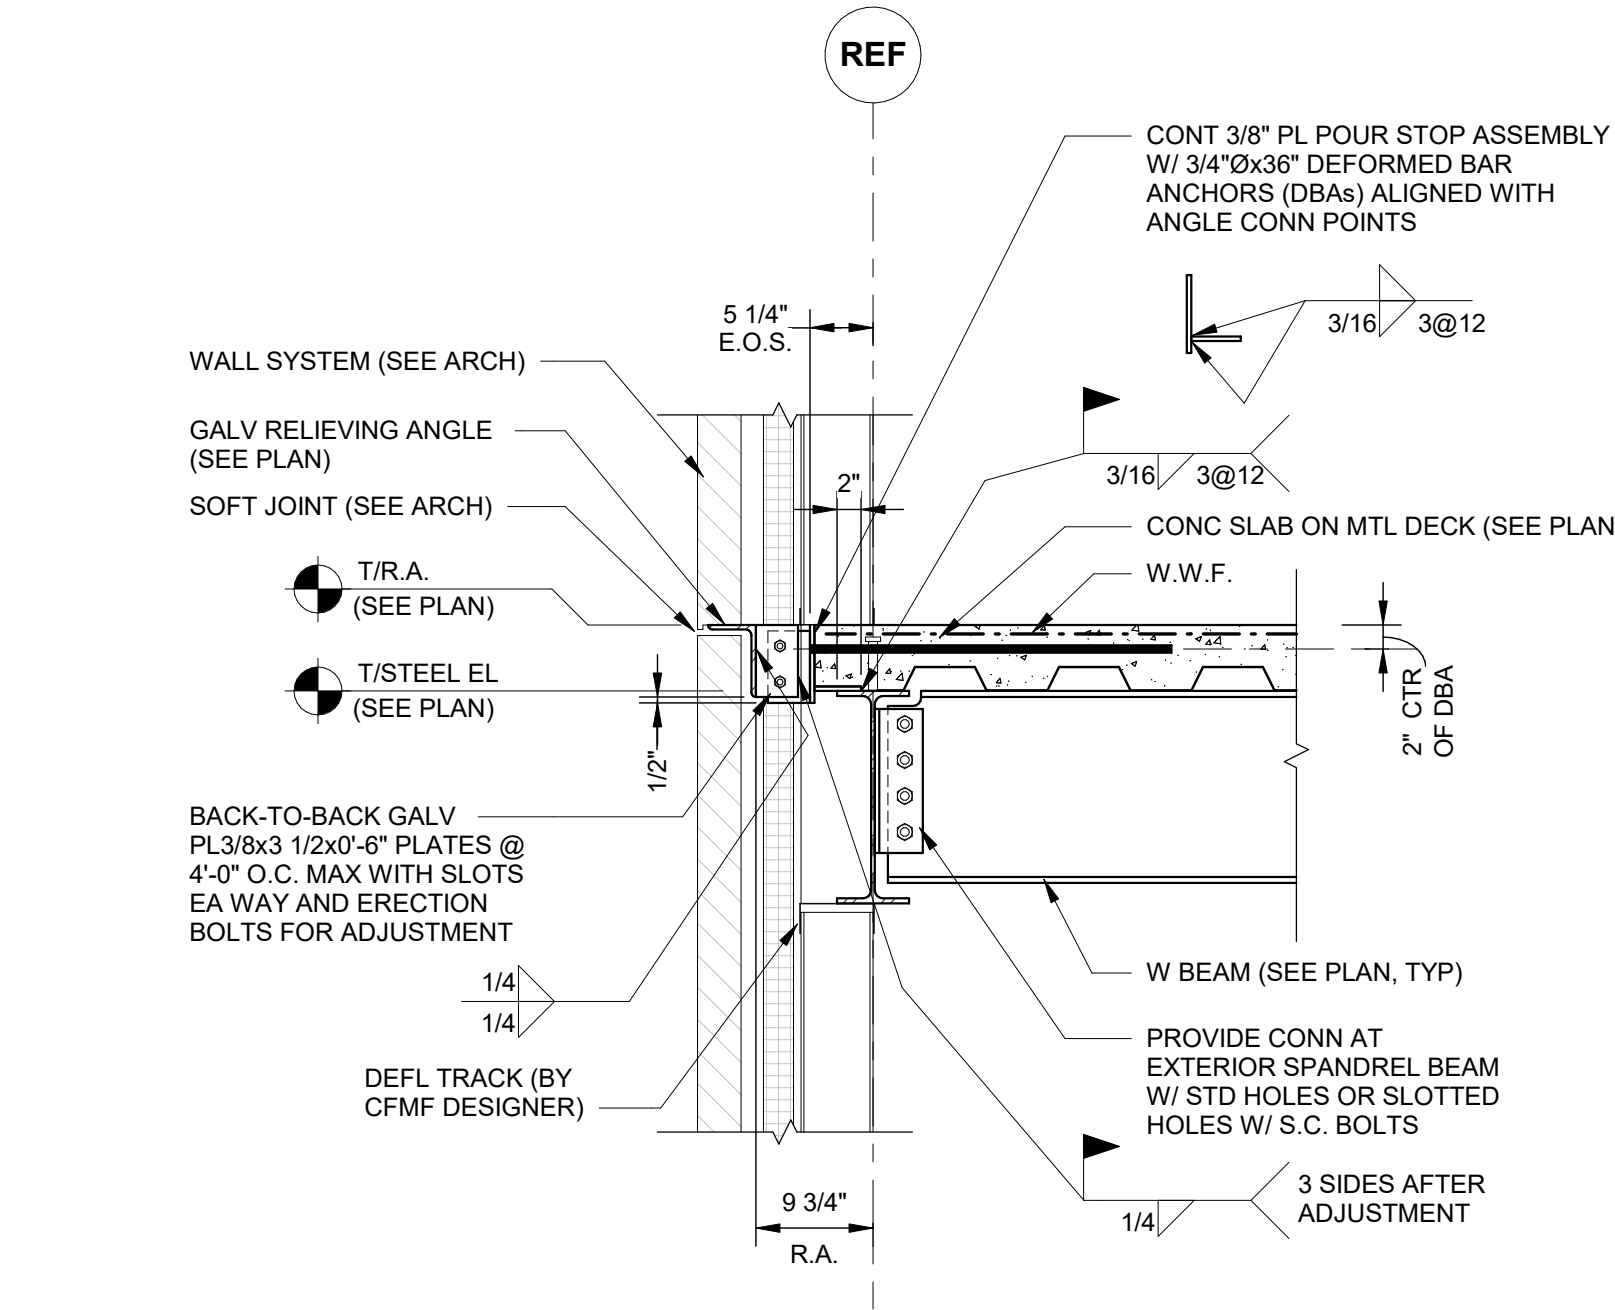
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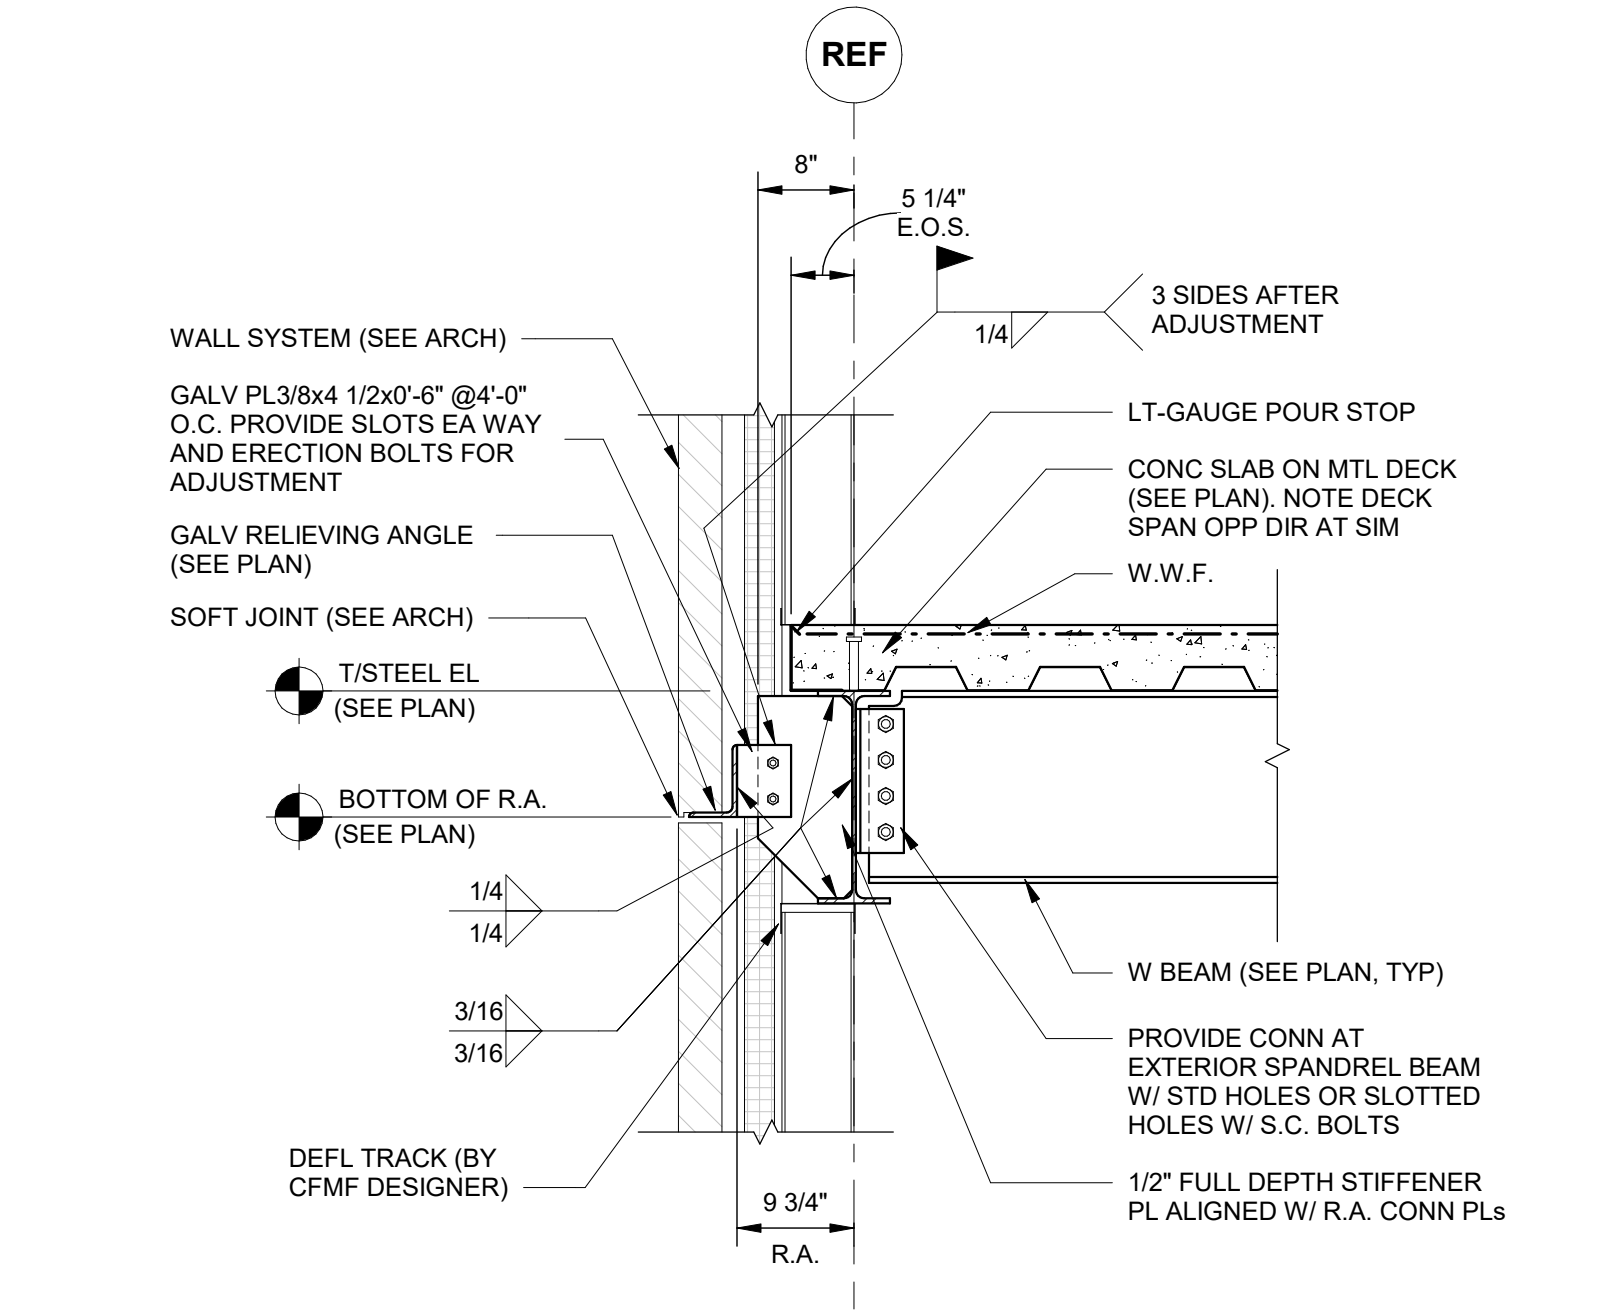
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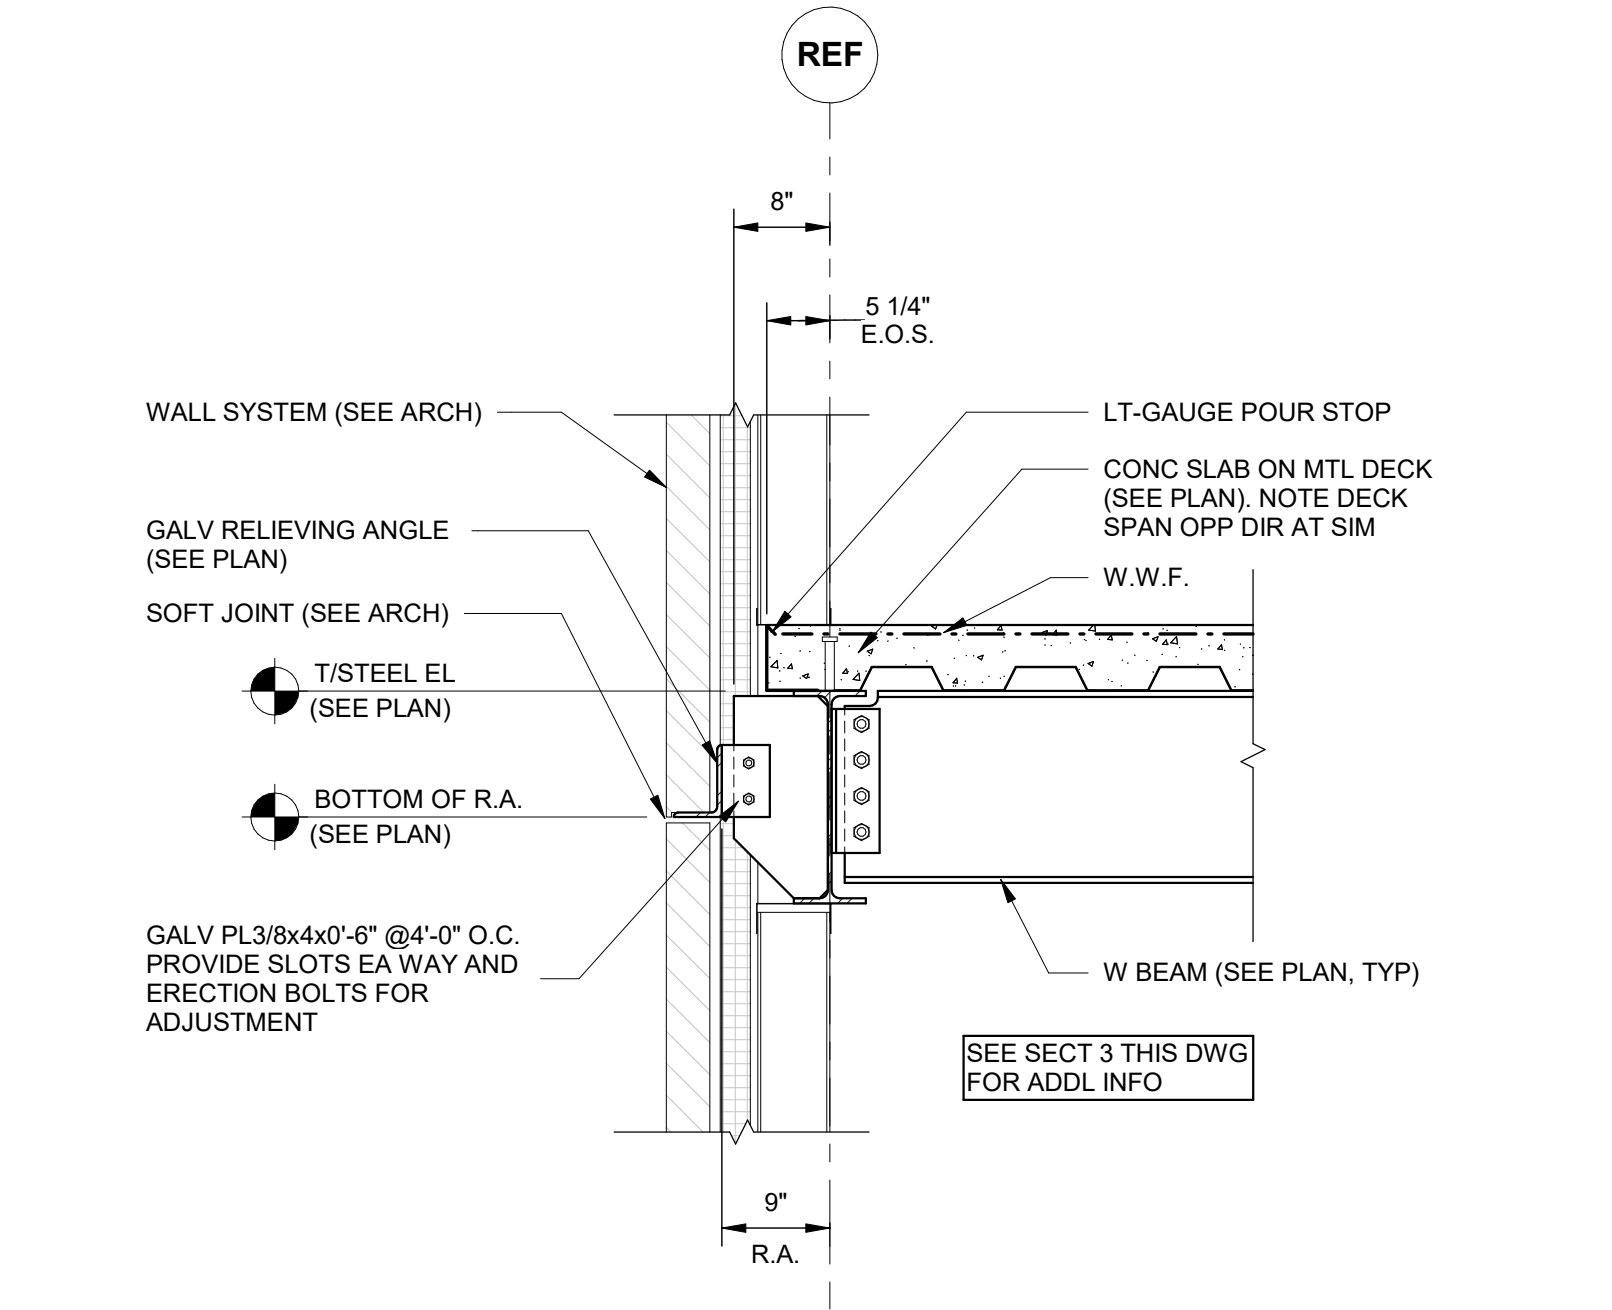
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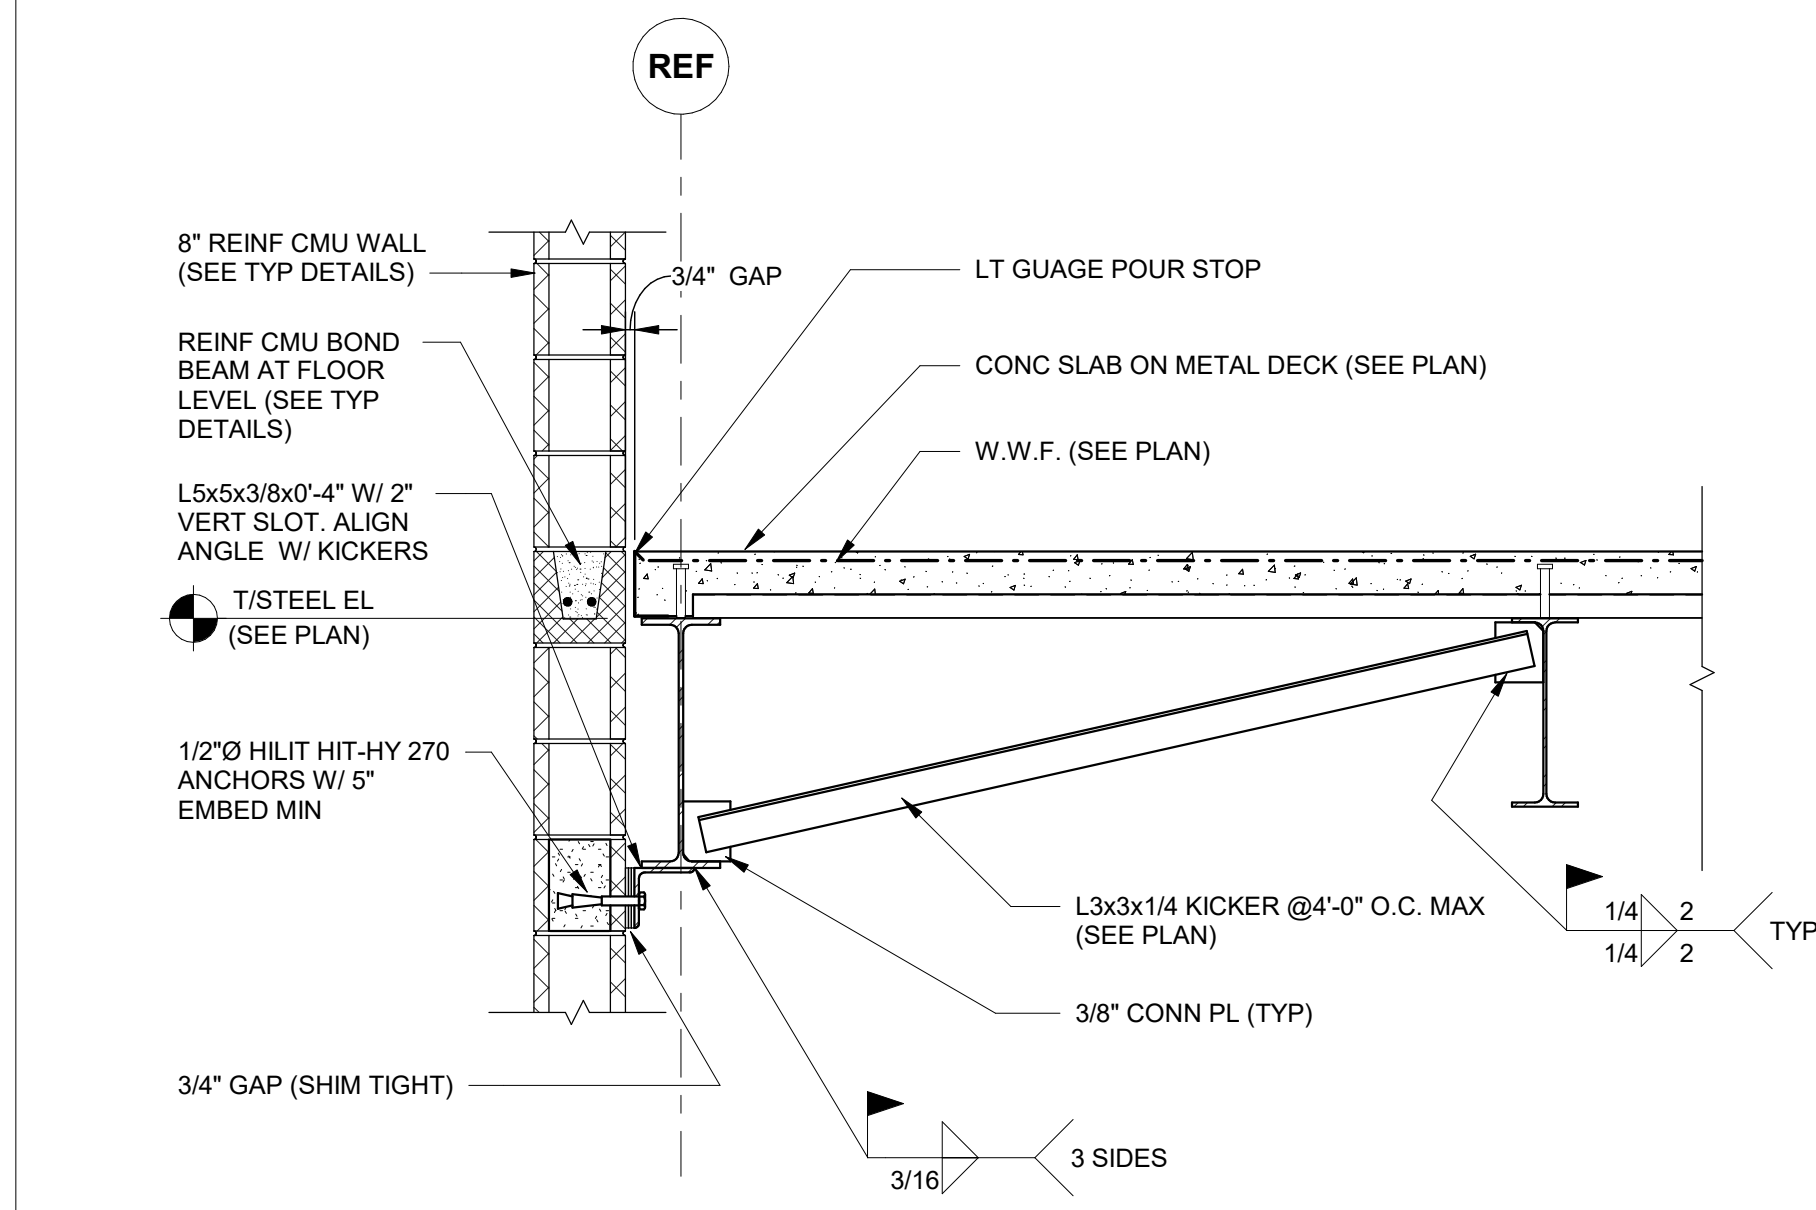
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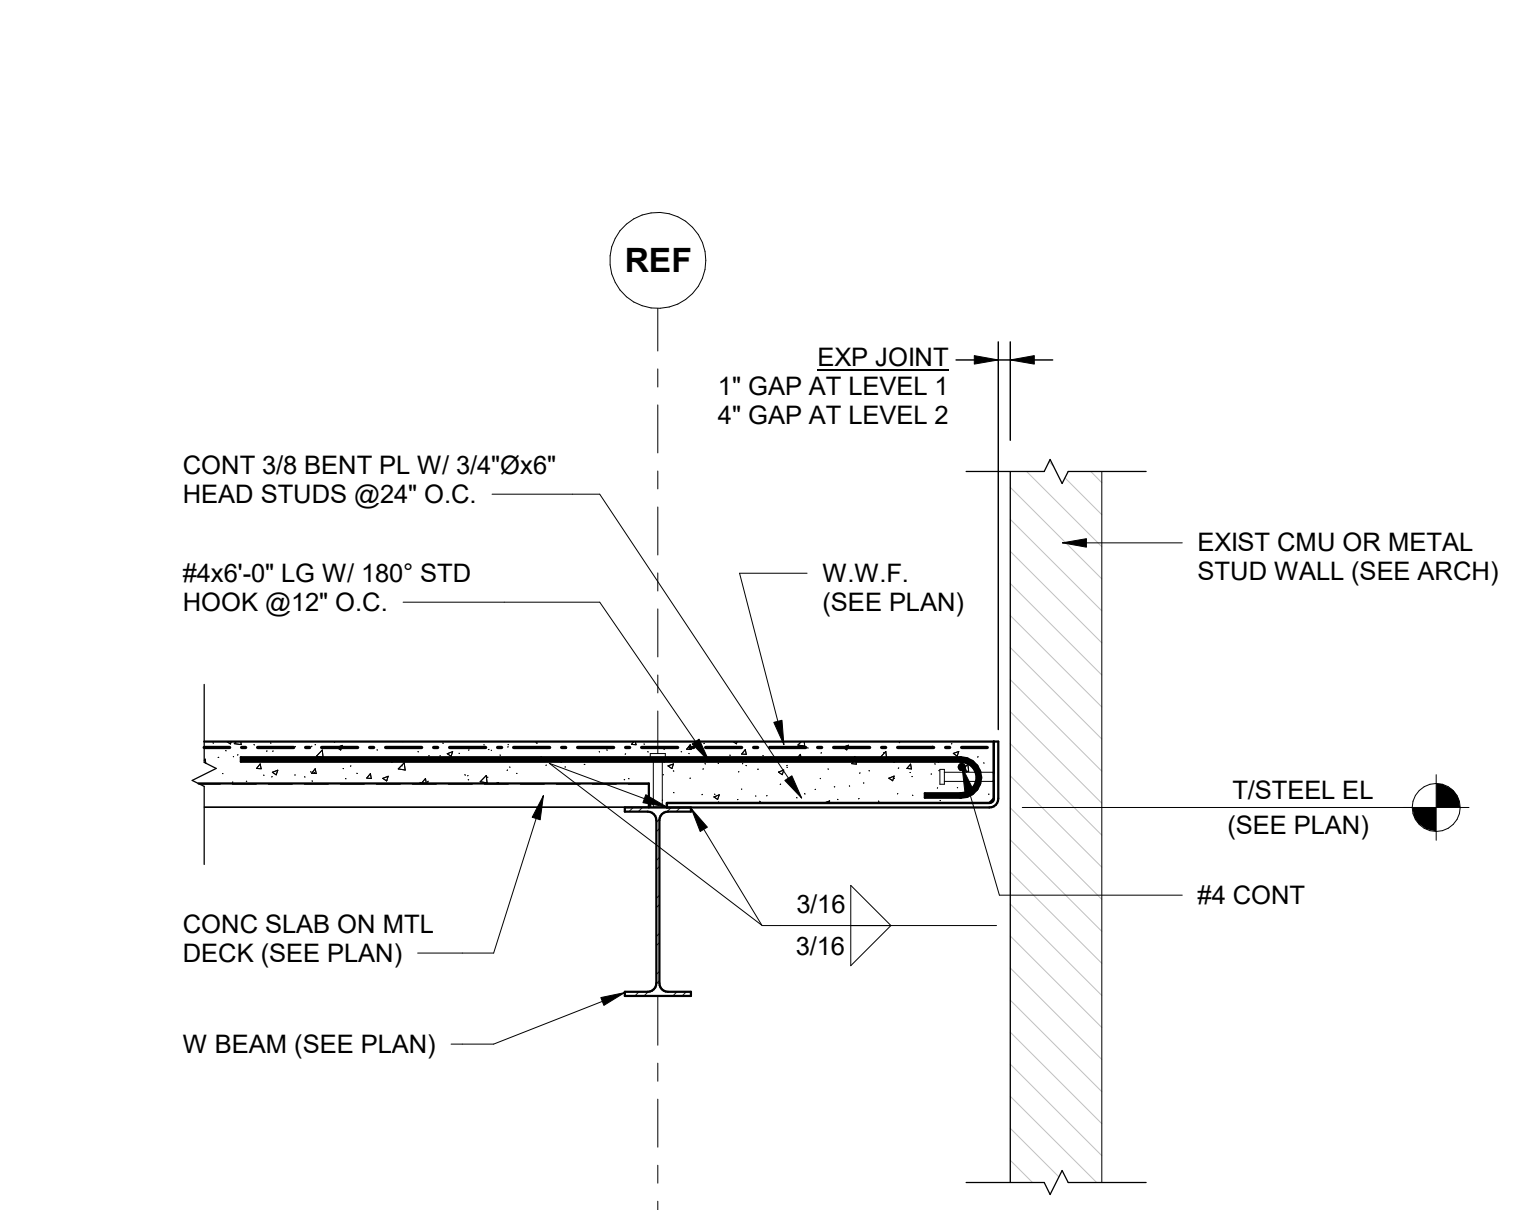
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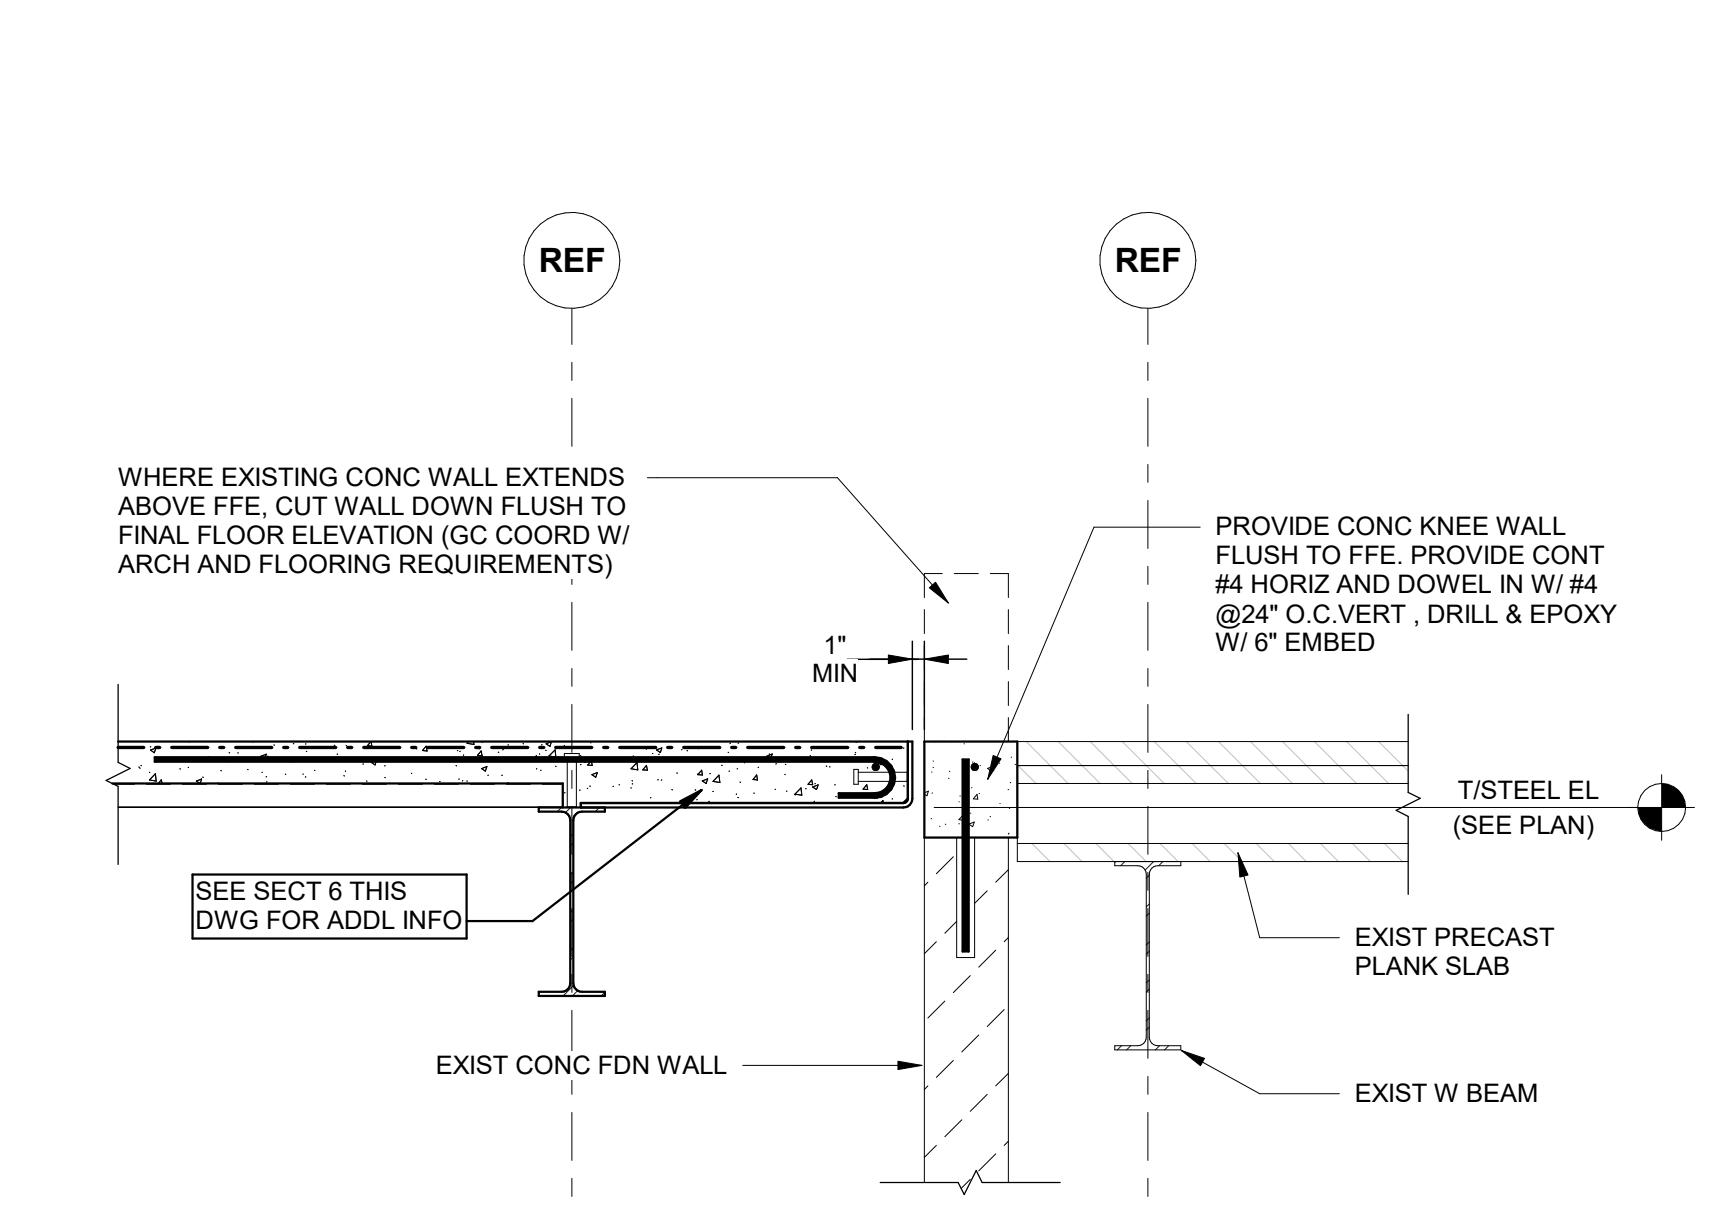
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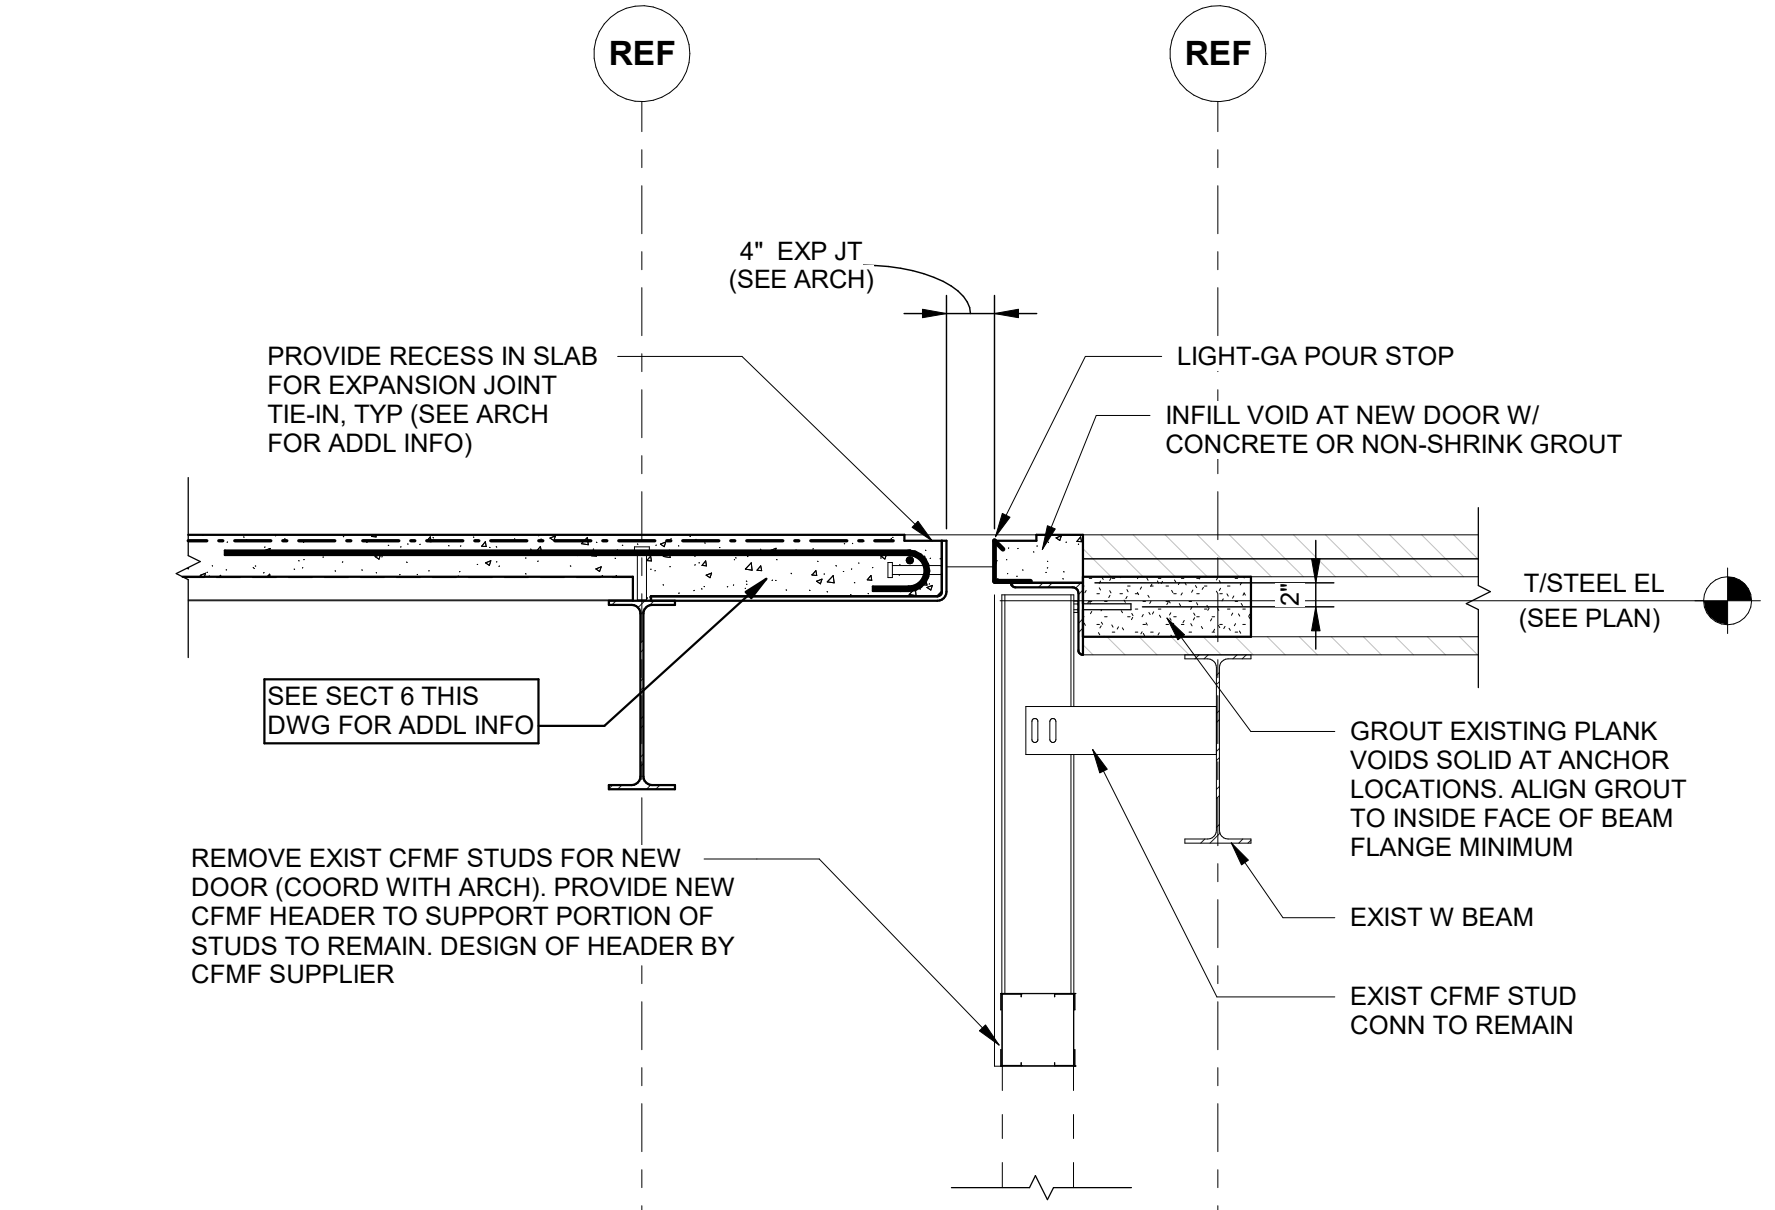
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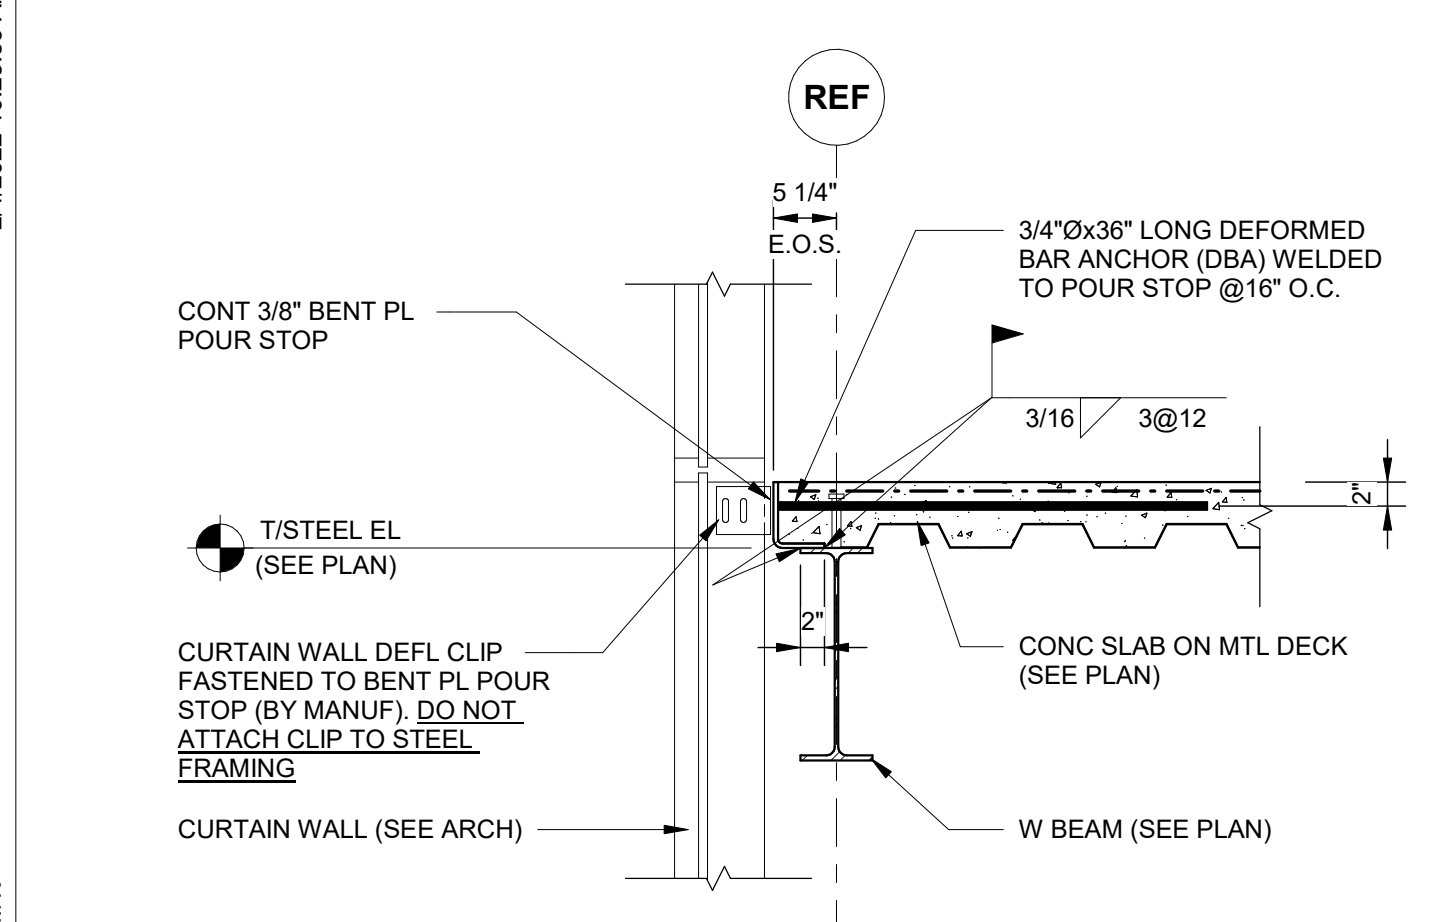
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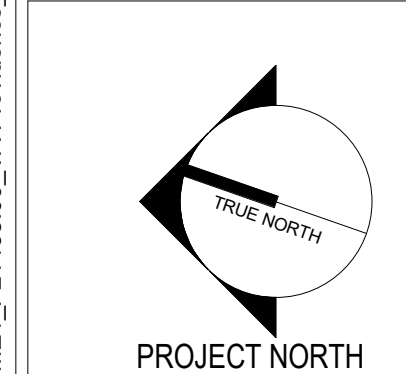
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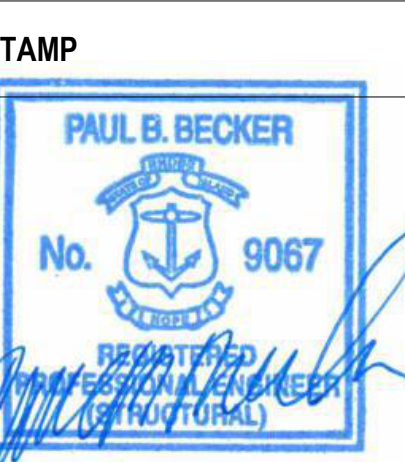
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Office of Construction and Facilities Management

VA U.S. Department of Veterans Affairs

Drawing Title

FRAMING SECTIONS & DETAILS

Approved:

VA RI FACILITIES MANAGEMENT SERVICE

Phase

CONSTRUCTION DOCUMENTS

FULLY SPRINKLERED

Project Title

NEW MENTAL HEALTH BUILDING - PHASE 2

Location

830 CHALKSTONE AVE PROVIDENCE, RI 02908

Issue Date

FEB 04 2022

Checked

CGW

Drawn

BSE

Project Number

650-347

Building Number

39

Drawing Number

SF-502

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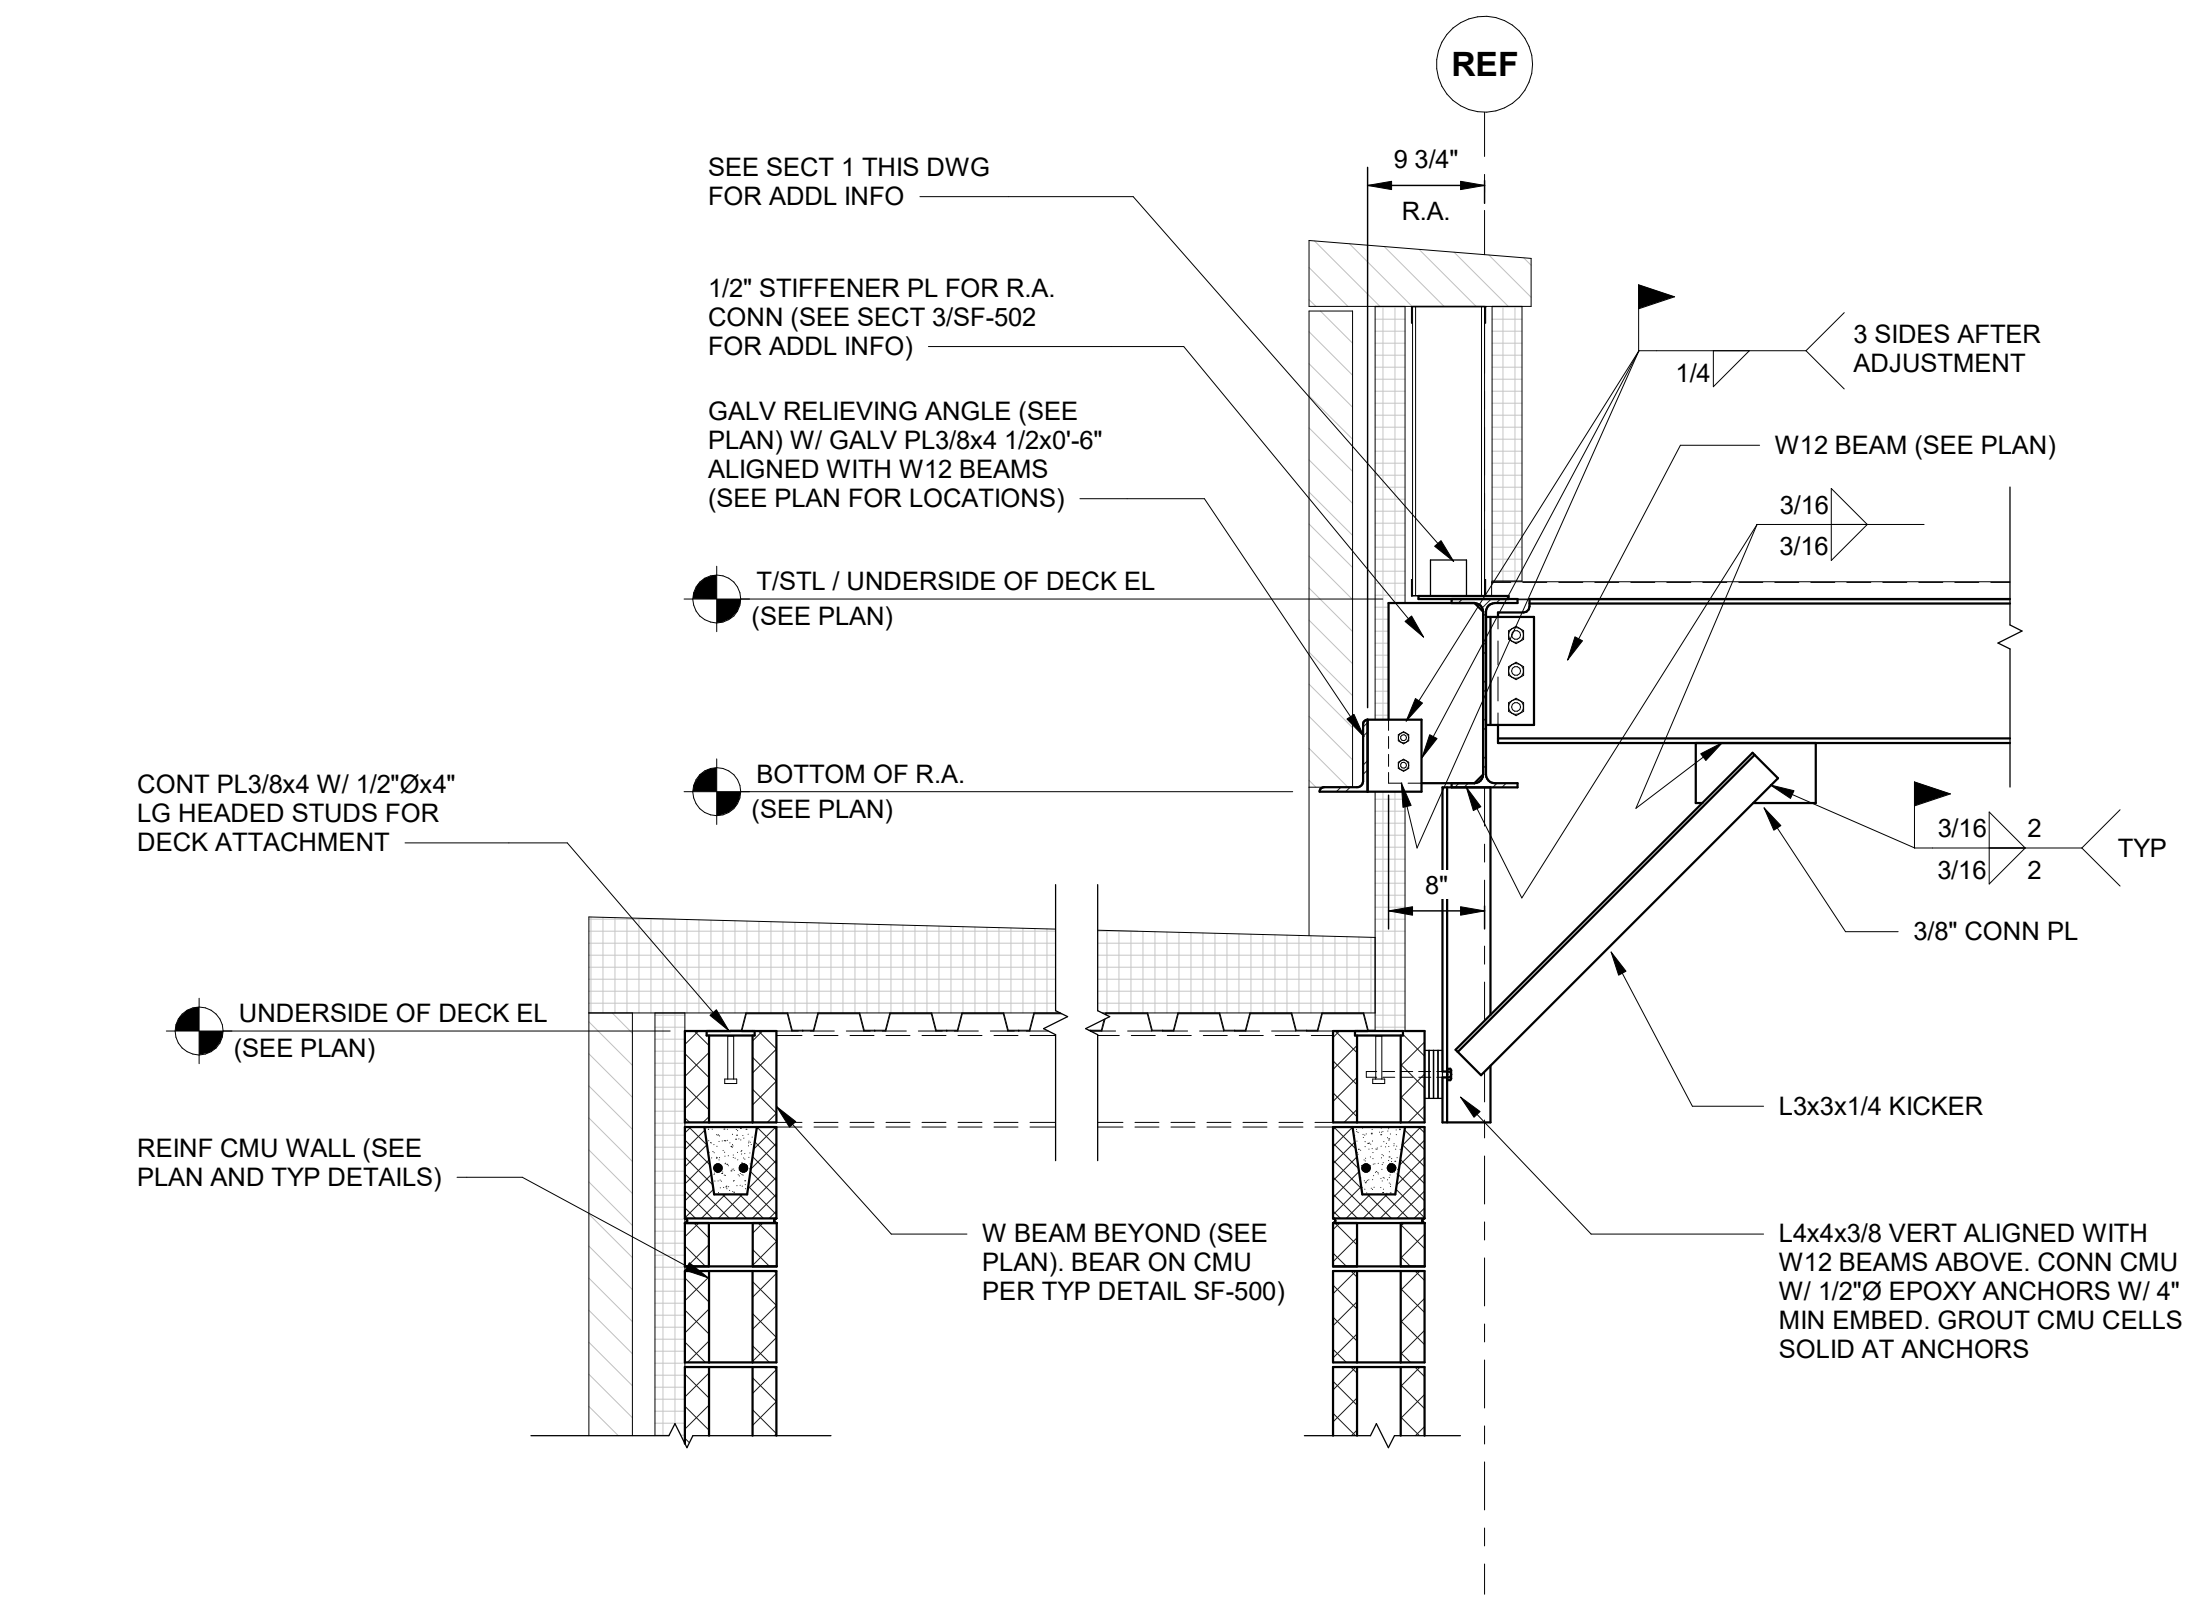
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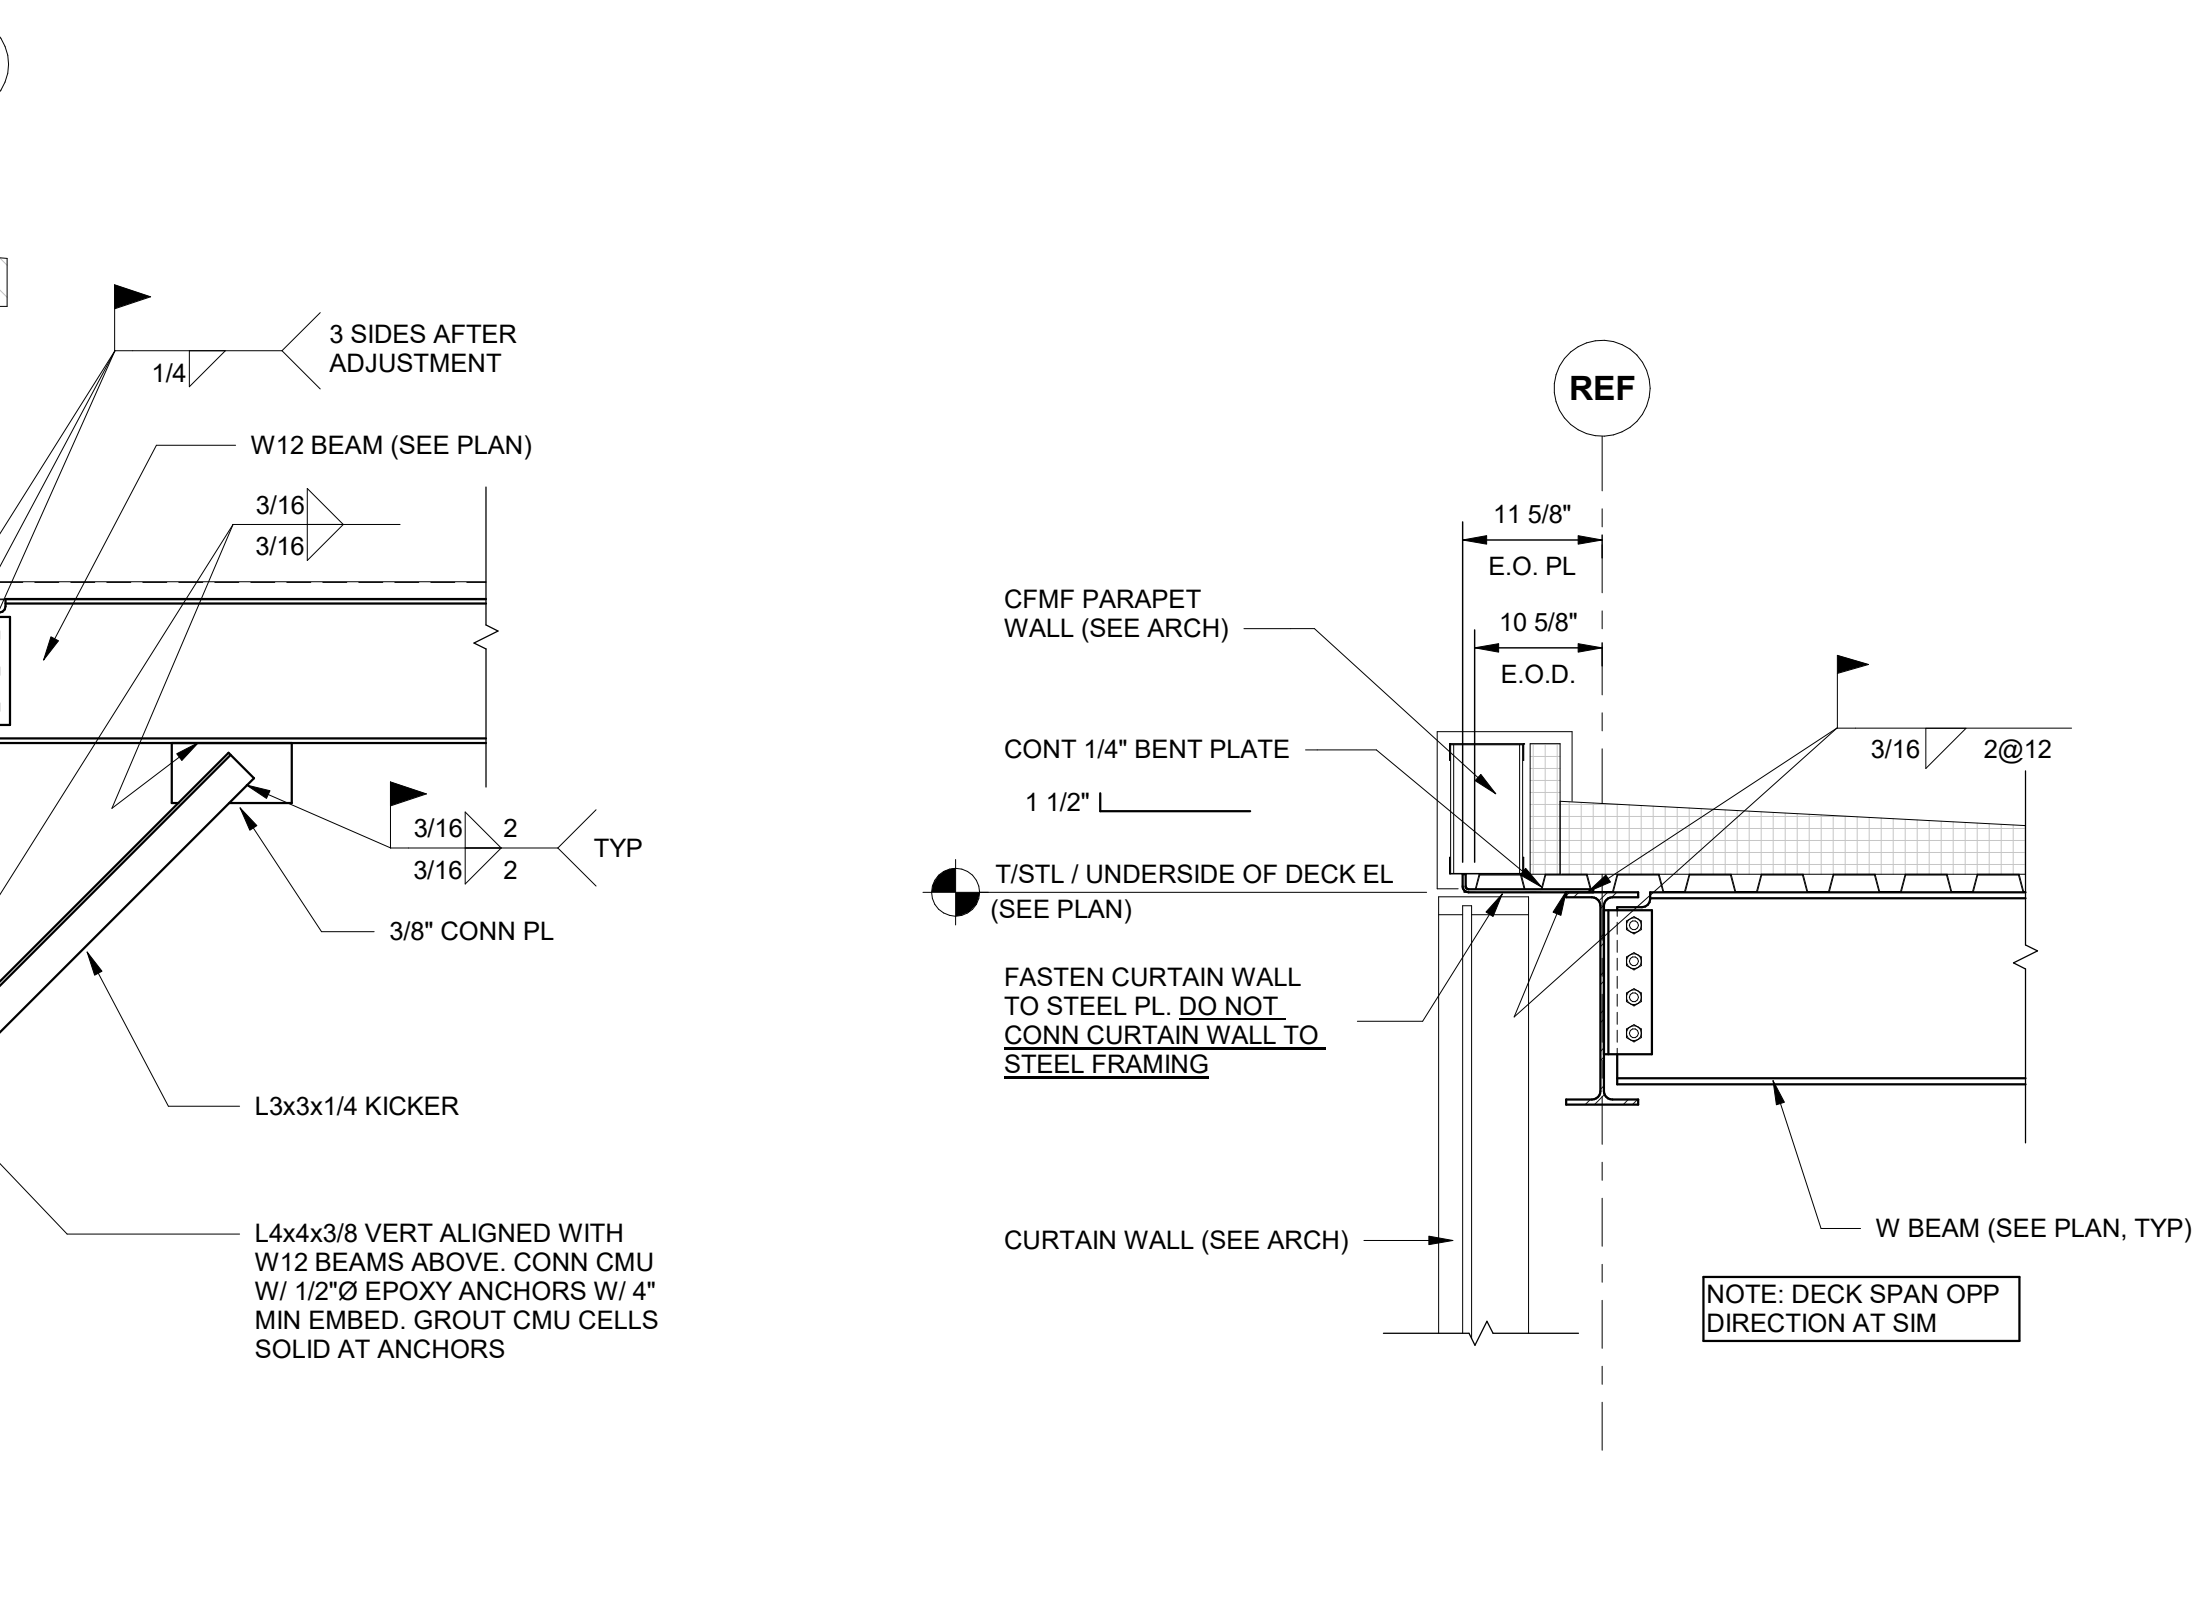
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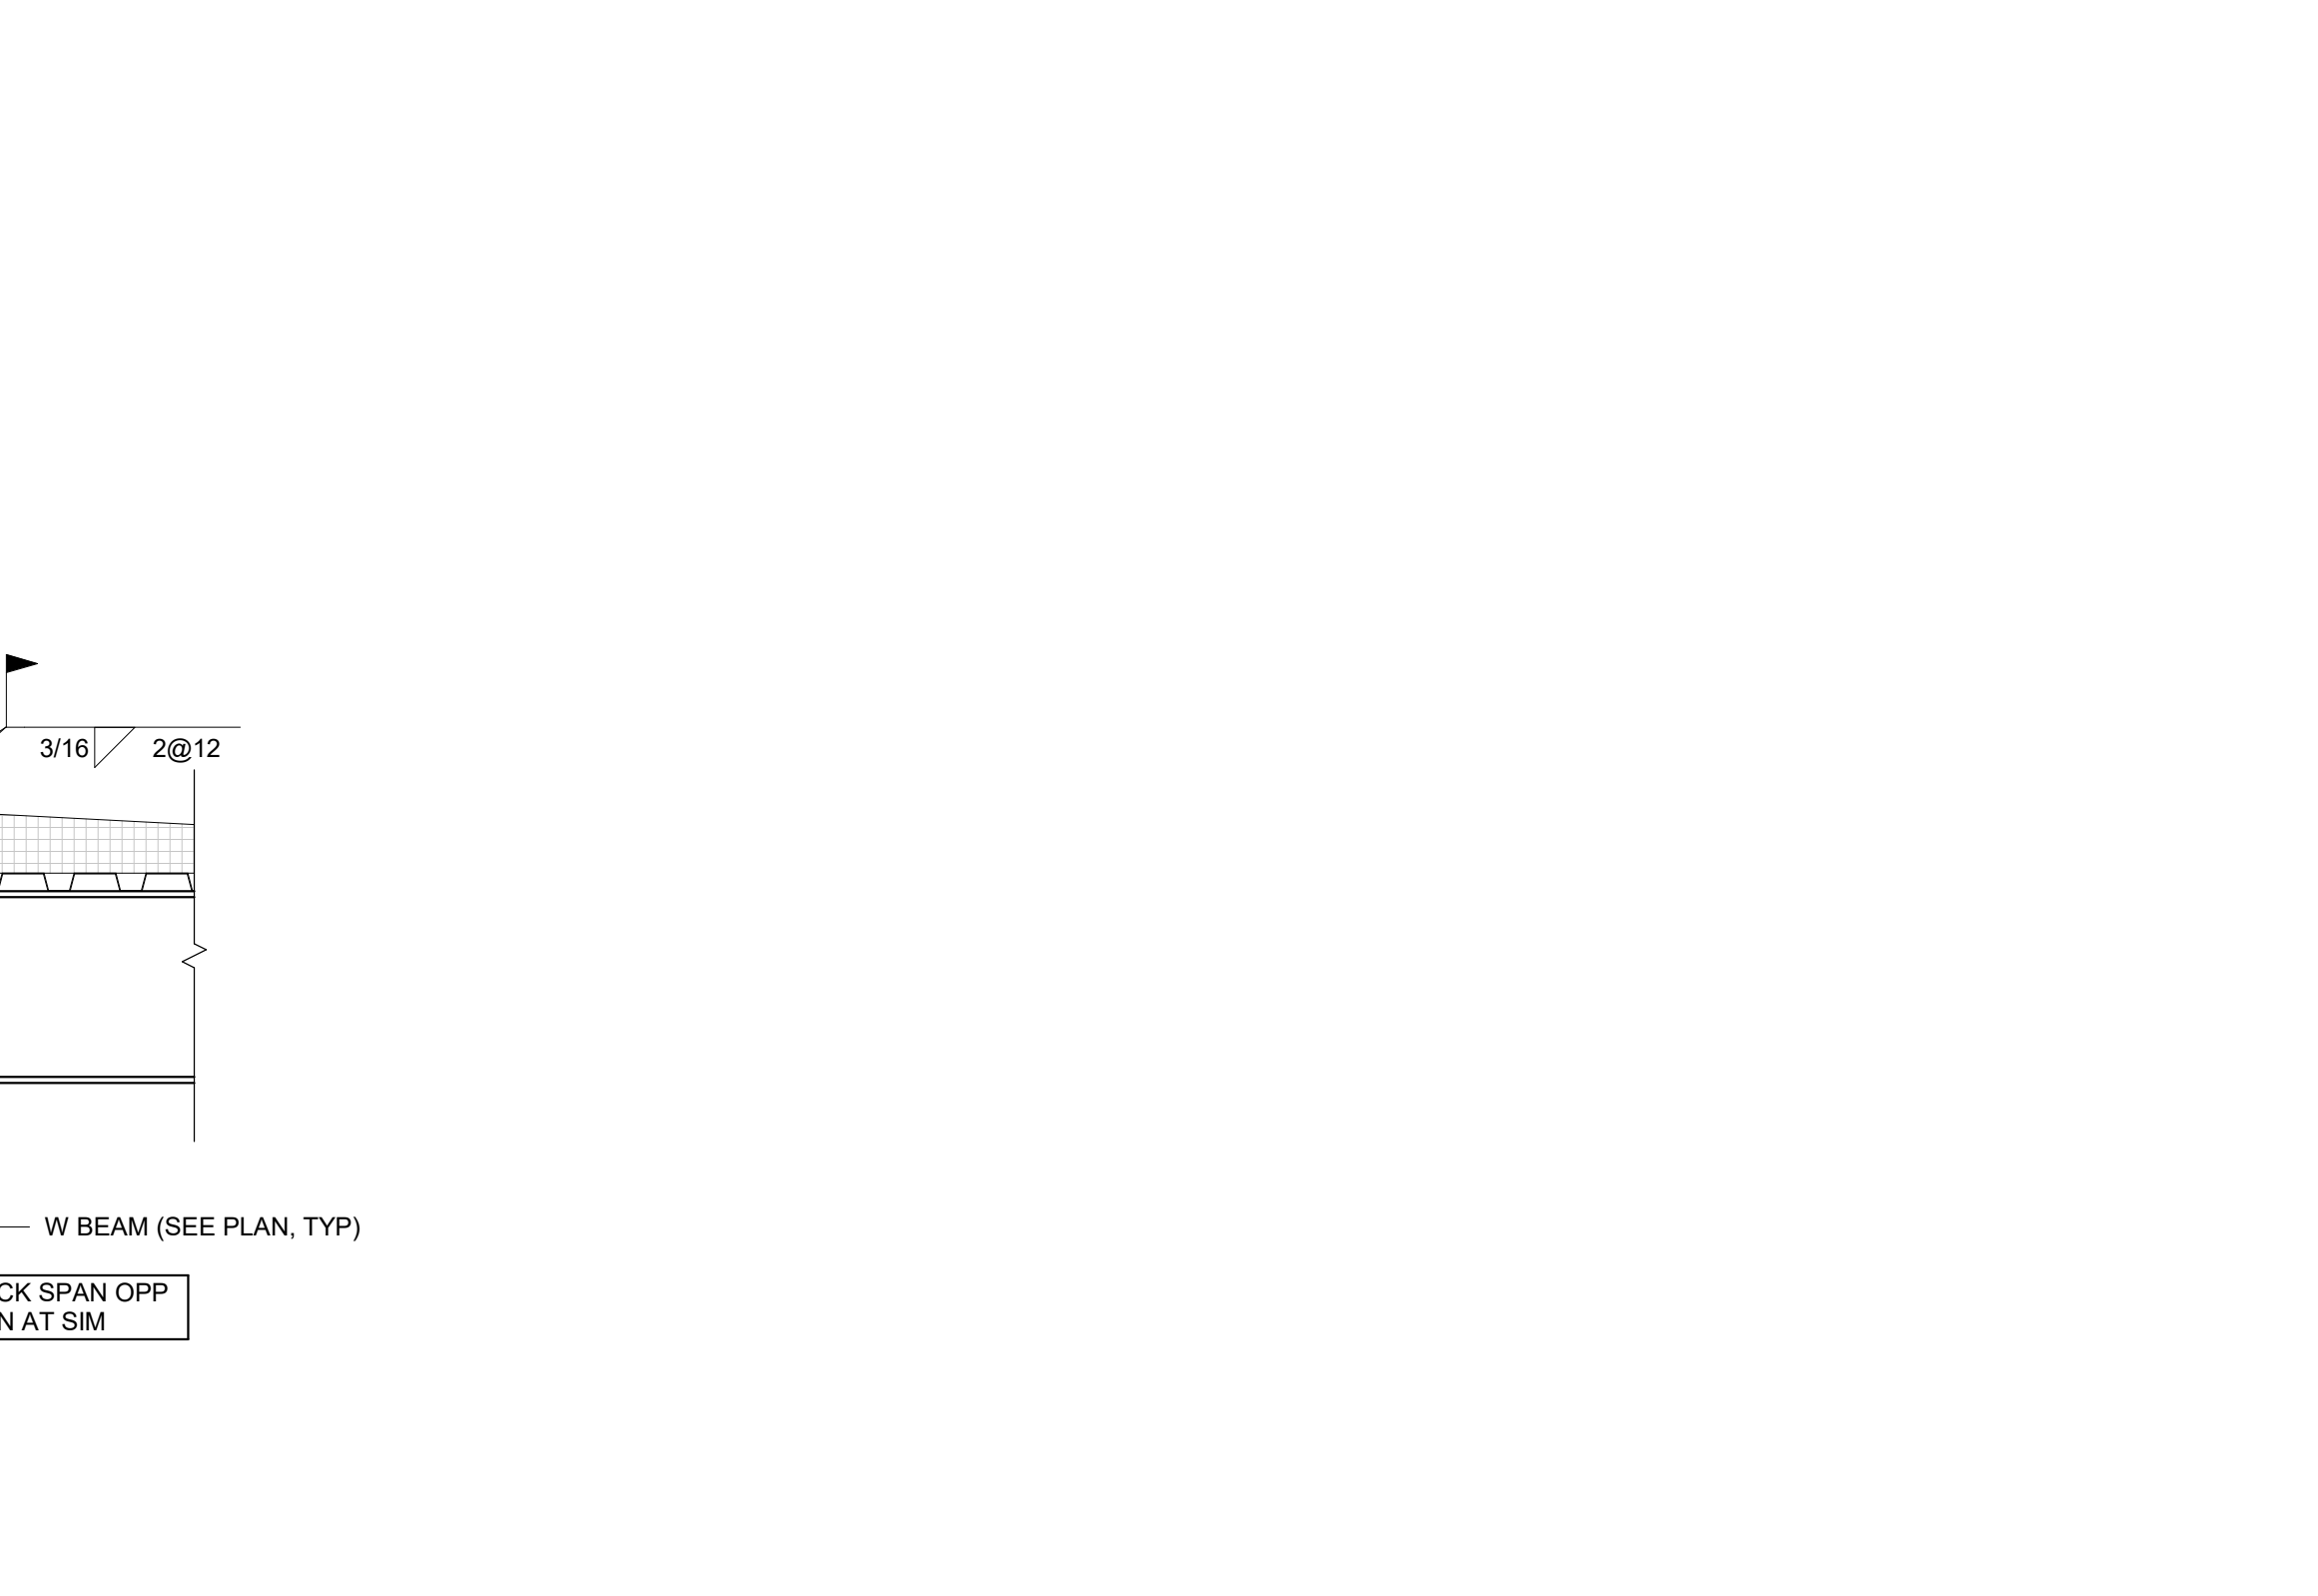
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