


ELECTRICAL SYMBOLOGY

-  MANHOLE
-  HANDHOLE
-  UNDERGROUND DUCTBANK CONSISTING OF FOUR 4" CONDUITS, UNLESS OTHERWISE NOTED.
-  ABOVE GROUND CONDUIT CONSISTING OF FOUR 4" CONDUITS, UNLESS OTHERWISE NOTED.


GENERAL NOTES

1. SCREENING OR SHADING OF WORK IS USED TO INDICATE EXISTING COMPONENTS OR TO DE-EMPHASIZE PROPOSED IMPROVEMENTS TO HIGHLIGHT SELECTED TRADE WORK. REFER TO CONTEXT OF EACH SHEET FOR USAGE.

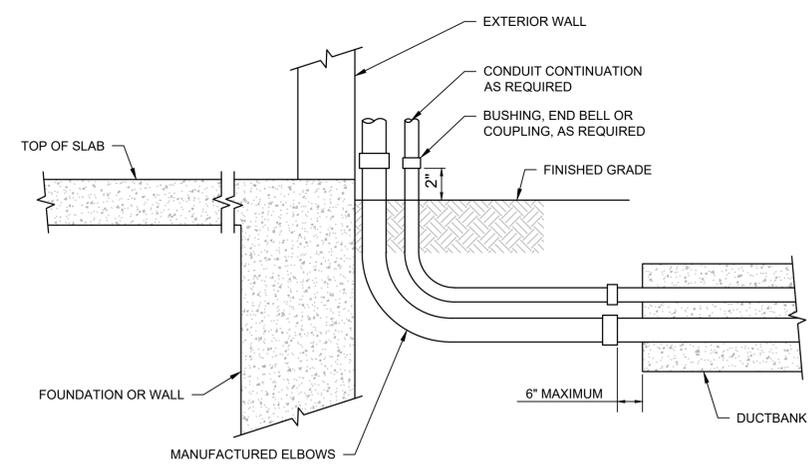


NOTE:
1. SEE DUCTBANK DETAIL FOR ADDITIONAL REQUIREMENTS.

1 CONDUIT TRANSITION TO ABOVE GRADE (EXTERIOR TO EXTERIOR)
NOT TO SCALE

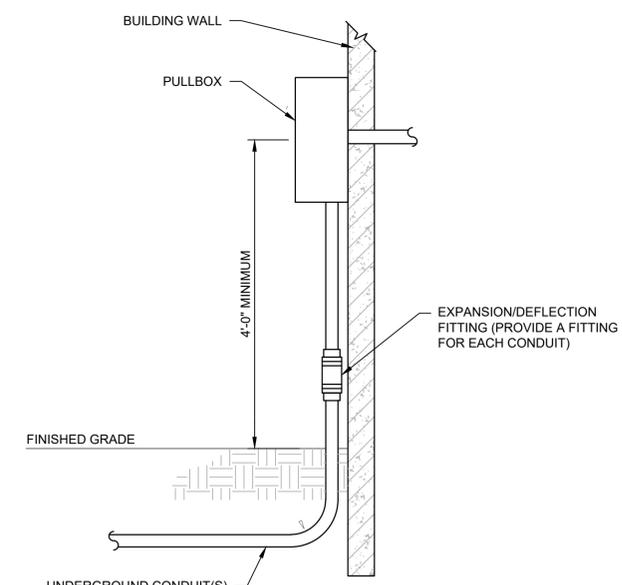

NOTE:
1. CONCRETE ENCASUREMENT IF REQUIRED, IS NOT SHOWN. SEE SITE PLAN FOR ENCASUREMENT OR DIRECT BURIED.

2 UNDERGROUND CONDUIT-BUILDING-ENTRY
NOT TO SCALE

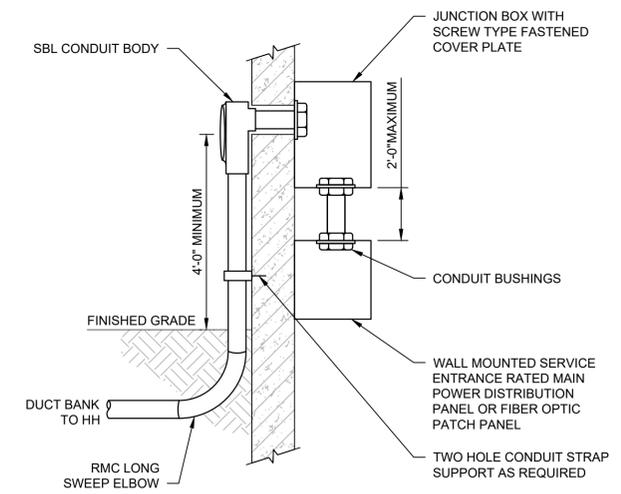

3 ABOVE GRADE FACILITY ENTRANCE DETAIL
NOT TO SCALE



ISSUE	DATE	DESCRIPTION
-	MARCH 2022	B-3 DESIGN SUBMITTAL

PROJECT MANAGER DEREK WORLEY	
DESIGNED BY:	ED CHINNIS
DRAWN BY:	JEREMY FORREST
CHECKED BY:	JIM ZAVADIL
CONTRACT #:	W9133L-15-D-0004
ANG PROJECT #:	FJRP182510
HDR PROJECT #:	10226692



EXTEND COMMUNICATIONS DUCT BANK
NC AIR NATIONAL GUARD
145TH AIRLIFT WING
CHARLOTTE, NC

CHARLOTTE AIR NATIONAL GUARD BASE ELECTRICAL LEGEND & GENERAL NOTES

0 1" 2" FILENAME | E-001.DWG
SCALE | NONE SHEET | E-001



OVERALL ELECTRICAL SITE PLAN

1" = 150'



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 ANG PROJECT #: FJRP182510
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**EXTEND
 COMMUNICATIONS DUCT
 BANK**


**NC AIR NATIONAL GUARD
 145TH AIRLIFT WING
 CHARLOTTE, NC**

**CHARLOTTE AIR NATIONAL GUARD BASE
 OVERALL ELECTRICAL SITE
 PLAN**



FILENAME | E-101.DWG
 SCALE | 1" = 150'


SHEET
E-101

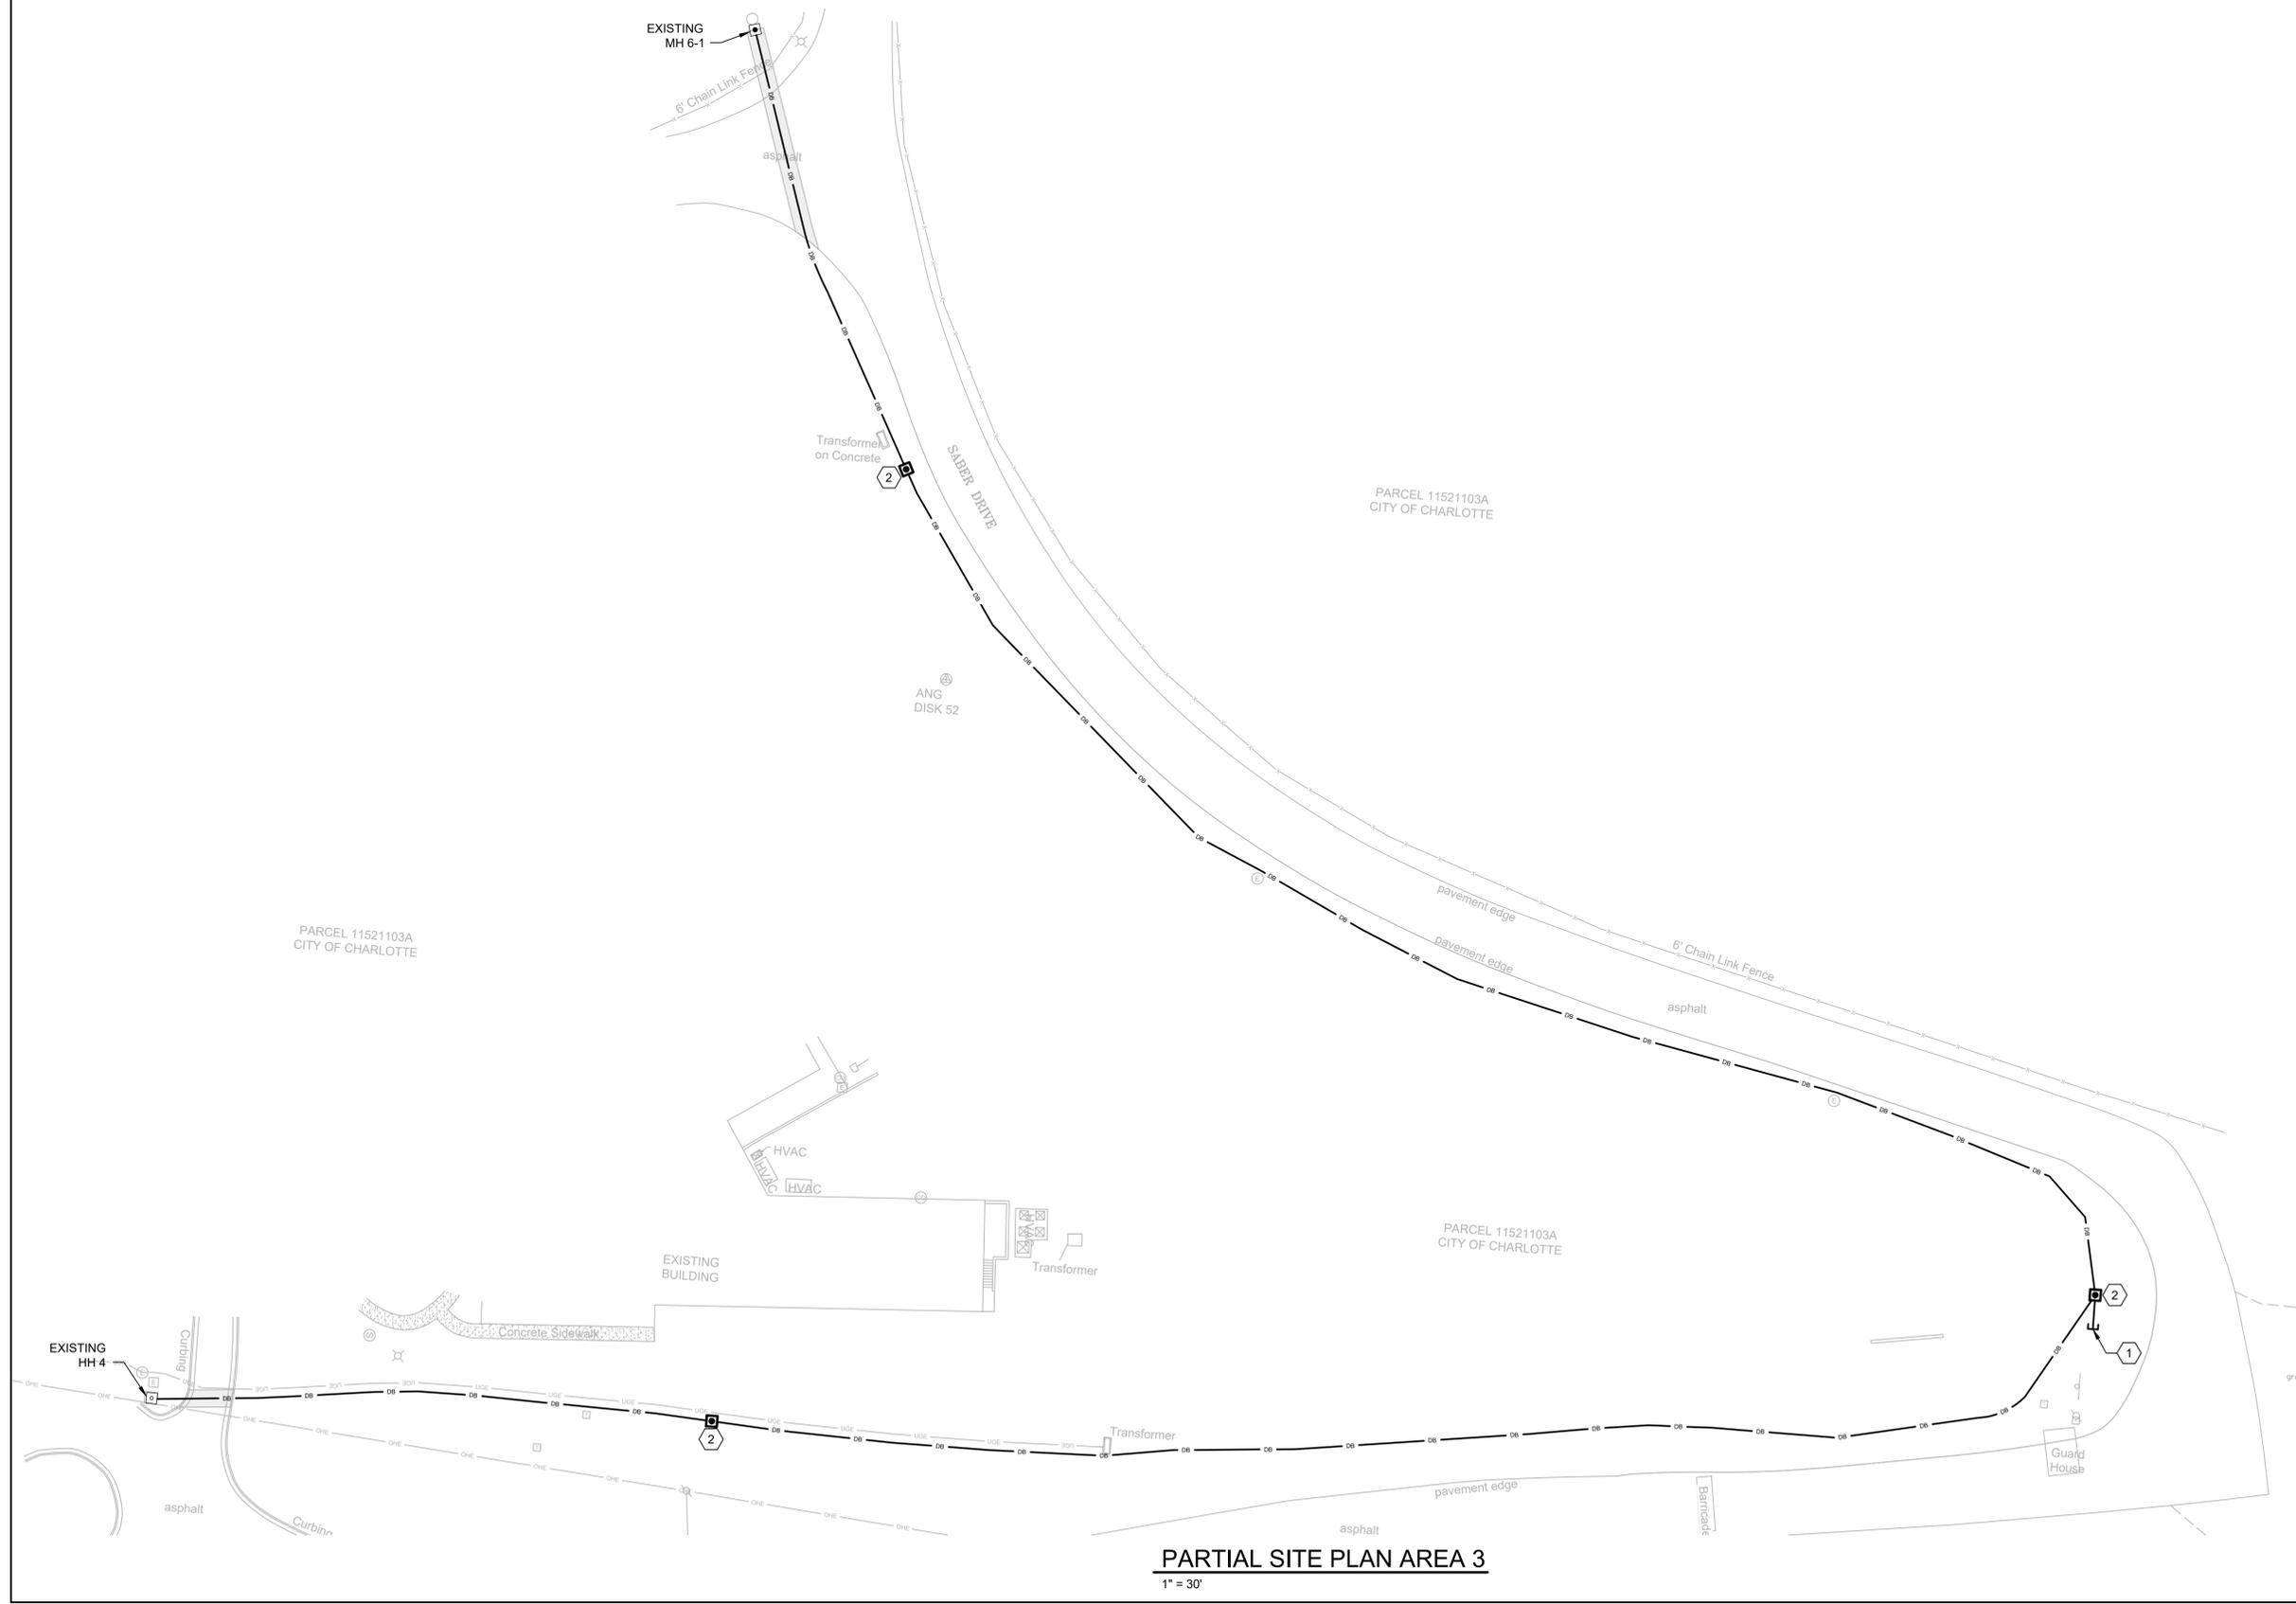

- GENERAL NOTES:**
- COORDINATE ALL UNDERGROUND STRUCTURES AND UTILITIES PRIOR TO BEGINNING WORK.
 - COMMUNICATION CONDUIT BENDS TO BE PROVIDED IN ACCORDANCE WITH SPECIFICATION 33 71 02, SECTION 3.4.1b.
 - NO SECTION OF COMMUNICATION CONDUIT TO CONTAIN MORE THAN TWO 90 DEGREE BENDS OR EQUIVALENT BETWEEN PULL POINTS.
 - INSTALL MAINTENANCE (MAN/HAND) HOLES WHERE CONDUIT SECTION LENGTH EXCEEDS 400FT.
 - UNDERGROUND CONDUITS TO BE INSTALLED SO THAT A SLOPE EXIST AT ALL POINTS OF THE RUN TO ALLOW DRAINAGE AND PREVENT ACCUMULATION OF WATER. SLOPE SLEEVES DOWNWARD 0.125IN/FT AWAY FROM BUILDING.
 - ENCASE UNDERGROUND CONDUITS IN A MINIMUM OF 3" OF CONCRETE.
 - INSTALL TWO 3-CELL FABRIC INNER DUCTS IN EACH CONDUIT THAT IS DESIGNATED FOR FIBER CABLES. INSTALL A PULL WIRE INSIDE EACH OF THE INNERDUCTS.
 - REINFORCE CONCRETE ENCASED DUCTBANK TO BE PROVIDED UNDER ROADS AND PAVED AREAS SUBJECT TO VEHICLE TRAFFIC.

- KEYNOTES:** (#)
- TYPICAL - PROVIDE CONDUIT STUBBED OUT AT EACH MANHOLE THAT IS INTENDED TO SERVE FUTURE BUILDINGS.
 - NEW MANHOLE. REFER TO DETAIL 1 ON SHEET E-501 FOR DETAILS.

PARTIAL SITE PLAN AREA 3
1" = 30'

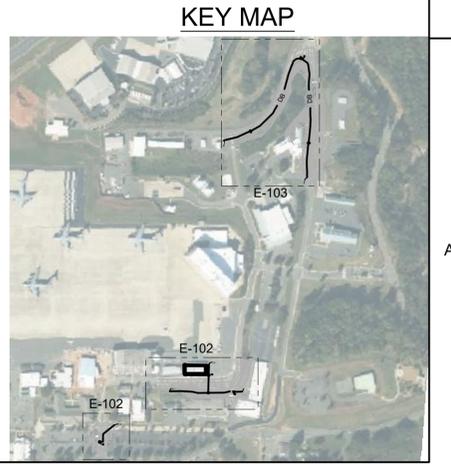


ISSUE	DATE	DESCRIPTION
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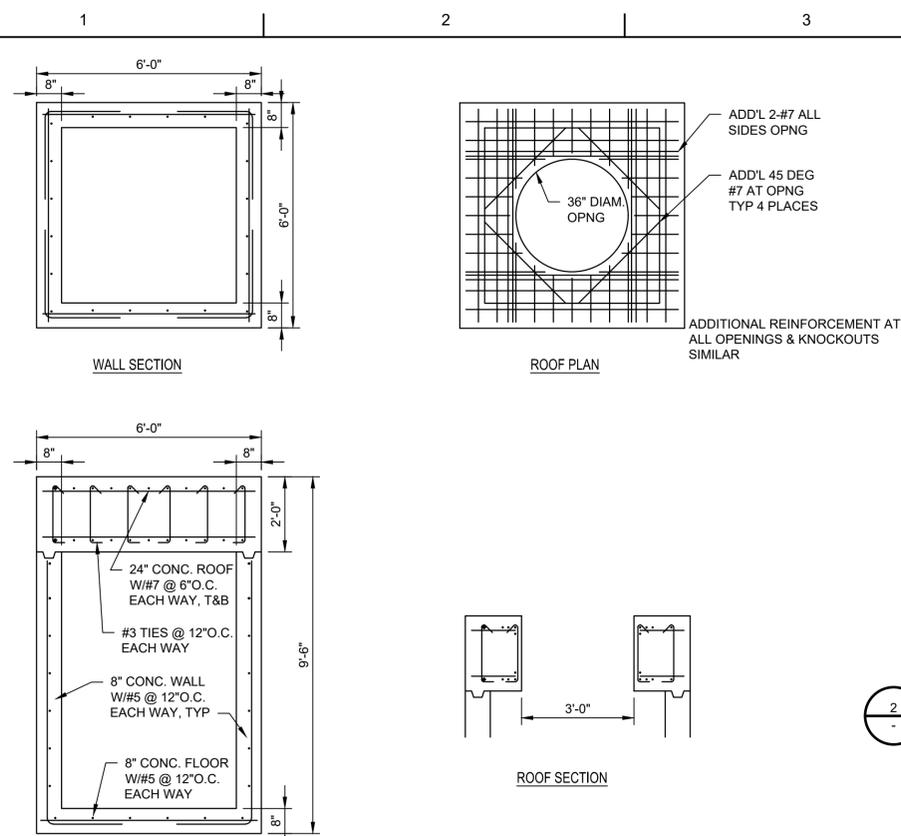
EXTEND COMMUNICATIONS DUCT BANK
NC AIR NATIONAL GUARD
145TH AIRLIFT WING
CHARLOTTE, NC

CHARLOTTE AIR NATIONAL GUARD BASE
PARTIAL ELECTRICAL SITE PLAN 2




FILENAME | E-103.DWG
SCALE | 1" = 30'

SHEET
E-103

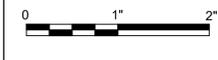


1 TELECOM MANHOLE DETAIL
NOT TO SCALE

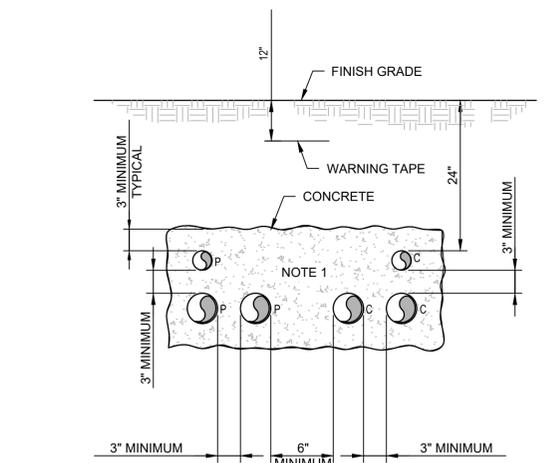


- NOTES:**
- NUMBER OF CONDUITS AS REQUIRED FOR THE APPLICATION.
 - "P" SUBSCRIPT ELECTRICAL POWER OR CONTROL CONDUIT.
 - "C" SUBSCRIPT COMMUNICATION (TELEPHONE, DATA, INSTRUMENTATION) CONDUIT.

4 CONCRETE ENCASED DUCTBANK
NOT TO SCALE

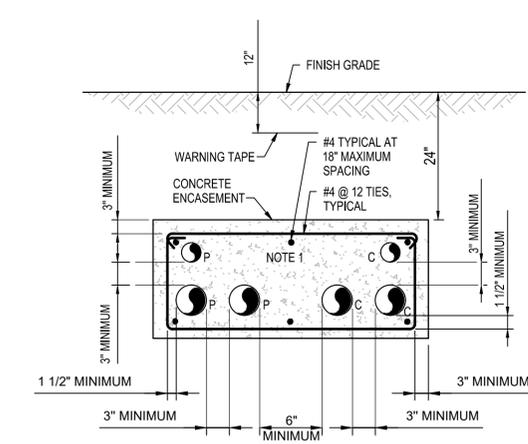

- NOTES:**
- NUMBER OF CONDUITS AS REQUIRED FOR THE APPLICATION.
 - "P" SUBSCRIPT ELECTRICAL POWER OR CONTROL CONDUIT.
 - "C" SUBSCRIPT COMMUNICATION (TELEPHONE, DATA, INSTRUMENTATION) CONDUIT.


2 REINFORCED CONCRETE ENCASED DUCTBANK SECTION
NOT TO SCALE

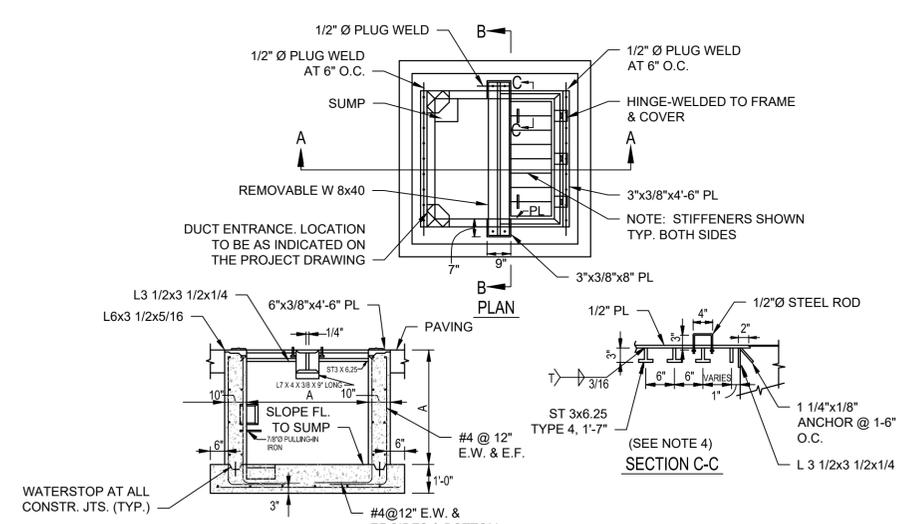


- NOTES:**
- ENTRANCE OF DUCTS INTO HANDHOLE MAY BE MADE ON SIDE FACES OR CORNERS AS REQUIRED.
 - FOR DETAILS OF CABLE RACKS, DUCT ENTRANCE AND PULLING-IN IRONS, SEE DETAIL 6 THIS SHEET.
 - HANDHOLE AND COVER IS DESIGNED FOR MAXIMUM SINGLE WHEEL LOAD OF 50,000 LB. OR DUAL WHEEL LOAD OF 90,000 LB.
 - COVER SHALL BE MADE OF STRUCTURAL STEEL CONFORMING TO ASTM A 36/A 36M.
 - MINIMUM COMPRESSIVE STRENGTH OF CONCRETE SHALL BE 3000 PSI.

HANDHOLE TYPE	DIMENSIONS
4	4'-0"

5 STANDARD ELECTRICAL HANDHOLE TYPE 4
NOT TO SCALE

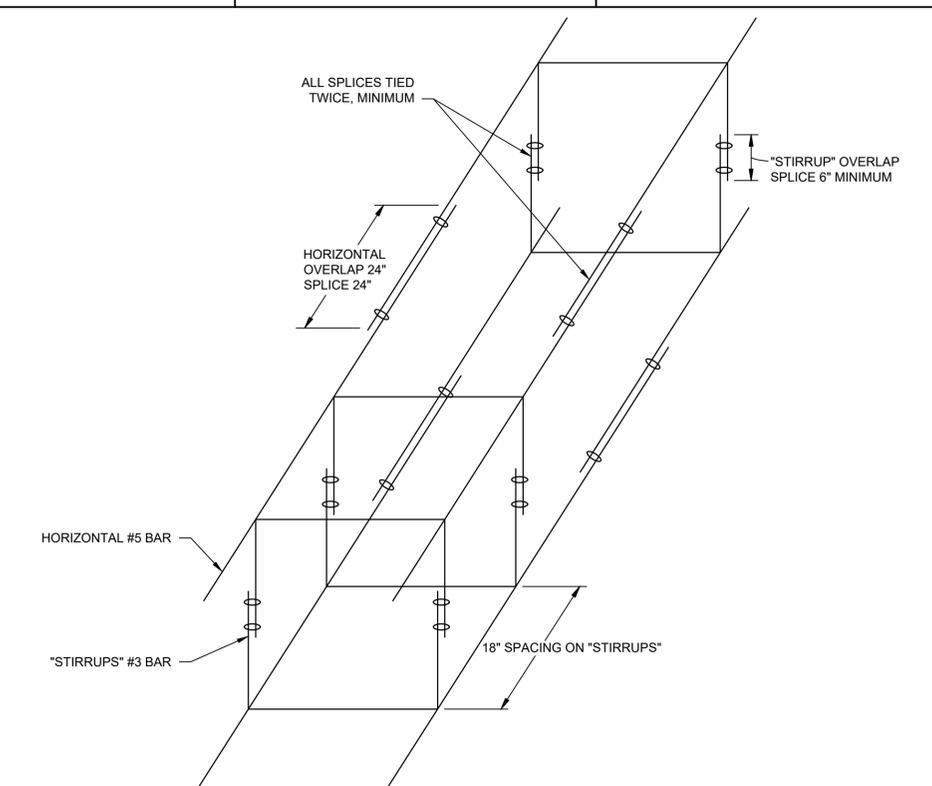

3 UNDERGROUND DUCTBANK CONCRETE REINFORCING DETAIL
NOT TO SCALE

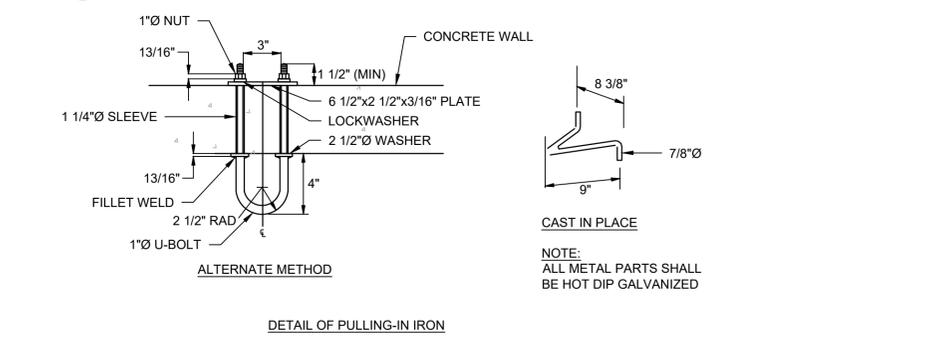

6 DETAILS (PULLING-IN IRON, CABLE RACK AND DUCT ENTRANCE)
NOT TO SCALE



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EXTEND COMMUNICATIONS DUCT BANK
NC AIR NATIONAL GUARD
145TH AIRLIFT WING
CHARLOTTE, NC

CHARLOTTE AIR NATIONAL GUARD BASE ELECTRICAL DETAILS

0 1" 2"
FILENAME | E-501.DWG
SCALE | AS NOTED
SHEET | E-501