


1P	SINGLE POLE	DPDT	DOUBLE POLE, DOUBLE THROW
1PH	SINGLE PHASE	DPST	DOUBLE POLE, SINGLE THROW
2/C	TWO-CONDUCTOR	DRSW	DOOR SWITCH
3/C	THREE-CONDUCTOR	DS	DISCONNECT SWITCH
3PH	THREE PHASE	DWG	DRAWING
4/C	FOUR-CONDUCTOR		
4W	FOUR WIRE	E	
		EL	ELEVATION
		ELEC	ELECTRIC OR ELECTRICAL
		ELEV	ELEVATOR
A		EMCP	EMERGENCY MONITORING CONTROL PANEL
A/C UNIT	AIR CONDITIONING UNIT	EMER	EMERGENCY
A/E	ARCHITECT / ENGINEER	EMI	ELECTROMAGNETIC INTERFERENCE
AAP	ALARM ANNUNCIATOR PANEL	ENCL	ELECTRICAL METALLIC TUBING
AC	ALTERNATING CURRENT OR ARMORED CABLE	ENCL	ENCLOSURE
ACC	ACCESSIBLE	EPO	EMERGENCY POWER OFF
ADDL	ADDITIONAL	EPRF	EXPLOSION PROOF
ADJ	ADJACENT OR ADJOINING	ESMT	EASEMENT
ADO	AUTOMATIC DOOR OPENER	EWC	ELECTRIC WATER COOLER
AF	AMPERE FRAME OR AMP FUSE	EWB	ELECTRIC WATER HEATER
AFC	ABOVE FINISHED COUNTER, AUTOMATIC FREQUENCY CONTROL, OR AVAILABLE FAULT CURRENT	EXST	EXISTING
		EC	ELECTRICAL
AFF	ABOVE FINISHED FLOOR	F	CONTRACTOR
AFG	ABOVE FINISHED GRADE	FA	FIRE ALARM
AH	AMPERE-HOUR	FAAP	FIRE ALARM ANNUNCIATOR PANEL
AHJ	AUTHORITY HAVING JURISDICTION	FABL	FIRE ALARM BELL
AIC	AMPERE INTERRUPTING CAPACITY	FABX	FIRE ALARM BOX
ALT	ALTERNATE	FACP	FIRE ALARM CONTROL PANEL
AMB OR A	AMBIENT	FC	FOOTCANDLE
AMP	AMPERE	FIXT	FIXTURE
ARCH	ARCHITECT	FLA	FULL LOAD AMPS
ASC	AMPS SHORT CIRCUIT	FLEX	FLEXIBLE METALLIC CONDUIT
AT	AMPERE TRIP	FLT	FLOODLIGHT
ATS	AUTOMATIC TRANSFER SWITCH	FLUOR	FLUORESCENT
AUTO	AUTOMATIC	FLUOR FIXT	FLUORESCENT FIXTURE
AV	AUDIO VISUAL	FOUTT	TELEPHONE FLOOR OUTLET
		FP	FIRE PROTECTION
		FT	FEET OR FOOT
		FU SW	FUSED SWITCH
		FVNR	FULL VOLTAGE NON-REVERSING
		FVR	FULL VOLTAGE REVERSING
		G	
		G OR GND	ELECTRICAL GROUND
		GC	GENERAL CONTRACTOR
		GEN	GENERATOR
		GFCI	GROUND FAULT CIRCUIT INTERRUPTER
		GTB	GROUND TERMINAL BOX
C			
C	CONDUIT	H	
CAB	CABINET	HCD	HIGH INTENSITY DISCHARGE
CALC	CALCULATE	HOA	HAND-OFF-AUTOMATIC
CAP	CAPACITY	HP	HORSEPOWER
CAT	CATALOG	HT	HEIGHT
CATV	COMMUNITY ANTENNA TELEVISION	HZ	HERTZ
CCR	CONTROL CONTRACTOR		
CCTV	CLOSED CIRCUIT TELEVISION		
CD	CANDELA OR CONSTRUCTION DOCUMENTS	I	
CF	CONTRACTOR FURNISHED	IESNA	ILLUMINATION ENGINEERING SOCIETY OF NORTH AMERICA
CF/CI	CONTRACTOR FURNISHED / CONTRACTOR INSTALLED	IMC	INTERMEDIATE METAL CONDUIT
CF/OI	CONTRACTOR FURNISHED / OWNER INSTALLED	INCAND	INCANDESCENT
CFE	CONTRACTOR FURNISHED EQUIPMENT	IR	INFRARED
CHW	CHILLED WATER	IWH	INSTANTANEOUS WATER HEATER
CHWP	CHILLED WATER PUMP		
CKT	CIRCUIT	J	
CKT BRKR	CIRCUIT BREAKER	J-BOX	JUNCTION BOX
CLF	CURRENT LIMITING FUSE		
CLG	CEILING	K	
CMU	CONCRETE MASONRY UNIT	KV	KILOVOLT
CO	CONTRACTING OFFICER	KVA	KILOVOLT-AMPERE
COAX	COAX CABLE	KVAH	KILOVOLT-AMPERE PER HOUR
COMM	COMMUNICATION	KVAR	KILOVOLT-AMPERE REACTIVE
COMP	COMPARTMENT	KW	KILOWATT
CONC	CONCRETE	KWH	KILOWATT HOUR
CONT	CONTINUE	KWHM	KILOWATT HOUR METER
CONTR	CONTRACTOR		
COORD	COORDINATE	L	
COR	CONTRACTING OFFICER'S REPRESENTATIVE	LED	LIGHT EMITTING DIODE
CPT	CONTROL POWER TRANSFORMER	LF	LINEAR FEET (FOOT)
CRI	COLOR RENDERING INDEX	LM	LUMEN
CT	CURRENT TRANSFORMER	LP	LIGHT POLE
CTV	CABLE TELEVISION	LPS	LOW PRESSURE SODIUM
CU	COPPER	LRA	LOCKED ROTOR AMPS
CU FT	CUBIC FEET	LT	LIGHT
CUR	CURRENT	LTG	LIGHTING
		LTG PNL	LIGHTING PANEL
		LTNG	LIGHTNING
		LV	LOW VOLTAGE
D		M	
DB	DECIBEL	MATV	MASTER ANTENNA TELEVISION SYSTEM
DC	DIRECT CURRENT	MAXIM	MAXIMUM
DCP	DIMMER CONTROL PANEL	MC	METAL-CLAD
DEG C	DEGREES CELSIUS	MCA	MINIMUM CIRCUIT AMPS
DEG F	DEGREES FAHRENHEIT	MCB	MAIN CIRCUIT BREAKER
DEMO	DEMOLITION	MCC	MOTOR CONTROL CENTER
DIAG	DIAGRAM	MDP	MAIN DISTRIBUTION PANEL
DISC	DISCONNECT	MECH	MECHANICAL
DISTR	DISTRIBUTION	MG	MOTOR GENERATOR
DISTR PNL	DISTRIBUTION PANEL	MH	MANHOLE
DMR SW	DIMMER SWITCH		
DN	DOWN		

VEG 4.11




U.S. Department
of Veterans Affairs


ELECTRICAL SYMBOLS - DIAGRAM

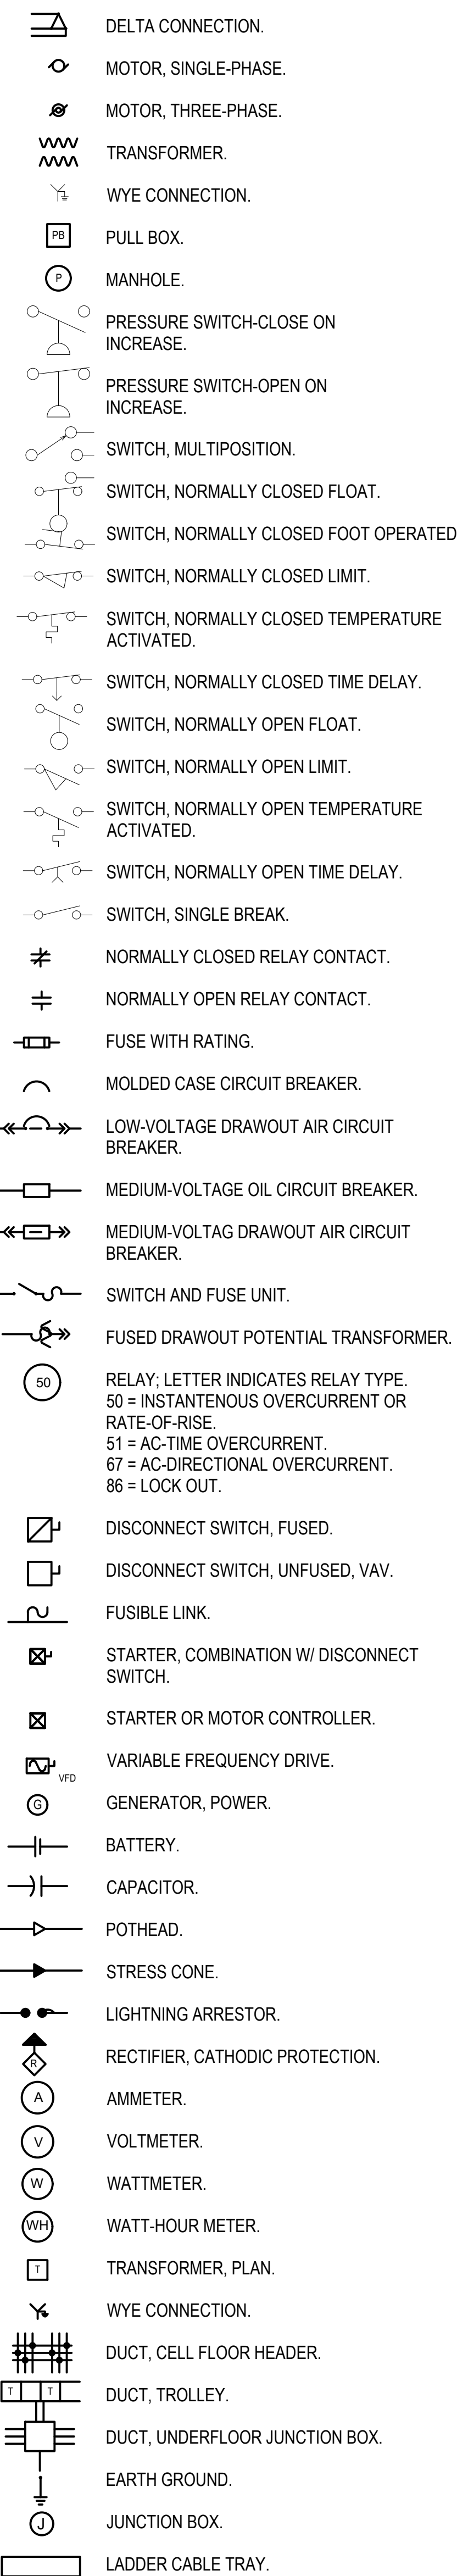


ELECTRICAL SYMBOLS - POWER PLAN

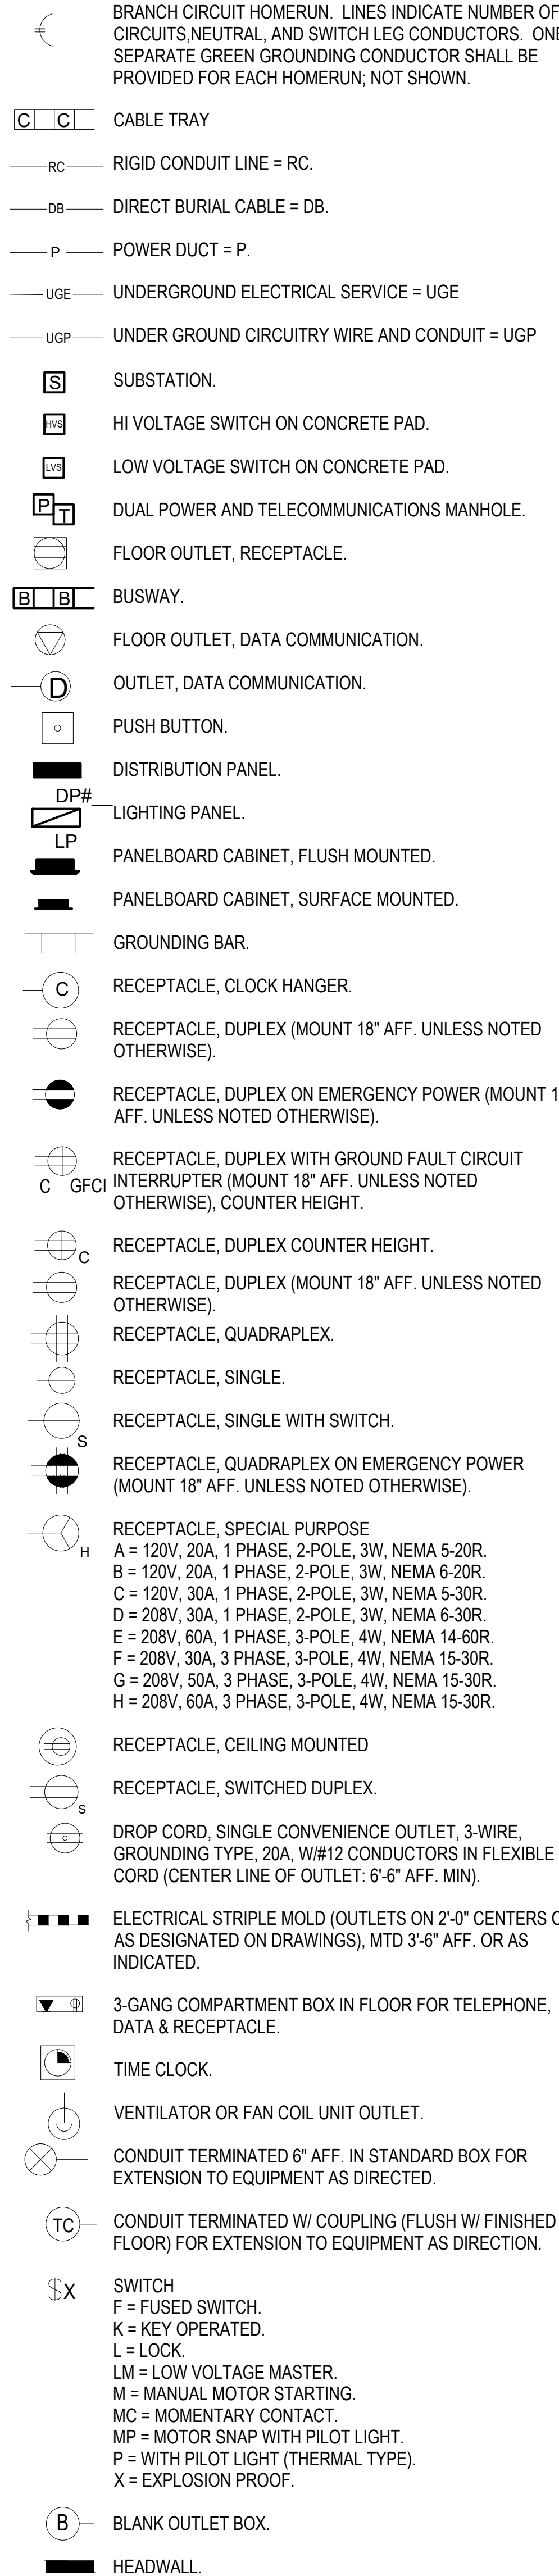

COMMUNICATION SYMBOLS:

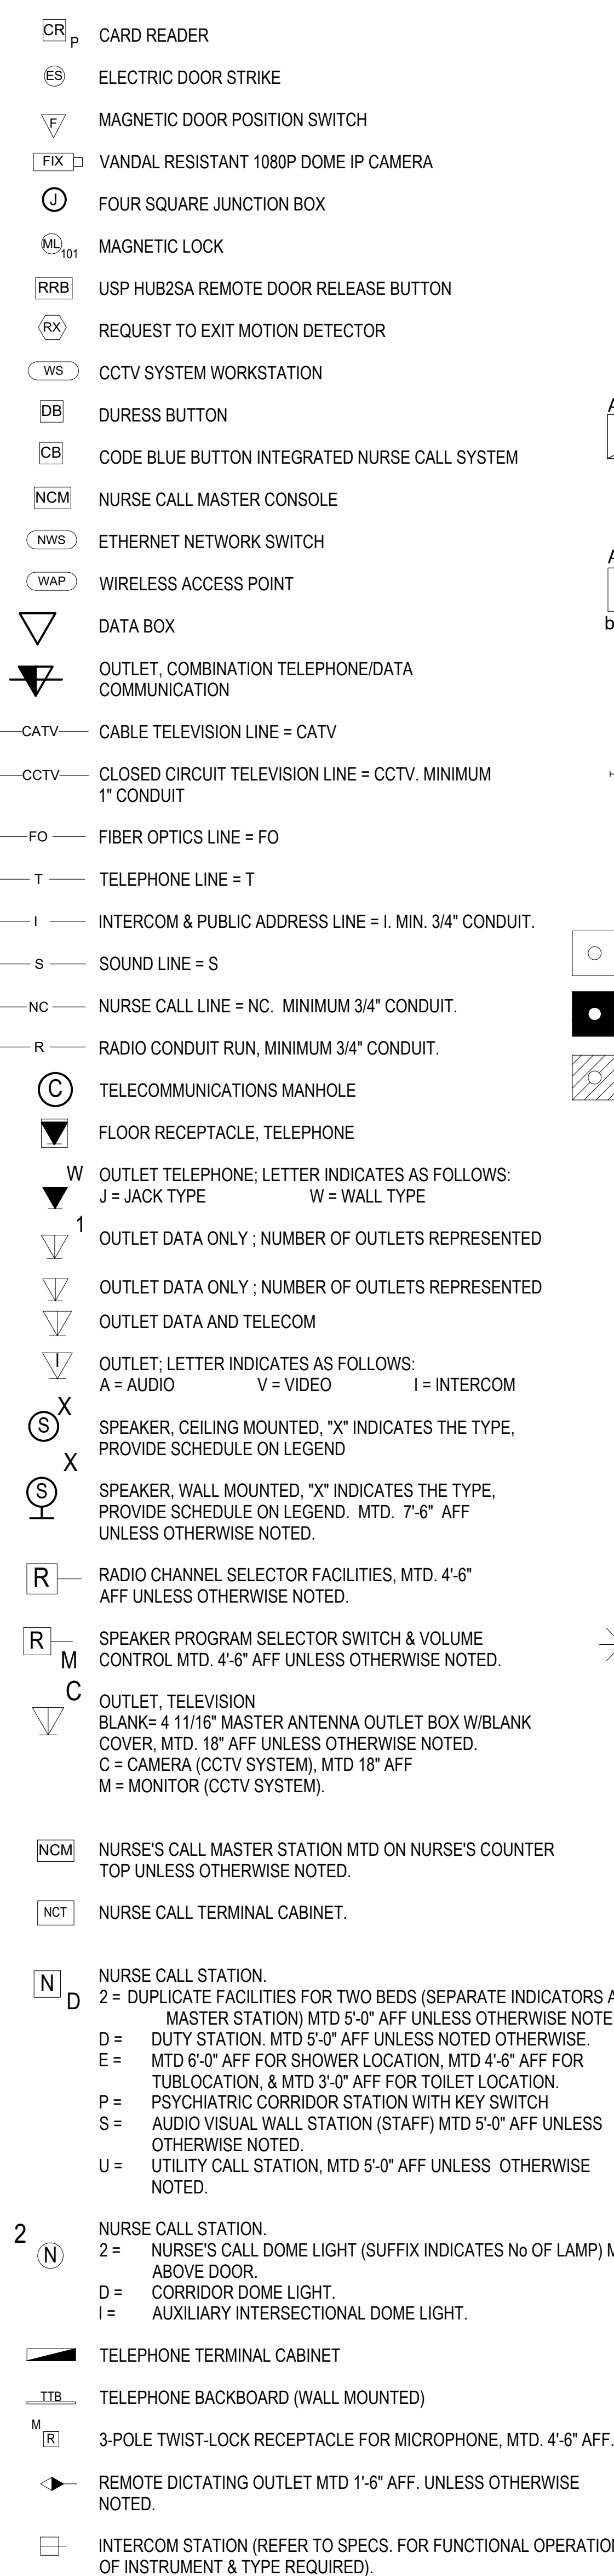

ELECTRICAL SYMBOLS - LIGHTING PLAN

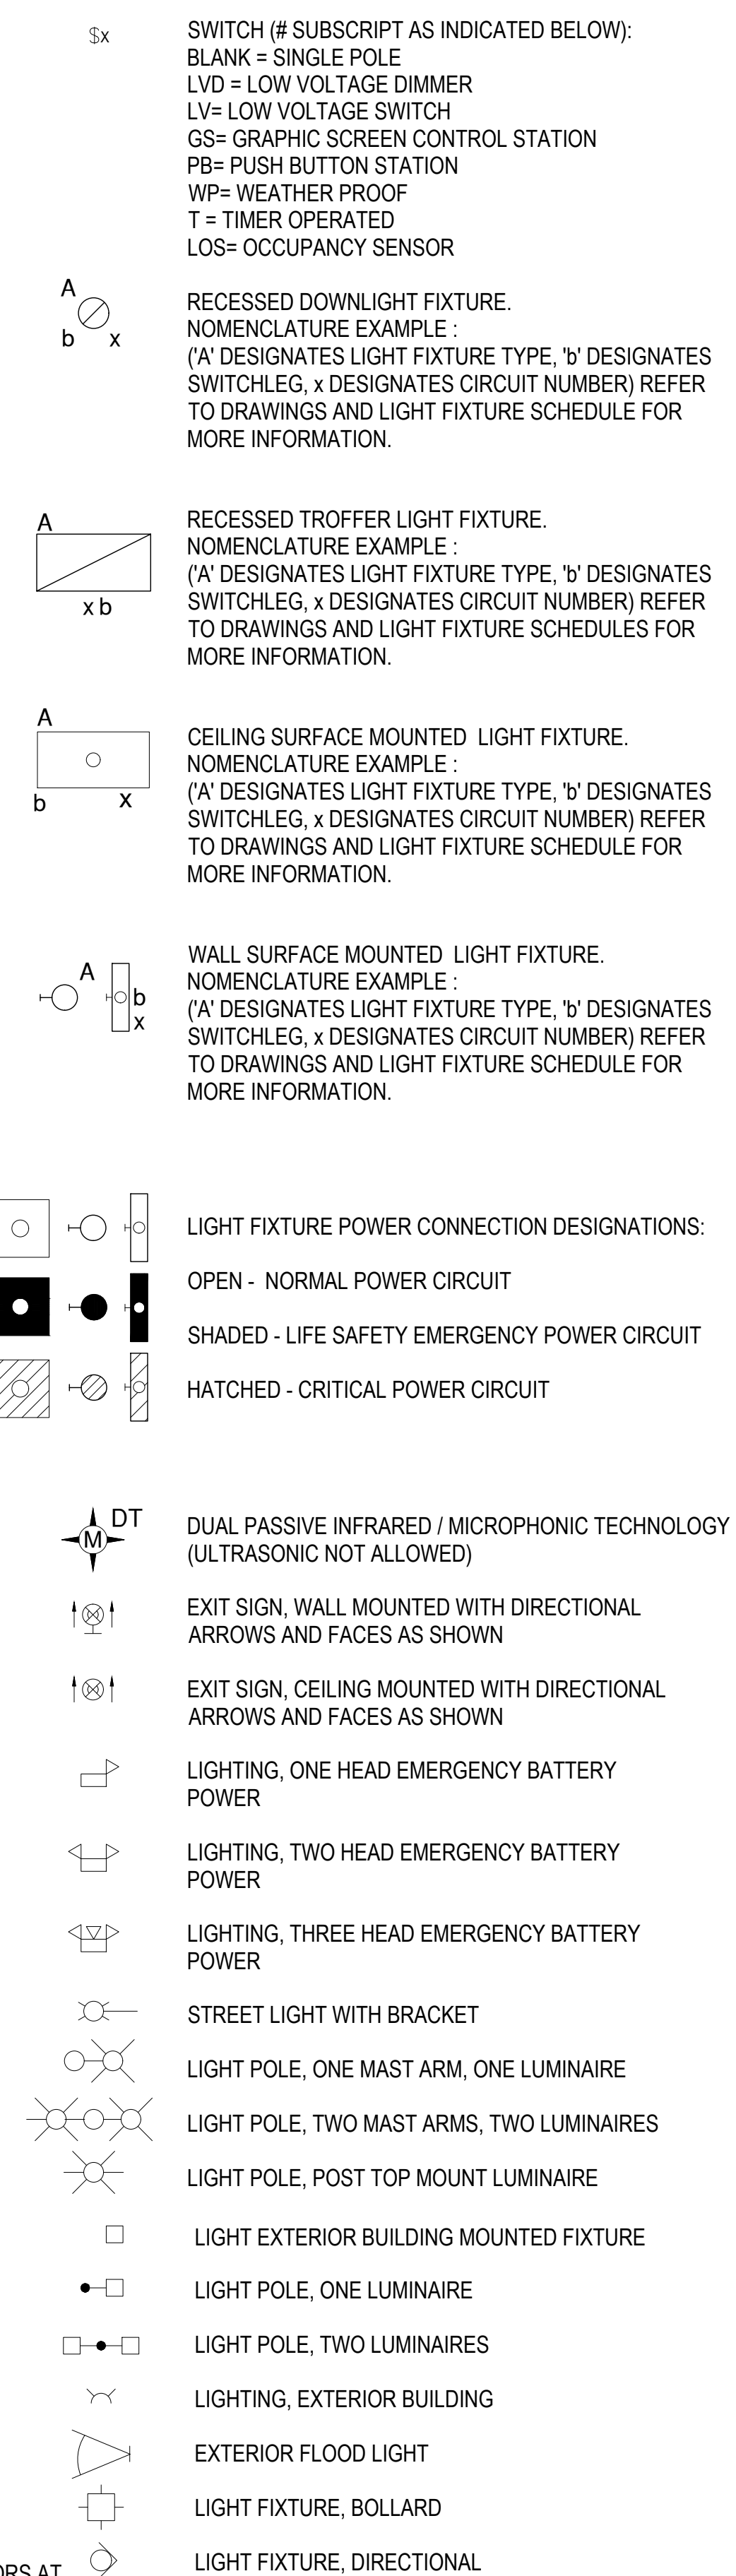

ELECTRICAL GENERAL NOTES:

A. FOR GENERAL NOTES AND SYMBOLS SEE SHEETS E-001 & E-002.



KEY NOTES:

- 1 DEMOLISH ALL EXISTING RECEPTACLES, VAV CIRCUITS, AND LIGHTS IN HATCHED AREA. CONDUCTORS AND CONDUIT TO BE DEMOLISHED BACK TO PANEL.
- 2 DEMOLISH DATA AND COMMUNICATION RECEPTACLES TO INCLUDE CONDUIT BACK TO HEAD-END EQUIPMENT.
- 3 RETAIN CONDUCTOR AND CONDUIT FOR EXISTING MECHANICAL EQUIPMENT TO REMAIN. REFER TO MECHANICAL PLANS FOR EQUIPMENT SCHEDULE.
- 4 FIRE ALARM CONTROL PANEL TO BE REMOVED FROM WALL AND RETAINED FOR REINSTALLATION.


1 POWER DEMOLITION PLAN

SCALE: 1/4" = 1'-0"

0 1' 2' 4' 8' 16'

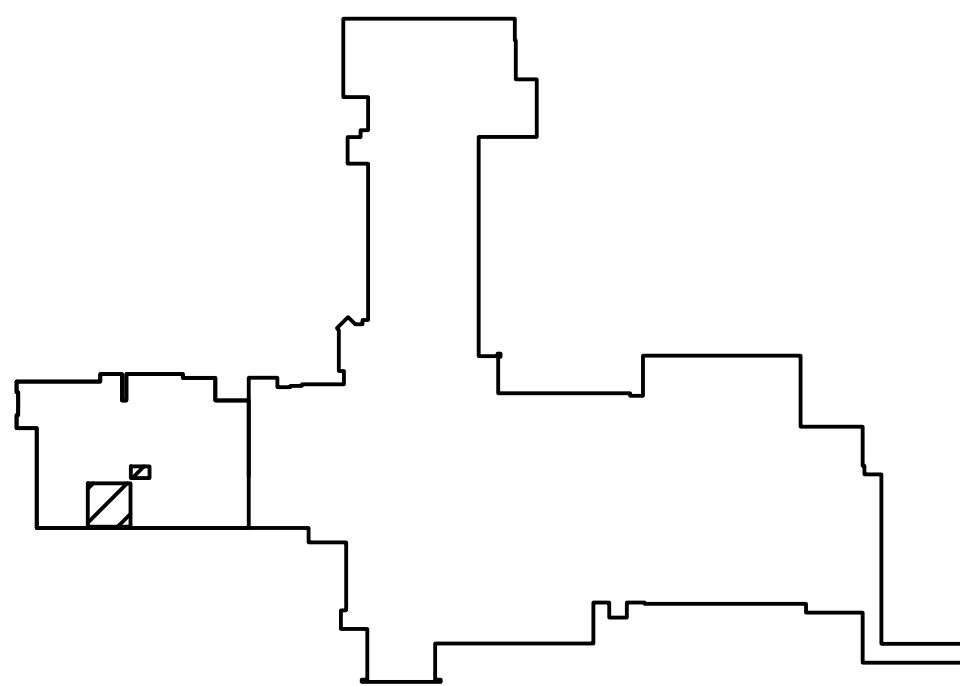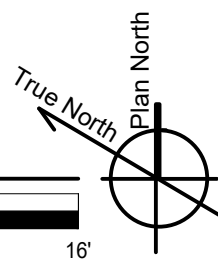

KEY PLAN

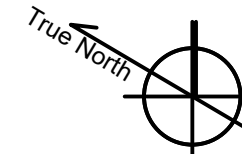

CONSULTANTS:



ARCHITECT/ENGINEERS:



750 W HAMPTON AVE
SUITE #300
ENGLEWOOD CO 80110
(720) 550-6307
WWW.VALHALLAENGINEERING.COM

VEG 4.11

STAMP:



U.S. Department
of Veterans Affairs

Drawing Title

POWER DEMOLITION PLAN -
FIRST FLOOR WEST

Approved: Project Director

Phase

100% CONSTRUCTION
DOCUMENTS

Project Title

OUTPATIENT MENTAL HEALTH /
EDUCATION ADDITION

Location

3687 VETERANS DRIVE, FORT HARRISON, MT 59636

Issue Date

08/05/2020

Checked

TL

Drawn

BWW

Project Number

436-114

Building Number

154

Drawing Number

ED101-P2

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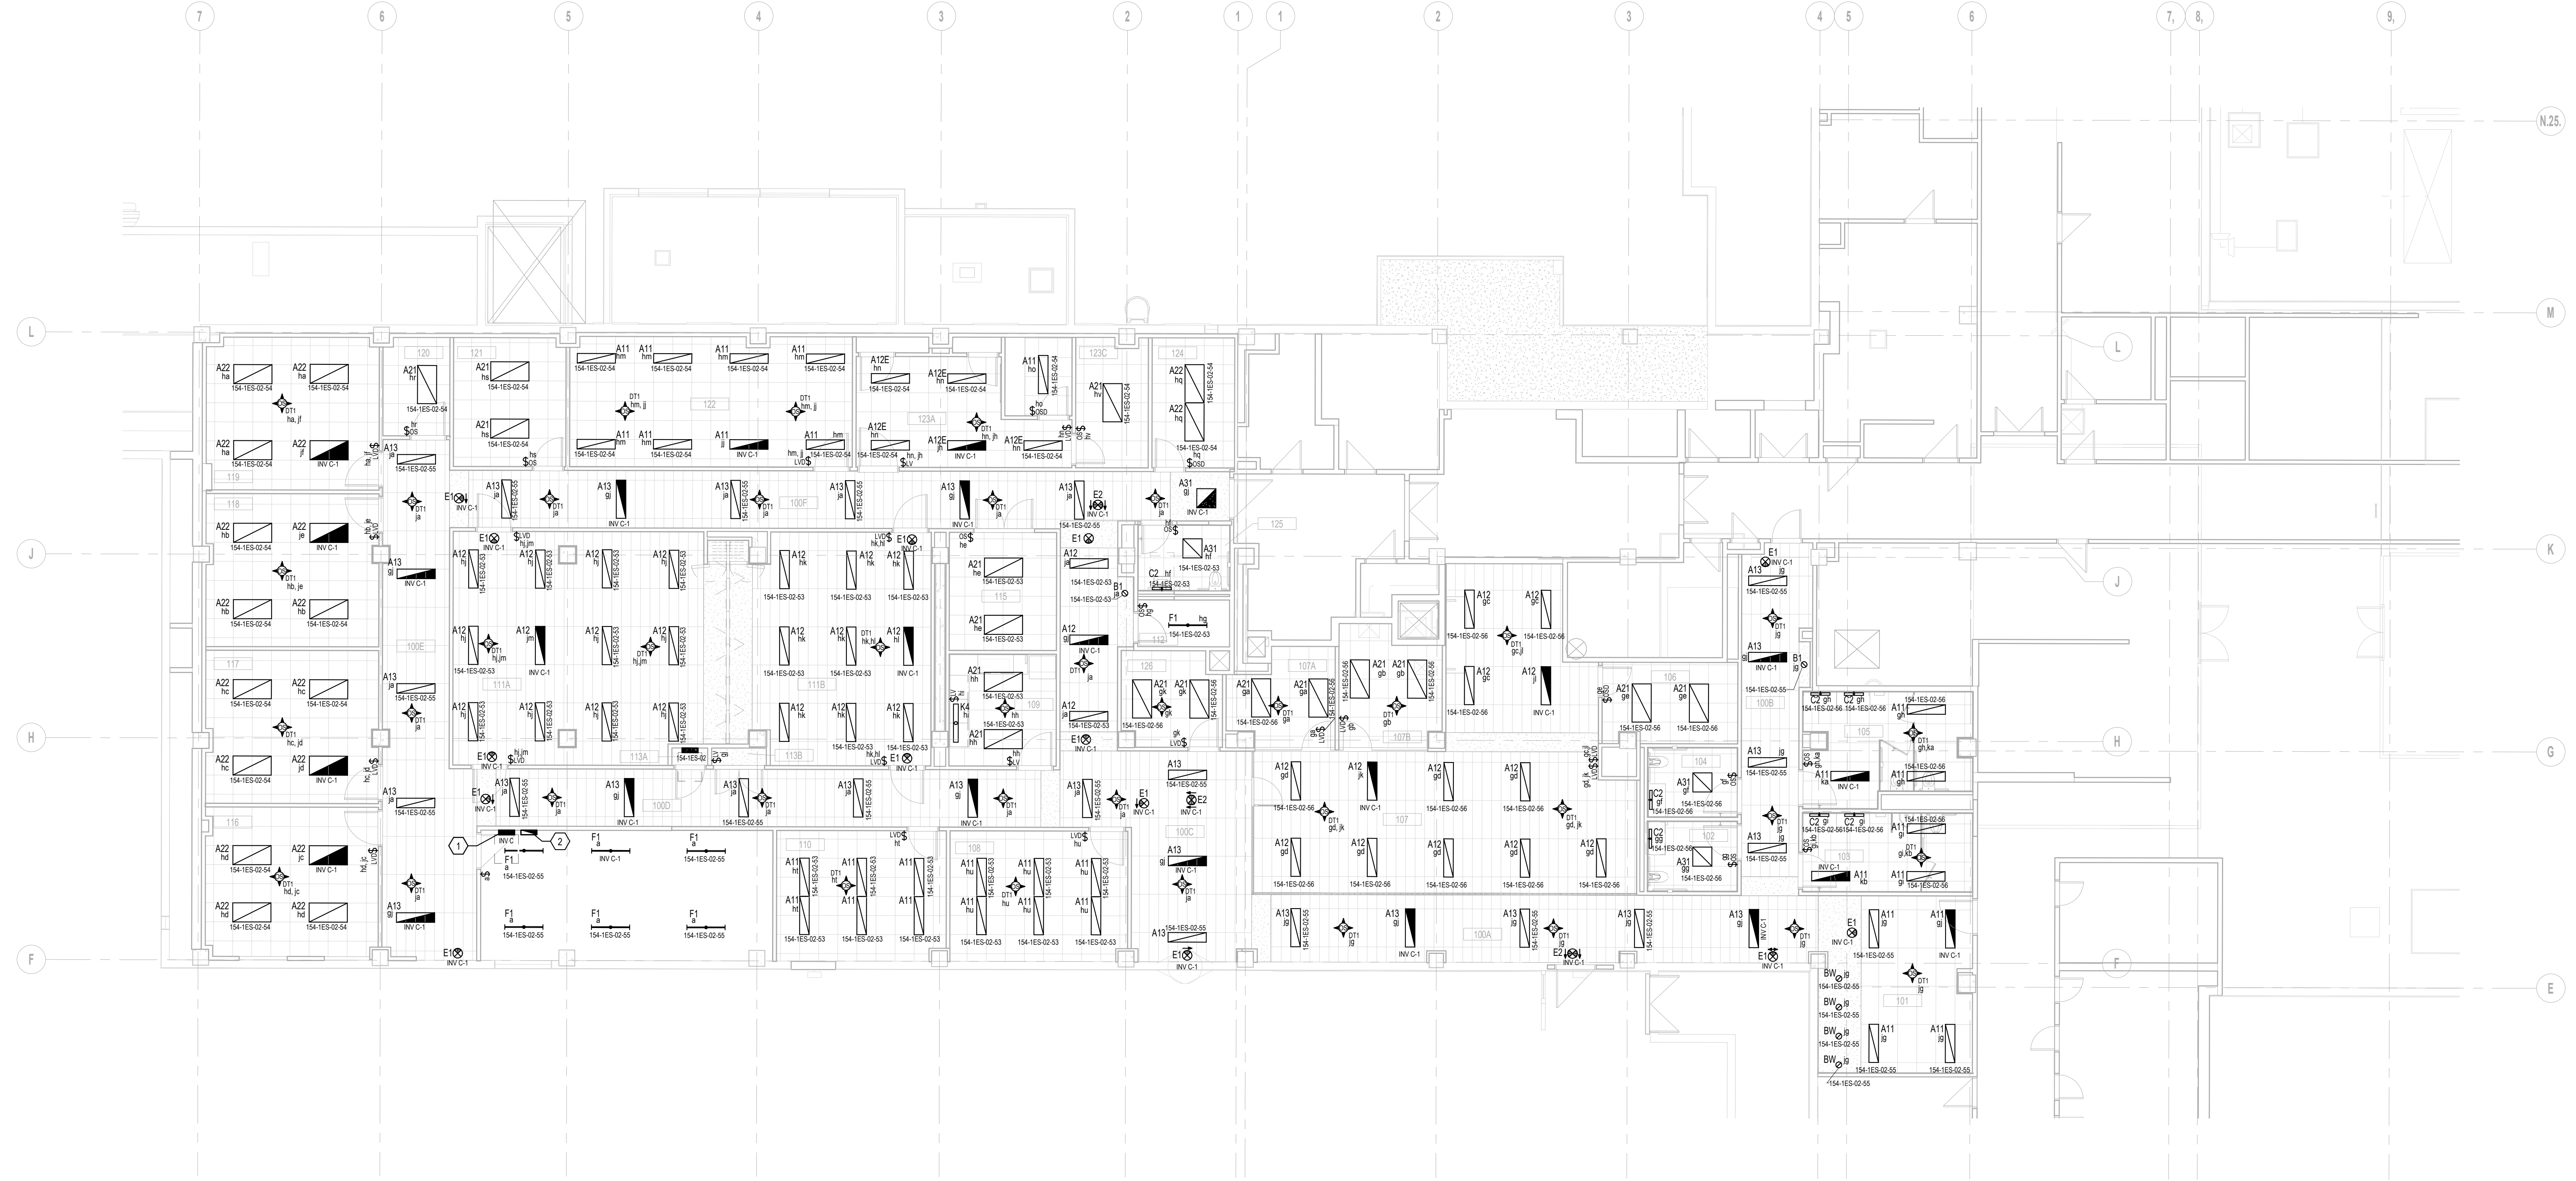
ELECTRICAL GENERAL NOTES:

A. REFER TO DRAWING E-002 FOR GENERAL NOTES PERTAINING TO THIS DRAWING.


B. FOR NON-DIMMED FIXTURES CONNECTED TO EMERGENCY INVERTER POWER PROVIDE A DIGITAL EMERGENCY SWITCHED RELAY PACK FOR EVERY CHANNEL CONTROLLING NON-DIMMED LIGHT FIXTURES.

C. FOR 0-10VDC DIMMED FIXTURES CONNECTED TO EMERGENCY INVERTER POWER PROVIDE A DIGITAL EMERGENCY 0-10VDC DIMMING RELAY PACK FOR EVERY CHANNEL CONTROLLING 0-10VDC DIMMING LIGHT FIXTURES.


- KEY NOTES:**
1. PROVIDE WALL MOUNTED INVERTER FOR EMERGENCY (LIFE SAFETY) EGRESS LIGHTING. MOUNT INVERTER AT 6'-0" A.F.F. TO THE BOTTOM OF INVERTER.
 2. LOW VOLTAGE LIGHTING CONTROL. PROVIDED BY CONTRACTOR. MUST INTERFACE TO CAMPUS WIDE LAN. PROVIDE AN ETHERNET CONNECTION TO CAMPUS WIDE LAN. INTERFACE DEVICE MUST BE MOUNTED WITHIN A 14"X14"X4" DEEP NEMA 1 RATED SURFACE MOUNTED BACKBOX. BACKBOX TO HAVE A SURFACE MOUNTED COVER. PROVIDE A 120VOLT CONNECTION TO CIRCUIT INV C-1.
 3. LOW VOLTAGE LIGHTING CONTROL CHANNEL MUST BE PROGRAMMED TO OPERATE CONTINUOUSLY.



1 EDUCATION BUILDING - FIRST FLOOR LIGHTING
1/8" = 1'-0"

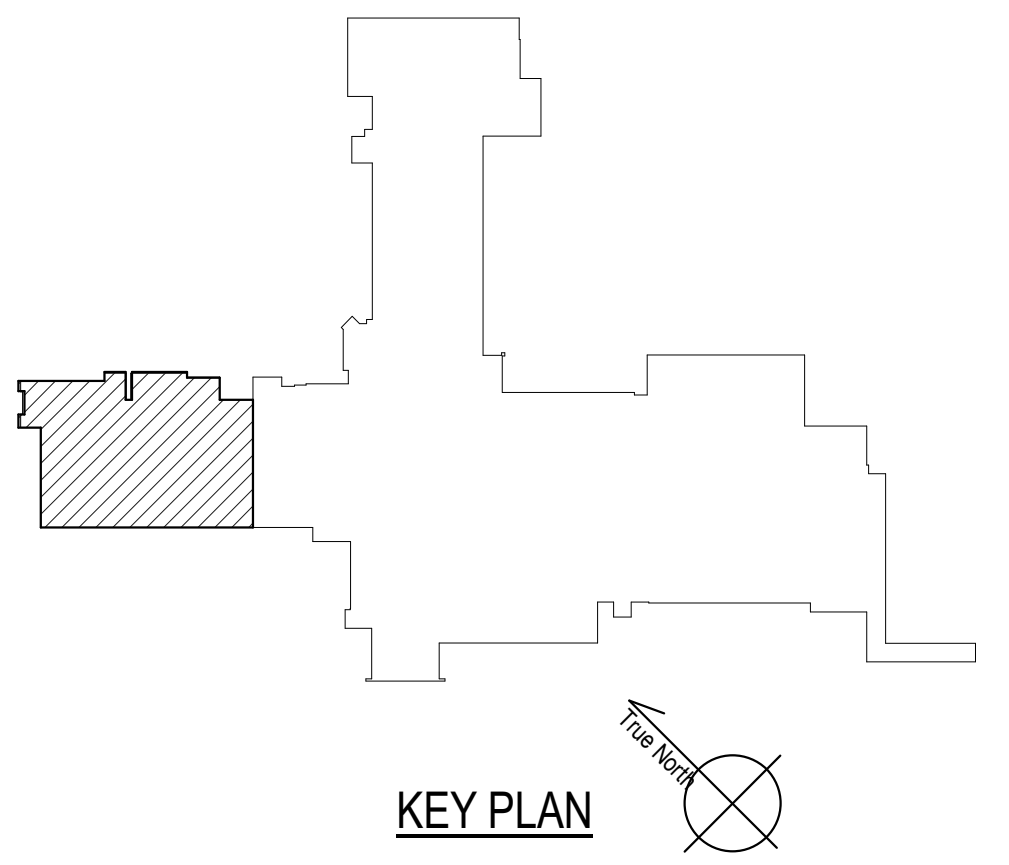

<p>CONSULTANTS:</p> <p>HOEFER WYSOCKI 1640 TONAWANDA CREEK PARKWAY SUITE 400, LEANWOOD, KANSAS 66041</p> <p>Protection Engineering CONSULTANTS</p> <p>JIRSA HEDRICK Structural Engineers</p>		<p>ARCHITECT/ENGINEER OF RECORD:</p> <p>VALHALLA ENGINEERING GROUP, LLC 750 W HAMPDEN AVE SUITE 300 ENGLEWOOD, CO 80110 (720) 550-6307 WWW.VALHALLAENGINEERING.COM</p>		<p>STAMP:</p> <p>PROFESSIONAL ENGINEER 8/15/2020</p>	<p>U.S. Department of Veterans Affairs</p>	<p>Drawing Title</p> <p>EDUCATION BUILDING - FIRST FLOOR LIGHTING</p> <p>Approved: Project Director</p>	<p>Phase</p> <p>100% CONSTRUCTION DOCUMENTS</p>	<p>Project Title</p> <p>OUTPATIENT MENTAL HEALTH / EDUCATION ADDITION</p> <p>Location 3687 Veterans Drive, Fort Harrison, MT 59636</p> <p>Issue Date 08/05/2020</p> <p>Checked TL</p> <p>Drawn JEE</p>	<p>Project Number</p> <p>436-114</p> <p>Building Number</p> <p>154</p> <p>Drawing Number</p> <p>EL101-P2</p>
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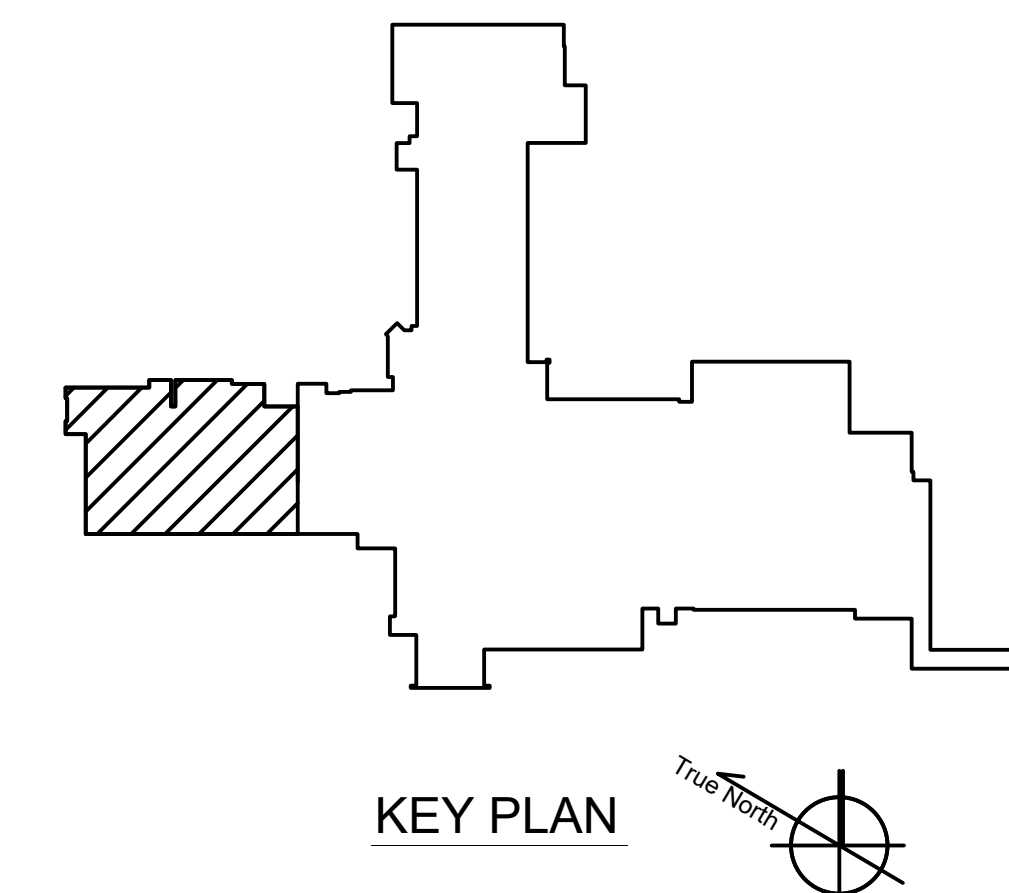


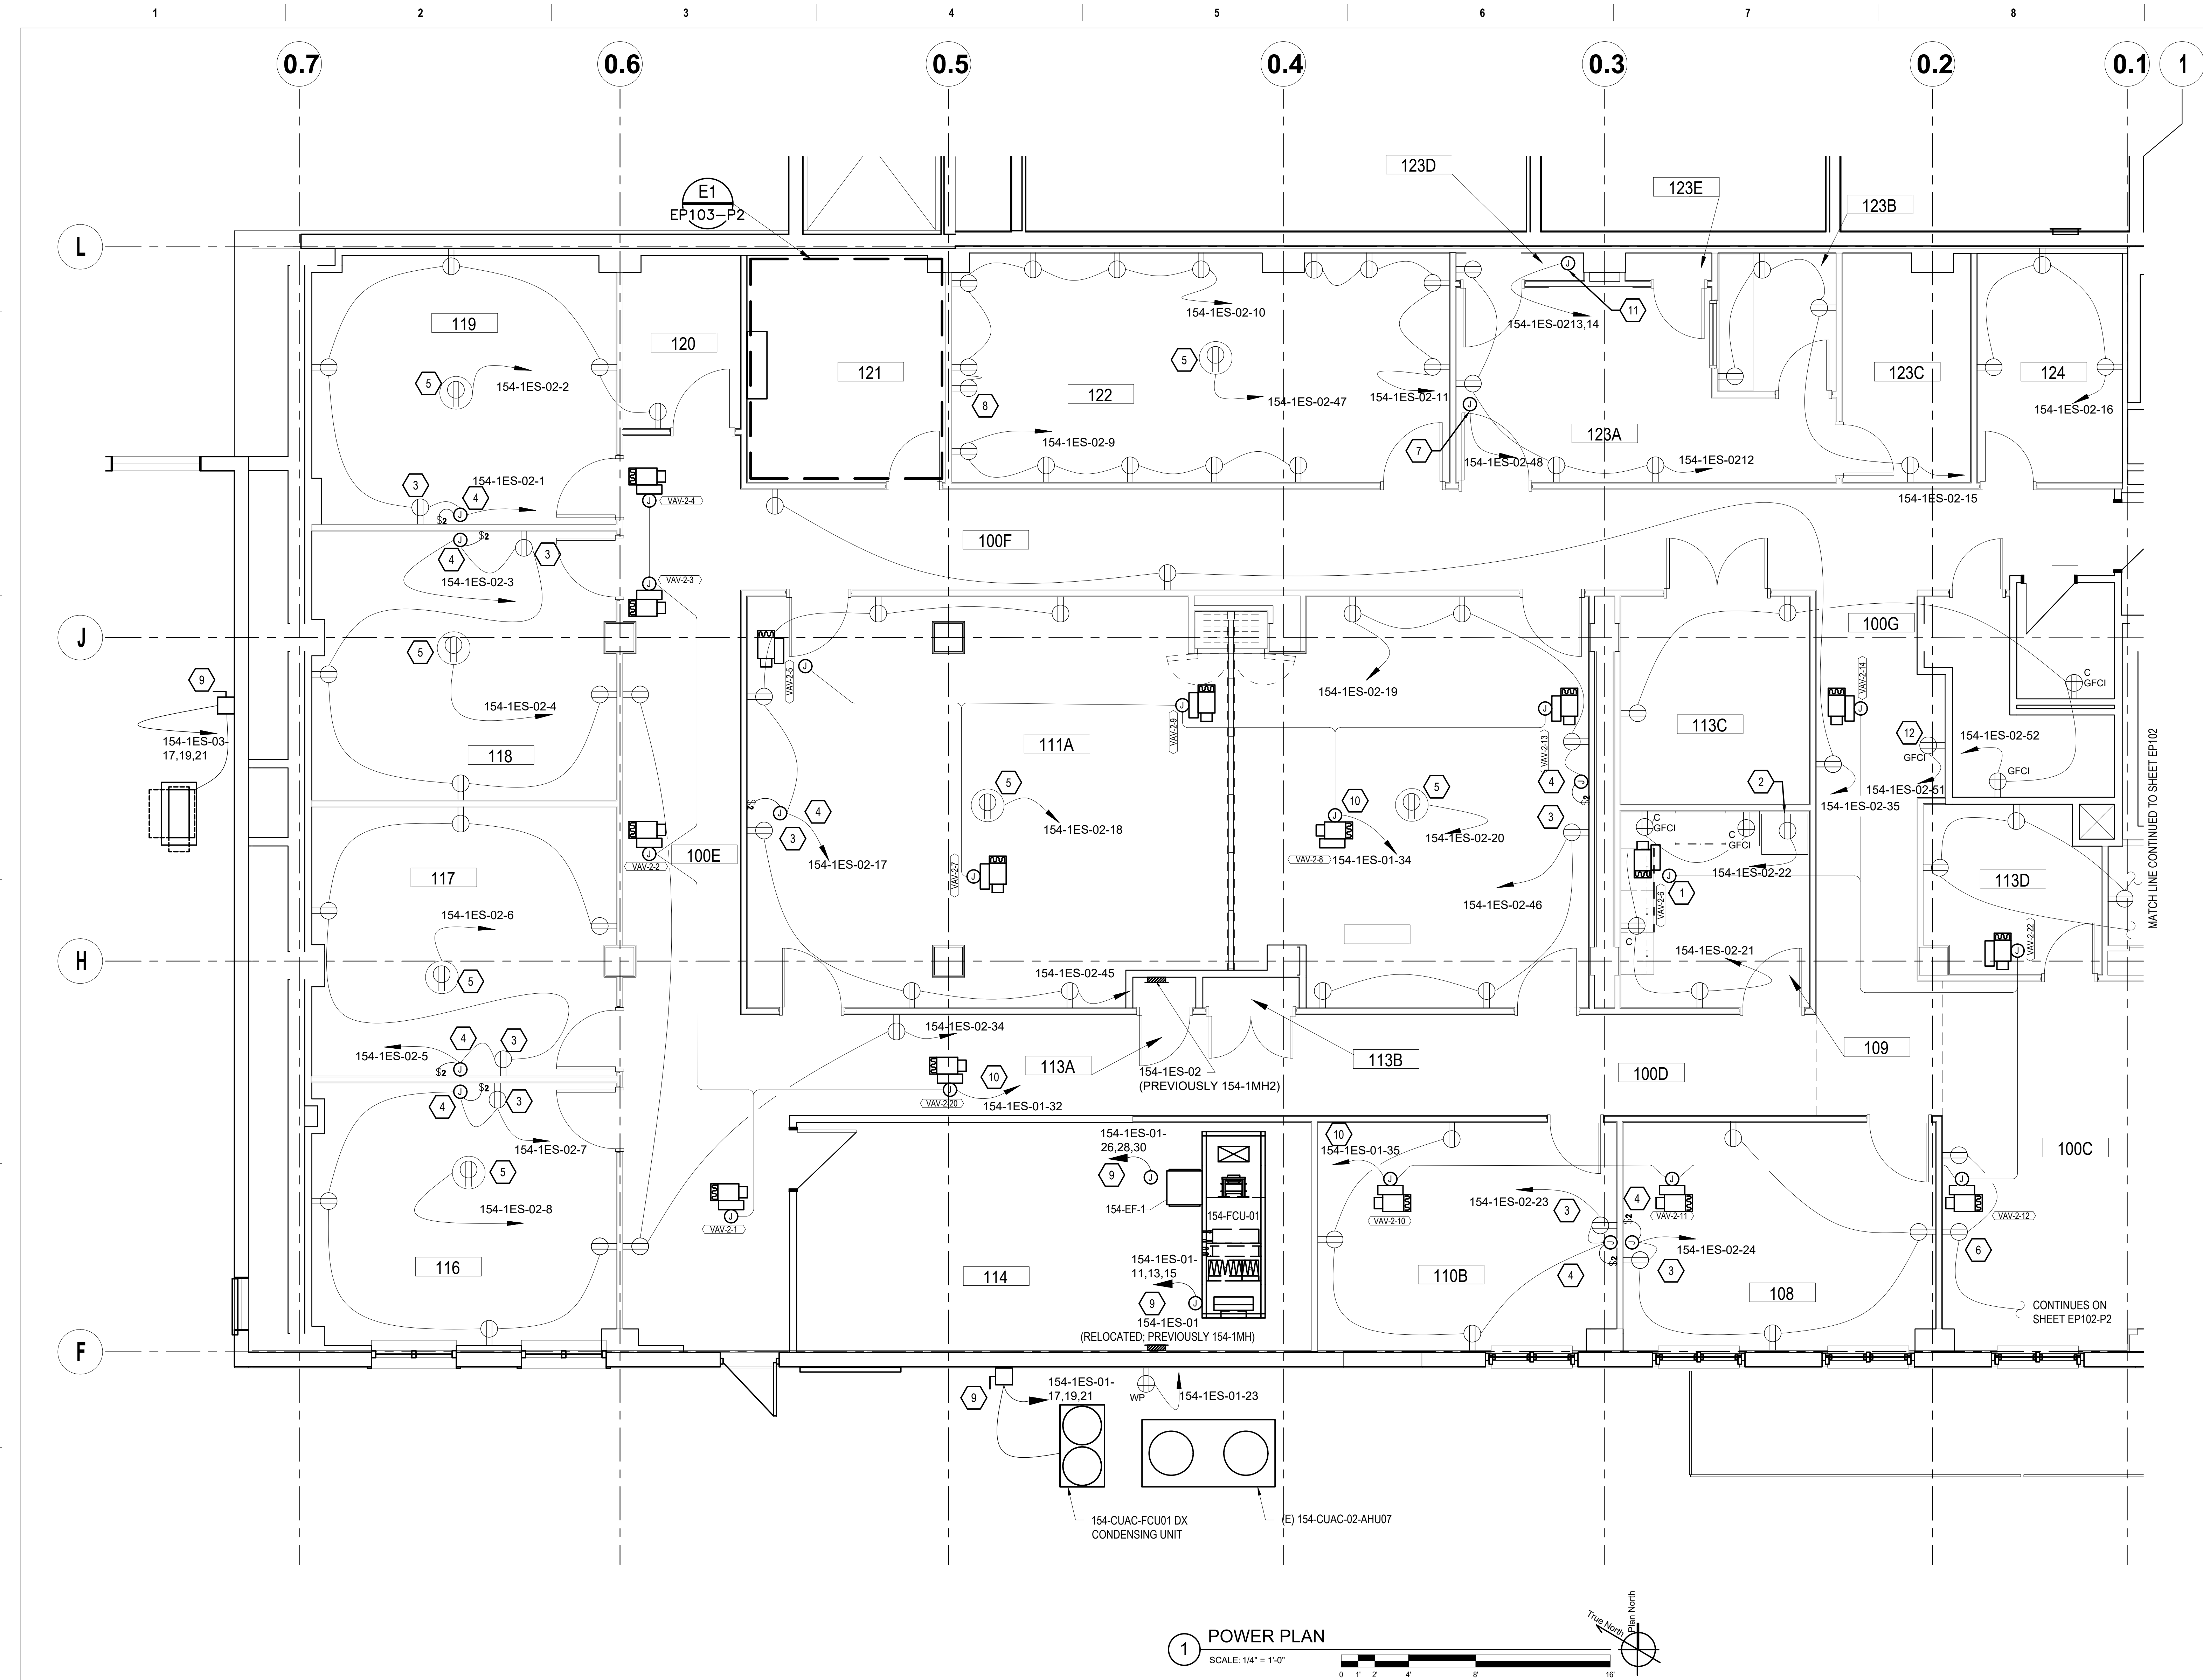ELECTRICAL GENERAL NOTES:

A. FOR GENERAL NOTES AND SYMBOLS SEE SHEETS E-001 & E-002.

KEY NOTES:

- 1 PROVIDE RECEPTACLE FOR MICROWAVE. COORDINATE EXACT LOCATION AND HEIGHT WITH CASEWORK ELEVATIONS.
- 2 RECEPTACLE FOR REFRIGERATOR. COORDINATE EXACT LOCATION AND HEIGHT WITH CASEWORK ELEVATIONS.
- 3 PROVIDE DUPLEX RECEPTACLE AND EMPTY SINGLE GANG BOX BEHIND PROJECTOR SCREEN MOUNTED 18" ABOVE FINISHED FLOOR. PROVIDE 3/4" CONDUIT WITH PULL STRING TO ABOVE ACCESSIBLE CEILING FOR LOW VOLTAGE CABLING BY OTHERS. COORDINATE EXACT MOUNTING HEIGHT WITH CASE WORK DETAIL.
- 4 PROVIDE JBOX IN CEILING AND SWITCH FOR DROP DOWN PROJECTION SCREEN.
- 5 PROVIDE CEILING MOUNTED DEDICATED 120V, 20A RECEPTACLE FOR PROJECTOR.
- 6 PROVIDE DUPLEX RECEPTACLE AND EMPTY SINGLE GANG BOX FOR TV LOCATION MOUNTED AT 60" ABOVE FINISHED FLOOR. PROVIDE 3/4" CONDUIT WITH PULL STRING TO ABOVE ACCESSIBLE CEILING FOR LOW VOLTAGE CABLING BY OTHERS. COORDINATE EXACT MOUNTING HEIGHT WITH CASE WORK DETAIL.
- 7 PROVIDE JBOX WITH DEDICATED CIRCUIT AS SHOWN FOR BATTERY CHARGING STATION FOR PATIENT LIFT SYSTEM.
- 8 PROVIDE DUPLEX RECEPTACLE AND EMPTY SINGLE GANG BOX FOR SMART BOARD LOCATION MOUNTED AT 60" ABOVE FINISHED FLOOR. PROVIDE 3/4" CONDUIT WITH PULL STRING TO ABOVE ACCESSIBLE CEILING FOR LOW VOLTAGE CABLING BY OTHERS. COORDINATE EXACT MOUNTING HEIGHT WITH ARCHITECT PRIOR TO ROUGH-IN.
- 9 PROVIDE CONNECTION FOR MECHANICAL EQUIPMENT AS SHOWN.
- 10 ELECTRICAL CONTRACTOR SHALL PROVIDE A 50VA, 120V/24V CONTROL TRANSFORMER TO VAV'S AND A 20A, 120V CIRCUIT. REFER TO SHEET EP601-P2 FOR MORE INFORMATION.
- 11 PROVIDE JBOX FOR PBPU RECEPTACLE POWER. COORDINATE WITH OTHERS TO INSTALL LOW VOLTAGE, MEDICAL GAS, VACUUM, OXYGEN, ETC. WITHOUT CONFLICT.
- 12 PROVIDE DEDICATED GFCI DUPLEX RECEPTACLE FOR DRINKING FOUNTAIN.



1 POWER PLAN
SCALE: 1/4" = 1'-0"
0 1' 2' 4' 8' 16'


<p>Issued:</p> <p>Date:</p>	<p>CONSULTANTS:</p> <p>HOEFER WYSOCKI</p> <p>15460 TOMAHAWK CREEK PARKWAY SUITE 400 LEANWOOD, KANSAS 66041</p> <p>Protection Engineering</p> <p>JIRSA HEDRICK</p> <p>Structural Engineers</p>	<p>ARCHITECT/ENGINEERS:</p> <p>VALHALLA ENGINEERING GROUP, LLC</p> <p>750 W HAMPDEN AVE SUITE #300 ENGLEWOOD CO 80110 (720) 550-6307 WWW.VALHALLAENGINEERING.COM</p> <p>VEG 4.11</p>	<p>STAMP:</p> <p>STATE OF COLORADO LICENSED PROFESSIONAL ENGINEER JASON W. THOMPSON 8/5/2020</p>	<p>U.S. Department of Veterans Affairs</p>	<p>Drawing Title</p> <p>POWER PLAN - FIRST FLOOR WEST</p> <p>Approved: Project Director</p>	<p>Phase</p> <p>100% CONSTRUCTION DOCUMENTS</p>	<p>Project Title</p> <p>OUTPATIENT MENTAL HEALTH / EDUCATION ADDITION</p> <p>Location 3687 VETERANS DRIVE, FORT HARRISON, MT 59636</p> <p>Issue Date 07/31/2020</p> <p>Checked TL</p> <p>Drawn BWW</p>	<p>Project Number</p> <p>436-114</p> <p>Building Number</p> <p>154</p> <p>Drawing Number</p> <p>EP101-P2</p>
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ELECTRICAL GENERAL NOTES:


A. FOR GENERAL NOTES AND SYMBOLS SEE SHEET E-001 & E-002.

KEY NOTES:

- 1 PROVIDE CONCRETE FLOOR BOX WITH A SINGLE DUPLEX 20A, 120V RECEPTACLE AND A DUPLEX DATA OUTLET SIMILAR TO LEGRAND RPB2-OG. VERIFY EXACT LOCATION PRIOR TO ROUGH-IN.
- 2 ELECTRICAL CONTRACTOR SHALL PROVIDE A 50VA, 120V/24V CONTROL TRANSFORMER TO VAV'S AND A 20A, 120V CIRCUIT. REFER TO SHEET EP601-P2 FOR MORE INFORMATION.
- 3 PROVIDE DEDICATED GFCI DUPLEX RECEPTACLE FOR DRINKING FOUNTAIN.

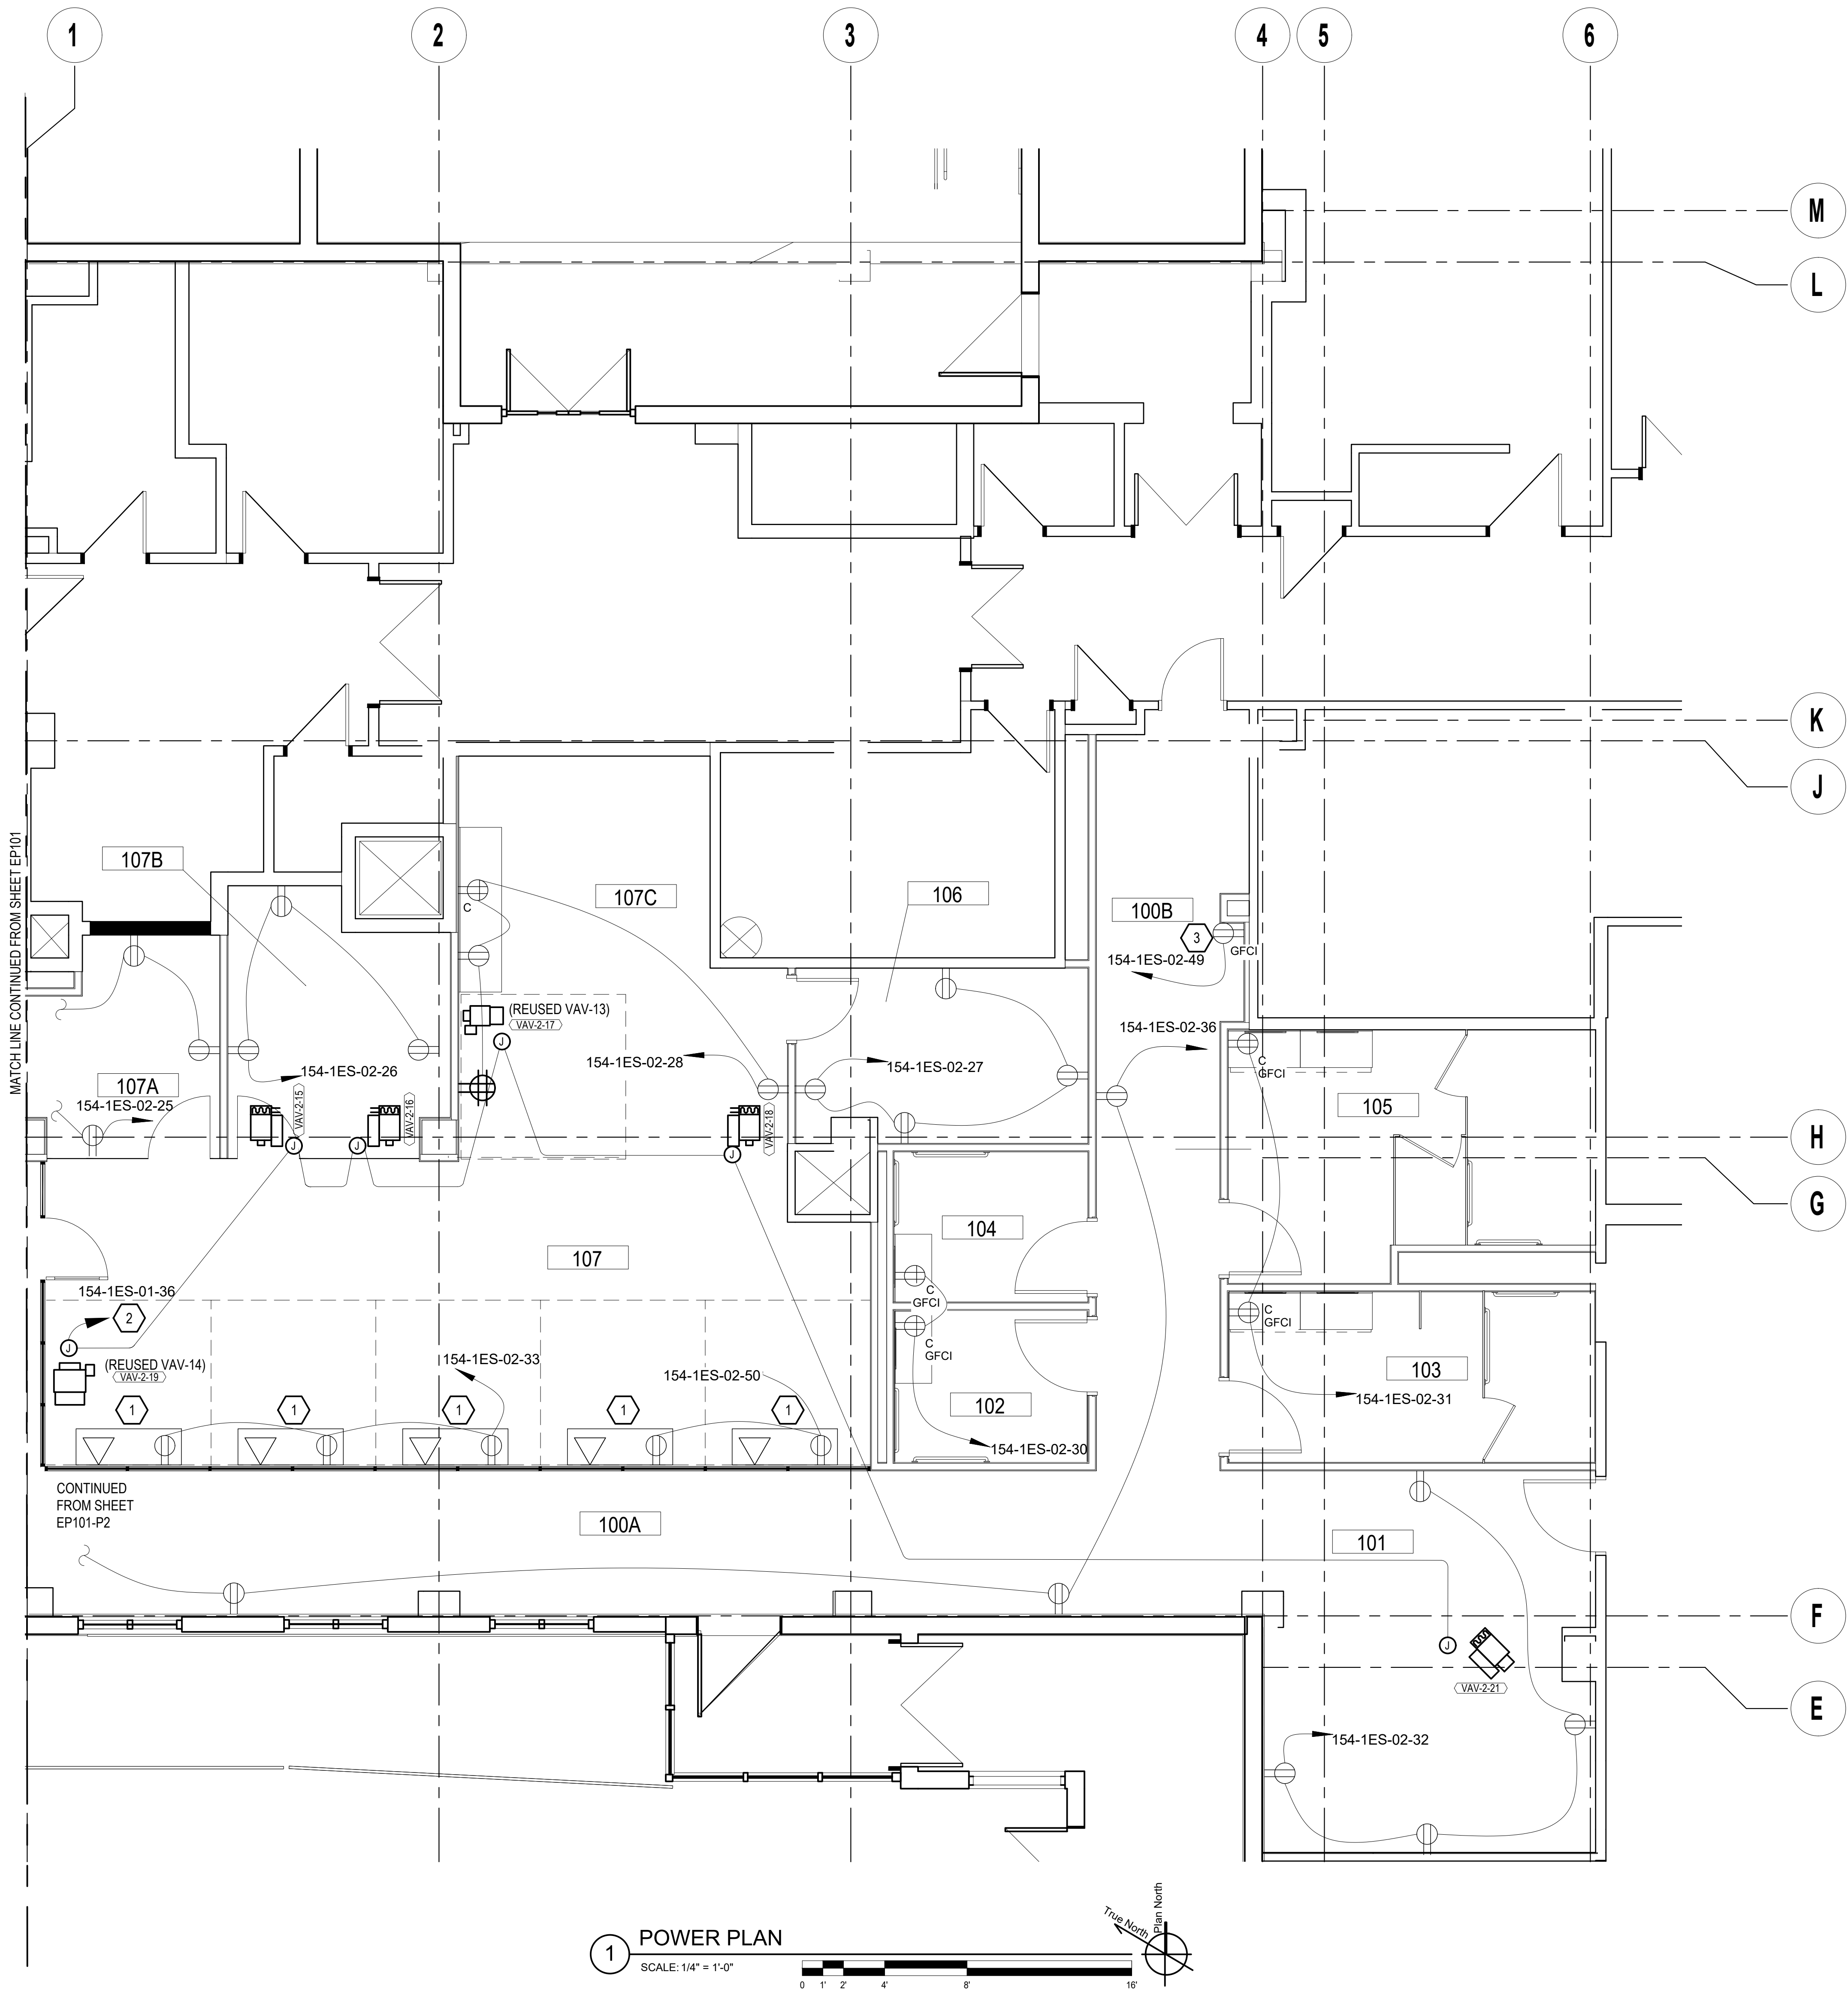

1 POWER PLAN
SCALE: 1/4" = 1'-0"

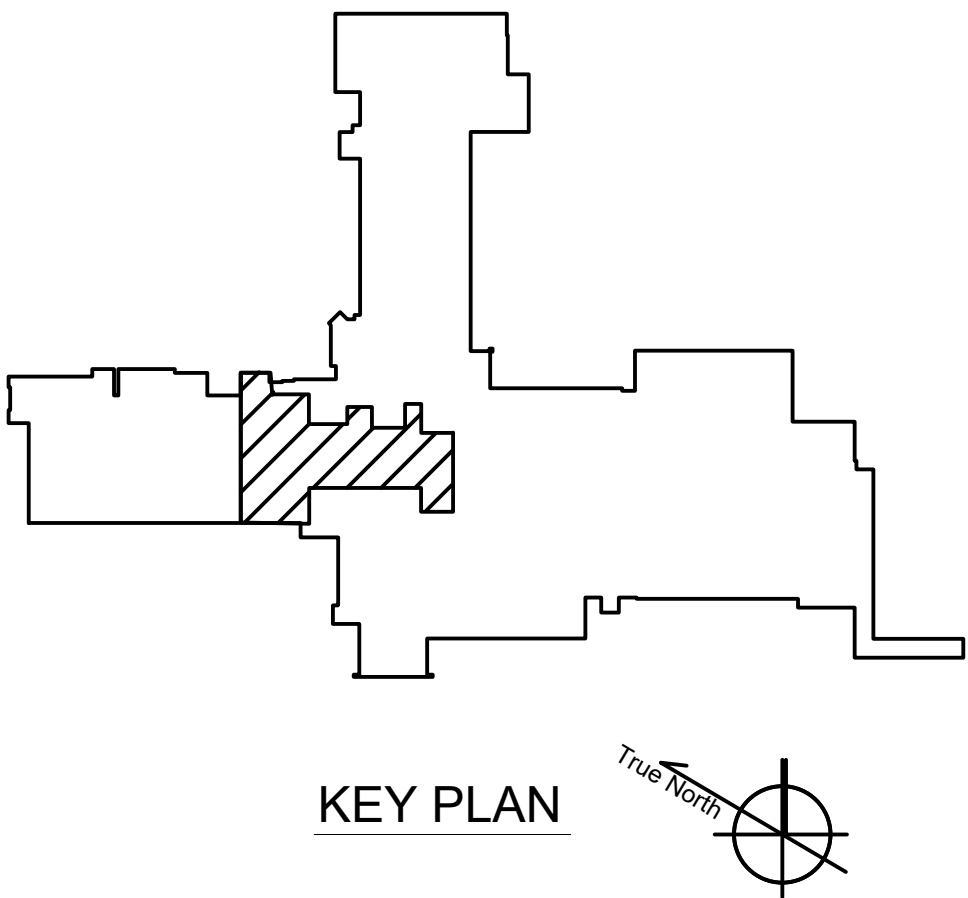

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ELECTRICAL GENERAL NOTES:

A. FOR SYMBOLS AND GENERAL NOTES SEE SHEET E-001 AND E-002.

KEY NOTES:



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





PROVIDE PANEL "154-1ES-03" AS SCHEDULED TO BE DEDICATED FOR " " ROOM POWER.
- 2

PROVIDE (2) NEMA L5-30R AND (1) DOUBLE-DUPLEX RECEPTACLE ABOVE RACK. CIRCUIT AS INDICATED.
- 3

PROVIDE NEMA L5-30R RECEPTACLE ON RACK FOR UPS SIMILAR TO APC SMART-UPS 500VA RACKMOUNT/TOWER UPS. UPS SHALL BE PROVIDED WITH DRY CONTACTS AND ONE "FORM C" CONTACT FOR LOCAL COMPUTER SIGNALING AND SHALL COME WITH COMPUTER SYSTEM SHUTDOWN SOFTWARE AND HARDWARE CONNECTIVITY, AS REQUIRED. UPS SHALL BE CAPABLE OF SUPPORTING 100% OF LOAD CONSISTING OF (2) CISCO 3850 SERVERS FOR A PERIOD OF ONE HOUR MINIMUM.
- 4

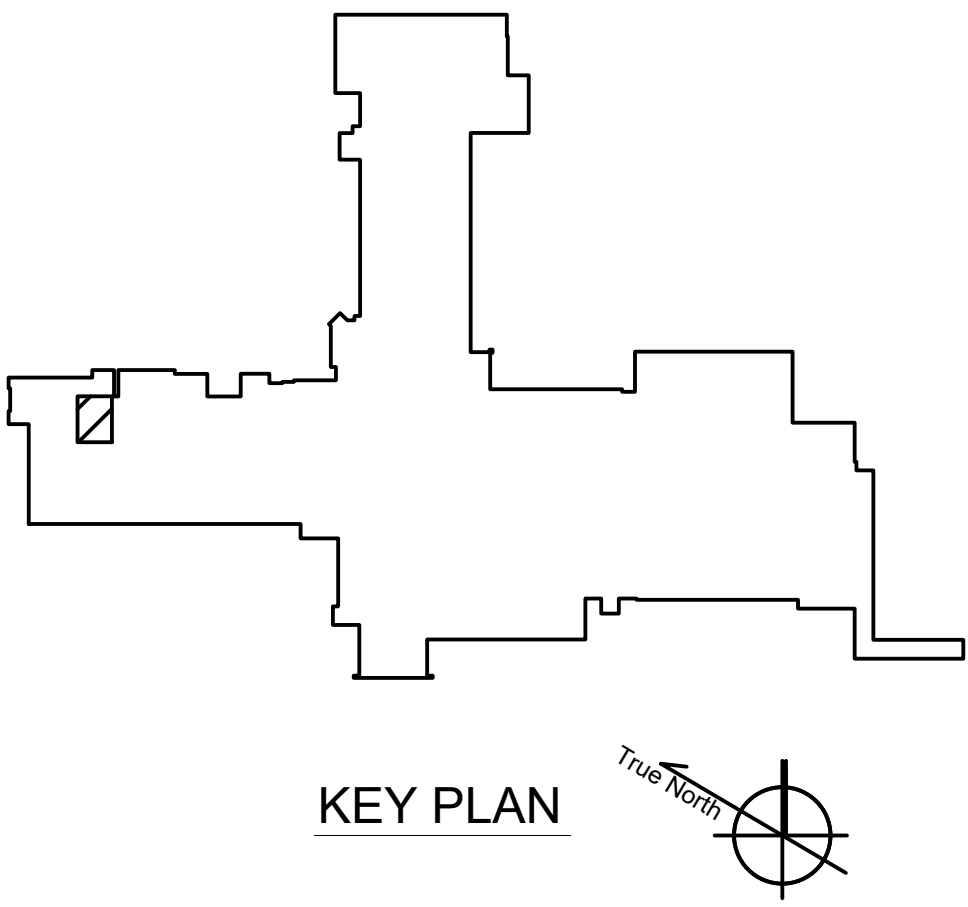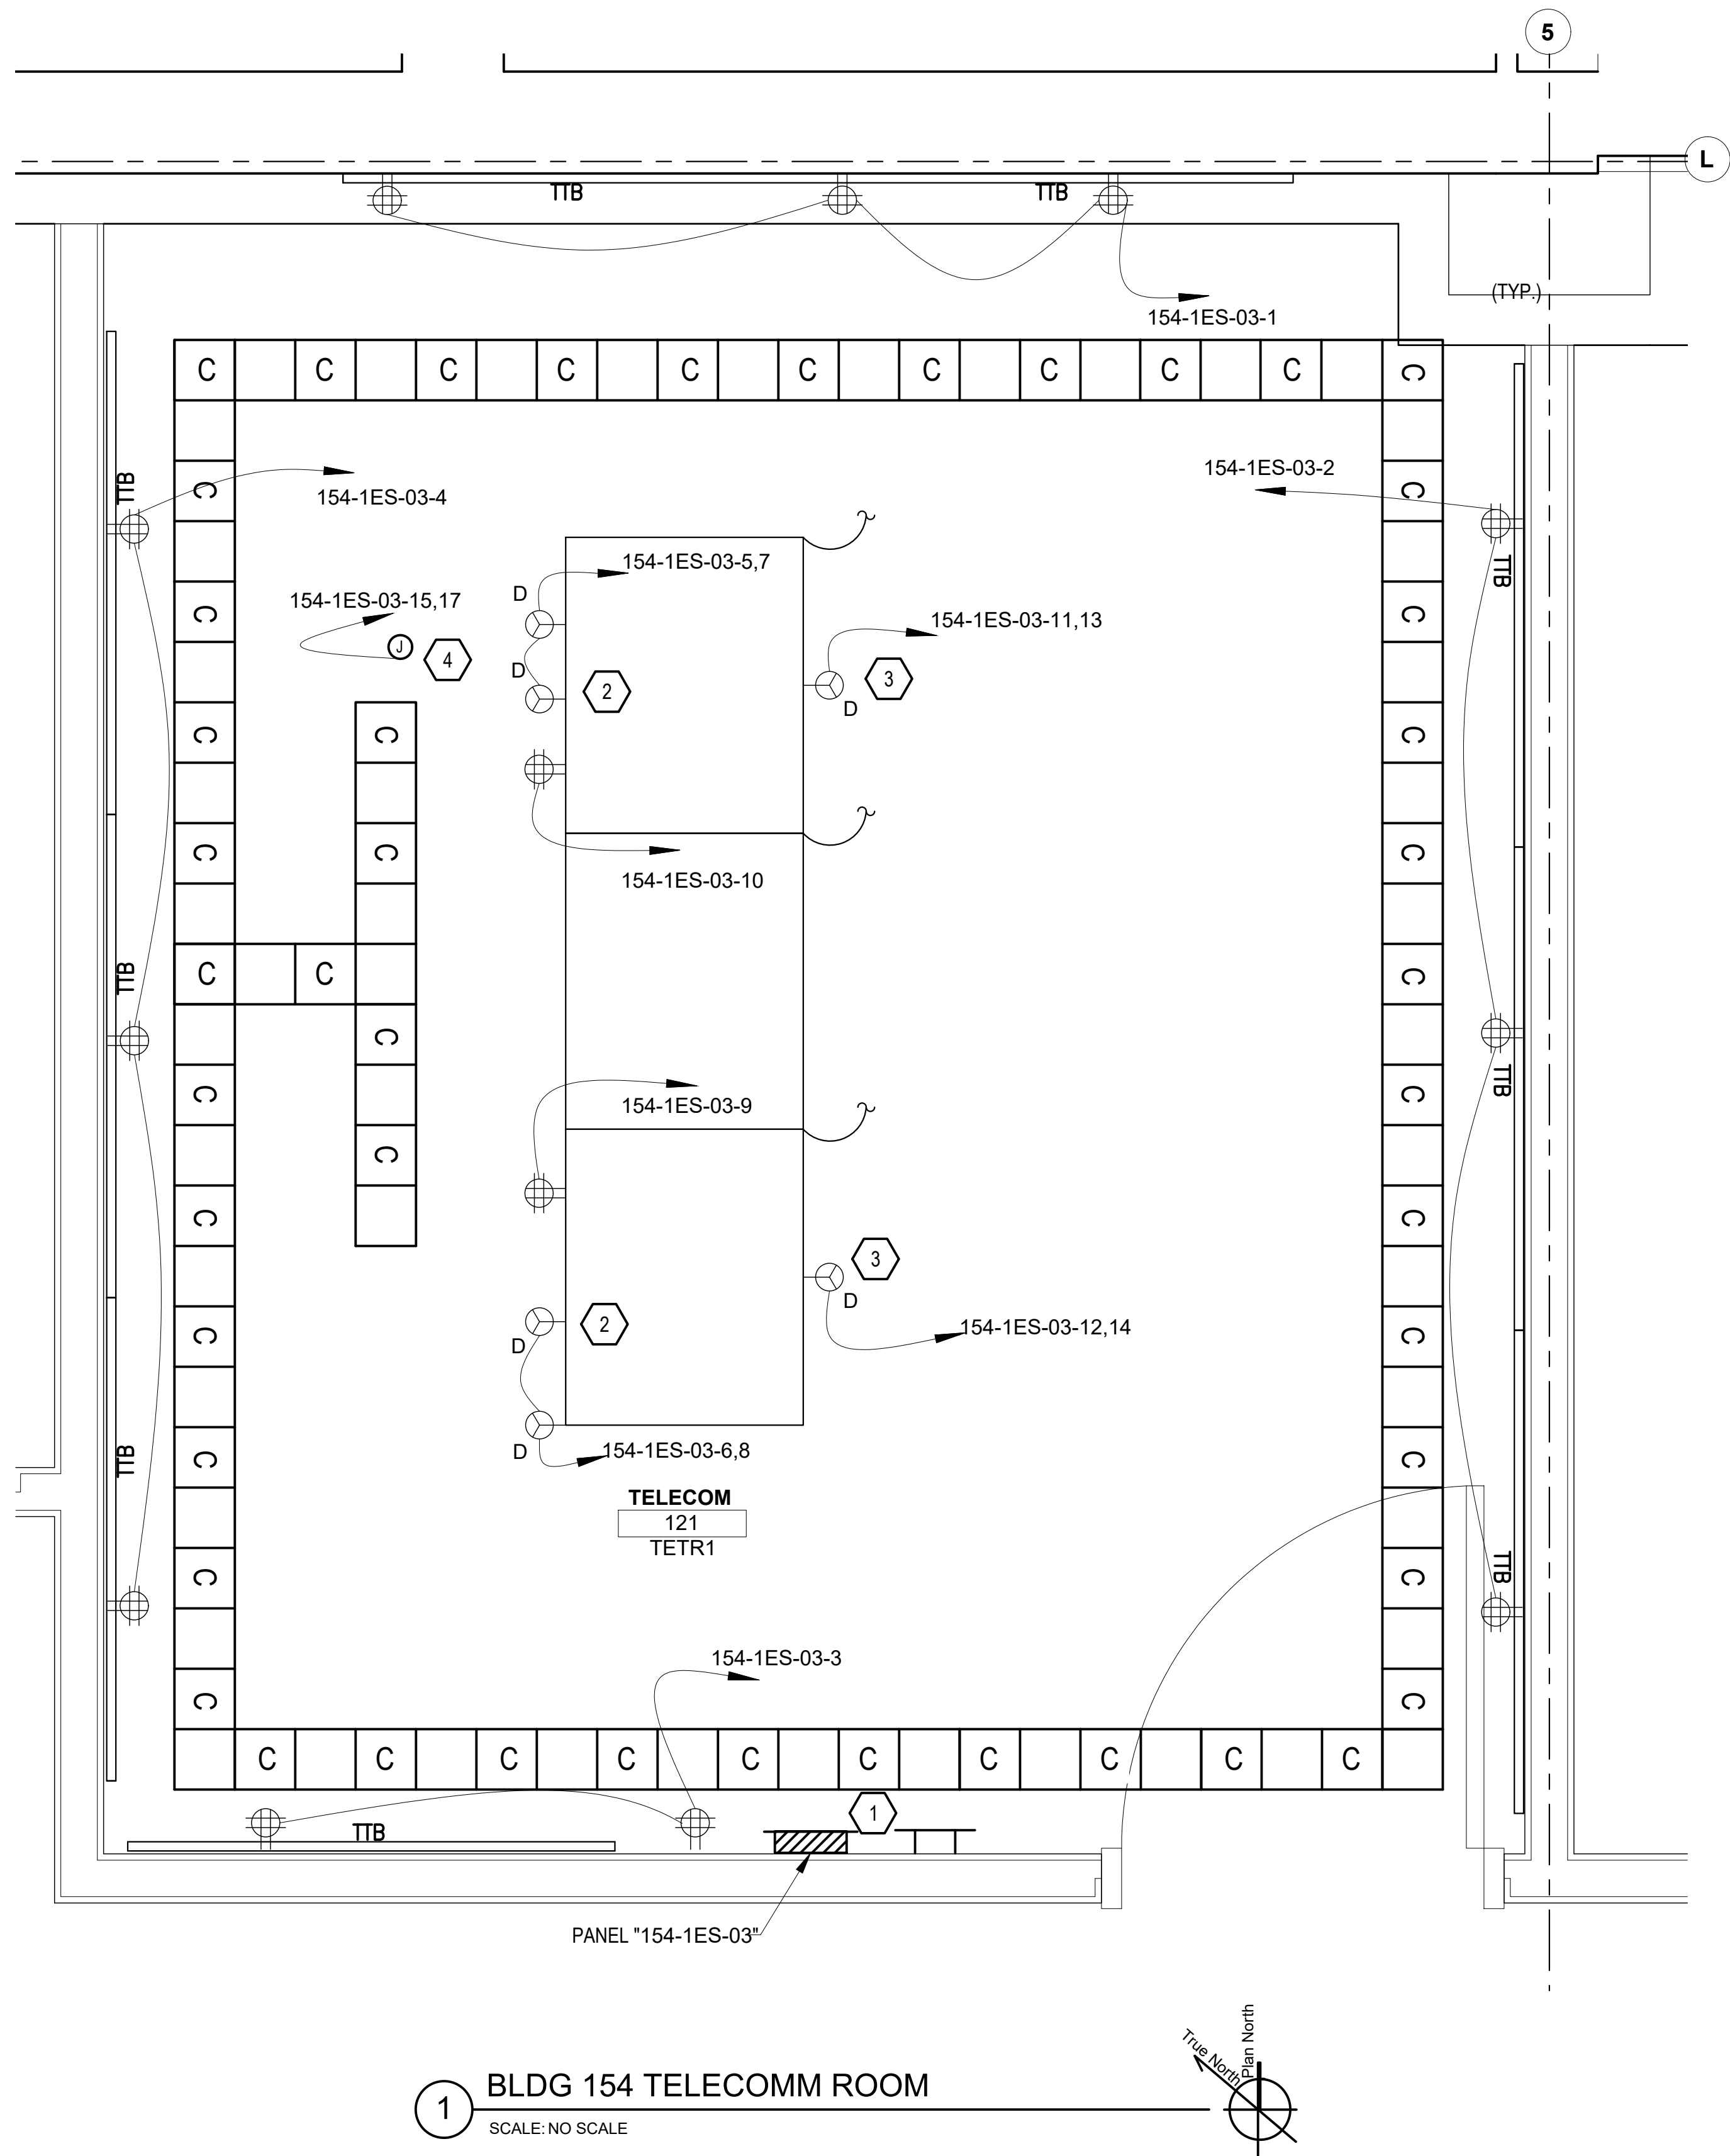PROVIDE CONNECTION FOR WALL-MOUNT COOLING UNIT. REFER TO MECHANICAL DRAWINGS FOR MORE INFORMATION.

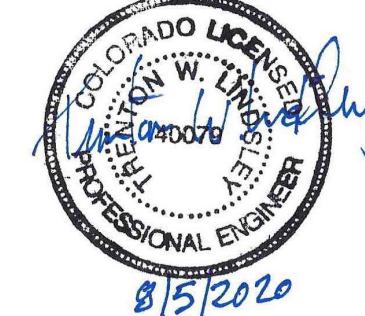



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								TELECOM ROOM POWER PLAN		100% CONSTRUCTION DOCUMENTS		OUTPATIENT MENTAL HEALTH / EDUCATION ADDITION		436-114	
		 		750 W HAMPDEN AVE SUITE #300 ENGLEWOOD CO 80110 (720) 550-6307 WWW.VALHALLAENGINEERING.COM				Approved: Project Director				Location 3687 VETERANS DRIVE, FORT HARRISON, MT 59636		Building Number 154	
Issued:		Date:		VEG 4.11								Issue Date 08/05/2020		Checked TL	
												Drawn GH		Drawing Number EP103-P2	

ELECTRICAL GENERAL NOTES:

A. FOR GENERAL NOTES AND SYMBOLS SEE SHEETS E-001 & E-002.

KEY NOTES:

- 1 PROVIDE DUPLEX DATA RECEPTACLE AND EMPTY SINGLE GANG BOX FOR TV LOCATION MOUNTED AT 60" ABOVE FINISHED FLOOR. PROVIDE 3/4" CONDUIT WITH PULL STRING TO ABOVE ACCESSIBLE CEILING FOR LOW VOLTAGE CABLING BY OTHERS. COORDINATE EXACT MOUNTING HEIGHT WITH CASE WORK DETAIL.
- 2 PROVIDE DUPLEX DATA BEHIND DROP DOWN PROJECTION SCREEN.
- 3 PROVIDING CEILING MOUNTED DUPLEX DATA OUTLET FOR PROJECTOR.
- 4 NOT USED
- 5 COORDINATE WITH VHA COR ON QUANTITY, TYPE, AND LOCATION OF DATA RECEPTACLES IN THIS ROOM PRIOR TO ROUGH-IN.
- 6 PROVIDE DUPLEX DATA RECEPTACLE AND EMPTY SINGLE GANG BOX FOR SMART BOARD LOCATION MOUNTED AT 60" ABOVE FINISHED FLOOR. PROVIDE 3/4" CONDUIT WITH PULL STRING TO ABOVE ACCESSIBLE CEILING FOR LOW VOLTAGE CABLING BY OTHERS. COORDINATE EXACT MOUNTING HEIGHT WITH ARCHITECT PRIOR TO ROUGH-IN.
- 7 PROVIDE JBOX FOR HEADWALL UNIT. COORDINATE WITH OTHERS TO INSTALL LOW VOLTAGE, MEDICAL GAS, VACUUM, OXYGEN, ETC. WITHOUT CONFLICT. JBOX LOCATED IN CHASE BEHIND HEADWALL IS FOR ALL LANDING ALL SIGNAL WIRES TO BE BROUGHT INTO HEADWALL.
- 8 SEE SHEET EP-103-P2 FOR MORE DETAIL ON TELCOM ROOM POWER. SEE SHEET ET-103-P2 FOR MORE DETAIL ON TELCOM ROOM DATA.
- 9 LINK NURSE CALL AND LIGHT POWER OVER ETHERNET BACK TO NURSE CALL ROUTER IN TELECOM ROOM TO FEED SIGNAL AND POWER INTO EXISTING NURSE CALL SYSTEM HEAD IN ROOM B13 IN BASEMENT USING CAT6 CABLE.
- 10 EXISTING SPEAKERS FOR PUBLIC ADDRESS SYSTEM TO BE REINSTALLED IN NEW CEILING.
- 11 FIELD COORDINATE ALL WIFI LOCATIONS WITH THE IT DEPARTMENT PRIOR TO START. ACCESS POINT HEAT MAP PROVIDED BY OIT.
- 12 RE-USE EXISTING CABLE J-HOOKS AND EXTEND INTO NEW IT ROOM 121 PER VA SPECIFICATION 270533 AND 270526 HEAD IN LOCATION ARE AS FOLLOWS: ROOM 9 IN BASEMENT FOR IT, ROOM B1A IN BASEMENT FOR FIBER, ROOM B13 IN BASEMENT FOR PUBLIC ADDRESS, INTERCOM, VAV CONTROL AND FOR WIRELESS ACCESS POINT.
- 13 PROVIDE VOICE ACTIVATED INTERCOM FROM CONTROL TO LAB.

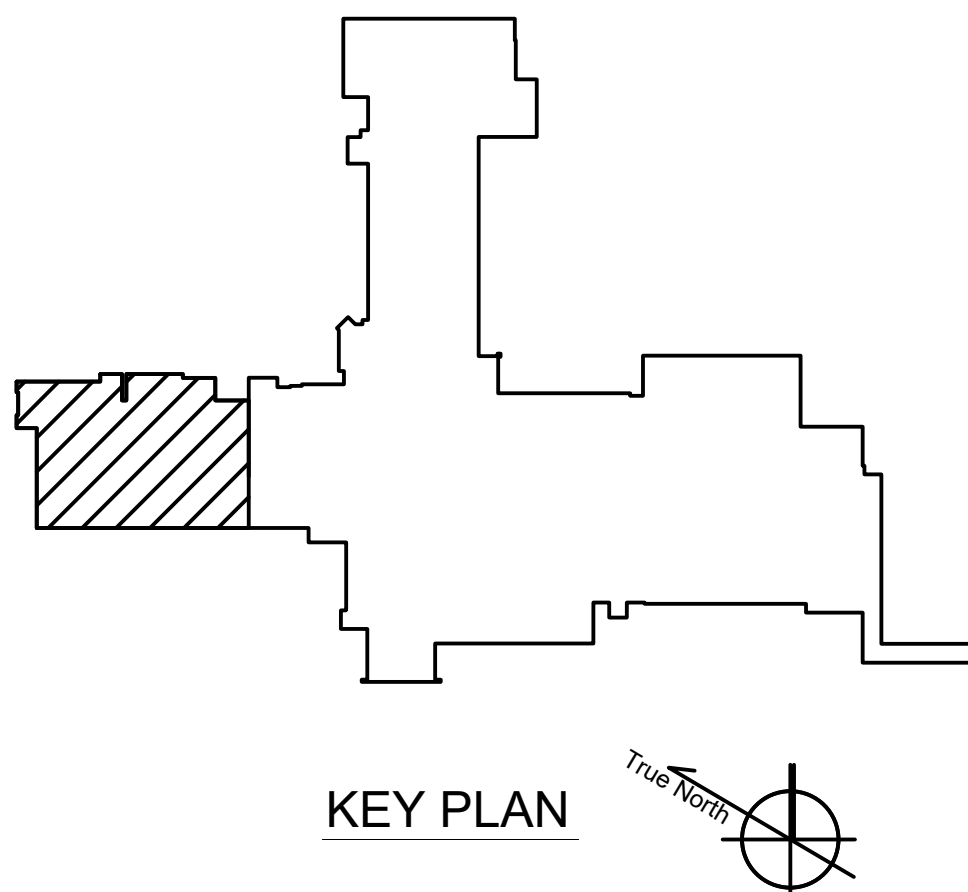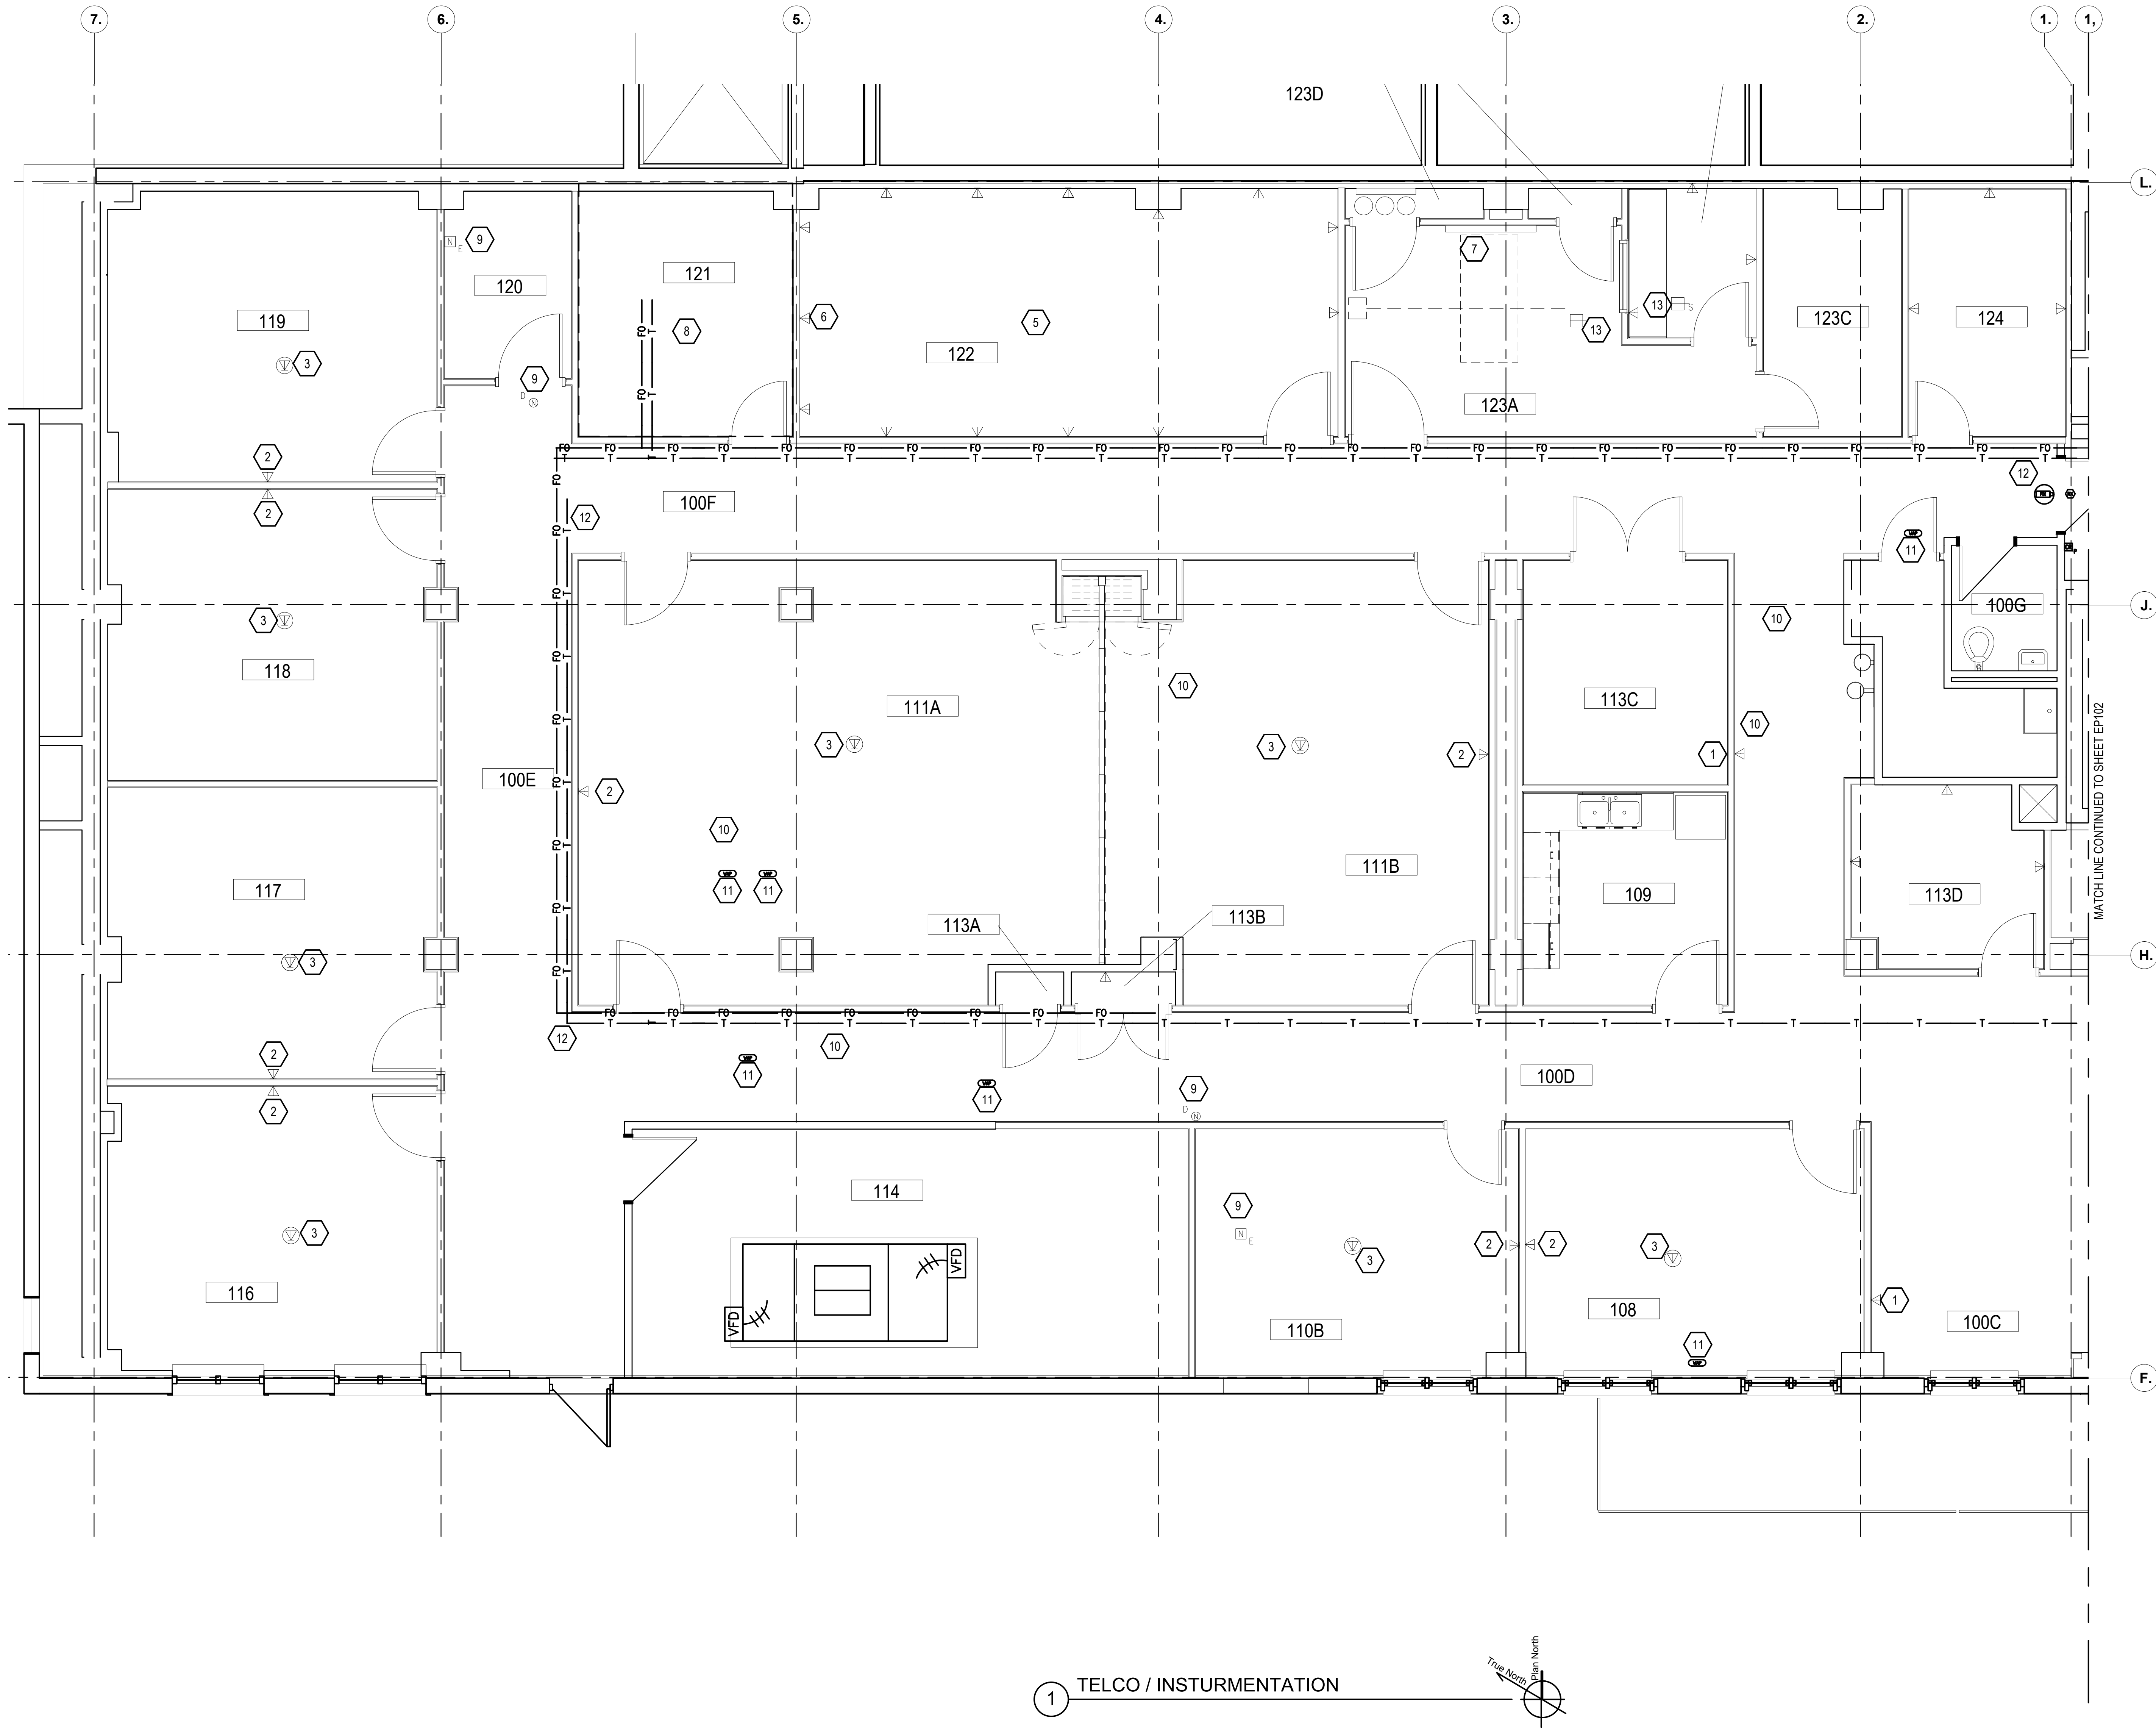

1 TELCO / INSTRUMENTATION



Issued:	Date:	CONSULTANTS: HOEFER WYSOCKI 11460 TOMAHAWK CREEK PARKWAY SUITE 400 LEANWOOD, KANSAS 66041 LAND3 Protection Engineering JIRSA HEDRICK Structural Engineers	ARCHITECT/ENGINEERS: VALHALLA ENGINEERING GROUP, LLC 750 W HAMPDEN AVE SUITE #300 ENGLEWOOD CO 80110 (720) 550-6307 WWW.VALHALLAENGINEERING.COM VEG 4.11	STAMP: 		Drawing Title TELCO / INSTRUMENTATION PLAN - FIRST FLOOR WEST Approved: Project Director	Phase 100% CONSTRUCTION DOCUMENTS	Project Title OUTPATIENT MENTAL HEALTH / EDUCATION ADDITION Location 3687 VETERANS DRIVE, FORT HARRISON, MT 59636 Issue Date 08/05/2020	Project Number 436-114 Building Number 154 Drawing Number ET101-P2
								Checked TL Drawn GG	

ELECTRICAL GENERAL NOTES:


A. FOR GENERAL NOTES AND SYMBOLS SEE SHEET E-001 & E-002.





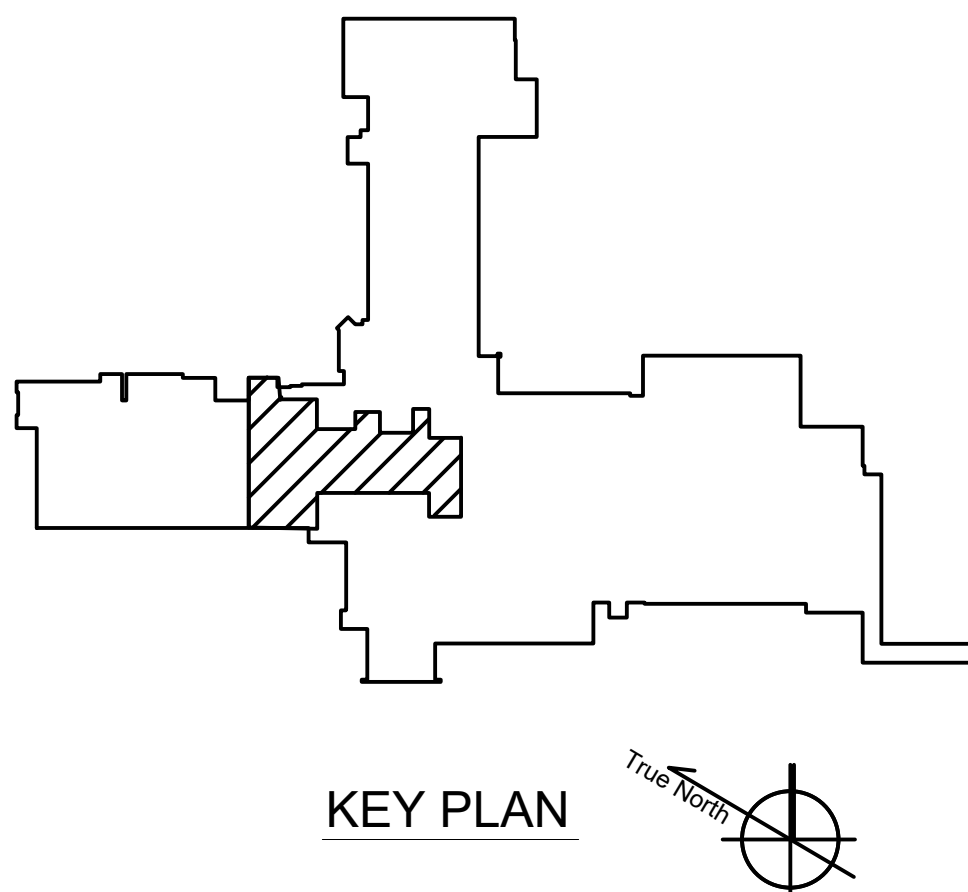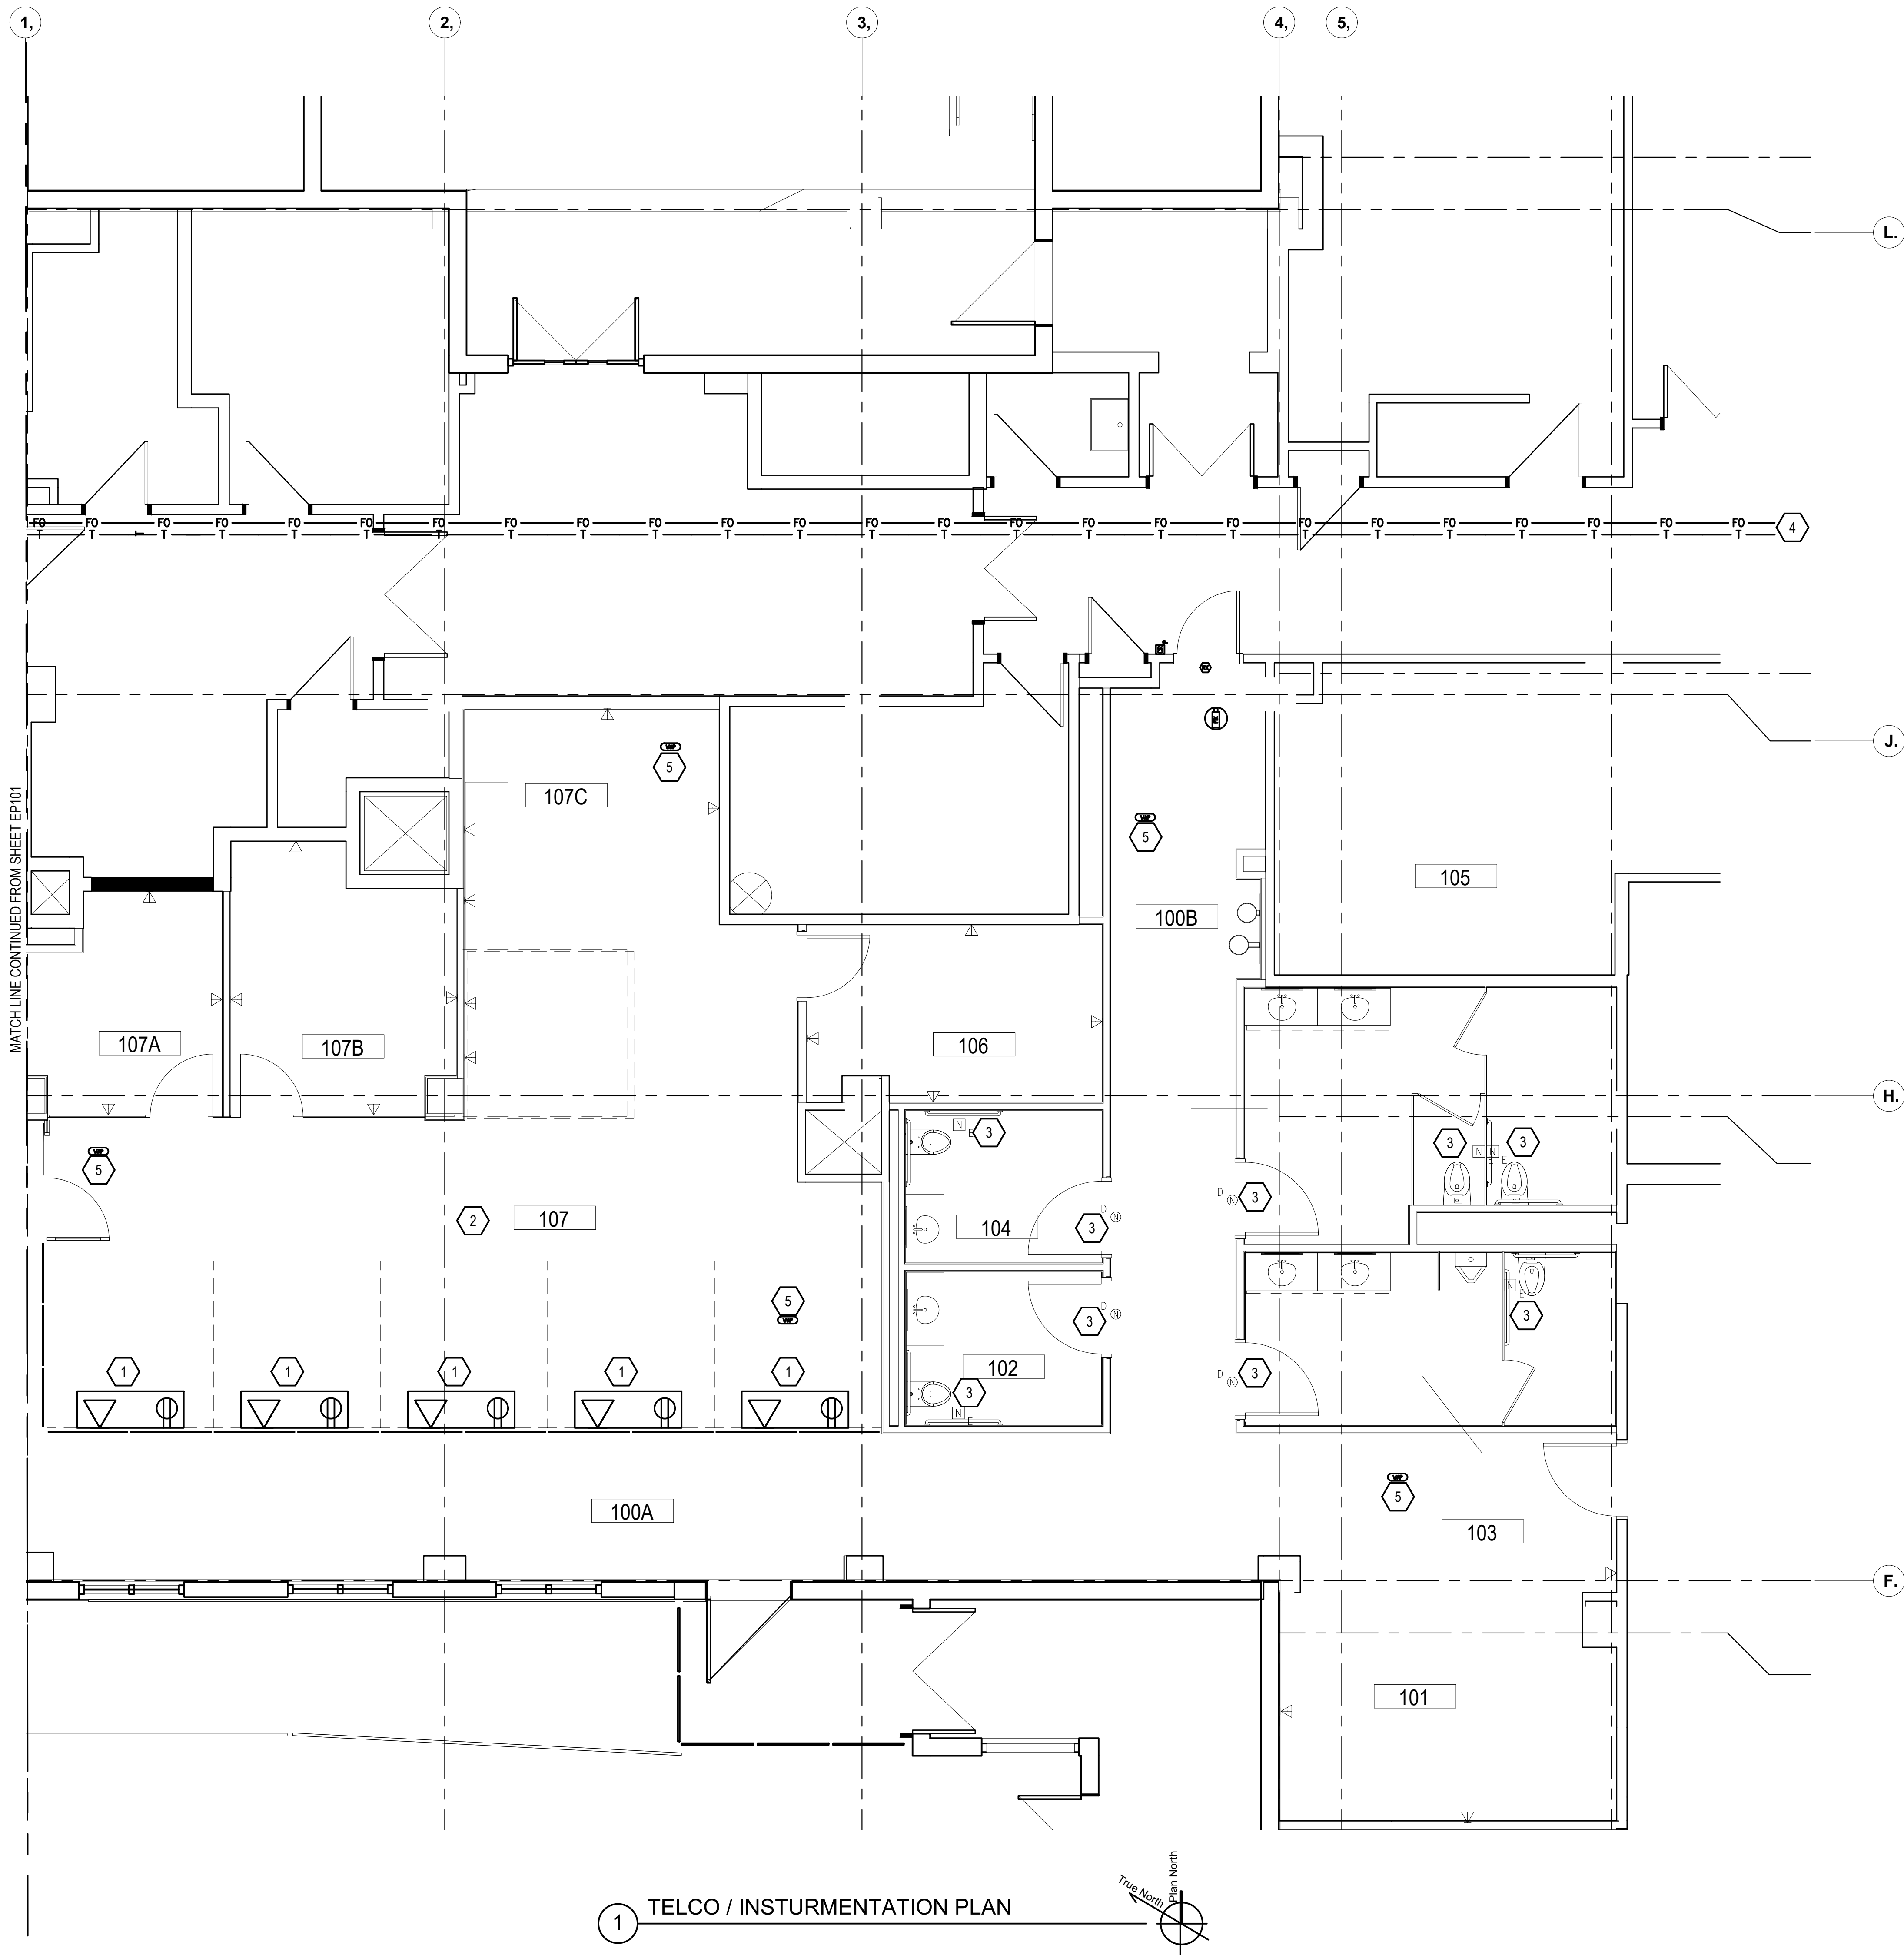

KEY NOTES:

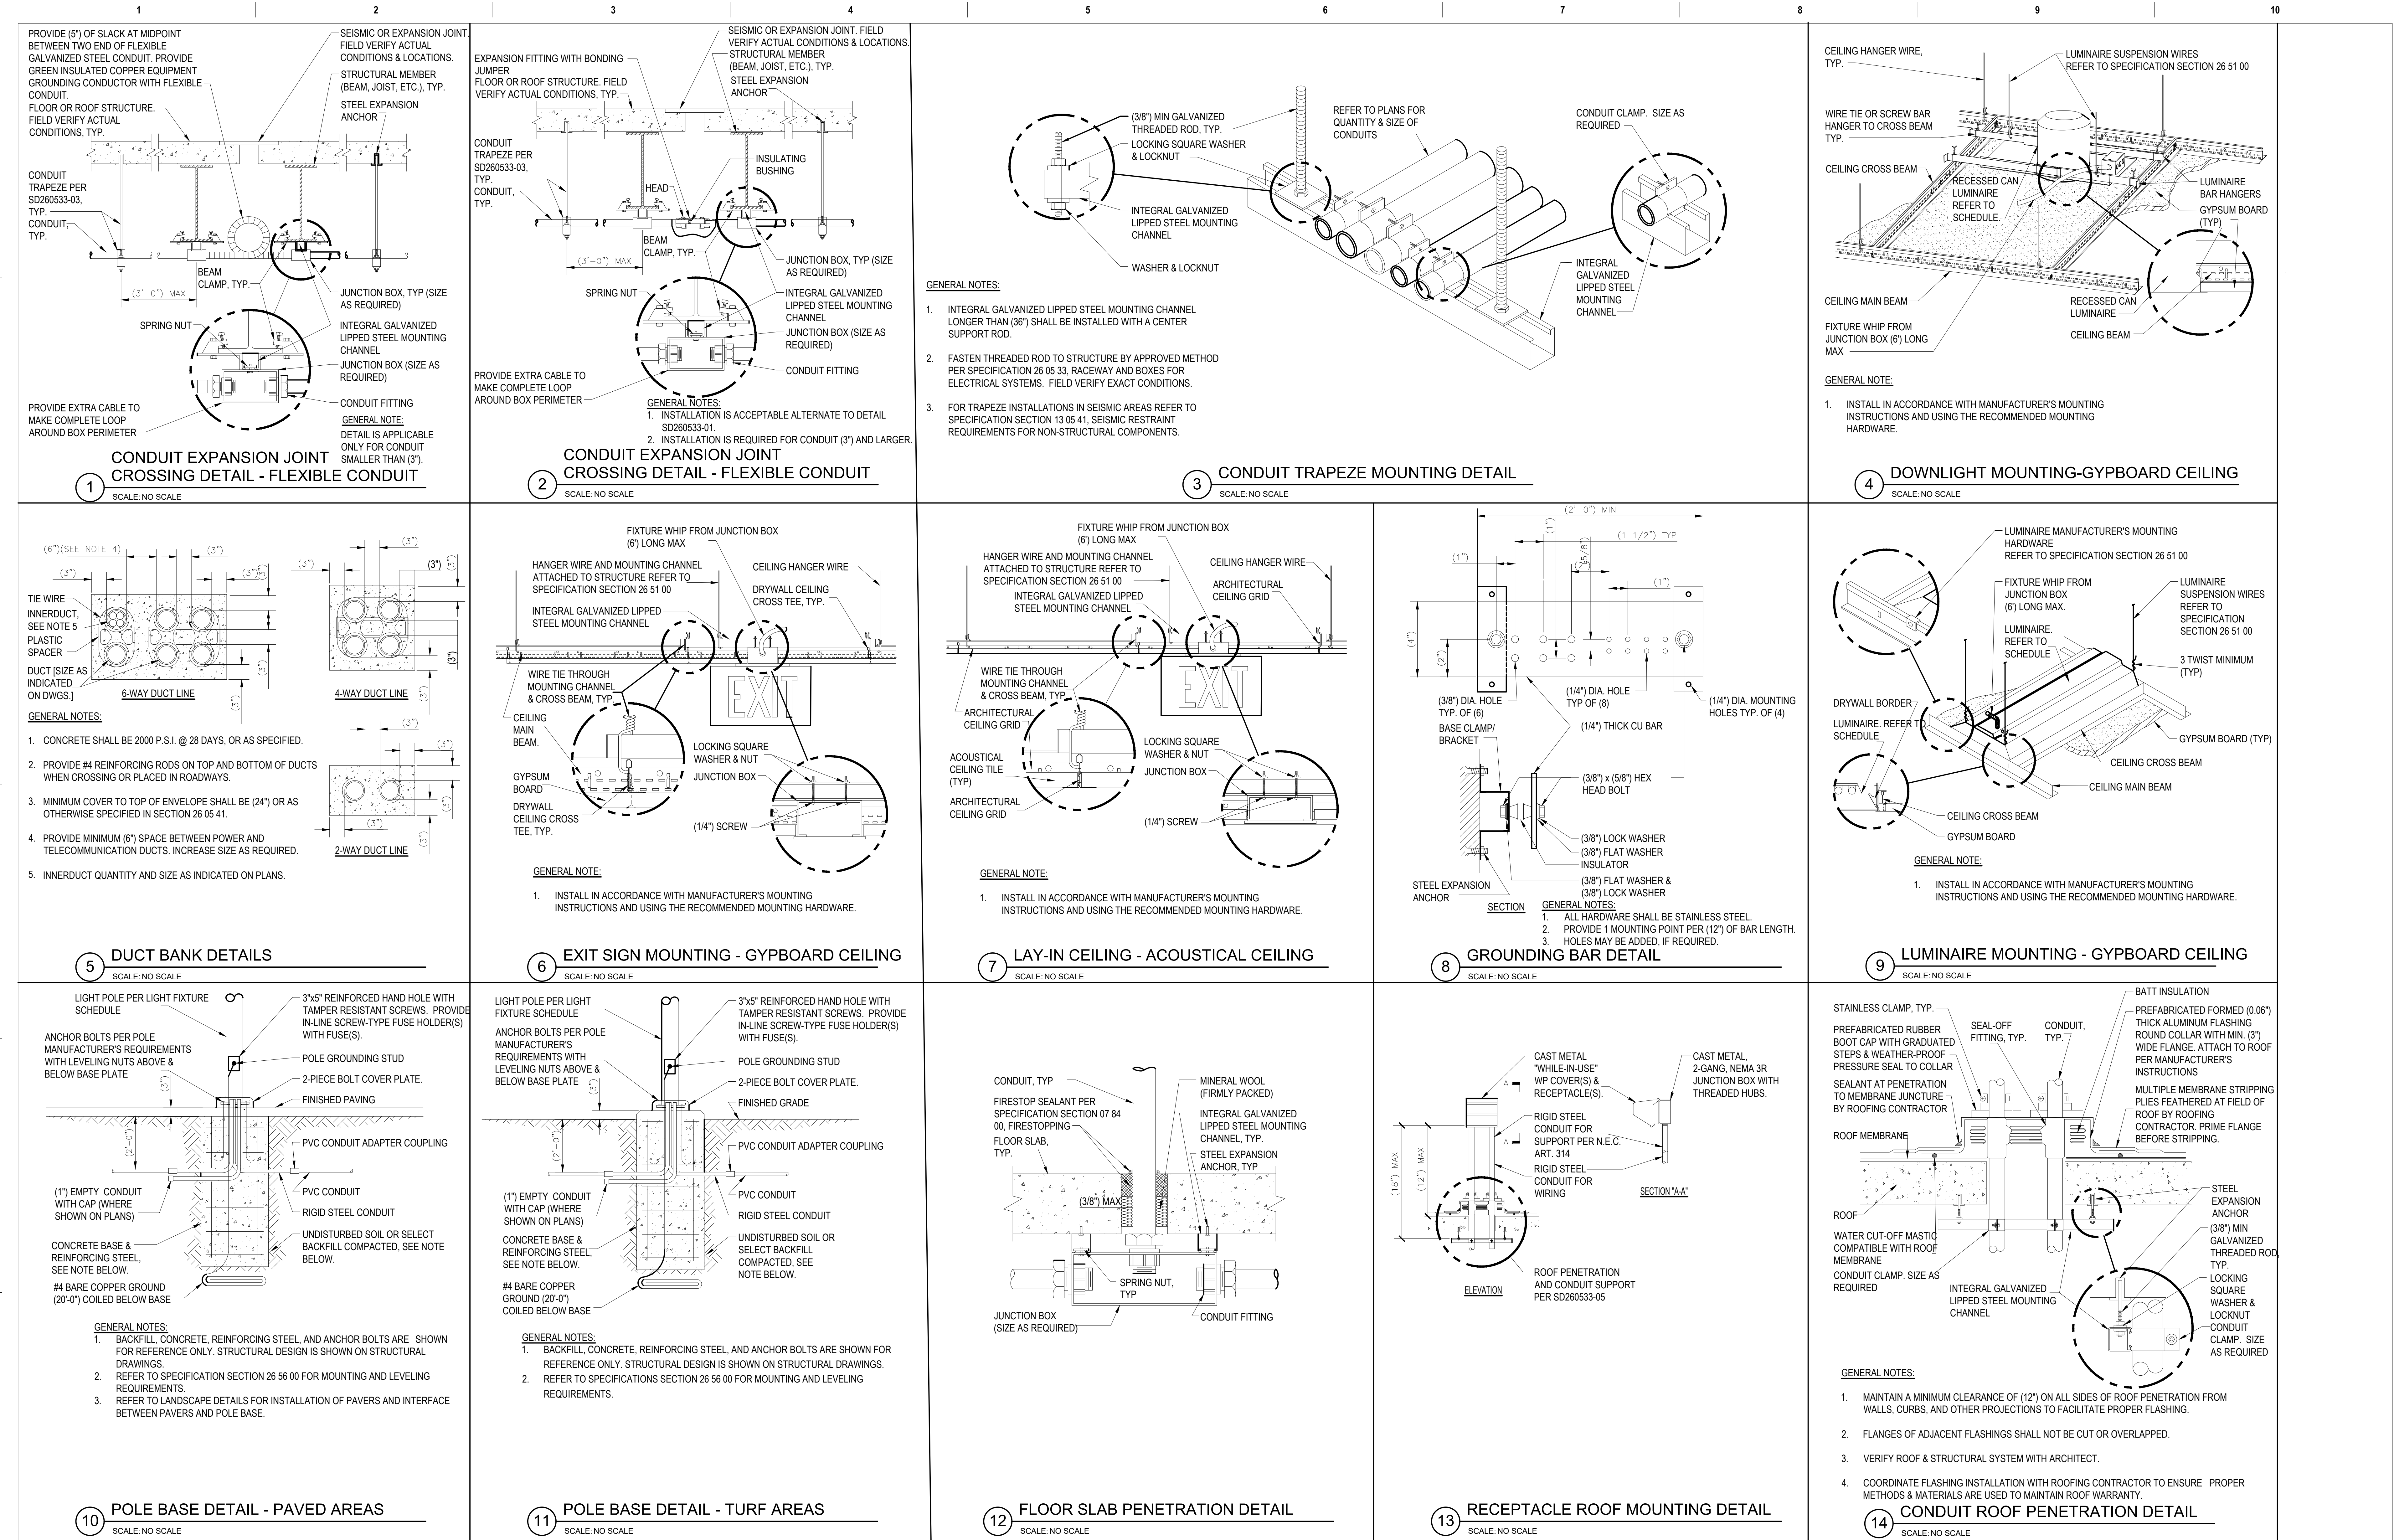
- 1 PROVIDE CONCRETE FLOOR BOX WITH A SINGLE DUPLEX 20A, 120V RECEPTACLE AND A DUPLEX DATA OUTLET SIMILAR TO LEGRAND RP82-OG. VERIFY EXACT LOCATION PRIOR TO ROUGH-IN
- 2 COORDINATE WITH VHA COR ON QUANTITY, TYPE, AND LOCATION OF DATA RECEPTACLES IN THIS ROOM PRIOR TO ROUGH-IN.
- 3 LINK NURSE CALL AND LIGHT POWER OVER ETHERNET BACK TO NURSE CALL ROUTER IN TELECOM ROOM 121 TO FEED SIGNAL AND POWER INTO EXISTING NURSE CALL SYSTEM HEAD IN ROOM B13 IN BASEMENT USING CAT6 CABLE.
- 4 RE-USE EXISTING CABLE J-HOOKS AND EXTEND INTO NEW IT ROOM 121 PER VA SPECIFICATION 270533 AND 270526 HEAD IN LOCATION ARE AS FOLLOWS: ROOM 9 IN BASEMENT FOR IT, ROOM B1A IN BASEMENT FOR FIBER, ROOM B13 IN BASEMENT FOR PUBLIC ADDRESS, INTERCOM, VAV CONTROL AND FOR WAP.
- 5 FIELD COORDINATE ALL WIFI LOCATIONS WITH THE VHA COR PRIOR TO START. ACCESS POINT HEATMAP PROVIDED BY OIT.




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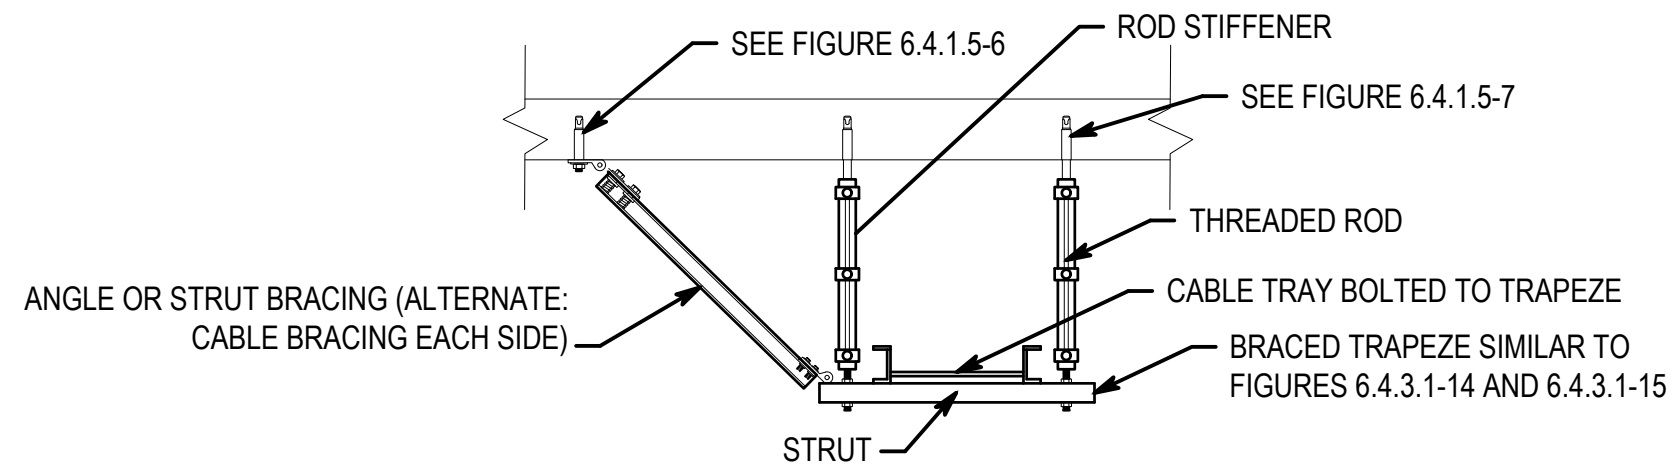


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 HOEFER WYSOCKI 1640 TOMAHAWK CREEK PARKWAY SUITE 400 LEANWOOD, KANSAS 66041		 VALHALLA ENGINEERING GROUP, LLC 750 W HAMPTON AVE SUITE #300 ENGLEWOOD CO 80110 (720) 550-6307 WWW.VALHALLAENGINEERING.COM				ELECTRICAL DETAIL SHEET		100% CONSTRUCTION DOCUMENTS		OUTPATIENT MENTAL HEALTH / EDUCATION ADDITION		436-114	
 Protection Engineering CONSULTANTS		 JIRSA HEDRICK Structural Engineers				Approved: Project Director				Location 3687 VETERANS DRIVE, FORT HARRISON, MT 59636		Drawing Number	
Issued:		Date:		VEG 4.11						Issue Date 08/05/2020		Checked TL	
										Drawn BWW		E-501	



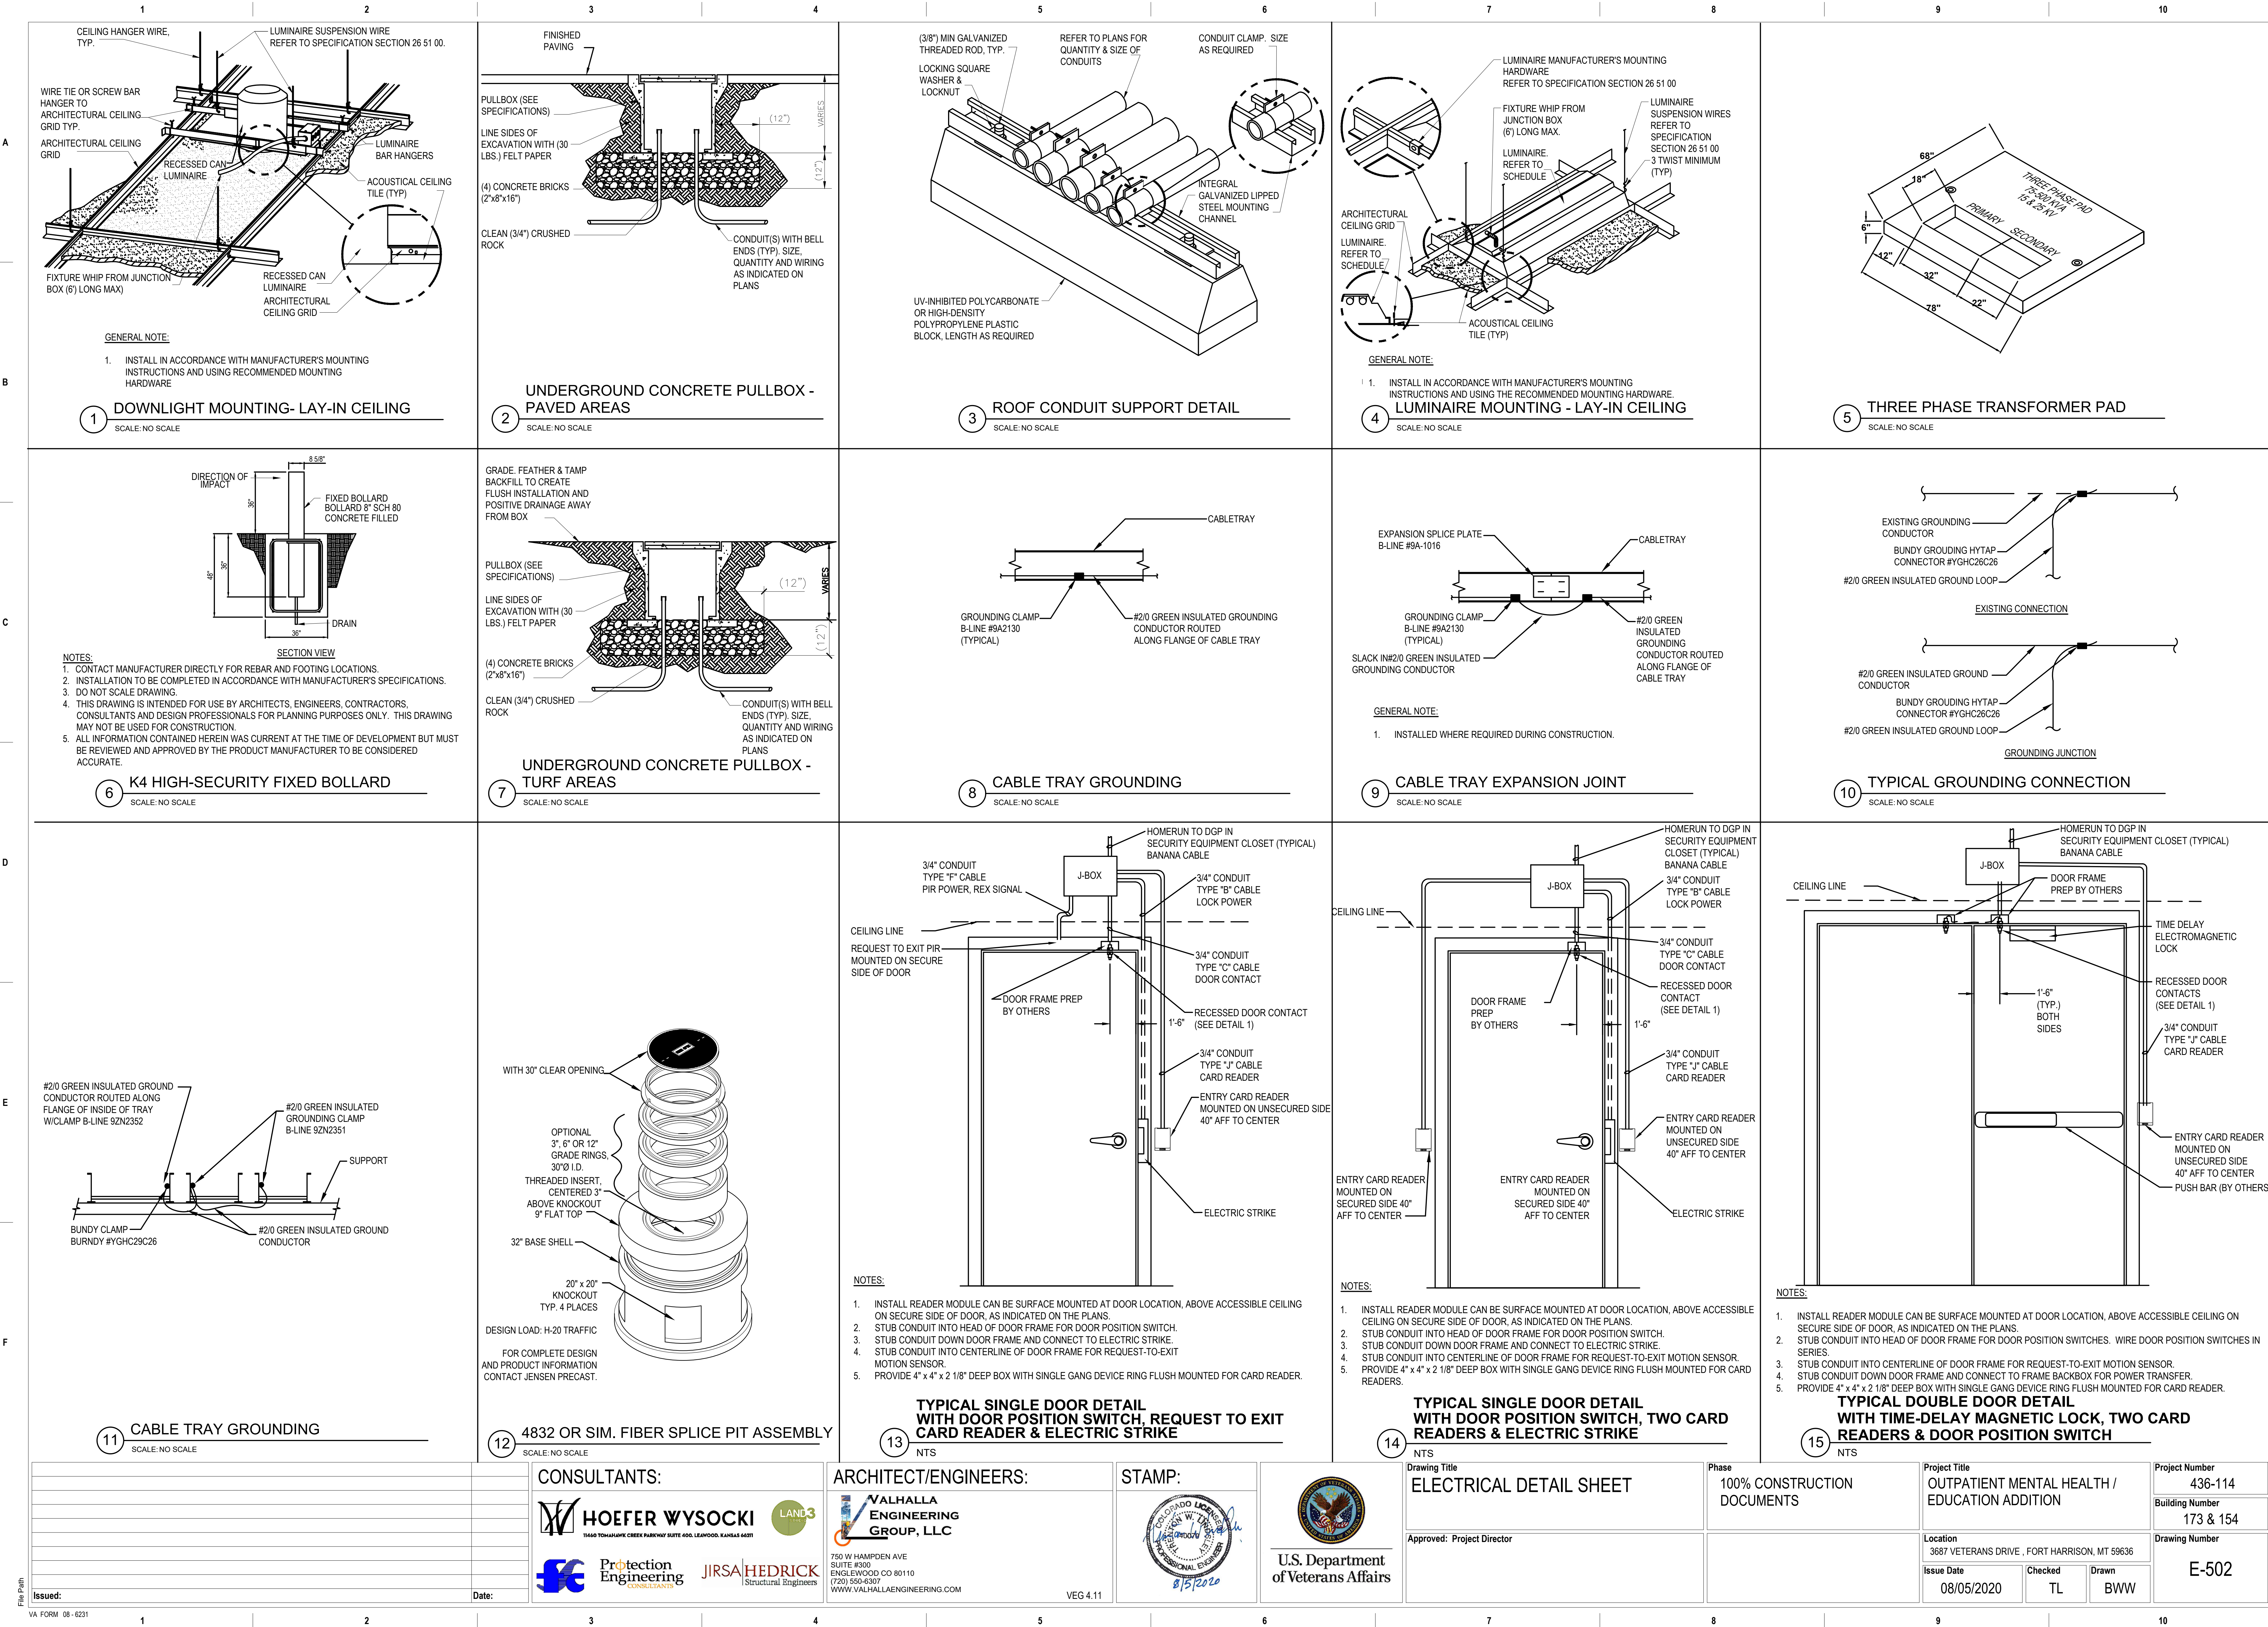

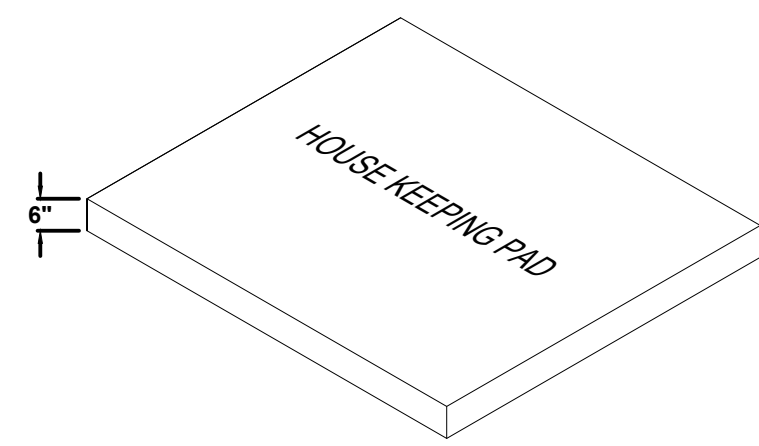
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SCALE: NO SCALE




2 CABLE TRAY ON BRACED TRAPEZE
SCALE: NO SCALE

ELECTRICAL GENERAL NOTES:


- SEE SHEET E-001 FOR SEISMIC RESTRAINT NOTES AND FACILITY-SPECIFIC SEISMIC DESIGN BASIS PARAMETERS.
- FIGURES ARE FROM FEMA E-74 REDUCING THE RISKS OF NONSTRUCTURAL EARTHQUAKE DAMAGE - A PRACTICAL GUIDE, DECEMBER 2012.

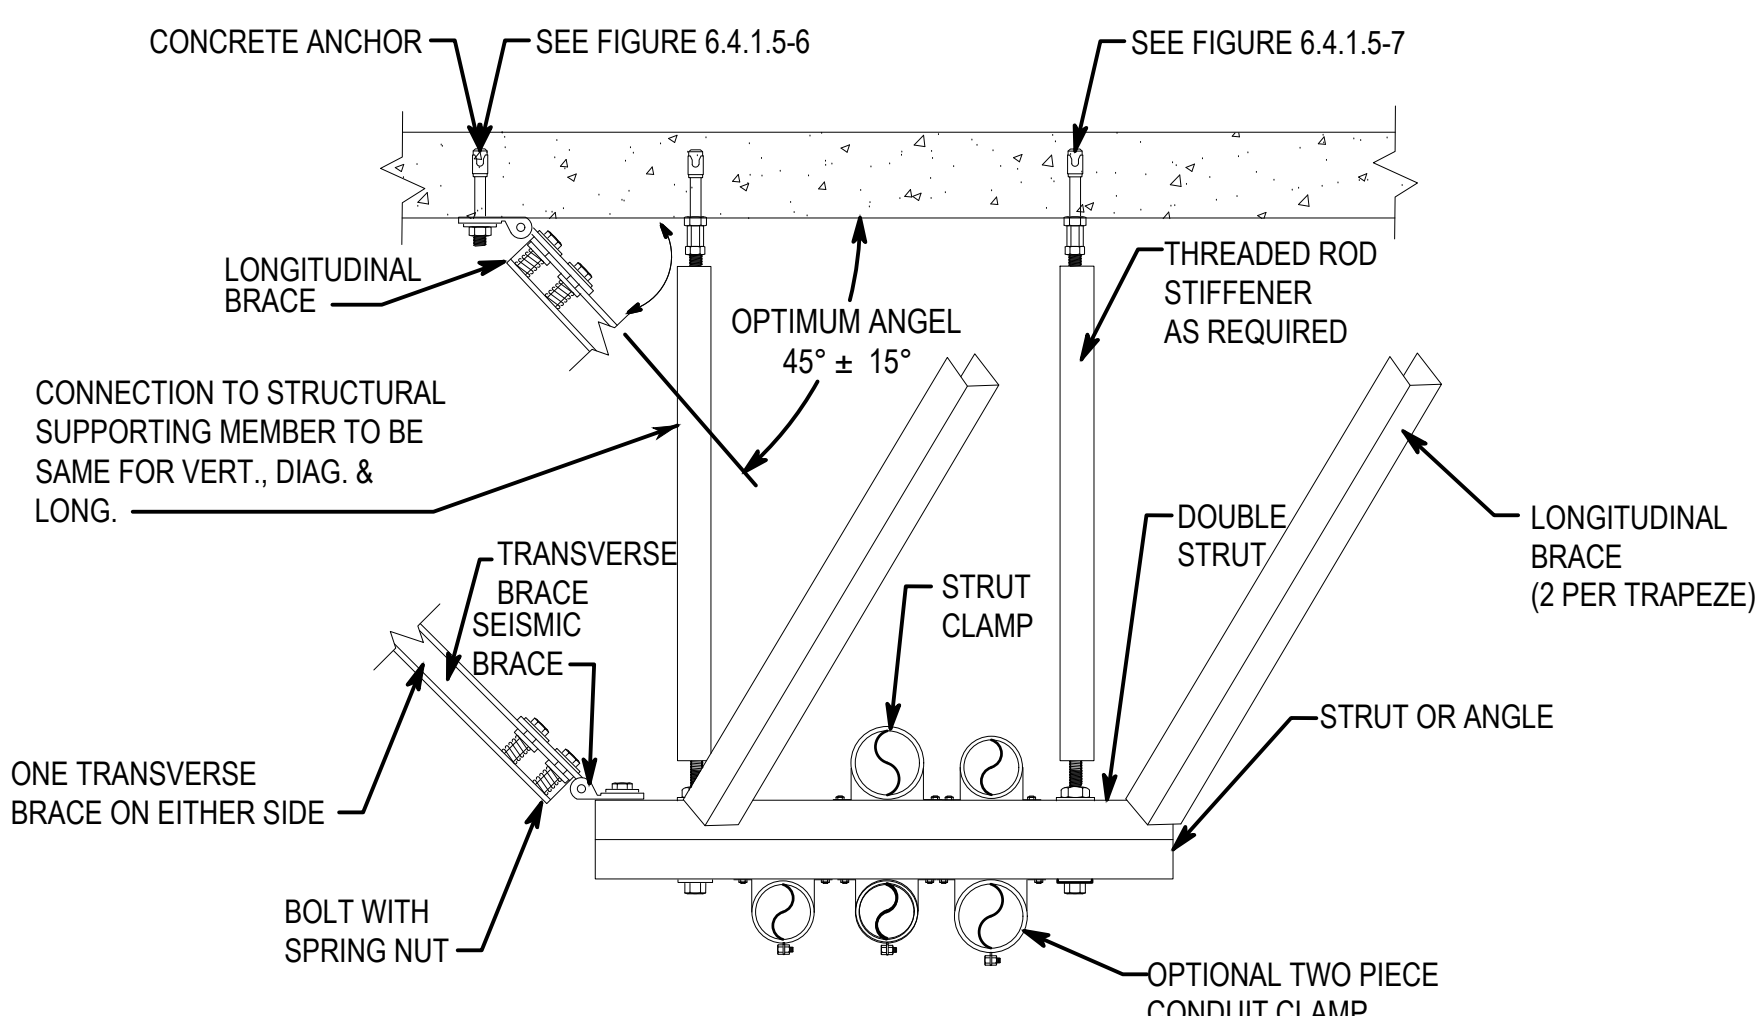


3 RIGID BRACING - TRAPEZE SUPPORTED CONDUIT
SCALE: NO SCALE

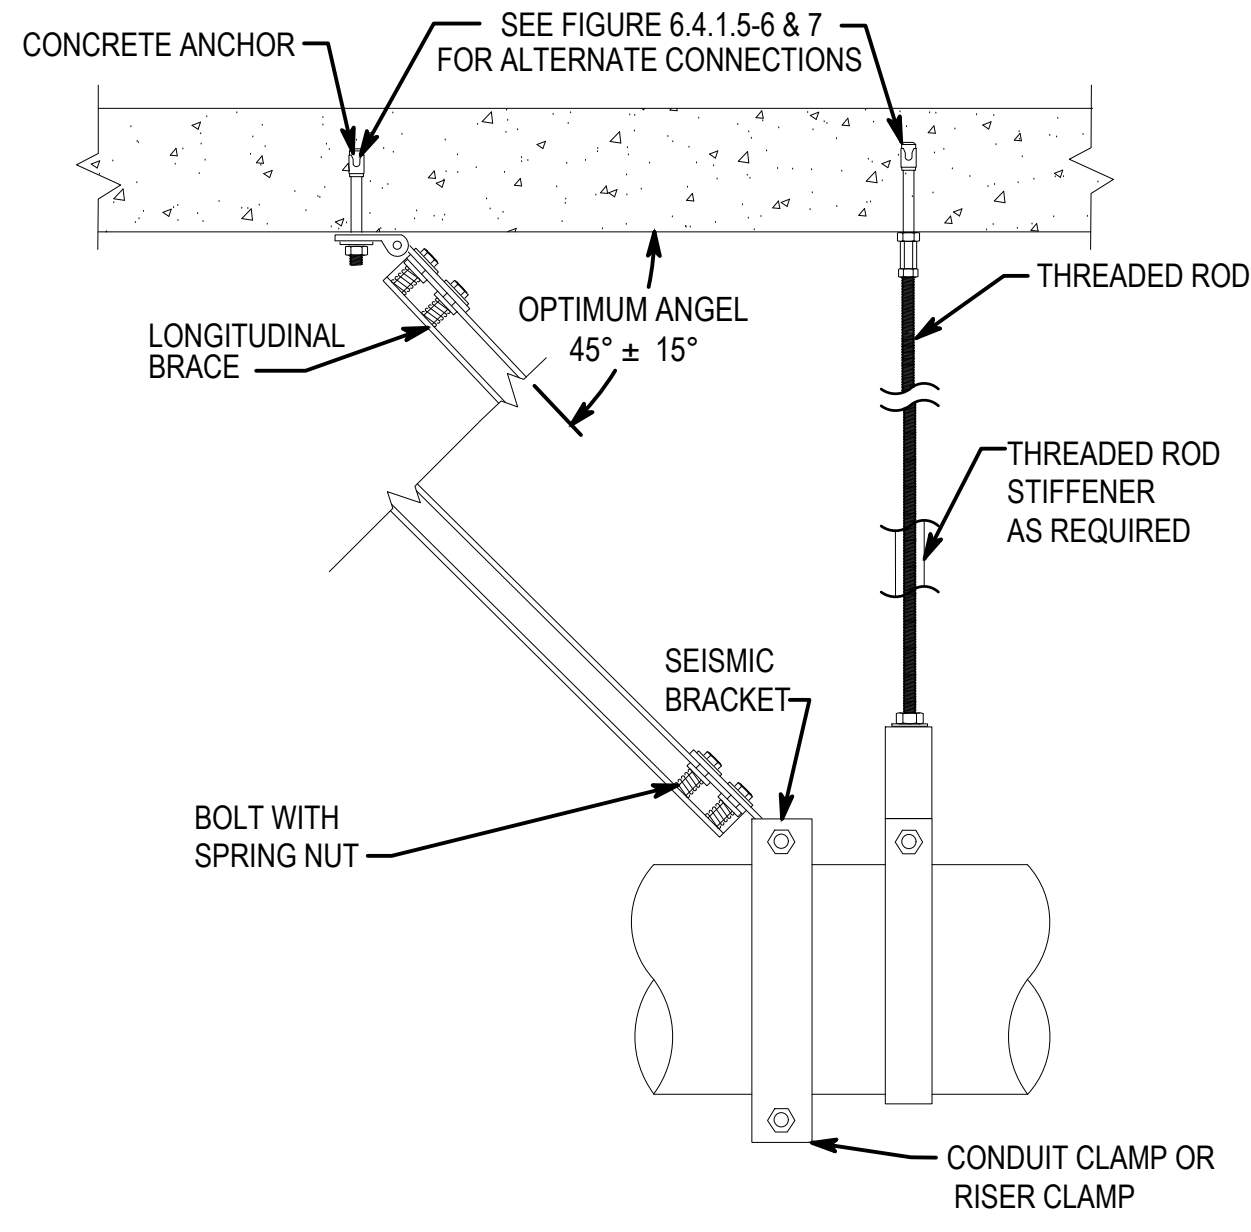


4 RIGID BRACING - SINGLE CONDUIT LONGITUDINAL
SCALE: NO SCALE

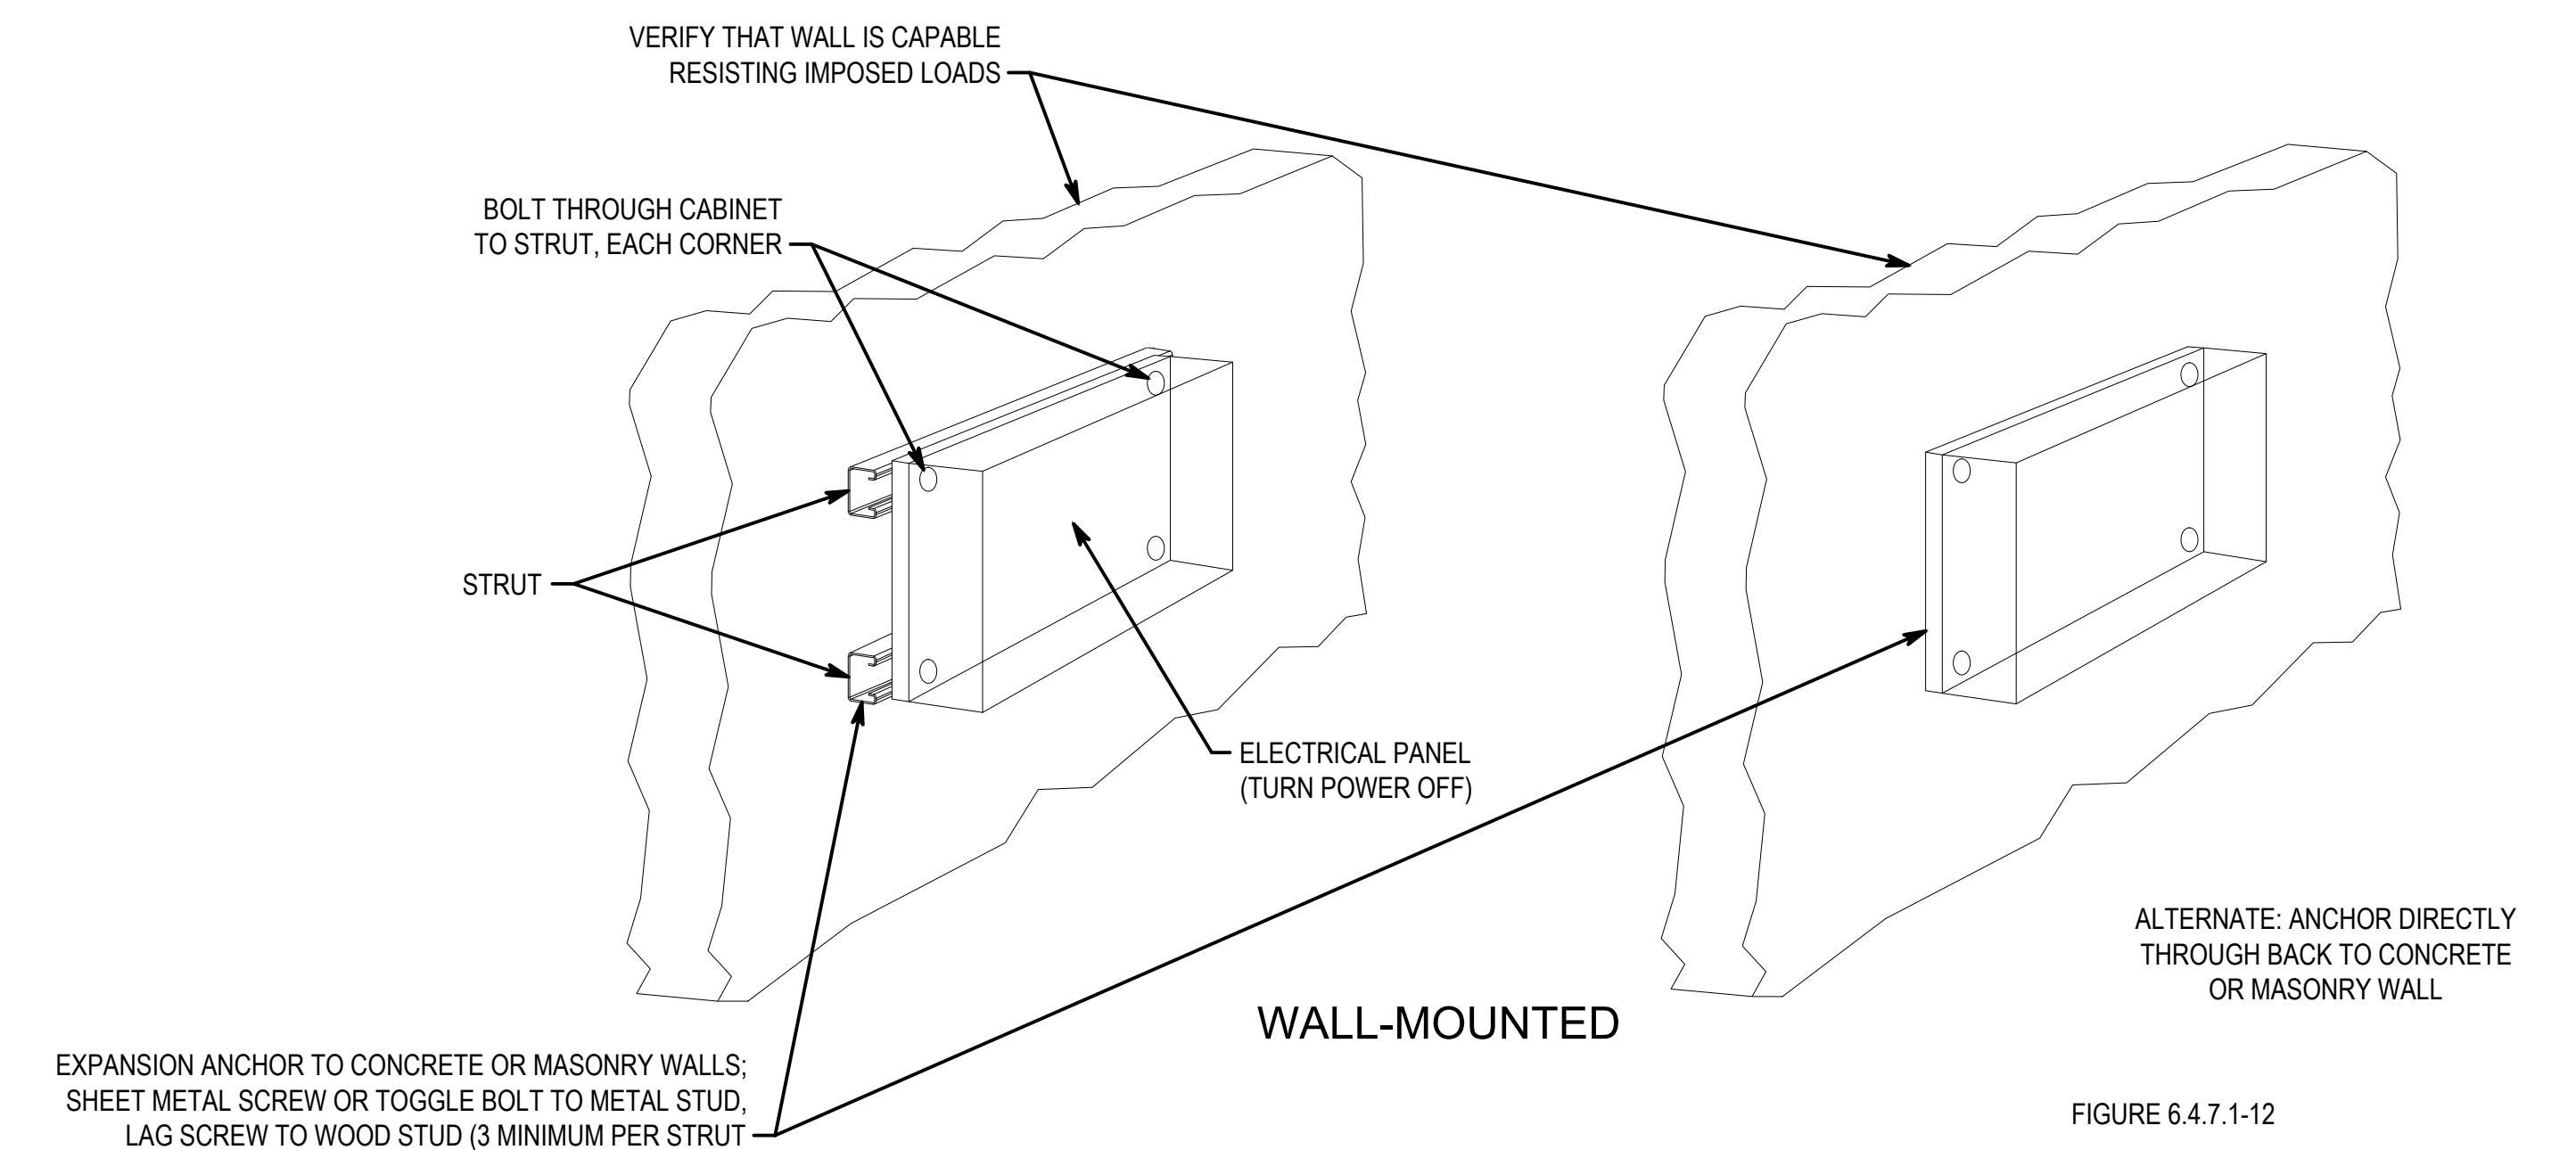

7 WALL-MOUNTED ELECTRICAL CONTROL PANELS, MOTOR CONTROLS CENTERS OR SWITCHGEAR (ER).
SCALE: NO SCALE

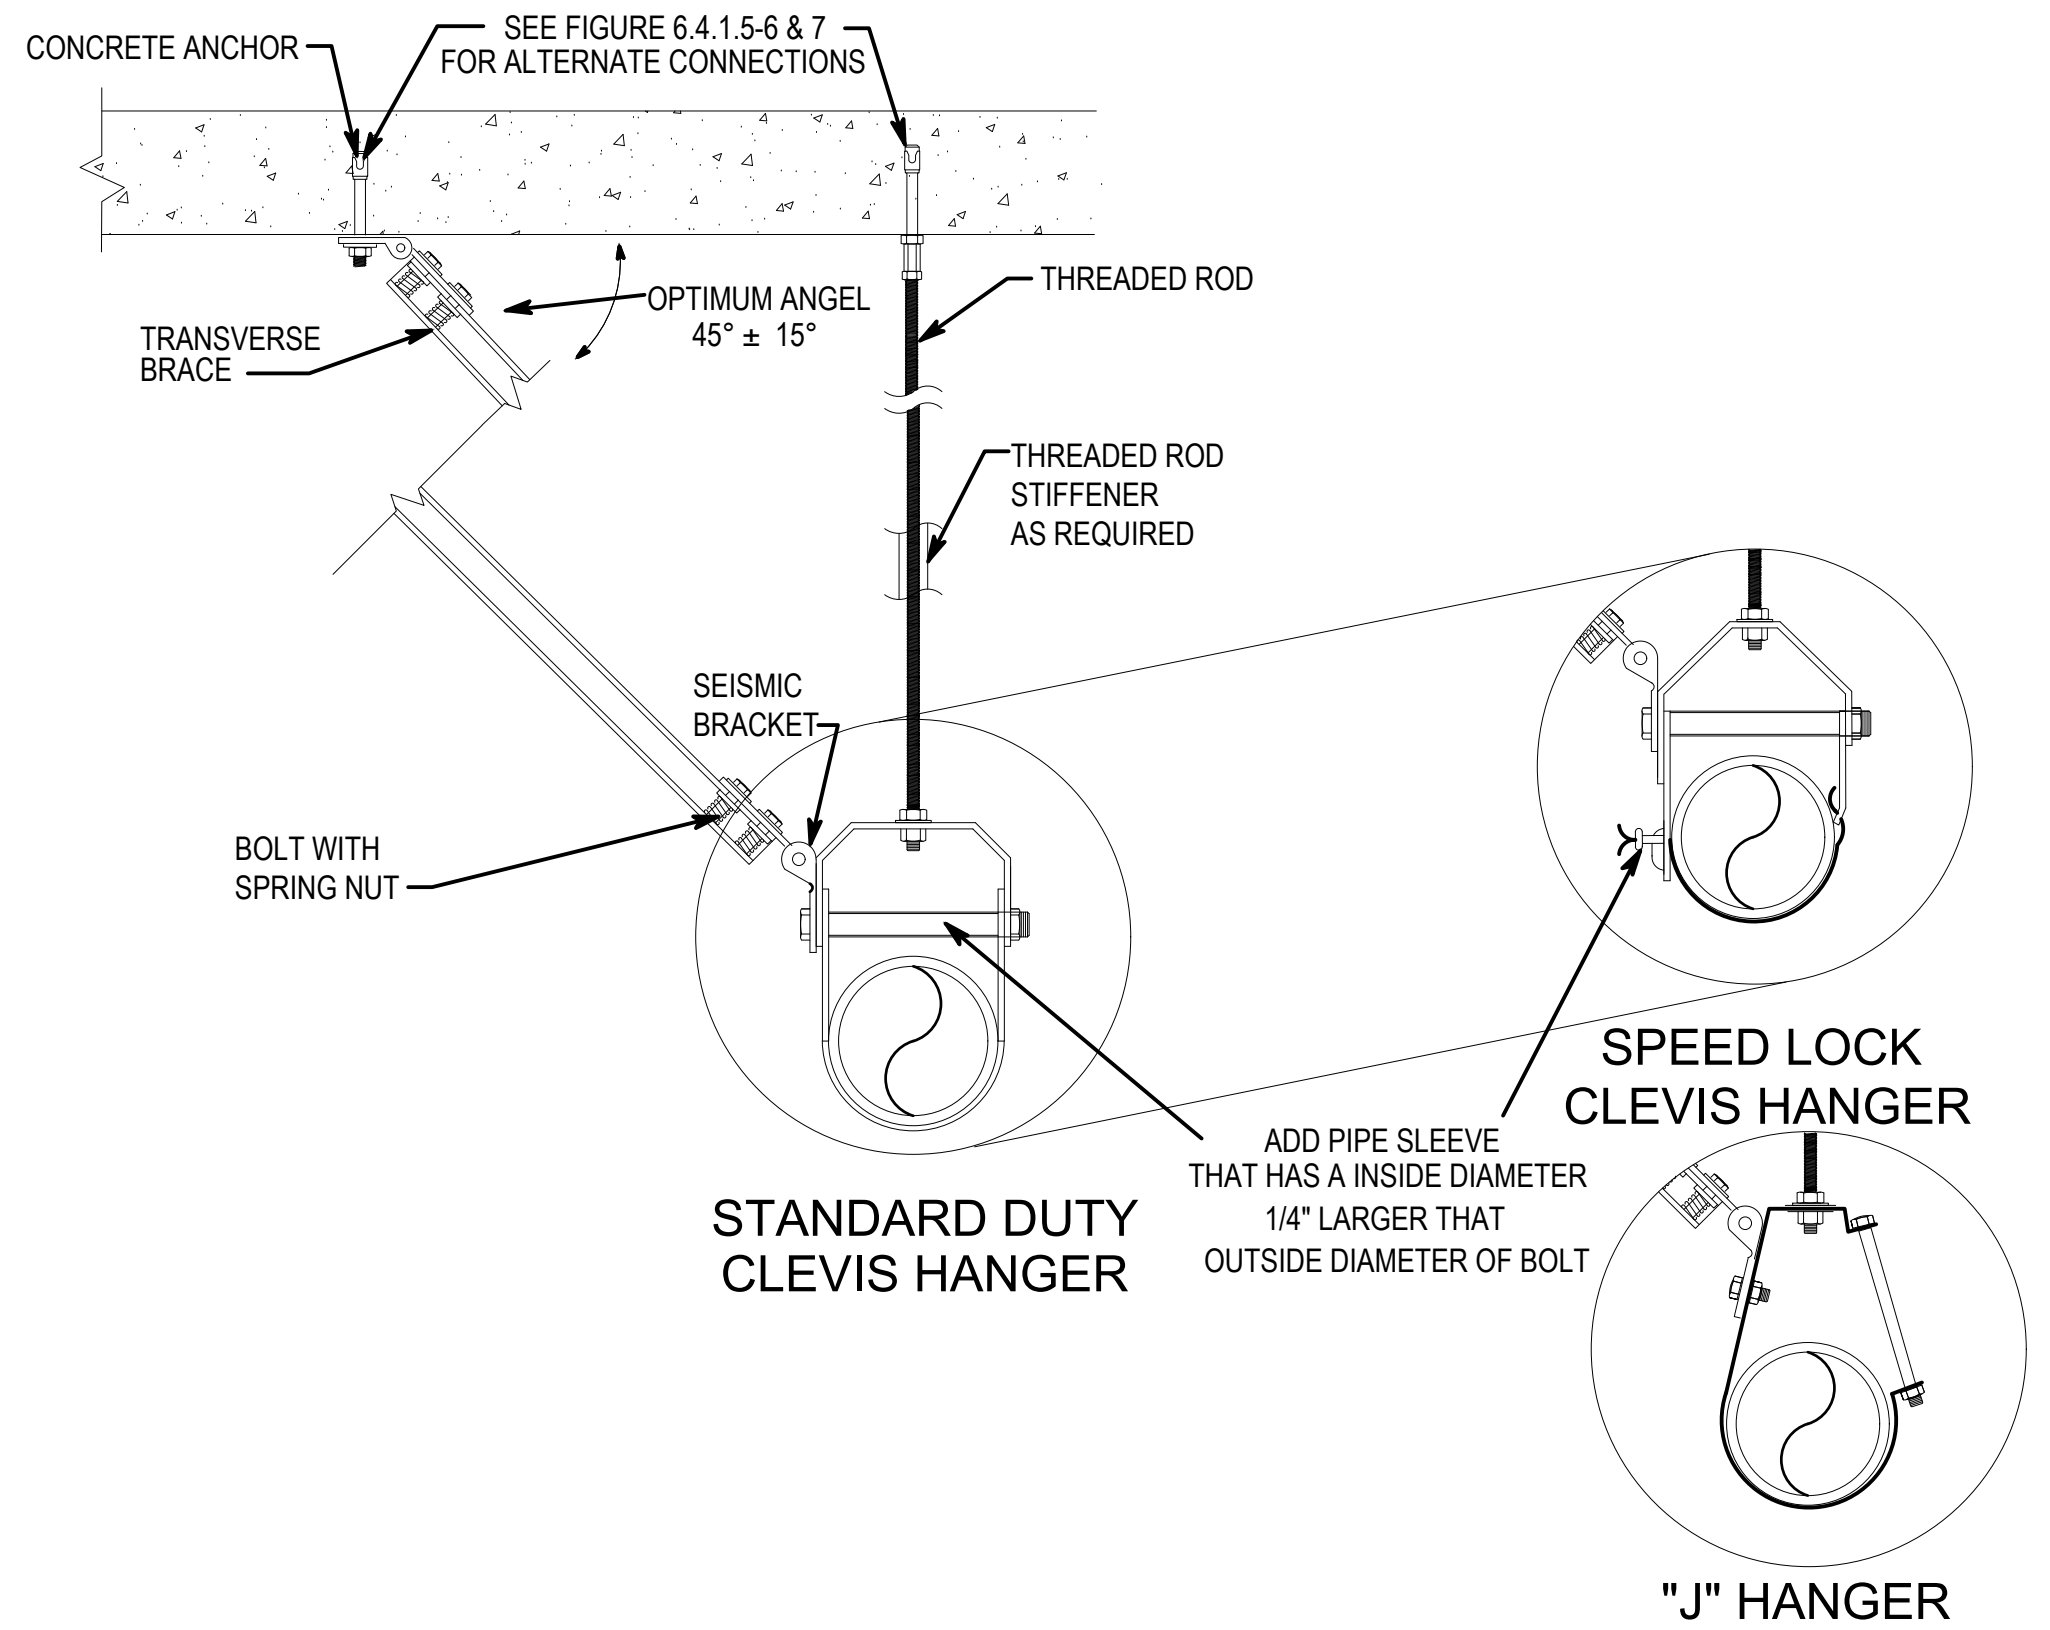

5 RIGID BRACING - SINGLE CONDUIT TRANSVERSE
SCALE: NO SCALE

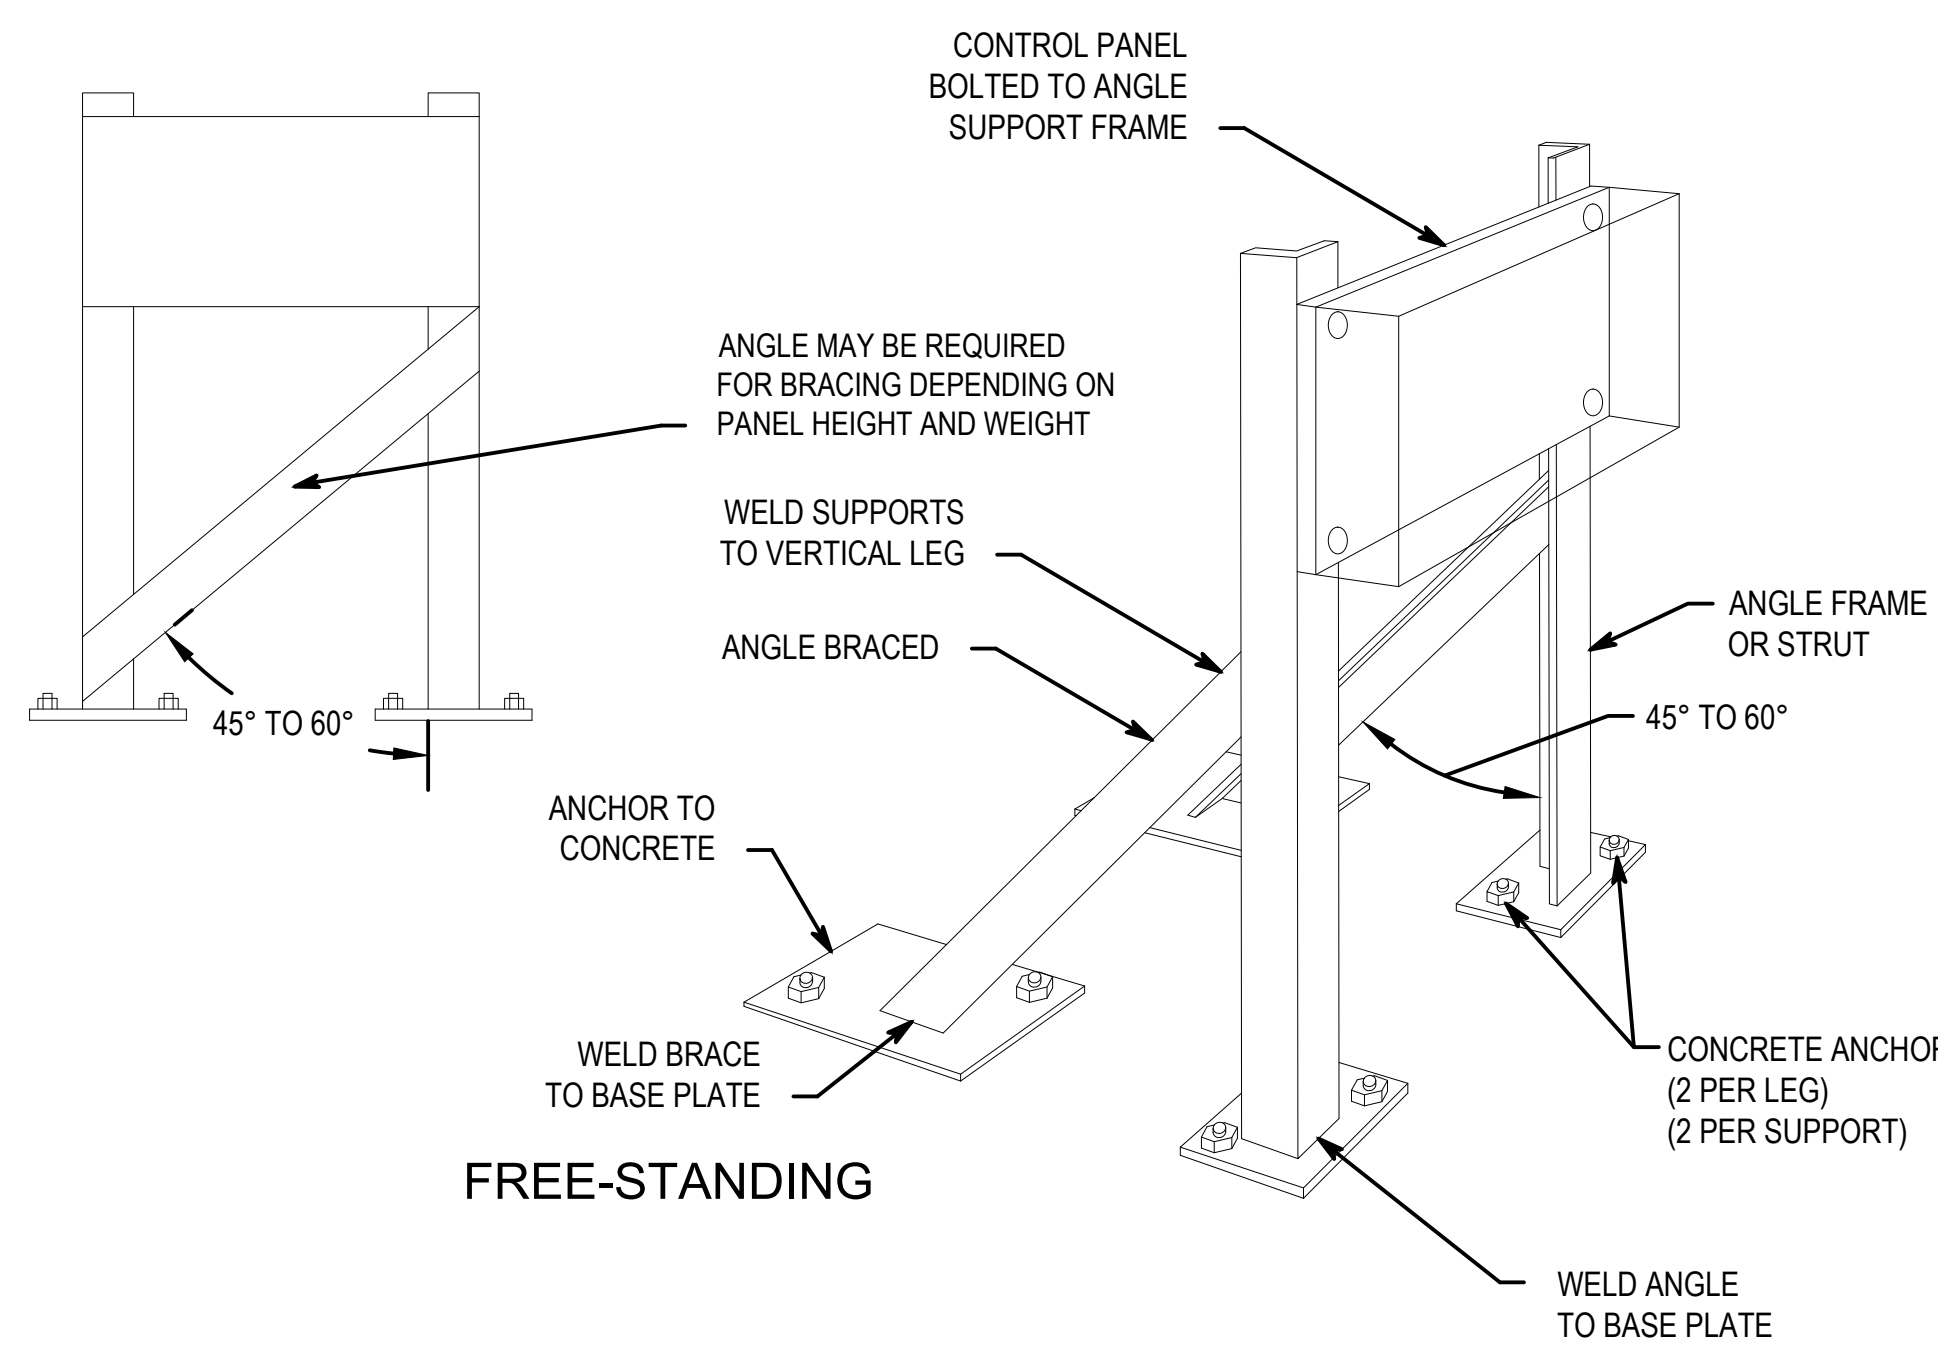

6 FREE STANDING ELECTRICAL CONTROL PANELS, MOTOR CONTROLS CENTERS OR SWITCHGEAR (ER).
SCALE: NO SCALE

File Path

VA FORM 08 - 6231

CONSULTANTS:



ARCHITECT/ENGINEERS:



750 W HAMPDEN AVE
SUITE #300
ENGLEWOOD CO 80110
(720) 550-6307
WWW.VALHALLAENGINEERING.COM

VEG 4.11

STAMP:



U.S. Department
of Veterans Affairs

Drawing Title
ELECTRICAL SEISMIC DETAILS

Approved: Project Director

Phase
100% CONSTRUCTION
DOCUMENTS

Project Title
OUTPATIENT MENTAL HEALTH /
EDUCATION ADDITION

Location
3687 VETERANS DRIVE, FORT HARRISON, MT 59636

Issue Date
08/05/2020

Checked
TL

Drawn
BWW


Project Number
436-114

Building Number
173 & 154


Drawing Number
E-503

A

B

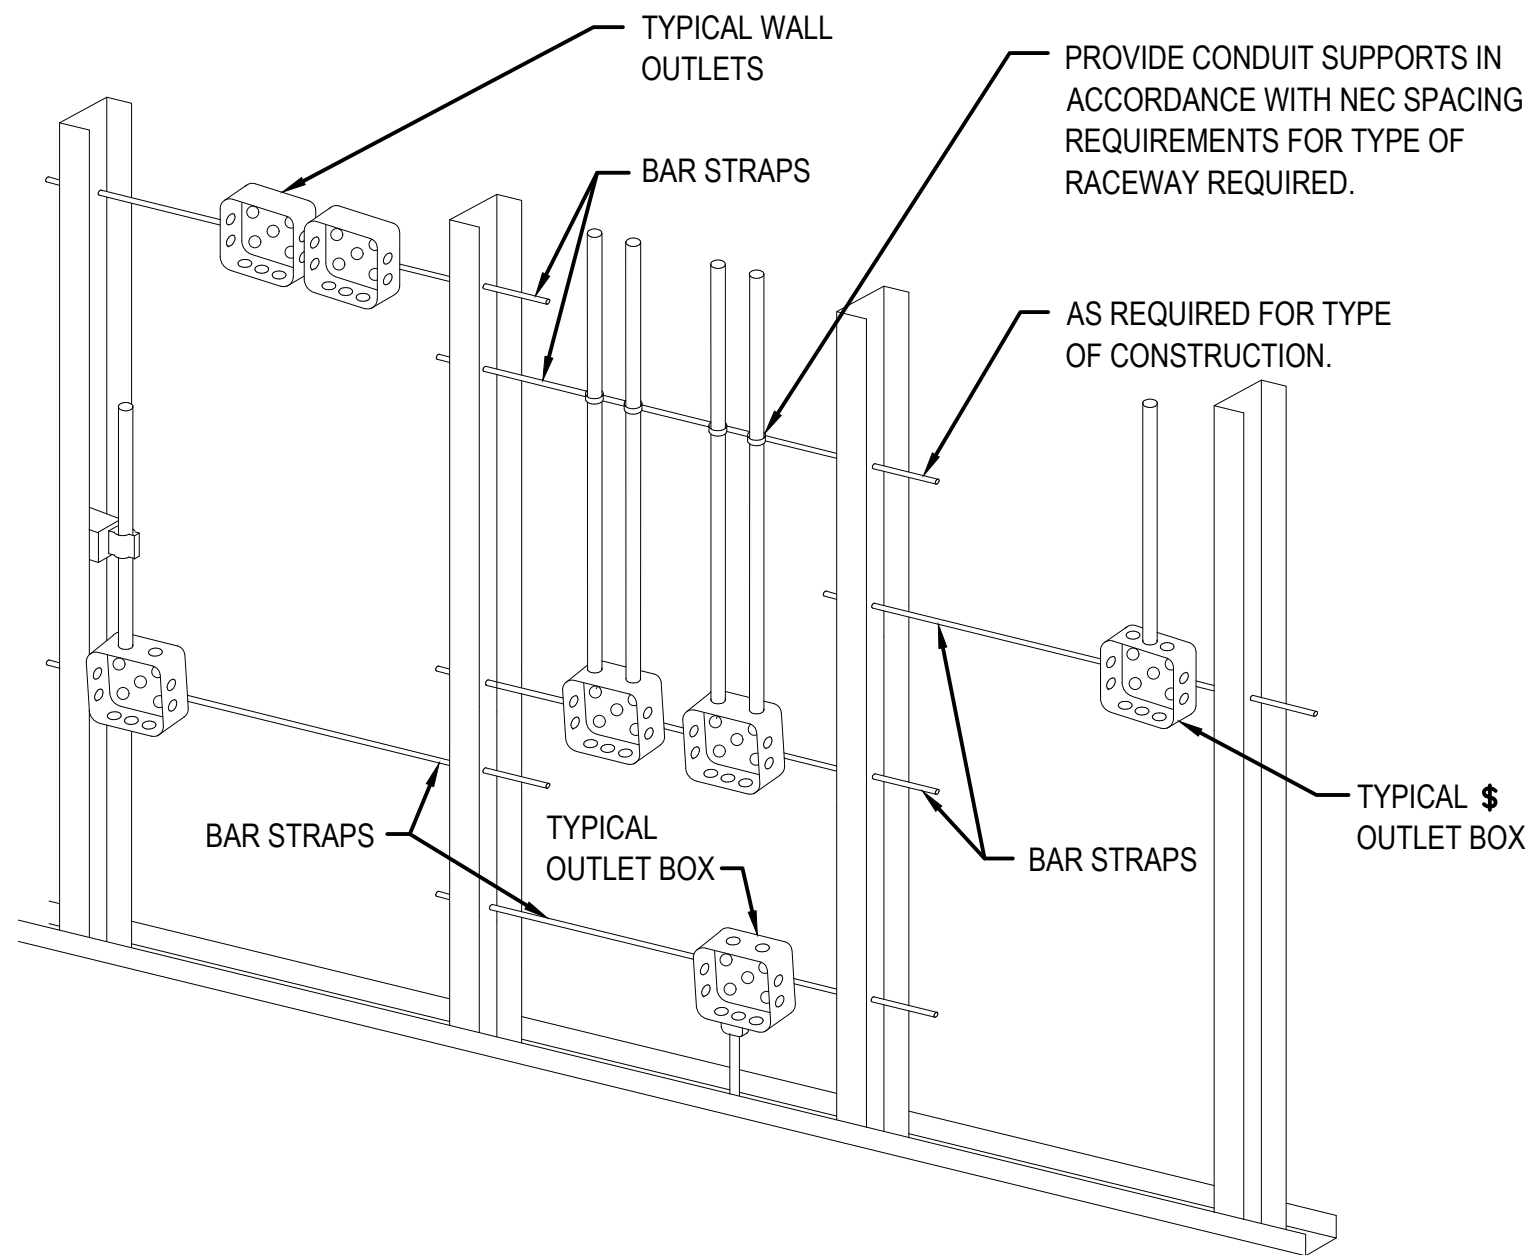

2 TYPICAL ROUGH-IN SUPPORT METHODS DETAIL
SCALE: NO SCALE

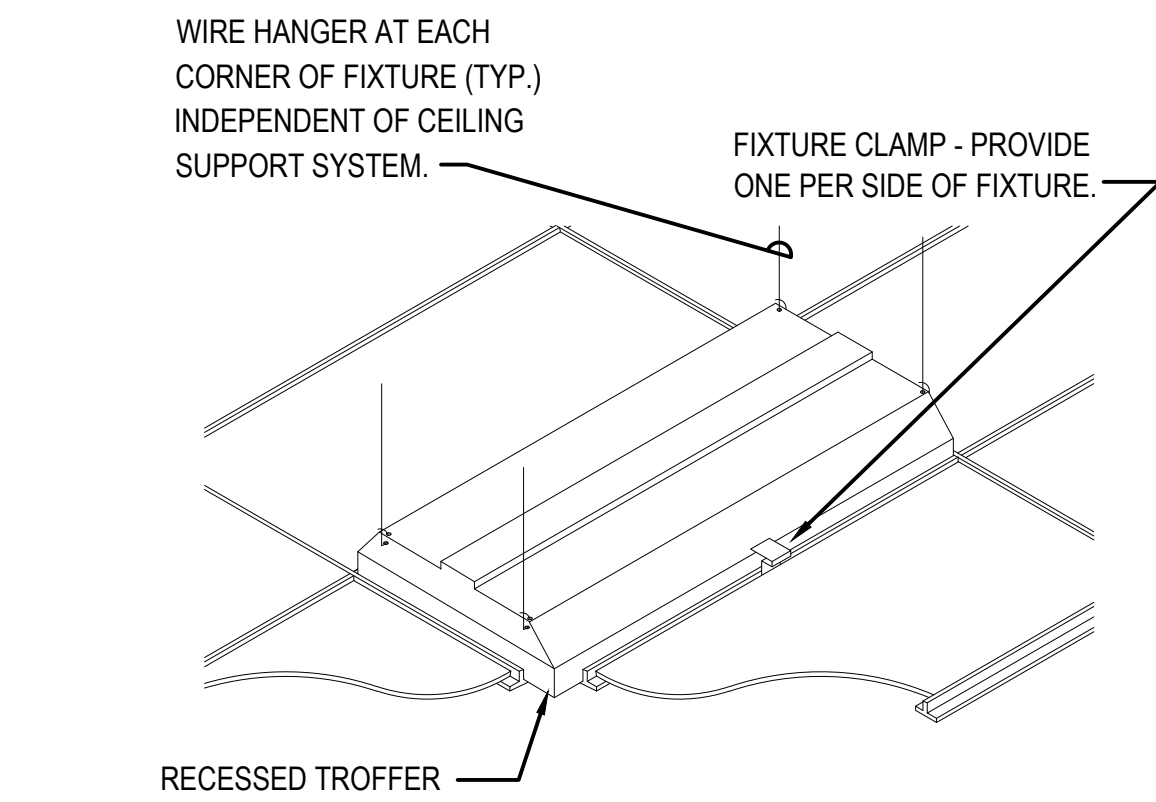


3 RECESSED FIXTURE MOUNTING DETAIL
SCALE: NO SCALE

ELECTRICAL GENERAL NOTES:


- SEE SHEET E-001 FOR SESIMIC RESTRAINT NOTES AND FACILITY-SPECIFIC SEISMIC DESIGN BASIS PARAMETERS.
- FIGURES ARE FROM FEMA E-74 REDUCING THE RISKS OF NONSTRUCTURAL EARTHQUAKE DAMAGE - A PRACTICAL GUIDE, DECEMBER 2012.
- COORDINATE EXACT LOCATION OF CAMERA ON SITE WITH WORK BY OTHER TRADES TO ENSURE DESIRED VIEWING AREA AND SERVICE ACCESS AFTER COMPLETION OF PROJECT AND TO MINIMIZE ANY POSSIBLE DAMAGE TO INSTALLED CAMERA OR ASSOCIATED CABLING.
- CONDUIT SHALL STUB TO NEAREST ACCESSIBLE CEILING AND TERMINATE ORIENTED HORIZONTALLY AT THE HEIGHT OF THE ASSOCIATED CABLE TRAY OR J-HOOK ROUTE. CONDUIT RUN SHALL NOT CONTAIN MORE THAN 180 DEGREES OF BEND BETWEEN ACCESSIBLE JUNCTION BOXES OR BETWEEN JUNCTION BOX AND END OF CONDUIT. WHERE CONDUIT STUBS THROUGH A WALL IN TO A CORRIDOR AND TERMINATES AT AN ASSOCIATED J-HOOK ROUTE, THE CONDUIT SHOULD ONLY EXTEND 2-4 INCHES IN TO THE CORRIDOR. WHERE CONDUIT STUBS TO AN ASSOCIATED CABLE TRAY, CONDUIT SHOULD EXTEND TO CABLE TRAY. ALL CONDUITS MUST BE FITTED WITH A NYLON BUSHING ON EACH END OF THE CONDUIT.
- INSTALLING CONTRACTOR SHALL FURNISH AND INSTALL FIRESTOP MATERIALS FOR CAMERA ROUGH-INS PER PROJECT REQUIREMENTS. REFER TO SPECIFICATIONS FOR FIRESTOP REQUIREMENTS.

C

D

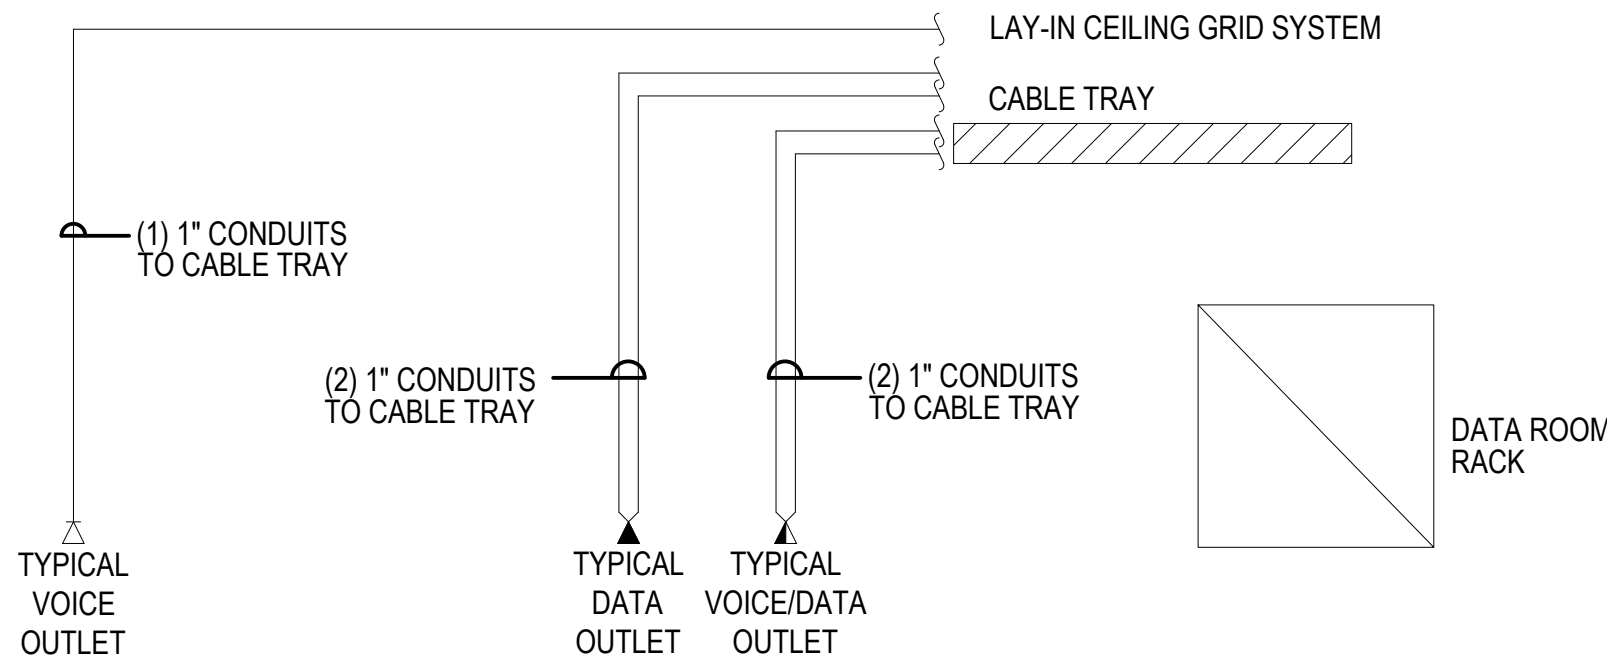

4 DATA ROOM RACK DETAIL
SCALE: NO SCALE

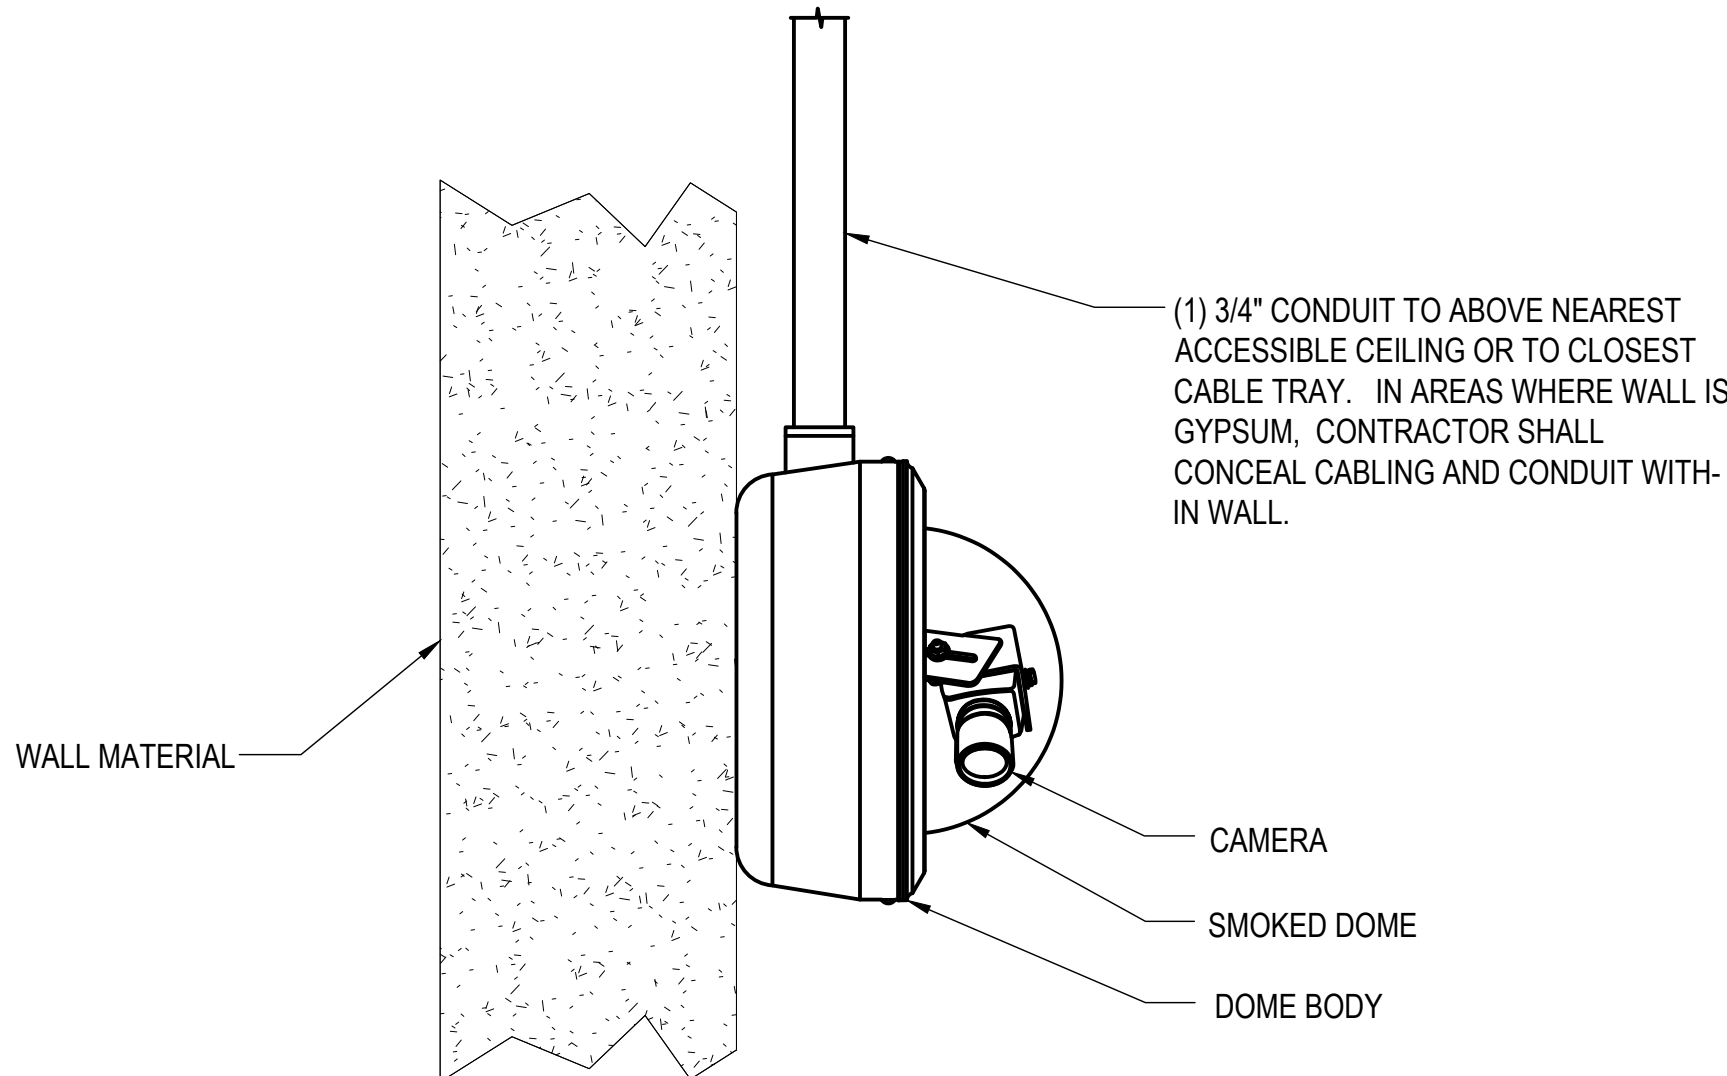

5 INTERIOR FIXED CAMERA WALL MOUNTING DETAIL
SCALE: NO SCALE

E

F

File Path

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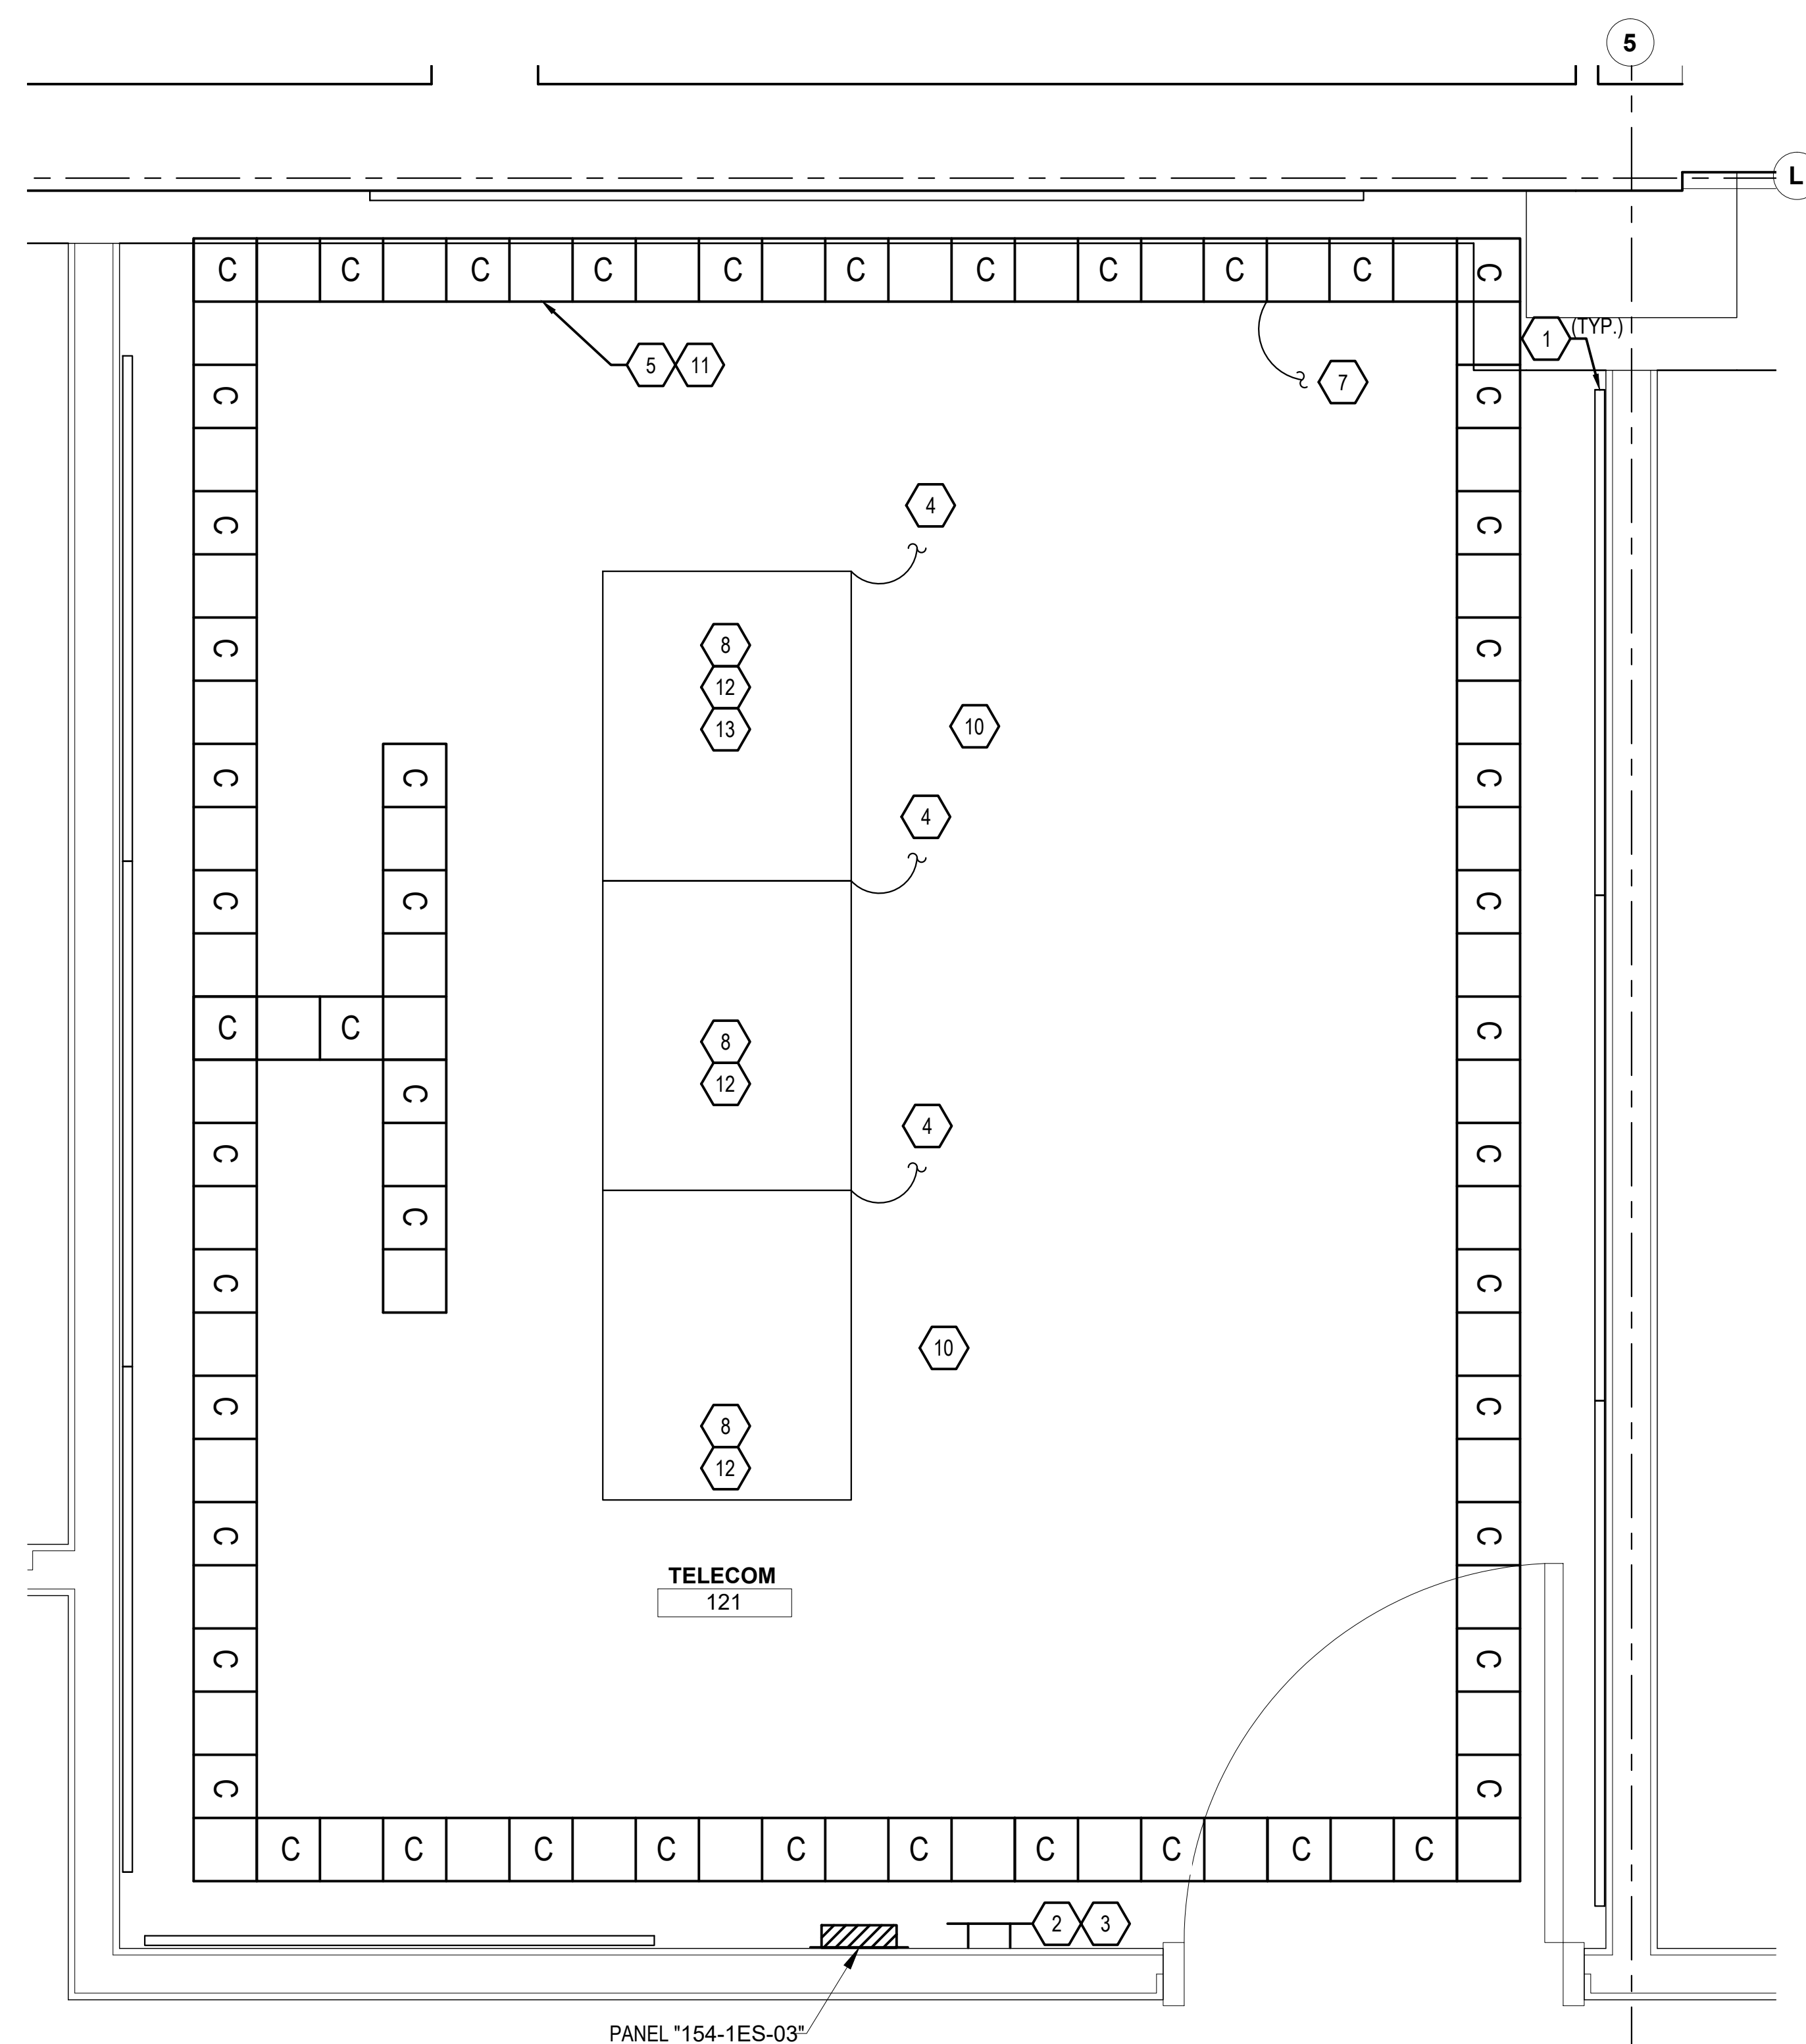
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ELECTRICAL GENERAL NOTES:



- A. FOR SYMBOLS AND GENERAL NOTES SEE SHEET E-001 AND E-002.
- B. ALL COMPONENTS ARE REQUIRED TO BE INSTALLED BY OEM CERTIFIED INSTALLER OF ITEMS PROVIDED FOR TELECOMMUNICATIONS CLOSET.
- C. PROVIDE AND INSTALL SHEETS OF 3/4" FIRE RETARDANT PLYWOOD, PAINTED WITH WHITE FIRE RETARDANT PAINT (FIRE RETARDANT MARKINGS ON PLYWOOD MUST REMAIN VISIBLE) FROM 36" ABOVE FLOOR, UP 4' ALONG THREE WALLS INCLUDING DEMARC (LOCAL EXCHANGE CARRIER POINT OF PRESENCE) WALL OF THE IT CLOSET. SEE SPECIFICATION 07-84-00 "FIRESSTOPPING" FOR ADDITIONAL INFORMATION.

KEY NOTES:

- 1 GENERAL CONTRACTOR SHALL PROVIDE 4X8' FIRE RATED BACKBOARD MOUNTED VERTICALLY WITH TOP AT 72" AFF PER SPECIFICATION 07-84-00 "FIRESTOPPING".
- 2 PROVIDE GROUND BAR PER DETAIL 8 ON SHEET E-501 AND PER SPECIFICATIONS 27-05-26 "GROUNDING AND BONDING FOR COMMUNICATION SYSTEMS."
- 3 PROVIDE #1/0 AWG STRANDED COPPER WIRE FROM GROUND BAR TO BUILDING STEEL WITHIN 6 FEET OF THE GROUND BAR, AND TERMINATE BOTH ENDS.
- 4 PROVIDE #6 AWG STRANDED COPPER WIRE INSTALLED WITH MINIMUM 2" SEPARATION FROM ALL OTHER CABLE TYPES, TO GROUND BAR IN ROOM AND TERMINATE BOTH ENDS.
- 5 REFERENCE TECHNICAL SPECIFICATIONS FOR THE UPS CHARACTERISTICS, SPECIFICATION No. 27-15-00 "COMMUNICATIONS STRUCTURED CABLING" AND 27-11-00 "COMMUNICATIONS EQUIPMENT ROOM FITTINGS".
- 6 NOT USED.
- 7 PROVIDE CONTINUOUS #6 AWG STRANDED COPPER WIRE LOOP AROUND CABLE TRAY AND TERMINATE ON GROUND BAR IN ROOM. BOND CONDUCTOR TO TRAY AS REQUIRED BY SPECIFICATION 27-05-26 "GROUNDING AND BONDING FOR COMMUNICATION SYSTEMS."
- 8 REFERENCE TECHNICAL SPECIFICATIONS FOR THE COMPUTER RACK CHARACTERISTICS, SPECIFICATION No. 27-11-00 "COMMUNICATIONS EQUIPMENT ROOM FITTINGS".
- 9 NOT USED.
- 10 REFERENCE TECHNICAL SPECIFICATIONS FOR THE UPS CHARACTERISTICS, SPECIFICATION No. 27-15-00 "COMMUNICATIONS STRUCTURED CABLING" AND 27-11-00 "COMMUNICATIONS EQUIPMENT ROOM FITTINGS".
- 11 ALL HORIZONTAL WIRE AND CABLE SHALL BE INSTALLED IN A RACEWAY SYSTEM WITHIN THE TELECOMMUNICATION CLOSET. THIS RACEWAY SHALL BE SUPPORTED FROM ABOVE THE RACK AREA WITH ENOUGH VERTICAL SPACE TO ALLOW FOR EASY ACCESS TO BOTH THE RACEWAY AND TOP OF THE RACK SYSTEM AND A GRACEFUL ENTRY FROM THE ABOVE RACEWAYS TO THE EQUIPMENT WITHIN THE RACKS BELOW. WATERFALL DEVICES PROVIDE THE SOFT TRANSITION FROM THE RACEWAY ABOVE THE RACKS TO THE DEVICES BELOW AND SHALL BE INSTALLED IN ADEQUATE NUMBERS TO FACILITATE THE NETWORK HARDWARE BEING DEPLOYED AND ADDITIONAL WATERFALL DEVICES PROVIDED TO IT FOR CURRENT AND FUTURE NEEDS. RACEWAY MUST RUN ACROSS THE TOP OF THE RACK IN FOUR DIRECTIONS, EACH POINT MEETING AT THE CENTER.
- 12 CONTRACTOR MUST INCLUDE IN THE PROCUREMENT THE NECESSARY PATCH CABLING TO SUPPORT EACH NETWORK JAC THAT IS INSTALLED. THESE CABLES SHALL BE GRAY 10' (STATION) AND GRAY 7(CLOSET CABLES) SUPPORTING BOTH THE STATION SIDE AND THE TELECOMMUNICATIONS CLOSET.
- 13 CONTRACTOR MUST PROVIDE AND INSTALL POINT OF DEMARCATION EXTENSION FROM THE LOCAL EXCHANGE CARRIER (LEC) DEMARCATION POINT TO THE MAIN IT TELECOMMUNICATIONS HALL. IF LEC FIBER DATA CIRCUIT HANDOFF IS AVAILABLE AT THE DEMARC, A 6 PAIR SINGLE MODE FIBER TERMINATED WITH LC BULKHEADS WILL BE PROVIDED FOR EXTENDING THE CIRCUIT.



1 BLDG 154 TELECOMM ROOM
SCALE: NO SCALE
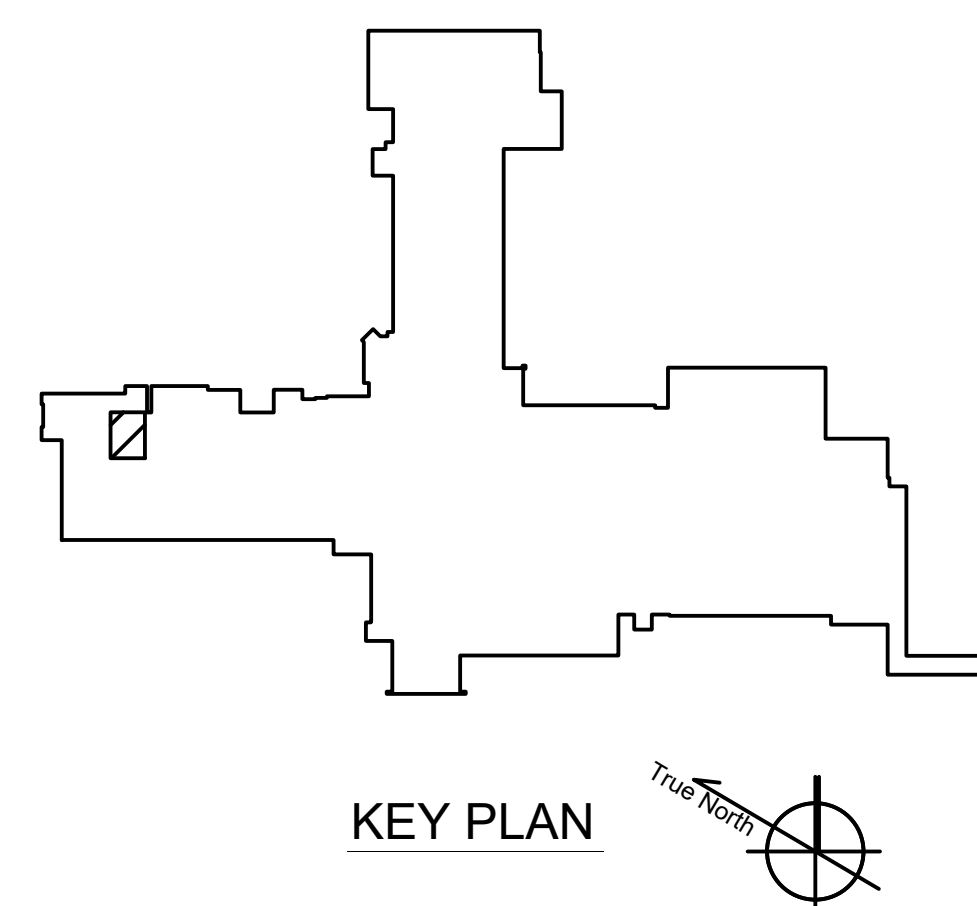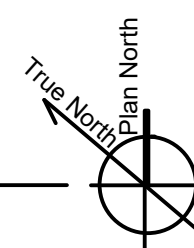
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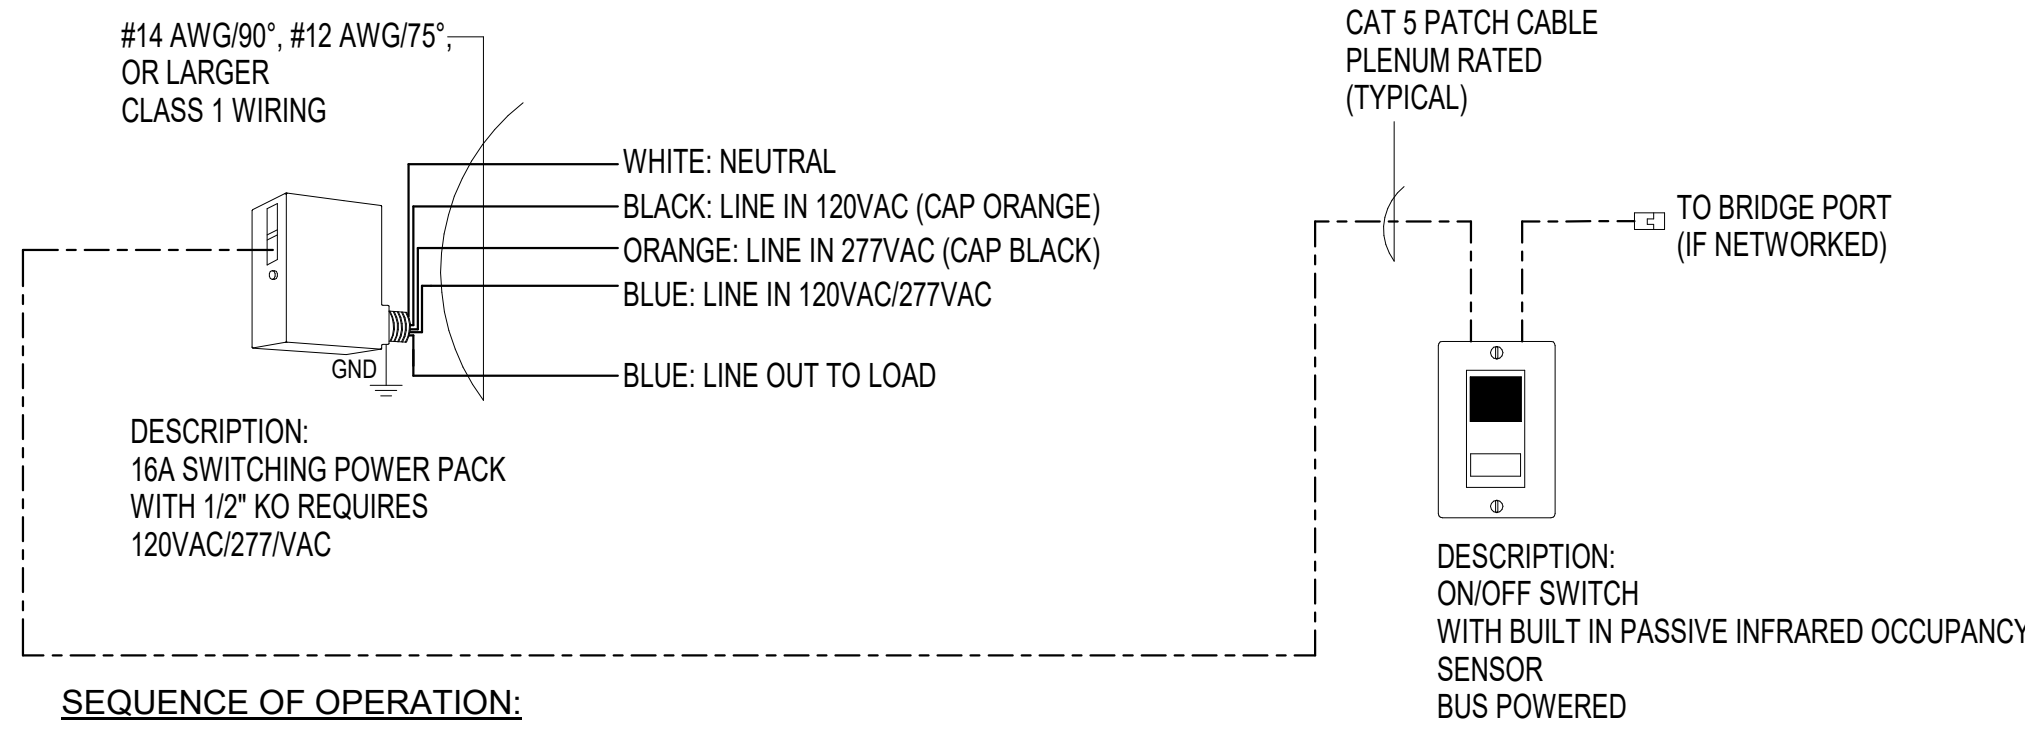
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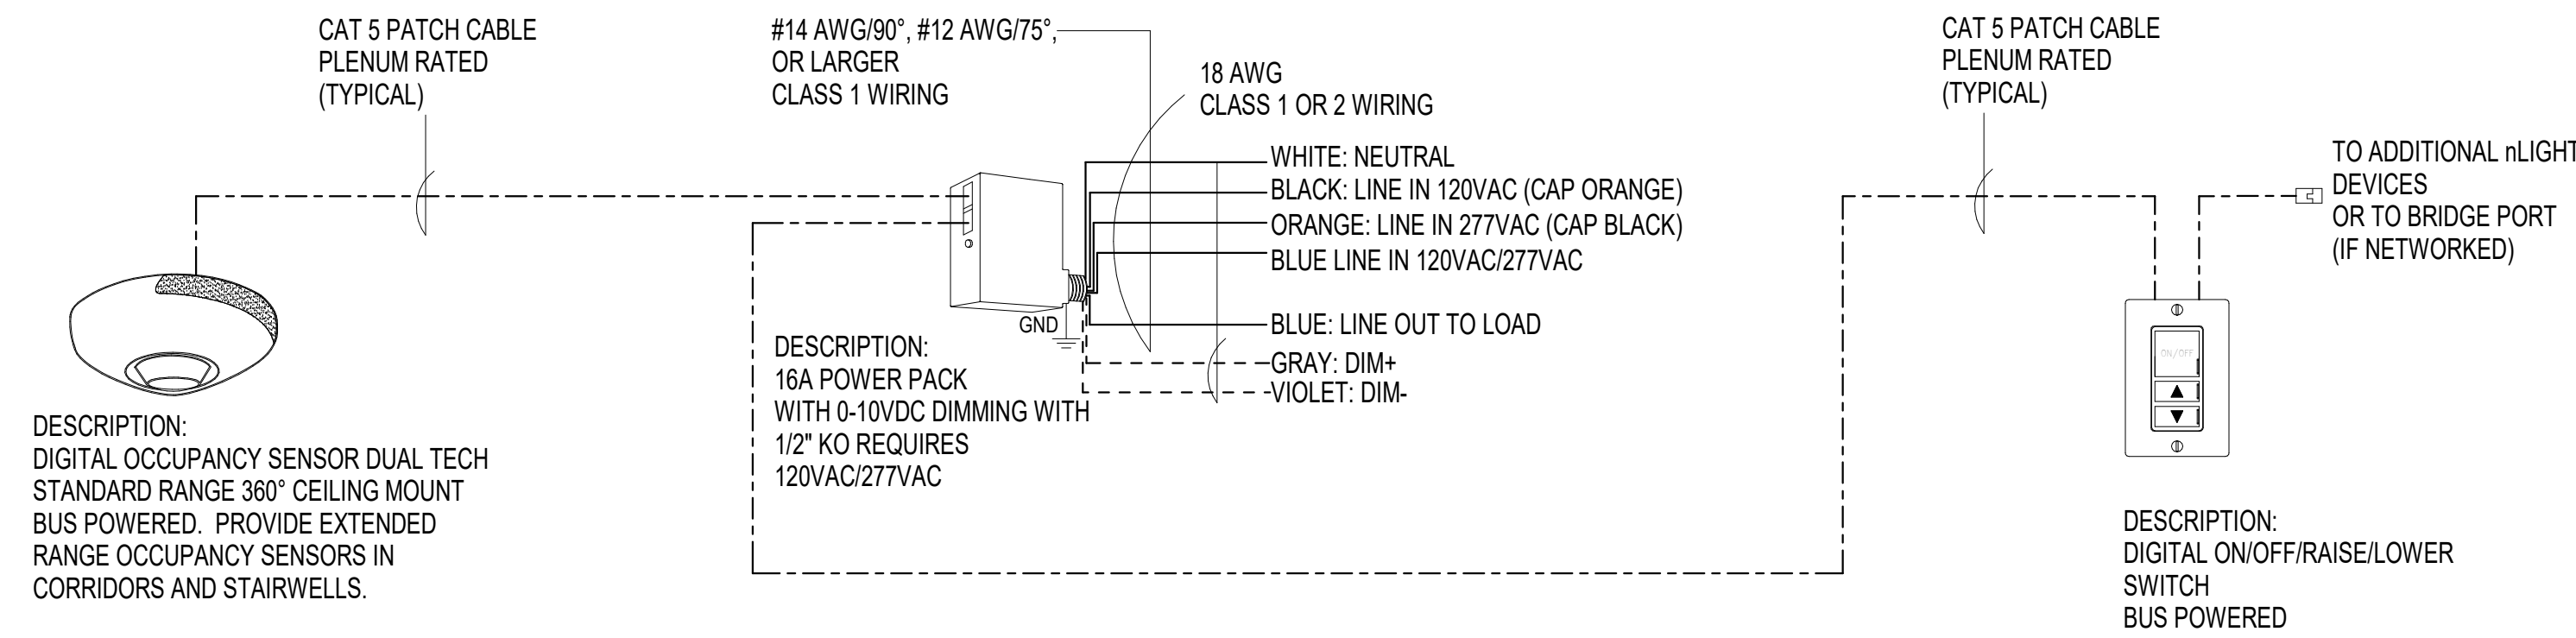
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SEQUENCE OF OPERATION:

1. LIGHTS ARE MANUAL ON.
2. OCCUPANCY SENSOR PROVIDES AUTOMATIC OFF OF LIGHTS BASED ON ROOM OCCUPANCY. USE DEFAULT TIME DELAY FOR OCCUPANCY SENSOR.
3. SWITCH PROVIDES MANUAL OVERRIDE OF THE LIGHTS: ON/OFF.


1 LOW VOLTAGE LIGHT SWITCH WITH INTEGRAL OCCUPANCY SENSOR SWITCH - PH 2
NO SCALE



SEQUENCE OF OPERATION:

1. LIGHTS ARE MANUAL ON.
2. OCCUPANCY SENSOR PROVIDES AUTOMATIC ON/OFF OF LIGHTS BASED ON ROOM OCCUPANCY (USE DEFAULT TIME DELAY FOR OCCUPANCY SENSOR).
3. DIMMER SWITCH PROVIDES MANUAL OVERRIDE OF THE LIGHTS: ON/OFF/RAISE/LOWER.


2 LOW VOLTAGE LIGHTING CONTROL WITH DIMMING - PH 2
NO SCALE

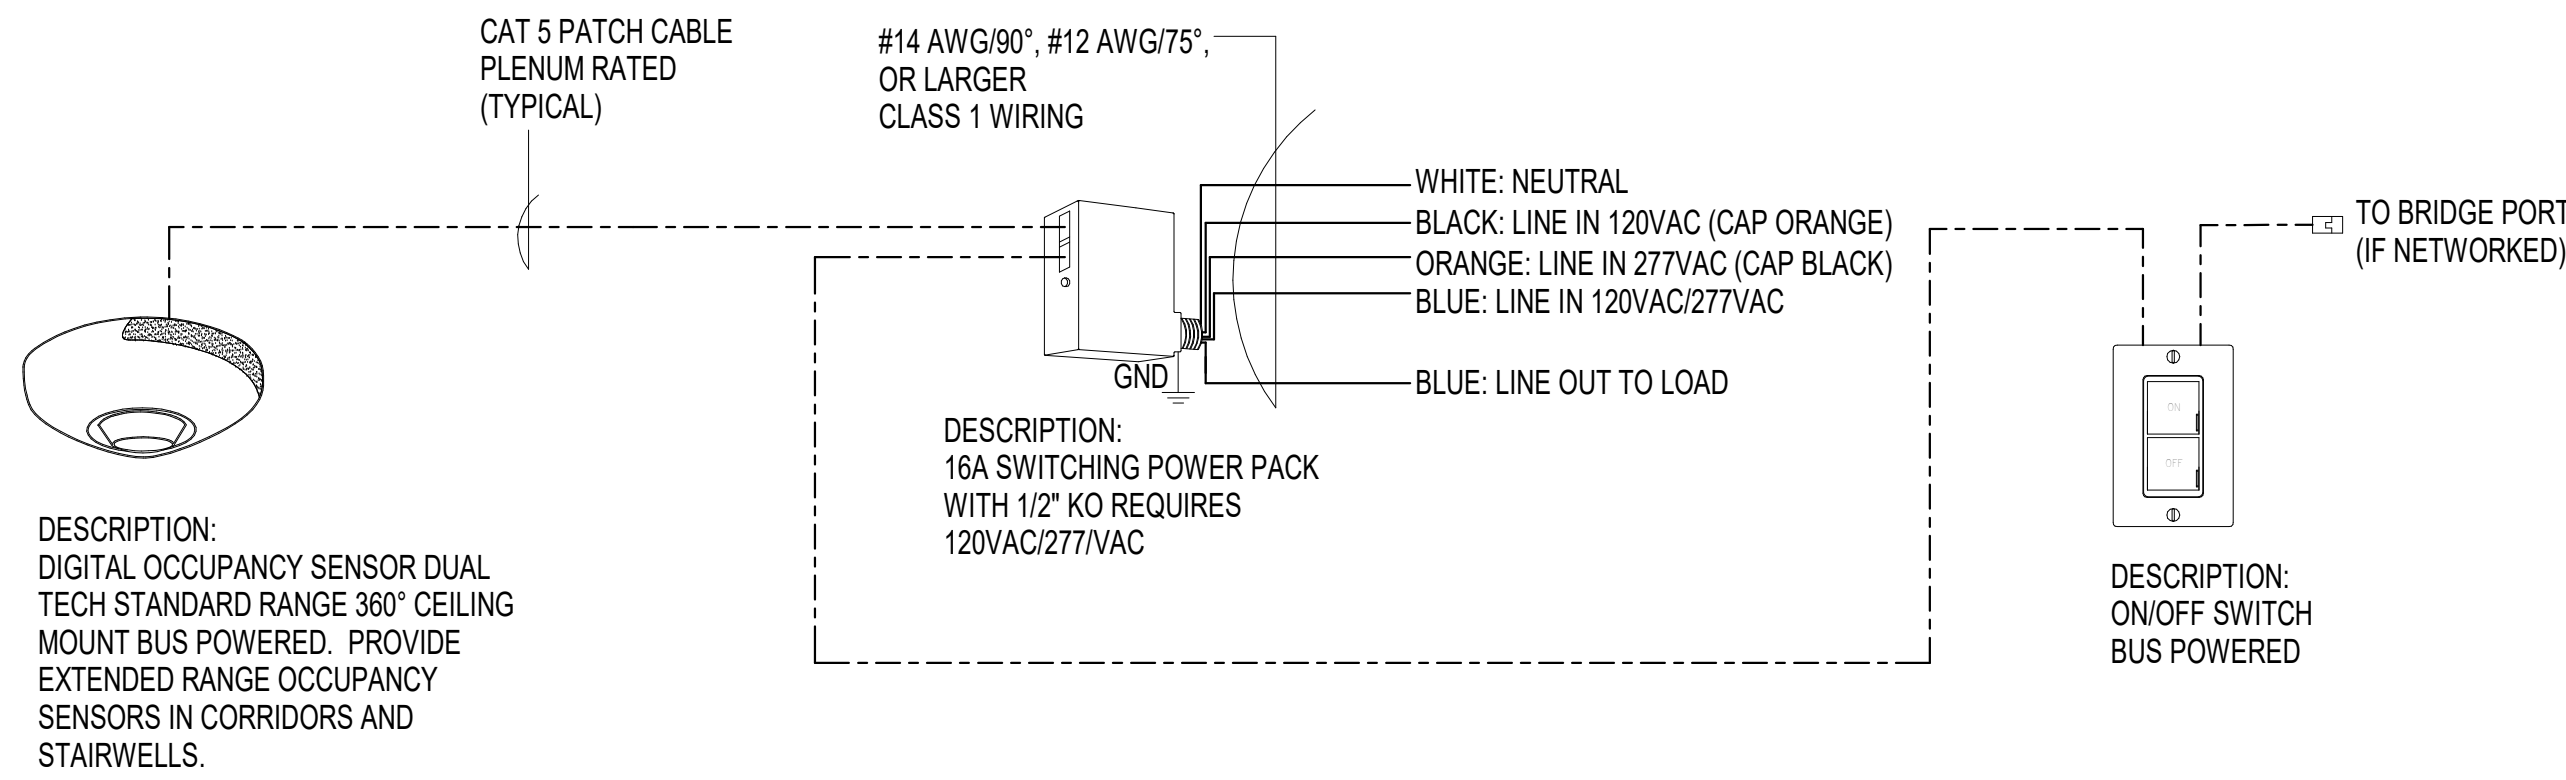

SEQUENCE OF OPERATION:

1. LIGHTS ARE MANUAL ON.
2. OCCUPANCY SENSOR PROVIDES AUTOMATIC OFF OF LIGHTS BASED ON ROOM OCCUPANCY. USE DEFAULT TIME DELAY FOR OCCUPANCY SENSOR.
3. SWITCH PROVIDES MANUAL OVERRIDE OF THE LIGHTS: ON/OFF.


3 LOW VOLTAGE LIGHTING CONTROL WITH SWITCHING- PH 2
NO SCALE

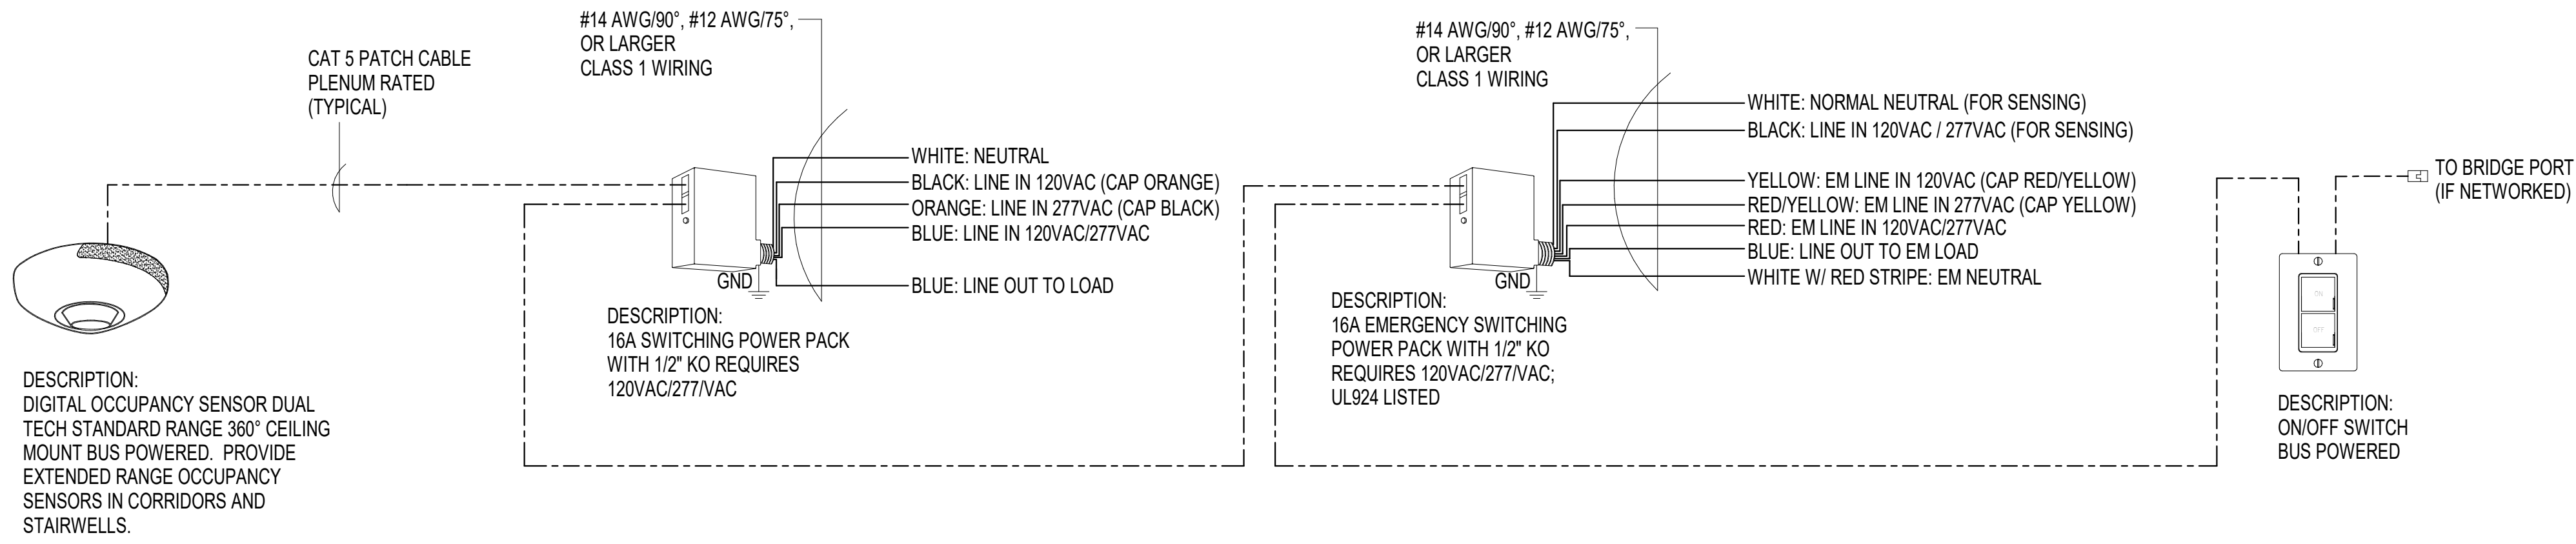

SEQUENCE OF OPERATION:

1. LIGHTS ARE MANUAL ON.
2. OCCUPANCY SENSOR PROVIDES AUTOMATIC OFF OF LIGHTS BASED ON ROOM OCCUPANCY. USE DEFAULT TIME DELAY FOR OCCUPANCY SENSOR.
3. SWITCH PROVIDES MANUAL OVERRIDE OF THE LIGHTS: ON/OFF.

4 LOW VOLTAGE LIGHTING CONTROL WITH SWITCHING W/EMER. TRANSFER DEVICE- PH 2
NO SCALE

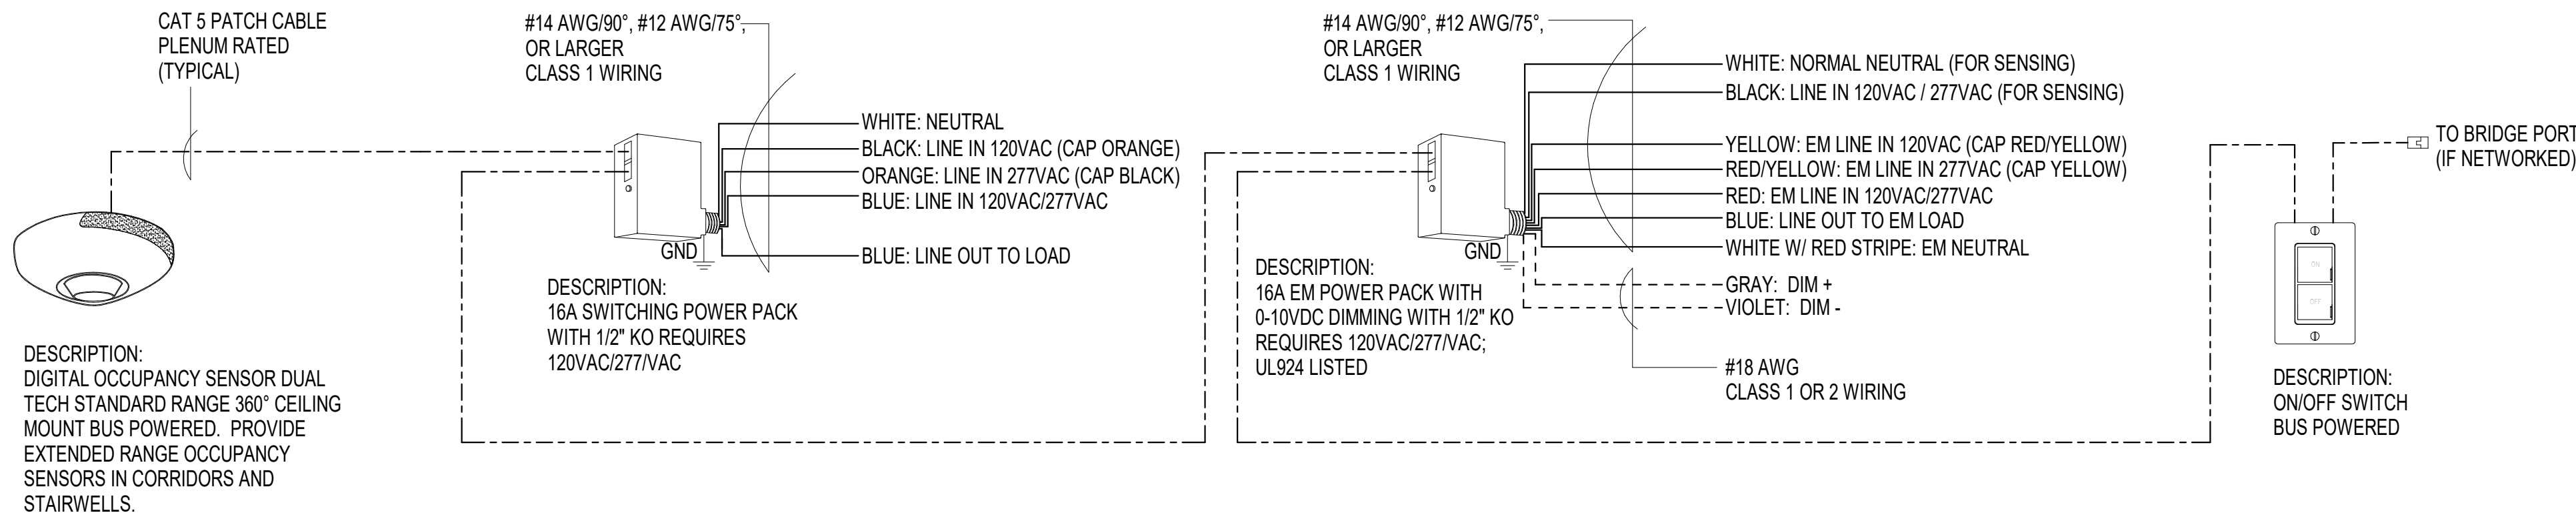

SEQUENCE OF OPERATION:

1. LIGHTS ARE MANUAL ON.
2. OCCUPANCY SENSOR PROVIDES AUTOMATIC OFF OF LIGHTS BASED ON ROOM OCCUPANCY. USE DEFAULT TIME DELAY FOR OCCUPANCY SENSOR.
3. SWITCH PROVIDES MANUAL OVERRIDE OF THE LIGHTS: ON/OFF.

5 LOW VOLTAGE LIGHTING CONTROL WITH 0-10VDC DIMMING W/EMER. TRANSFER DEVICE- PH 2
NO SCALE

CONSULTANTS:



ARCHITECT/ENGINEER OF RECORD:



750 W HAMPDEN AVE
SUITE 300
ENGLEWOOD, CO 80110
(720) 550-6307
WWW.VALHALLAENGINEERING.COM

STAMP:



Drawing Title

**LOW VOLTAGE LIGHTING
CONTROL WIRING DIAGRAMS**

Approved: Project Director

Phase

**100% CONSTRUCTION
DOCUMENTS**

Project Title

**OUTPATIENT MENTAL HEALTH /
EDUCATION ADDITION**

Location

3687 Veterans Drive, Fort Harrison, MT 59636

Issue Date

08/05/2020

Checked

TL

Drawn

JEE

Project Number

436-114

Building Number

154

Drawing Number

E-505-P2

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




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
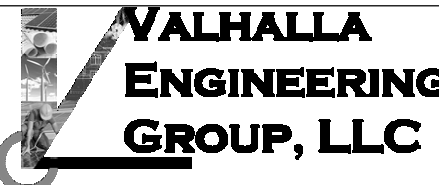




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LIGHTING CONTROL ZONE SCHEDULE				
ROOM NUMBER	ROOM NAME	CHANNEL	LIGHT CONTROL TYPE	REMARKS
100A	CORRIDOR	jg	0-10VDC DIMMED	1
100B	CORRIDOR	jg	0-10VDC DIMMED	1
100C	PREFUNCTION LOBBY	ja	0-10VDC DIMMED	1
100D	CORRIDOR	ja	0-10VDC DIMMED	1
100E	CORRIDOR	ja	0-10VDC DIMMED	1
100F	CORRIDOR	ja	0-10VDC DIMMED	1
101	WAITING	jg	0-10VDC DIMMED	1
102	TOILET - STAFF	gg	SWITCHED	
103	TOILET - MALE	gf	SWITCHED	
103	TOILET - MALE	kb	SWITCHED	3
104	TOILET - STAFF	gf	SWITCHED	
105	TOILET - FEMALE	gh	SWITCHED	
105	TOILET - FEMALE	ka	SWITCHED	3
106	OFFICE LEARNING SUPERVISOR	ge	0-10VDC DIMMED	2
107	INSTRUCTOR CUBICLE	gc	0-10VDC DIMMED	2
107	INSTRUCTOR CUBICLE	gd	0-10VDC DIMMED	2
107	INSTRUCTOR CUBICLE	jk	0-10VDC DIMMED	2, 3
107A	OFFICE CHIEF OF STAFF	ga	0-10VDC DIMMED	2
107B	OFFICE LEARNING OFFICER	gd	0-10VDC DIMMED	2
107C	COPY PRINT	jl	0-10VDC DIMMED	2, 3
108	CONFERENCE	hu	0-10VDC DIMMED	2
109	KITCHEN	hi	SWITCHED	
109	KITCHEN	hi	SWITCHED	
110	CONFERENCE	ht	0-10VDC DIMMED	2
111A	CONFERENCE/CLASSROOM	ht	0-10VDC DIMMED	2
111A	CONFERENCE/CLASSROOM	jm	0-10VDC DIMMED	2, 3
111B	CONFERENCE/CLASSROOM	hk	0-10VDC DIMMED	2
111B	CONFERENCE/CLASSROOM	ht	0-10VDC DIMMED	2, 3
112	HAC	hq	SWITCHED	
113B	ELECTRICAL CLOSET	gl		
115	STORAGE	ha	SWITCHED	
116	CLASSROOM	hd	0-10VDC DIMMED	2
116	CLASSROOM	jc	0-10VDC DIMMED	2, 3
117	CLASSROOM	hc	0-10VDC DIMMED	2
117	CLASSROOM	jd	0-10VDC DIMMED	2, 3
118	CLASSROOM	hb	0-10VDC DIMMED	2
118	CLASSROOM	je	0-10VDC DIMMED	2, 3
119	CLASSROOM	ha	0-10VDC DIMMED	2
119	CLASSROOM	jt	0-10VDC DIMMED	2, 3
120	STORAGE	hr	SWITCHED	
121	TELECOM	hs	SWITCHED	
122	COMPUTER LAB	hm	0-10VDC DIMMED	2
122	COMPUTER LAB	jj	0-10VDC DIMMED	2, 3
123A	SIMULATION LAB	hm	0-10VDC DIMMED	2
123A	SIMULATION LAB	jh	0-10VDC DIMMED	2, 3
123B	CONTROL	ho	0-10VDC DIMMED	2
123C	SIM STORAGE	hv	SWITCHED	
124	LIBRARY	hq	0-10VDC DIMMED	2
125	TOILET	ht	SWITCHED	
126	OFFICE	gk	0-10VDC DIMMED	2
A106G	CORRIDOR	ja	0-10VDC DIMMED	1
GENERAL SCHEDULE NOTES: A. PROVIDE A DIGITALLY CONTROLLED POWER/RELAY PACK MATCHING THE VOLTAGE AND CONTROL TYPE SCHEDULE FOR EACH CHANNEL. B. ALL DIGITAL LOW VOLTAGE DEVICES SHALL BE CONNECTED TO LOW VOLTAGE LIGHTING CONTROL NETWORK.				
SCHEDULE NOTES: 1. LIGHTING CHANNEL INTENSITY TO BE CONTROLLED AT NETWORK LEVEL. 2. LIGHTING CHANNEL INTENSITY TO BE CONTROLLED USING LOCAL DEVICE. 3. PROVIDE AUTOMATIC EMERGENCY POWER TRANSFER DEVICE FOR THIS CHANNEL.				

LIGHTING FIXTURE SCHEDULE										
TYPE	DESCRIPTION	LENS-LOUVER	MOUNTING	LAMP	BALLAST / DRIVER	VOLT	WATT	MFR	CATALOG SERIES	NOTE
A11	EDGE/IT FLAT PANEL 1X4 RECESSED LED LUMINAIRE SEAMLESS ALUMINUM FRAME WITH WHITE FINISH	FLUSH SATIN ACRYLIC DIFFUSER	LAY-IN GRID	3000 LUMEN / 4 FT @ 3500K LED	ELDO LED 0-10VDC 1-100% CD	120 V	26 W	LITHONIA	EPANL 1X4 3000LM 80CRI 35K MINI EZT MVOLT	
A12	EDGE/IT FLAT PANEL 1X4 RECESSED LED LUMINAIRE SEAMLESS ALUMINUM FRAME WITH WHITE FINISH	FLUSH SATIN ACRYLIC DIFFUSER	LAY-IN GRID	3000 LUMEN / 4 FT @ 3500K LED	ELDO LED 0-10VDC 1-100% CD	120 V	38 W	LITHONIA	EPANL 1X4 4000LM 80CRI 35K MINI EZT MVOLT E10WCP	
A12E	EDGE/IT FLAT PANEL 1X4 RECESSED LED LUMINAIRE SEAMLESS ALUMINUM FRAME WITH WHITE FINISH	FLUSH SATIN ACRYLIC DIFFUSER	LAY-IN GRID	3000 LUMEN / 4 FT @ 3500K LED	ELDO LED 0-10VDC 1-100% CD & 10W SELF DIAGNOSTIC BATTERY PACK	120 V	38 W	LITHONIA	EPANL 1X4 4000LM 80CRI 35K MINI EZT MVOLT E10WCP	
A21	EDGE/IT FLAT PANEL 2X4 RECESSED LED LUMINAIRE SEAMLESS ALUMINUM FRAME WITH WHITE FINISH	FLUSH SATIN ACRYLIC DIFFUSER	LAY-IN GRID	6000 LUMEN @ 3500K LED	ELDO LED 0-10VDC 1-100% CD	120 V	53 W	LITHONIA	EPANL 2X4 6000LM 80CRI 35K MINI EZT MVOLT	
A22	EDGE/IT FLAT PANEL 2X4 RECESSED LED LUMINAIRE SEAMLESS ALUMINUM FRAME WITH WHITE FINISH	FLUSH SATIN ACRYLIC DIFFUSER	LAY-IN GRID	4800 LUMEN @ 3500K LED	ELDO LED 0-10VDC 1-100% CD	120 V	47 W	LITHONIA	EPANL 2X4 4800LM 80CRI 35K MINI EZT MVOLT	
A31	EDGE/IT FLAT PANEL 2X2 RECESSED LED LUMINAIRE SEAMLESS ALUMINUM FRAME WITH WHITE FINISH	FLUSH SATIN ACRYLIC DIFFUSER	RECESSED FLANGED	2000 LUMEN	END	120 V	16 W	LITHONIA	EPANL 2X2 2000LM 80CRI 35K	
BW	4 INCH DIAMETER OPEN WALL WASH DOWNLIGHT, SELF FLANGED TRIM, REFLECTOR TO HAVE CLEAR DIFFUSED FINISH.	NONE	RECESSED	LED 1000 LUMEN @ 3500K	ELDO LED 0-10VDC 1-100% CD	120 V	13 W	GOTHAM	EVO WW 3510 44R LD MVOLT G2i	
C2	2 FOOT LINEAR LUMINAIRE, 3 1/2" WIDE X 3 1/2" TALL, EXTRUDED ALUMINUM HOUSING WITH SATIN ANODIZED FINISH AND NO VISIBLE FASTENERS. FROSTED ACRYLIC WRAP LENS.	FROSTED ACRYLIC	SURFACE WALL	5760 LUMEN / 4 FT @ 3500K LED	0-10VDC 10-100% CD	120 V	16 W	LUMUM	NB3 SMT LED M 35K 2 U 10D SC MF F	
E1	CONTEMPORARY LED DOUBLE FACED EXIT SIGN WITH WHITE POWDER PAINT ALUMINUM HOUSING, WHITE STENCIL FACE, RED LETTERS, AND CHEVRON ARROWS AS SHOWN ON PLANS.	—	UNIVERSAL	LED 50000 HR	—	120 V	5 W	LITHONIA	LES W 1 R 120277	
E2	CONTEMPORARY LED DOUBLE FACED EXIT SIGN WITH WHITE POWDER PAINT ALUMINUM HOUSING, WHITE STENCIL FACE, RED LETTERS, AND CHEVRON ARROWS AS SHOWN ON PLANS.	—	UNIVERSAL	LED 50000 HR	—	120 V	5 W	LITHONIA	LES W 2 R 120277	
F1	4 FOOT LINEAR LED INDUSTRIAL STRIP LUMINAIRE	FROSTED ACRYLIC	CHAIN SUSPEND	4,390 LUMENS @ 4000K	END	120 V	41 W	LITHONIA	ZL1N L48 5000LM FST MVOLT 40K 80CRI	1
K4	4 FOOT SOLID FRONT TASK LIGHT, STEEL HOUSING WITH WHITE PAINTED FINISH, PRISMATIC ACRYLIC LENS.	.125 ACRYLIC PRISMATIC	UNDERCABINET	760 LUMEN / FT 3500K	END	120 V	30 W	FAILSAFE	4LD4 35 A12125 EDC1 UW	
DRIVER TYPES: END ELECTRONIC NON-DIM 0-10VDC CONTINUOUS DIMMING										
GENERAL NOTES: A. COMPLY WITH APPROPRIATE SECTIONS 260923, 265100 OF THE SPECIFICATIONS. B. REFER TO SPECIFICATIONS FOR IMPORTANT TECHNICAL REQUIREMENTS FOR LIGHTING FIXTURES, DRIVERS AND LIGHT SOURCES. C. THE CATALOG NUMBERS LISTED BELOW HAVE BEEN CAREFULLY PREPARED TO ASSIST BIDDERS IN SELECTING PRODUCTS TO ACHIEVE THE DESIGN CONCEPT. HOWEVER, PRIOR TO BIDDING, EACH MANUFACTURER SHALL COMPARE THE CATALOG NUMBERS SHOWN WITH THE DESCRIPTION AND REQUIREMENTS ON THE DRAWINGS, AND SHALL NOTIFY THE COR OF ANY DISCREPANCIES. D. SPECIFICALLY INCLUDED IN THE EVALUATION SHALL BE THE VERIFYING OF PROPER MOUNTING KITS OR ACCESSORIES TO FACILITATE INSTALLATION AS SHOWN AT EACH LOCATION ON THE DRAWINGS. E. NO ALLOWANCE OR REDRESS WILL BE ALLOWED FOR DISCREPANCIES THAT WERE NOT REPORTED TO THE COR IN TIME FOR CORRECTION OR CLARIFICATION BEFORE THE BID DATE. FAILURE TO COMPLY WITH THIS REQUIREMENT MAY DISQUALIFY THE PRODUCTS AND EMPOWER THE ENGINEER TO DETERMINE FAIR VALUE FOR FIXTURE AND INSTALLATION CHANGES WITHOUT FURTHER INPUT FROM THE CONTRACTOR OR INSTALLER. F. PROVIDE UNIT PRICES AND FIXTURE BRAND SELECTED FOR ADD/DELETE CHANGES FOR EACH FIXTURE TYPE SHOWN WITHIN 48 BUSINESS HOURS OF THE BID DATE. FAILURE TO COMPLY WITH THIS REQUIREMENT MAY DISQUALIFY THE PRODUCTS AND EMPOWER THE ENGINEER TO DETERMINE FAIR VALUE FOR FIXTURE AND INSTALLATION CHANGES WITHOUT FURTHER INPUT FROM THE CONTRACTOR OR INSTALLER. G. SUBMITTAL PACKAGE SHALL INCLUDE CATALOG NUMBER ON EACH FIXTURE SHEET. H. ALL FIXTURES SHALL BE APPROVED BY UL OR ANOTHER ACCEPTABLE TESTING LAB FOR THE PURPOSE INTENDED AND WITH THE DRIVER AND LED PACKAGE PROPOSED. I. UNIVERSAL VOLTAGE (120/277) DRIVERS REQUIRED UNLESS NOTED OTHERWISE.										
SCHEDULE NOTES: 1. CAP OFF LOW VOLTAGE CONTROL WIRING TO ALLOW SWITCHING CONTROL.										

INVERTER SCHEDULE								
INV. NO.	MANUFACTURER	CATALOG NO.	DESCRIPTION	CAPACITY	MOUNTING	VOLTAGE INPUT	VOLTAGE OUTPUT	QTY. OF OUTPUT BREAKERS
INV C	MEYERS POWER PRODUCTS	LV-4R-2-B2001	SINGLE-PHASE EMERGENCY LIGHTING SYSTEM PURE SINE WAVE OUTPUT, COMPATIBLE WITH LED LIGHT SOURCE, UL924 TESTED, FIELD SELECTED 120/277V INPUT/OUTPUT, RED HOUSING FINISH COLOR, SYSTEM STATUS INDICATORS AND MOMENTARY TEST SWITCH, YL924 SELF TESTING AND DIAGNOSTIC, INPUT FUSE AND BATTERY FUSE PROTECTION.	750 VA	WALL	120V	120V	1

LIGHTING CONTROL DEVICE SCHEDULE				
TYPE	DESCRIPTION	MANUFACTURER	CATALOG No.	VOLTS NOTES
 DT1	DUAL TECHNOLOGY PASSIVE INFRARED AND ULTRASONIC OCCUPANCY SENSOR, WIDE ANGLE LENS.	nLIGHT	nCM PDT 9 RUB	24 V 1, 2
 SW	DIGITAL LOW VOLTAGE WALL SWITCH	nLIGHT	nPODM	24 V 1, 2
 LVD	DIGITAL LOW VOLTAGE DIMMER	nLIGHT	nPODM DX	24 V 1, 2
 OS	DIGITAL LOW VOLTAGE WALL SWITCH WITH INTEGRAL PIR OCCUPANCY SENSOR	nLIGHT	nWSX LV	24 V 1, 2
 OSD	DIGITAL LOW VOLTAGE WALL DIMMER WITH INTEGRAL PIR OCCUPANCY SENSOR	nLIGHT	nWSX PDT LV DX	24 V 1, 2
SCHEDULE NOTES: 1. BUS POWERED DEVICE. 2. PROVIDE 24 VDC POWER PACK WITH INPUT TO MATCH LIGHTING FIXTURE VOLTAGE, SWITCHING CONTACT RATED FOR 20A, DRIVER.				

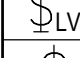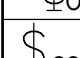		CONSULTANTS:	ARCHITECT/ENGINEER OF RECORD:	STAMP:		Drawing Title	Phase	Project Title	Project Number
		 1640 TONAWANDA CREEK PARKWAY SUITE 400, LEANWOOD, KANSAS 66021	 750 W HAMPDEN AVE SUITE 300 ENGLEWOOD, CO 80110 (720) 550-6307 WWW.VALHALLAENGINEERING.COM	 8/5/2020	 U.S. Department of Veterans Affairs	LIGHTING SCHEDULES	100% CONSTRUCTION DOCUMENTS	OUTPATIENT MENTAL HEALTH / EDUCATION ADDITION	436-114
		 CONSULTANTS	 Structural Engineers			Approved: Project Director		Location 3687 Veterans Drive, Fort Harrison, MT 59636	Building Number 154
		Issued:	Date:					Issue Date 08/05/2020	Checked TL
								Drawn JEE	Drawing Number E-601-P2
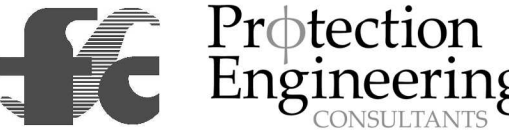
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C

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of Veterans Affairs

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08/05/2020	TL	GH

EP601-P2

ARCHITECT/ENGINEERS:



**VALHALLA
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GROUP, LLC**


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8/5/2020

Phase	100% CONSTRUCTION DOCUMENTS
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Approved: Project Director

Location	3687 VETERANS DRIVE , FORT HARRISON, MT 59636
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Issue Date	Checked	Drawn
08/05/2020	TL	GH

430-114
Building Number
154


Drawing Number
EP601-P2

ELECTRICAL GENERAL NOTES:

A. FOR GENERAL NOTES AND SYMBOLS SEE SHEET E-001.

KEY NOTES:

1 WORK TO BE DONE IN EXISTING PANEL.

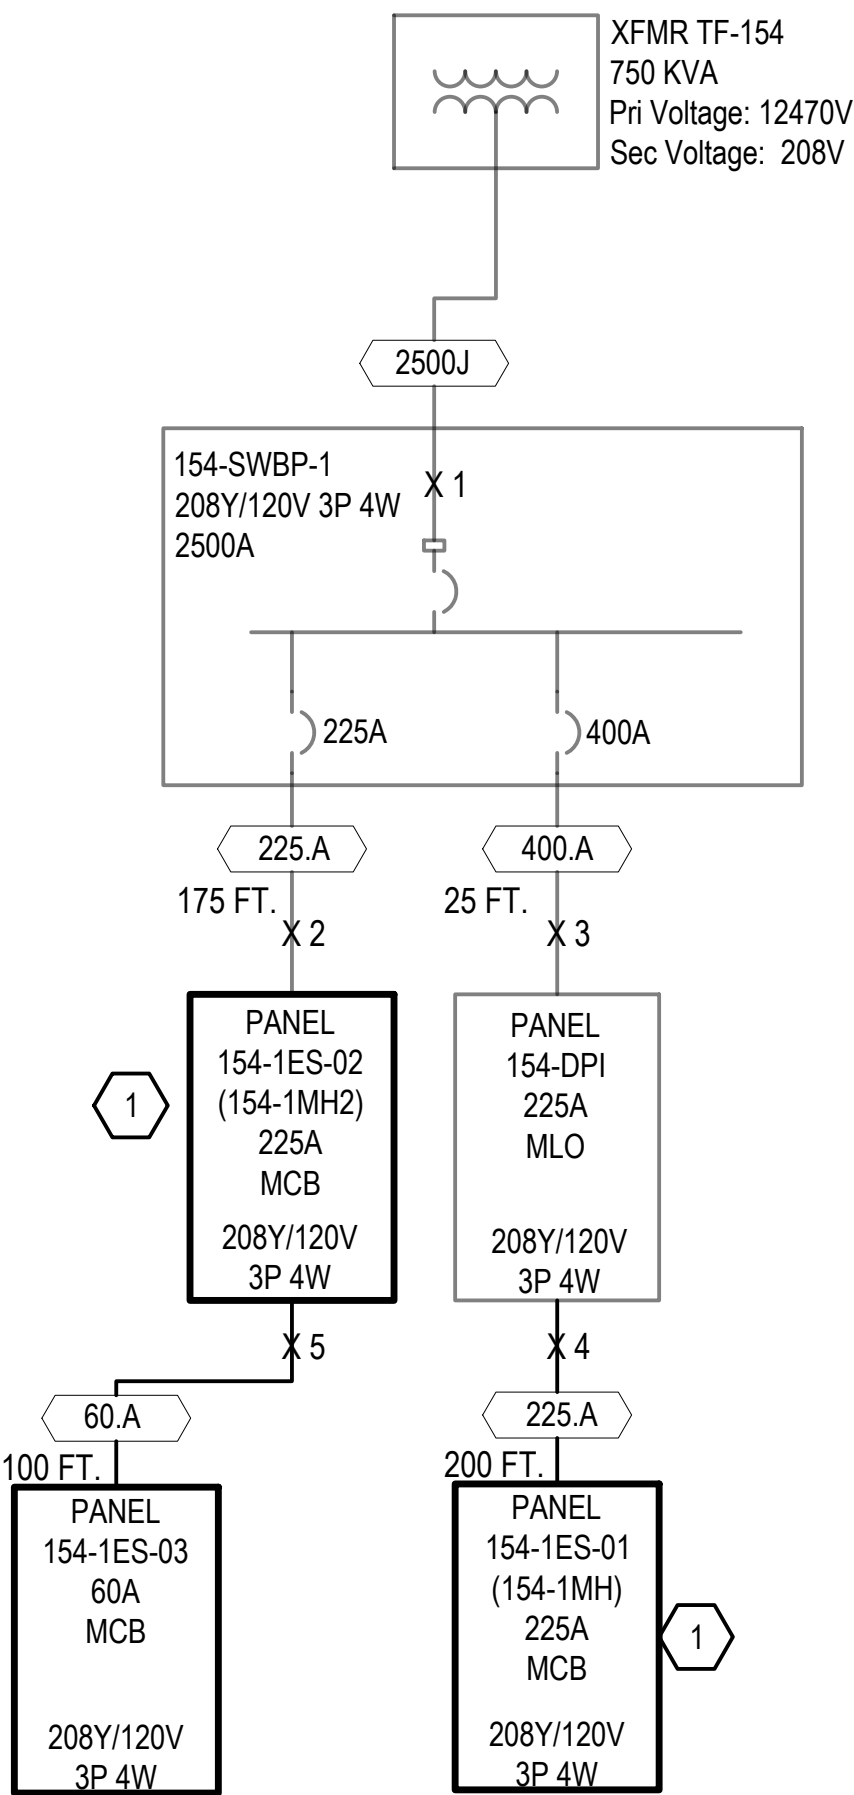

FEEDER SCHEDULE		
ID	FEEDER AMPS	CONDUIT AND FEEDER
60.A	60	(4#4 & 1#10G)1-1/2"C
100.A	100	(4#1 & 1#8G)EXTEND CONDUIT 25'
225.A	225	(4#4/0 & 1#4G)EXISTING CONDUIT
400.A	400	(4#500MMVM, 1#1/0G)EXISTING CONDUIT
2500J	2500	6(4#600KCML & 1#1/0G)3-1/2"C

SIZING METHOD: COPPER, 60°C #12 THROUGH #1, 75°C 1/0 AND ABOVE
FEEDER SCHEDULE

SHORT CIRCUIT TABLE	
ID	SHORT CIRCUIT VALUE
1	22800A Isc
2	7119A Isc
3	18782A Isc
4	3551A Isc
5	2783A Isc

1 ONE LINE DIAGRAM BLDG 154
SCALE: NO SCALE

File Path

VA FORM 08-6231

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VEG 4.11

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U.S. Department of Veterans Affairs

Drawing Title

ONE-LINE DIAGRAMS & PHASE DIAGRAMS

Approved: Project Director

Phase

100% CONSTRUCTION DOCUMENTS

Project Title

OUTPATIENT MENTAL HEALTH / EDUCATION ADDITION

Location
3687 VETERANS DRIVE , FORT HARRISON, MT 59636

Issue Date
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Project Number

436-114

Building Number

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Drawing Number

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