

# USDC & USBC TRANSACTION WINDOWS

**U.S. COURTHOUSE,  
5400 FEDERAL PLAZA,  
HAMMOND, IN 46320-1839  
(IN0300ZZ)**

**100% CD / OCTOBER 28, 2022**

PREPARED FOR:



PBS SOUTHERN SERVICE CENTER OPERATIONS DIVISION  
230 S. DEARBORN STREET  
CHICAGO, IL 60604

**GOVERNMENT TEAM**

CARY KUBIAK, PROJECT MANAGER & CONTRACTING OFFICER'S REPRESENTATIVE  
ANEESA MUHAMMAD, CONTRACTING OFFICER  
TOM ROGIC, PROPERTY MANAGER

**ARCHITECT**

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CHICAGO, IL 60601  
ROBIN WHITEHURST, PROJECT PRINCIPAL  
SUSAN HICKEY, PROJECT ARCHITECT  
KENT LOCKE, PROJECT ENGINEER

DATE: 10/28/2020  
PROJECT NO: 47PF0020F0874  
BUILDING NO: IN0300  
BED PROJECT NO: 17005-020019-00-0000  
PROJECT ADDRESSES: 5400 FEDERAL PLAZA  
HAMMOND, IN 46320

**GENERAL NOTES**

- THESE DRAWINGS INDICATE THE GENERAL SCOPE OF THE PROJECT IN TERMS OF THE ARCHITECTURAL DESIGN CONCEPT, DIMENSIONS, MAJOR ELEMENTS AND MATERIALS. THESE DRAWINGS DO NOT NECESSARILY INDICATE OR DESCRIBE ALL WORK REQUIRED FOR THE FULL COMPLETION OF THE PROJECT. ALL CONTRACTORS SHALL FURNISH ALL OF THOSE ITEMS AND LABOR REQUIRED FOR THE FULL COMPLETION OF THIS PROJECT IN A FIRST CLASS WORKMANSHIP-LIKE MANNER.
- ALL WORK IS TO BE PERFORMED FROM FINAL CONSTRUCTION DOCUMENTS ONLY AND A COPY OF THE APPROVED FINAL SET MUST BE LOCATED ON THE SITE AT ALL TIMES. ALL CONTRACTOR'S SUBCONTRACTORS SHALL BE GIVEN FULL SETS OF FINAL CONSTRUCTION DOCUMENTS WITH NO SHEETS EXCLUDED.
- DO NOT SCALE DRAWINGS.** WRITTEN DIMENSIONS HOLD PRIORITY OVER APPARENT SCALE. DIMENSIONS ARE TO THE FACE OF FINISHED ELEMENTS OR TO THE CENTERLINE OF ELEMENTS UNLESS NOTED OTHERWISE. CONTRACTOR TO VERIFY CRITICAL DIMENSIONS WITH THE GOVERNMENT PRIOR TO COMMENCING WORK.
- ALL EXISTING WALLS AND PARTITIONS ARE DIMENSIONED TO THE FACE OF WALLS. ALL NEW PARTITIONS ARE DIMENSIONED TO THE CENTERLINE OF WALL.

**SHEET INDEX**

- G000 COVER SHEET
- G001 LOCATION MAP
- G002 ADA ACCESSIBILITY AND CODE STANDARDS
- G003 CODE SHEET
- A100 US. BANKRUPTCY CLERK'S OFFICE RECEPTION DESK - DEMO & NEW WORK FLOOR PLAN
- A101 US. BANKRUPTCY CLERK'S OFFICE RECEPTION DESK - DEMO & NEW WORK RCP
- A102 US. DISTRICT COURT CLERK'S OFFICE RECEPTION DESK - DEMO & NEW WORK FLOOR PLAN
- A103 US. DISTRICT COURT CLERK'S OFFICE RECEPTION DESK - DEMO & NEW WORK RCP
- A300 INTERIOR ELEVATIONS
- A600 SECTIONS AND DETAILS
- FP110 FIRE PROTECTION FLOOR PLANS
- FP111 FIRE PROTECTION FLOOR PLANS
- M000 MECHANICAL STANDARDS
- M110 MECHANICAL FLOOR PLANS
- M111 MECHANICAL FLOOR PLANS
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- E110 LIGHTING FLOOR PLANS
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- E112 POWER AND SYSTEM FLOOR PLANS
- E113 POWER AND SYSTEM FLOOR PLANS
- E200 ELECTRICAL CONDUIT ROUTE PLANS

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**KEY MAP**

U.S. COURTHOUSE  
5400 FEDERAL PLAZA,  
HAMMOND, IN 46320-1839



GSA GREAT LAKES REGION 5  
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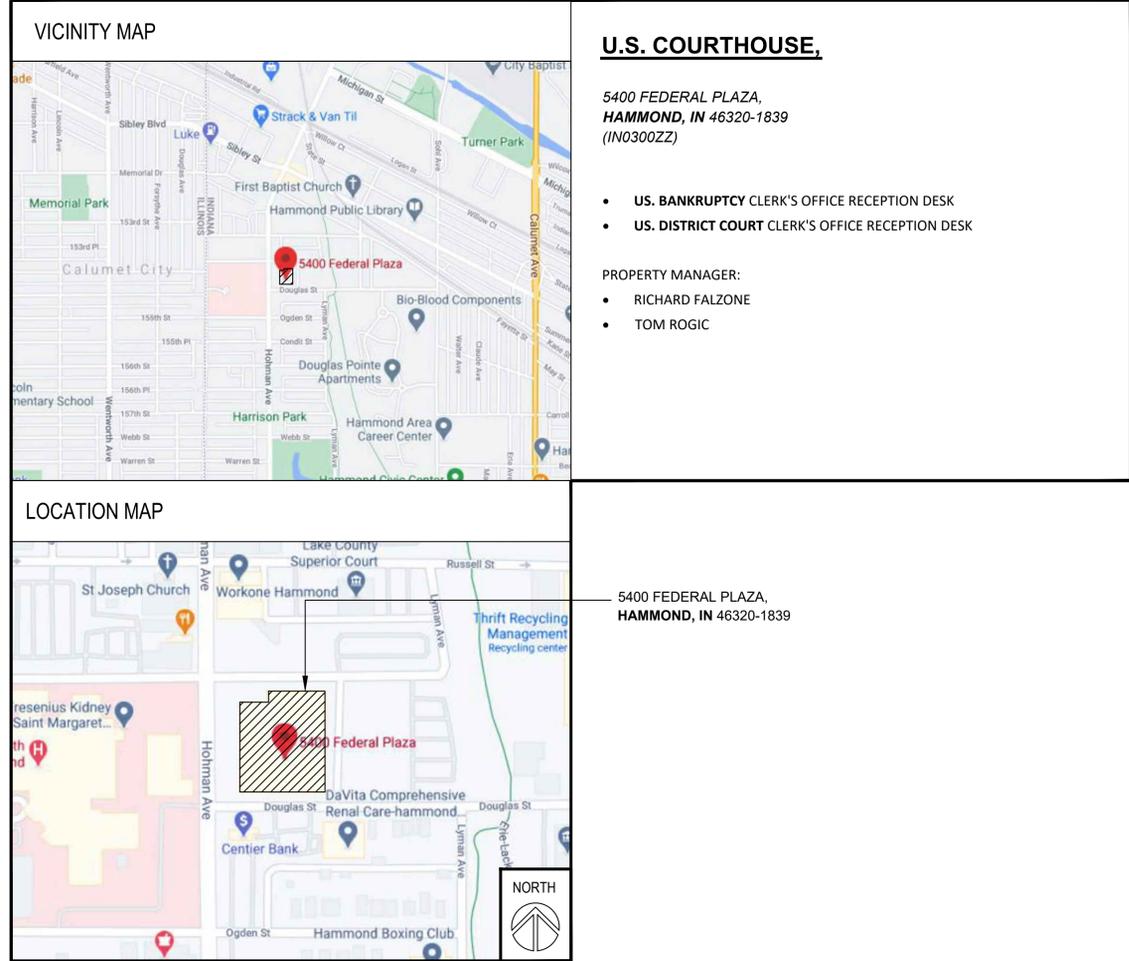
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MARK	DESCRIPTION	DATE
	100% CD	10.28.2022

GENERAL SERVICES ADMINISTRATION REGION 5 CHICAGO, IL	
BUILDING NAME	U.S. COURTHOUSE
BUILDING STREET	5400 FEDERAL PLAZA
BUILDING CITY/STREET/ZIP	HAMMOND, IN 46320-1839
BUILDING NO.	(IN0300ZZ)
OTHER BUILDING NOS.	
PJCT. PROJECT DESCRIPTION	USDC & USBC TRANSACTION WINDOWS
PJCT. PROJECT NO.	17005 - 020019 - 00
DRAWING TITLE	COVER SHEET
DRAWING TYPE	GENERAL
DRAWING FILE NAME	
DRAWING FLOOR NO.	
DRAWING DRAWN BY	AM SHEET SIZE: 24 X 36
DRAWING CHECKED BY	SH DATE: 09.24.20
DRAWING NO.	G000
	SHEET 1 OF 21

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**U.S. COURTHOUSE,**

5400 FEDERAL PLAZA,  
HAMMOND, IN 46320-1839  
(IN0300ZZ)

- US. BANKRUPTCY CLERK'S OFFICE RECEPTION DESK
- US. DISTRICT COURT CLERK'S OFFICE RECEPTION DESK

PROPERTY MANAGER:

- RICHARD FALZONE
- TOM ROGIC

5400 FEDERAL PLAZA,  
HAMMOND, IN 46320-1839



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REGION 5 CHICAGO, IL

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	TYPE	GENERAL
	FILE NAME	
DRAWING	FLOOR NO.	
	DRAWN BY	AM SHEET SIZE: 24 X 36
DRAWING	CHECKED BY	SH DATE: 09.24.20
	DRAWING NO.	G001
		SHEET 2 OF 21

CHAPTER 3: BUILDING BLOCKS

304 TURNING SPACE

304.3.1 CIRCULAR SPACE. THE TURNING SPACE SHALL BE A SPACE OF 60 INCHES (1525 MM) DIAMETER MINIMUM. THE SPACE SHALL BE PERMITTED TO INCLUDE KNEE AND TOE CLEARANCE COMPLYING WITH 306.

304.3.2 T-SHAPED SPACE. THE TURNING SPACE SHALL BE A T-SHAPED SPACE WITHIN A 60 INCH (1525 MM) SQUARE MINIMUM WITH ARMS AND BASE 36 INCHES (915 MM) WIDE MINIMUM. EACH ARM OF THE T SHALL BE CLEAR OF OBSTRUCTIONS 12 INCHES (305 MM) MINIMUM IN EACH DIRECTION AND THE BASE SHALL BE CLEAR OF OBSTRUCTIONS 24 INCHES (610 MM) MINIMUM. THE SPACE SHALL BE PERMITTED TO INCLUDE KNEE AND TOE CLEARANCE COMPLYING WITH 306 ONLY AT THE END OF EITHER THE BASE OR ONE ARM.

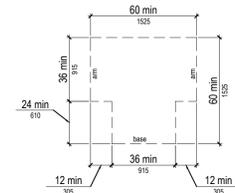


FIGURE 304.3.2 T-SHAPED TURNING SPACE


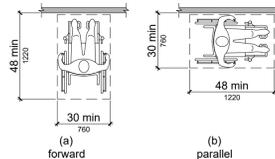


FIGURE 305.5 POSITION OF CLEAR FLOOR OR GROUND SPACE

308.3 SIDE REACH.

308.3.1 UNOBSTRUCTED. WHERE A CLEAR FLOOR OR GROUND SPACE ALLOWS A PARALLEL APPROACH TO AN ELEMENT AND THE SIDE REACH IS UNOBSTRUCTED, THE HIGH SIDE REACH SHALL BE 48 INCHES (1220 MM) MAXIMUM AND THE LOW SIDE REACH SHALL BE 15 INCHES (380 MM) MINIMUM ABOVE THE FINISH FLOOR OR GROUND.

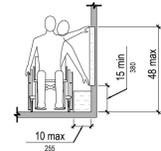

308.3.2 OBSTRUCTED HIGH REACH. WHERE A CLEAR FLOOR OR GROUND SPACE ALLOWS A PARALLEL APPROACH TO AN ELEMENT AND THE HIGH SIDE REACH IS OVER AN OBSTRUCTION, THE HEIGHT OF THE OBSTRUCTION SHALL BE 34 INCHES (865 MM) MAXIMUM AND THE DEPTH OF THE OBSTRUCTION SHALL BE 24 INCHES (610 MM) MAXIMUM. THE HIGH SIDE REACH SHALL BE 48 INCHES (1220 MM) MAXIMUM FOR A REACH DEPTH OF 10 INCHES (255 MM) MAXIMUM. WHERE THE REACH DEPTH EXCEEDS 10 INCHES (255 MM), THE HIGH SIDE REACH SHALL BE 46 INCHES (1170 MM) MAXIMUM FOR A REACH DEPTH OF 24 INCHES (610 MM) MAXIMUM.

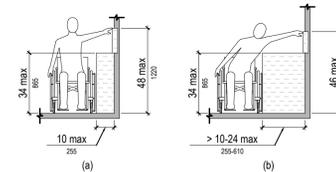



FIGURE 308.3.2 OBSTRUCTED HIGH SIDE REACH

CHAPTER 9: BUILT-IN ELEMENTS

904.3 SALES AND SERVICE COUNTERS.

SALES COUNTERS AND SERVICE COUNTERS SHALL COMPLY WITH 904.4.1 OR 904.4.2. THE ACCESSIBLE PORTION OF THE COUNTER TOP SHALL EXTEND THE SAME DEPTH AS THE SALES OR SERVICE COUNTER TOP.

EXCEPTION: IN ALTERATIONS, WHEN THE PROVISION OF A COUNTER COMPLYING WITH 904.4 WOULD RESULT IN A REDUCTION OF THE NUMBER OF EXISTING COUNTERS AT WORK STATIONS OR A REDUCTION OF THE NUMBER OF EXISTING MAIL BOXES, THE COUNTER SHALL BE PERMITTED TO HAVE A PORTION WHICH IS 24 INCHES (610 MM) LONG MINIMUM COMPLYING WITH 904.4.1 PROVIDED THAT THE REQUIRED CLEAR FLOOR OR GROUND SPACE IS CENTERED ON THE ACCESSIBLE LENGTH OF THE COUNTER.

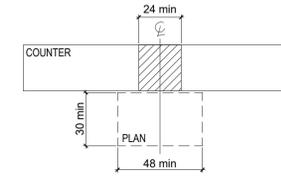

904.4.1 PARALLEL APPROACH.

A PORTION OF THE COUNTER SURFACE THAT IS 36 INCHES (915 MM) LONG MINIMUM AND 36 INCHES (915 MM) HIGH MAXIMUM ABOVE THE FINISH FLOOR SHALL BE PROVIDED. A CLEAR FLOOR OR GROUND SPACE COMPLYING WITH 305 SHALL BE POSITIONED FOR A PARALLEL APPROACH ADJACENT TO THE 36 INCH (915 MM) MINIMUM LENGTH OF COUNTER.

EXCEPTION: WHERE THE PROVIDED COUNTER SURFACE IS LESS THAN 36 INCHES (915 MM) LONG, THE ENTIRE COUNTER SURFACE SHALL BE 36 INCHES (915 MM) HIGH MAXIMUM ABOVE THE FINISH FLOOR.

1 ADA ACCESSIBILITY STANDARDS

NTS

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MARK	DESCRIPTION	DATE
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GENERAL SERVICES ADMINISTRATION REGION 5 CHICAGO, IL	
BUILDING	NAME U.S. COURTHOUSE STREET 5400 FEDERAL PLAZA CITY/STREET/ZIP HAMMOND, IN 46320-1839 BUILDING NO. (IN0300ZZ)
P.L.C.T.	OTHER BUILDING NOs.
	PROJECT DESCRIPTION USDC & USBC TRANSACTION WINDOWS PROJECT NO. 17005 - 020019 - 00
	DRAWING TITLE ADA ACCESS.& CODE STANDARDS TYPE GENERAL FILE NAME FLOOR NO.
DRAWING	DRAWN BY AM SHEET SIZE: 24 X 36 CHECKED BY SH DATE: 09.24.20
	DRAWING NO. G002 SHEET 3 OF 21

**CODE ANALYSIS:**

NFPA 101 MAXIMUM FLOOR AREA ALLOWANCES PER OCCUPANT	
BUSINESS AREAS	150 GROSS
ACCESSORY STORAGE AREAS, MECHANICAL EQUIPMENT ROOM	300 GROSS

**US. BANKRUPTCY CLERK'S OFFICE**

**US. DISTRICT COURT CLERK'S OFFICE**

BUSINESS USE = 10,254 SQFT  
 BUSINESS USE (RESTROOMS) = 162 SQFT  
 TOTAL BUSINESS USE = 10,416 SQFT % 150 = 69.44

BUSINESS USE = 12,432 SQFT  
 BUSINESS USE (RESTROOMS) = 224 SQFT  
 TOTAL BUSINESS USE = 12,656 SQFT % 150 = 84.37  
 STORAGE USE = 456 SQFT % 300 GROSS = 1.52

US. BANKRUPTCY CLERK'S OFFICE: 2 MAIN EXIT PATHS / 2 EXIT PATHS  
 US. BANKRUPTCY CLERK'S OFFICE RECEPTION (NEW ENCLOSED SPACE):  
 1 MAIN EXIT / 2 EXIT PATH

US. DISTRICT COURT CLERK'S OFFICE: 3 MAIN EXIT / 2 EXIT PATH  
 US. DISTRICT COURT CLERK'S OFFICE RECEPTION (NEW ENCLOSED SPACE):  
 1 MAIN EXIT / 2 EXIT PATH

**NATIONAL FIRE PROTECTION ASSOCIATION: GROUP**

BUSINESS (B)
STORAGE (S)

**OCCUPANCY GROUP (B)**  
 MAXIMUM OCCUPANCY LOAD WITH (1) EXIT = 50  
 MINIMUM NO. OF OCCUPANTS WITH (2) EXIT = 51 - 500

**OCCUPANCY GROUP (S)**  
 MAXIMUM OCCUPANCY LOAD WITH (1) EXIT = 30  
 MINIMUM NO. OF OCCUPANTS WITH (2) EXIT = 31 - 500

**LIFE SAFETY GENERAL NOTES:**

1. EXISTING LIFE SAFETY INFORMATION SHOWN IS FROM LIFE SAFETY DRAWINGS PROVIDED BY THE OWNER. ALL CONTRACTORS SHALL REVIEW ANY POSSIBLE RECENT REVISIONS TO THE OWNERS LIFE SAFETY CRITERIA AND FIELD VERIFY CONDITIONS OF RATINGS INDICATED PRIOR TO COMMENCING THE WORK.


**CODE PLAN LEGEND:**

- LINE OF TRAVEL FROM REMOTE LOCATION TO EXIT (NOT TO EXCEED 300-FT)
- LINE OF ACCESSIBLE ROUTE (NOT TO EXCEED 100-FT)
- VERTICAL EGRESS

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U.S. COURTHOUSE, 5400 FEDERAL PLAZA, HAMMOND, IN 46320-1839

KEYPLAN

2ND FLOOR N.T.S.  
 NORTH

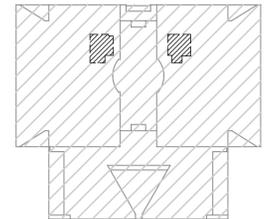AREA N.I.C. PROJECT AREA



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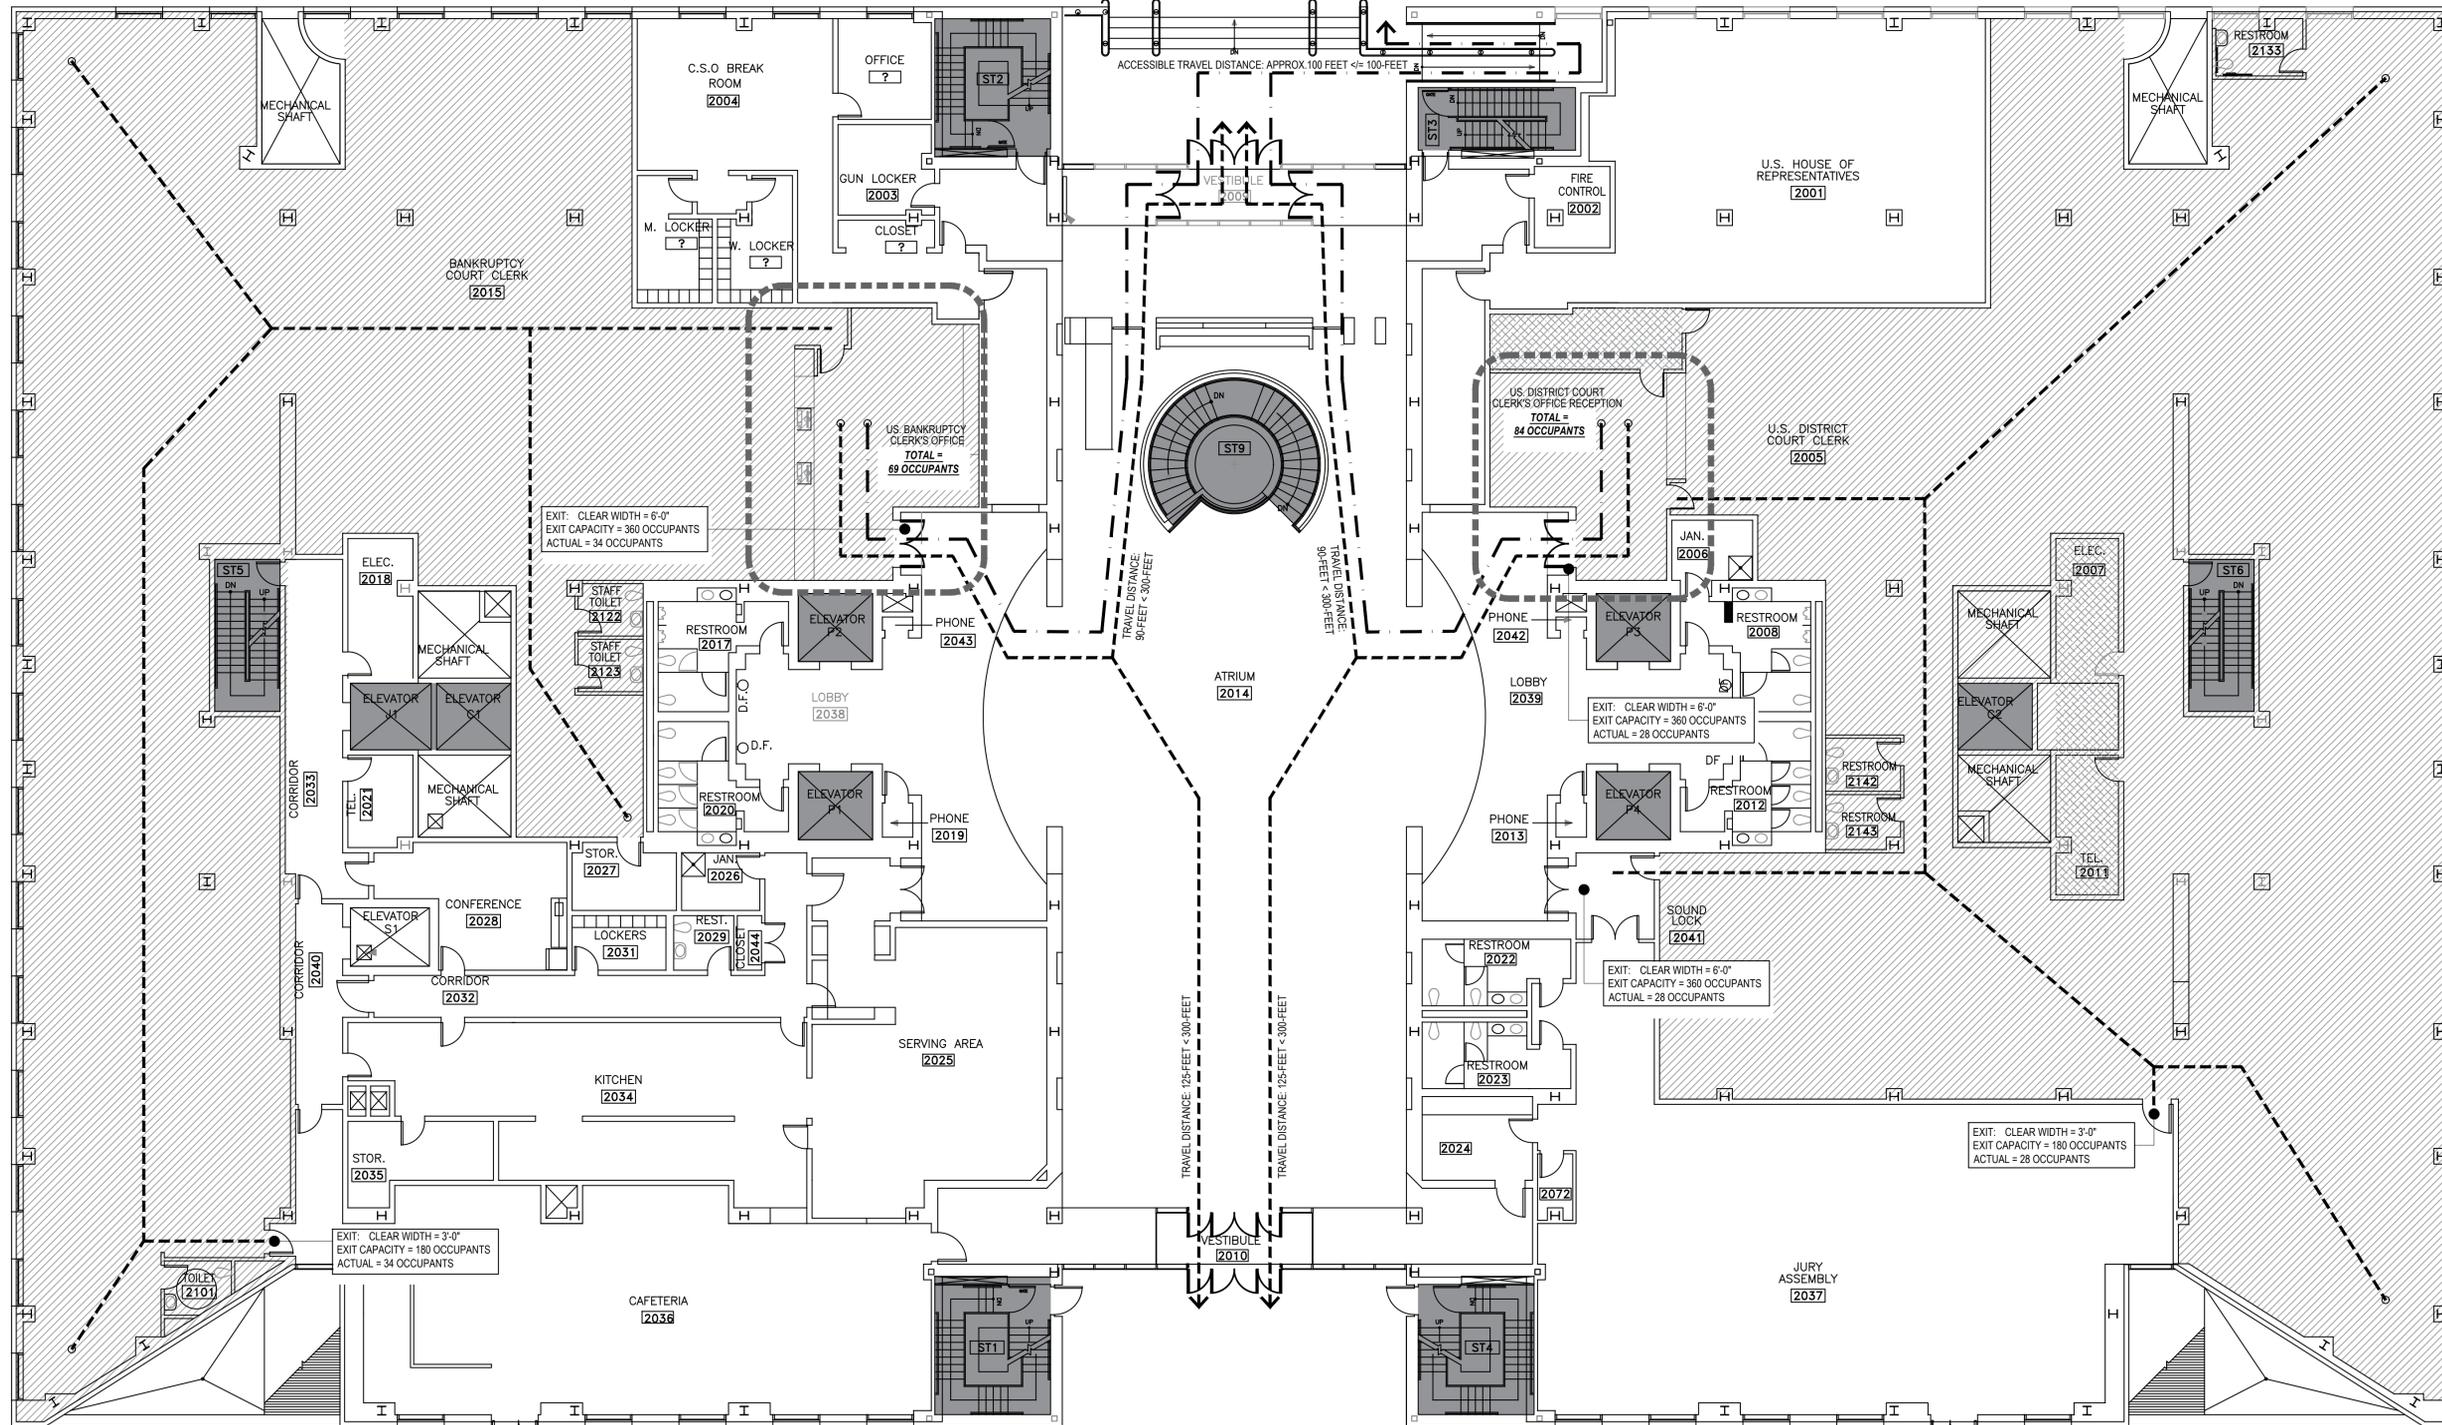
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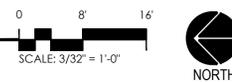
GENERAL SERVICES ADMINISTRATION  
 REGION 5 CHICAGO, IL

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	PROJECT NO.	17005 - 020019 - 00
DRAWING	DRAWING TITLE	CODE PLANS: HAMMOND, IN
	TYPE	GENERAL
DRAWING	FILE NAME	
	FLOOR NO.	
DRAWING	DRAWN BY	AM SHEET SIZE: 24 X 36
	CHECKED BY	SH DATE: 09.24.20
DRAWING	DRAWING NO.	G003
	SHEET	4 OF 21



U.S. COURTHOUSE  
 5400 FEDERAL PLAZA. HAMMOND, IN 46320-1839

SCALE: 3/32"=1'-0"



NORTH

**DEMOLITION GENERAL NOTES**

- REMOVE AND LEGALLY DISPOSE OFF SITE THOSE ITEMS INDICATED TO BE REMOVED. REMOVE AND DISPOSE OF DEMOLITION DEBRIS DAILY, AFTER GOVERNMENT OCCUPIED HOURS.
- CONTRACTORS TO USE CARE WHEN PERFORMING WORK ABOVE CEILINGS TO AVOID DAMAGE TO EXISTING UTILITIES AND OTHER MATERIALS TO REMAIN.
- ALL DEMOLITION TO BE DONE NEATLY AND WITHOUT DAMAGE TO EXISTING CONSTRUCTION. PROTECT CONSTRUCTION TO REMAIN. PROMPTLY REPAIR DAMAGES CAUSED TO ADJACENT FACILITIES AT NO COST TO THE GOVERNMENT. SEE SPECIFICATION SECTION 01 73 20 SELECTIVE DEMOLITION.
- ERECT AND MAINTAIN DUST-PROOF PARTITIONS AND CLOSURES AS REQUIRED TO PREVENT SPREAD OF DUST OR FUMES.
- THIS DRAWING IS PRIMARILY FOR ARCHITECTURAL DEMOLITION SCOPE. REFER TO MECHANICAL, ELECTRICAL, AND PLUMBING FOR ADDITIONAL DEMOLITION REQUIREMENTS.
- ALL CONTRACTORS EXPECTED TO RECYCLE CONSTRUCTION WASTE AND DEMOLITION MATERIALS AND TO SUBMIT TO GSA CERTIFICATES FOR ALL MATERIALS DIVERTED FROM LANDFILL. CONTRACTORS ARE ALLOWED TO BRING ADDITIONAL DUMPSTERS. ALL DEMOLITION WASTE REMOVAL SHOULD BE COORDINATED WITH THE PROPERTY MANAGER. SEE SPECIFICATION SECTION 01 74 19.
- ALL CONTRACTORS ARE REQUIRED TO MAKE A SITE VISIT TO VERIFY EXISTING CONDITIONS PRIOR TO SUBMITTING BIDS.
- THE CONTRACTOR IS REQUIRED TO FOLLOW ALL BUILDING SPECIFIC WORK RESTRICTIONS- SEE SPECIFICATIONS SECTION 01 14 00.
- WHERE DEMOLITION OCCURS, REMOVE AND CAP UTILITIES AT THEIR SOURCE UNLESS NOTED OTHERWISE.
- PLANS ARE DIAGRAMMATIC AND PROVIDED TO SHOW INTENT ONLY. UNLESS NOTED OTHERWISE ALL PARTITION ASSEMBLIES INDICATED TO BE DEMOLISHED SHALL BE DEMOLISHED COMPLETELY, INCLUDING FINISHES GYP. BD., METAL FRAMING, FASTENING DEVICES ETC.

- AREA OF DEMOLITION/REMOVAL IN CORRIDOR. CONTRACTOR SHALL REPAIR FLOORS, WALLS AND FINISHED CEILINGS AS REQUIRED TO MATCH EXISTING AND TO BE FLUSH AND SMOOTH WITH ADJACENT.
- CONTRACTOR TO INSPECT ABOVE CEILING FOR CONTINUITY OF PLENUM ENCLOSURE. NOTIFY ARCHITECT OF ANY EXISTING DEFECTS /GAPS/ OPENINGS PRIOR TO PROCEEDING

**DEMOLITION KEYNOTES:**

- EXISTING ADA HEIGHT COUNTERTOP TO REMAIN
- MODIFY EXISTING PLASTIC LAMINATE COUNTERTOP AND BASE CABINET AS REQUIRED FOR NEW DOCUMENT TRAY DEPRESSED INTO COUNTER

**LEGEND**

- EXISTING DOOR AND FRAME TO BE DEMOLISHED
- EXISTING WALL TO REMAIN
- EXISTING DOOR AND FRAME TO REMAIN
- EXISTING WALL TO BE REMOVED
- EXISTING TO BE DEMOLISHED
- AREA N.I.C.
- INDICATES KEYNOTE APPLICABLE TO ENTIRE WORK AREA
- ROOM NAME  
ROOM #
- ROOM TAG

**NEW WORK PLAN GENERAL NOTES**


- CONTRACTOR SHALL VISIT SITE AND BECOME FAMILIAR WITH EXISTING CONDITIONS PRIOR TO COMMENCING WORK. EXISTING CONDITIONS SHOWN ARE FROM INFORMATION PROVIDED BY GOVERNMENT. VERIFY IN FIELD ALL EXISTING CONDITIONS, PRIOR TO PROCEEDING WITH THE WORK.
- CONTRACTOR SHALL NOTIFY ARCHITECT OF ANY AND ALL DISCREPANCIES BETWEEN CONTRACT DOCUMENTS AND EXISTING CONDITIONS PRIOR TO PROCEEDING WITH WORK.
- PATCH AND PREPARE EXISTING WALLS AS NECESSARY TO RECEIVE NEW FINISHES WHERE SCHEDULED.
- ROOM LAYOUTS AND CONFIGURATIONS FOR AREAS OUTSIDE OF CURRENT WORK ARE SHOWN FOR REFERENCE ONLY.

**KEYNOTES:**

- PROVIDE BLOCKING REINFORCEMENT UNDER COUNTERTOP AS REQUIRED TO SUPPORT NEW TEMPERED GLAZING WINDOW AND ALUMINUM FRAME
- NEW BREAK RESISTANT TEMPERED GLAZING WINDOW, FROM COUNTERTOP TO CEILING WITH ALUMINUM FRAME AT BOTH ENDS
- NEW DOCUMENT TRAY DEPRESSED INTO PLASTIC LAMINATE COUNTER
- NEW DOCUMENT TRAY DEPRESSED INTO PLASTIC LAMINATE COUNTER, ADA HEIGHT, 36" MAX
- COMPUTER STATION


**LEGEND**

- AREA N.I.C.
- EXISTING WALL TO REMAIN
- NEW WALL
- EXISTING DOOR AND FRAME TO REMAIN
- EXISTING EQUIPMENT
- WINDOW TAG. SEE SCHEDULE, SHEET A900
- PARTITION TYPE TAG. SEE SHEET G002
- DOOR TAG. SEE SCHEDULE, SHEET A900
- ROOM NAME  
ROOM #
- ROOM TAG. SEE SCHEDULE, SHEET A901
- NEW DOOR AND FRAME

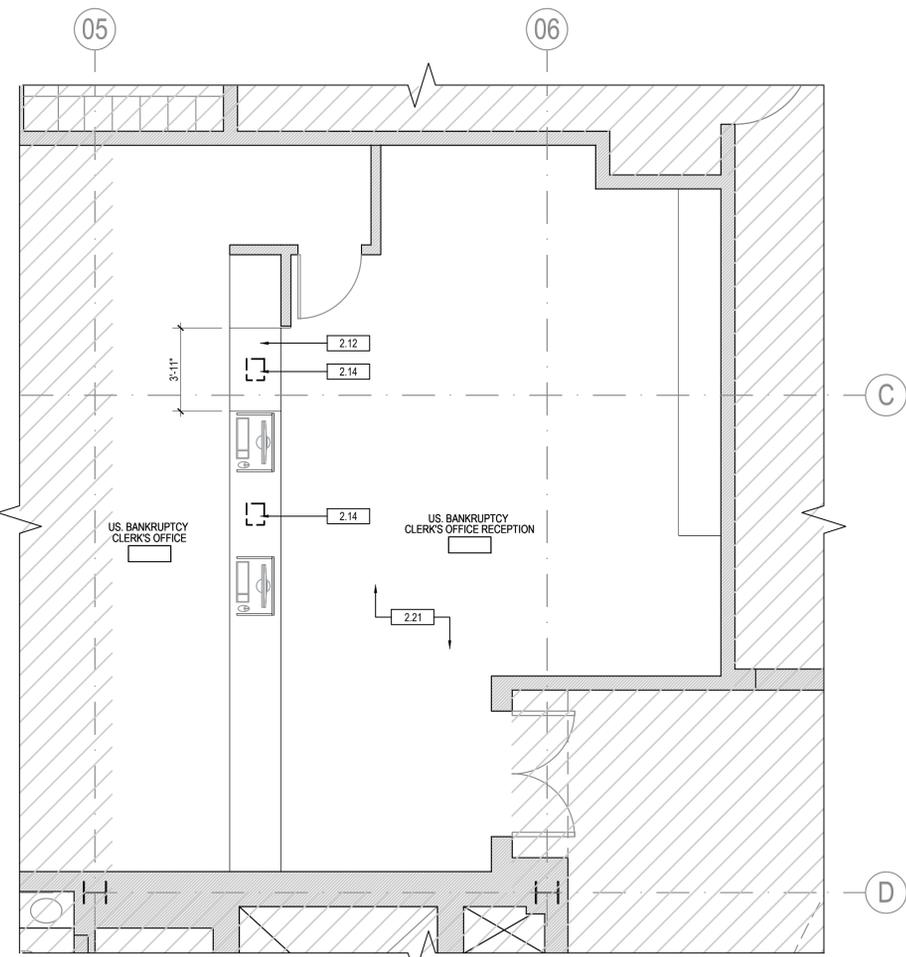


**2ND LEVEL PARTIAL DEMO FLOOR PLAN  
US. BANKRUPTCY CLERK'S OFFICE RECEPTION DESK**

1 SCALE: 1/4"=1'-0"

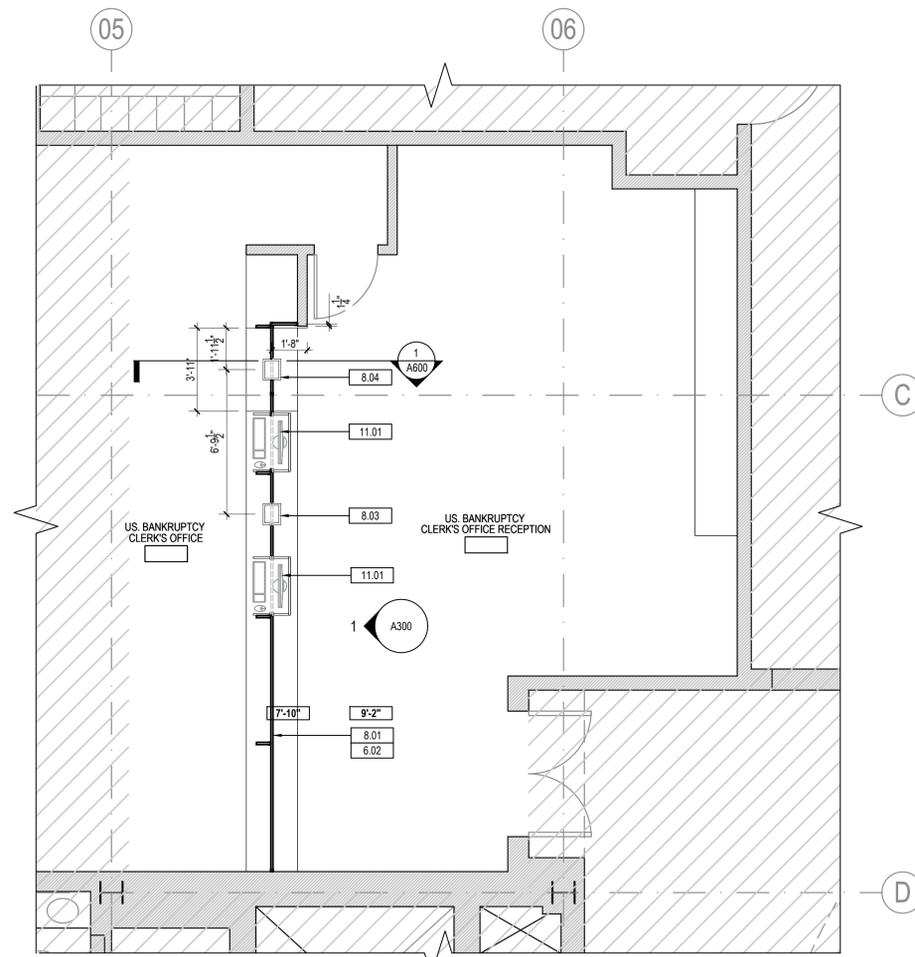

**2ND LEVEL PARTIAL NEW WORK FLOOR PLAN  
US. BANKRUPTCY CLERK'S OFFICE RECEPTION DESK**

2 SCALE: 1/4"=1'-0"

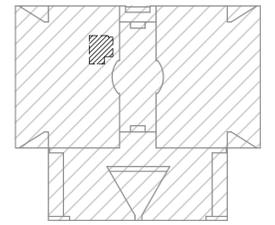

U.S. COURTHOUSE, 5400 FEDERAL PLAZA, HAMMOND, IN 46320-1839

**KEYPLAN**

2ND FLOOR N.T.S.  
NORTH

- AREA N.I.C.
- PROJECT AREA



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	TYPE	ARCHITECTURE
	FILE NAME	
	FLOOR NO.	2ND FLOOR
	DRAWN BY	AM SHEET SIZE: 24 X 36
	CHECKED BY	SH DATE: 09.24.20
	DRAWING NO.	A100
	SHEET	5 OF 21

**RCP DEMOLITION GENERAL NOTES**

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- WHERE DEMOLITION OCCURS, REMOVE AND CAP UTILITIES AT THEIR SOURCE UNLESS NOTED OTHERWISE.
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- AREA OF DEMOLITION/REMOVAL IN CORRIDOR. CONTRACTOR SHALL REPAIR FLOORS, WALLS AND FINISHED CEILINGS AS REQUIRED TO MATCH EXISTING AND TO BE FLUSH AND SMOOTH WITH ADJACENT.
- CONTRACTOR TO INSPECT ABOVE CEILING FOR CONTINUITY OF PLENUM ENCLOSURE. NOTIFY ARCHITECT OF ANY EXISTING DEFECTS /GAPS/ OPENINGS PRIOR TO PROCEEDING

**DEMOLITION KEYNOTES:**

- REMOVE EXISTING GYPSUM BOARD SOFFIT. PATCH ADJACENT WALL AND PREP FOR NEW SOFFIT
- EXISTING ACT CEILING TILES TO BE REMOVED

**RCP LEGEND**

- AREA NOT IN SCOPE OF WORK
- EXISTING WALL TO REMAIN
- EXISTING TO BE DEMOLISHED
- EXISTING 2x2 LIGHT FIXTURE TO BE REMOVED; REF. ELECTRICAL PLANS
- EXISTING MECH. SUPPLY DIFFUSER TO BE REMOVED, REF. MECHANICAL PLANS
- EXISTING MECH. RETURN DIFFUSER TO BE REMOVED, REF. MECHANICAL PLANS
- INDICATES KEYNOTE APPLICABLE FOR ENTIRE AREA
- EXISTING SPRINKLER TO BE REMOVED
- EXISTING FIRE ALARM TO BE REMOVED
- EXISTING OCC SENSOR TO BE REMOVED
- EXISTING 2X2 ACOUSTICAL CEILING TILES AND GRID TO REMAIN
- EXISTING 2X2 ACOUSTICAL CEILING TILES AND GRID TO BE REMOVED
- EXISTING 2X2 LIGHT FIXTURE TO BE REMOVED; REF. ELECTRICAL PLANS
- EXISTING 2X4 LIGHT FIXTURE TO BE REMOVED; REF. ELECTRICAL PLANS
- EXISTING GYP BOARD CEILING TO BE REMOVED

**RCP GENERAL NOTES**

- CONTRACTOR SHALL VISIT THE SITE AND BECOME FAMILIAR WITH THE EXISTING CONDITIONS PRIOR TO COMMENCING THE WORK. EXISTING CONDITIONS SHOWN ARE FROM INFORMATION PROVIDED BY THE GOVERNMENT. VERIFY IN FIELD ALL EXISTING CONDITIONS, DIMENSIONS, ELEVATION HEIGHTS, CONSTRUCTION AND BUILDING SYSTEMS PRIOR TO PROCEEDING WITH THE WORK.
- CONTRACTOR SHALL NOTIFY THE ARCHITECT OF ANY AND ALL DISCREPANCIES BETWEEN THE CONTRACT DOCUMENTS AND EXISTING CONDITIONS PRIOR TO PROCEEDING WITH THE WORK.
- ROOM LAYOUTS AND CONFIGURATIONS FOR AREAS OUTSIDE OF THE CURRENT WORK ARE SHOWN FOR REFERENCE ONLY. EXISTING CONSTRUCTION IS BASED UPON LIMITED SURVEYS BY THE ARCHITECT AND INFORMATION PROVIDED BY THE GOVERNMENT. FIELD VERIFICATION PRIOR TO COMMENCEMENT OF CONSTRUCTION IS REQUIRED.

**KEYNOTES:**


- NEW GYPSUM BOARD SOFFIT

**RCP LEGEND**

- AREA NOT IN SCOPE OF WORK
- EXISTING WALL TO REMAIN
- NEW WALL
- NEW 2x2 LIGHT FIXTURE; REF. ELECTRICAL PLANS
- NEW MECH. SUPPLY DIFFUSER; REF. MECHANICAL PLANS
- NEW MECH. RETURN DIFFUSER; REF. MECHANICAL PLANS
- INDICATES KEYNOTE APPLICABLE FOR ENTIRE AREA
- NEW SPRINKLERS
- NEW FIRE ALARM
- NEW OCC SENSOR
- NEW 2X2 ACOUSTICAL CEILING TILES AND GRID
- NEW 2X4 ACOUSTICAL CEILING TILES AND GRID
- NEW 2X2 SURFACE MOUNTED LIGHT FIXTURE; REF. ELECTRICAL PLANS
- NEW 2X4 SURFACE MOUNTED LIGHT FIXTURE; REF. ELECTRICAL PLANS
- NEW GYP BOARD CEILING

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U.S. COURTHOUSE, 5400 FEDERAL PLAZA, HAMMOND, IN 46320-1839

**KEYPLAN**  
2ND FLOOR N.T.S.  
NORTH

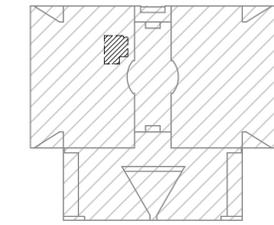AREA N.I.C.  
 PROJECT AREA



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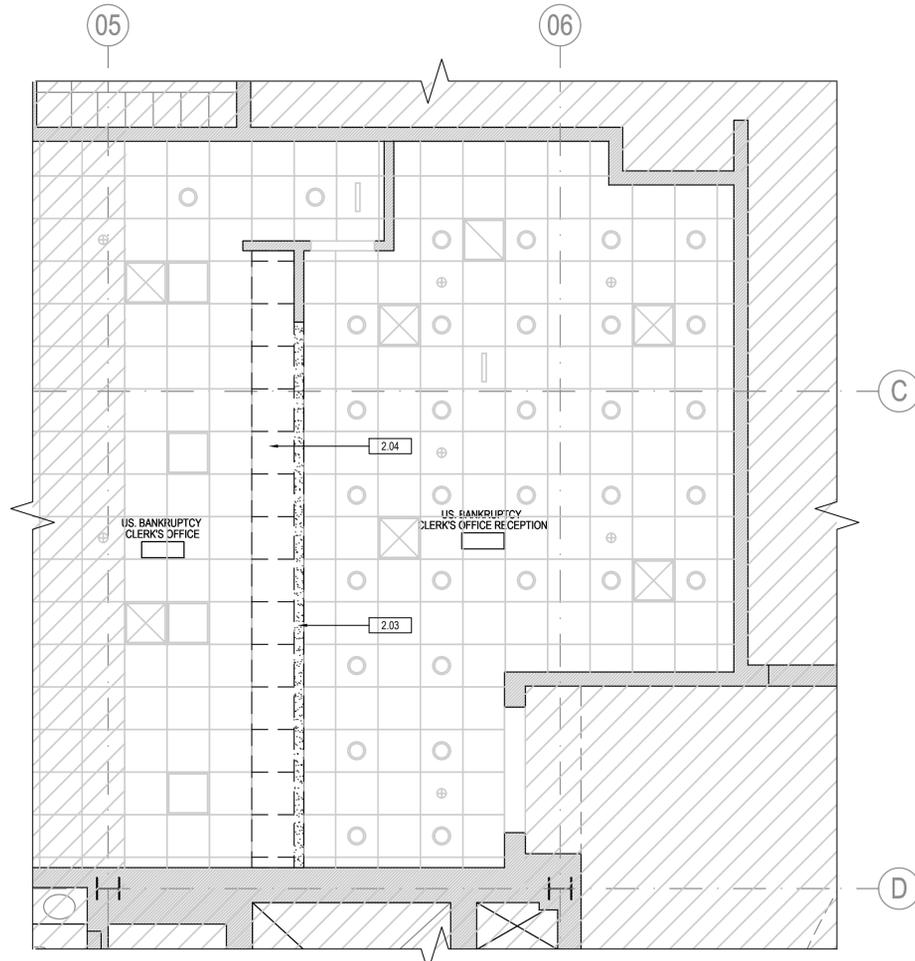
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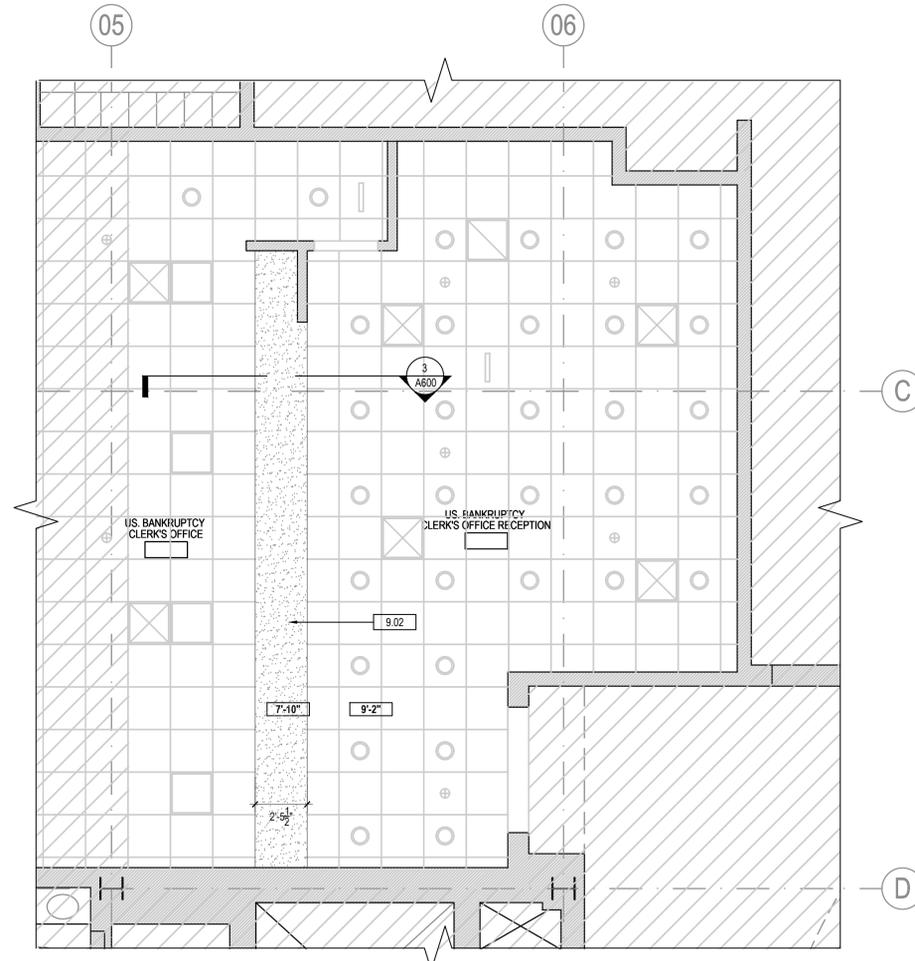
MARK	DESCRIPTION	DATE
	100% CD	10.28.2022

GENERAL SERVICES ADMINISTRATION  
REGION 5 CHICAGO, IL

BUILDING	NAME	U.S. COURTHOUSE	
	STREET	5400 FEDERAL PLAZA, HAMMOND, IN 46320-1839	
PROJECT	BUILDING NO.	(IN0300ZZ)	
	DESCRIPTION	USDC & USBC TRANSACTION WINDOWS	
DRAWING	PROJECT NO.	17005 - 020019 - 00	
	DRAWING TITLE	DEMO & NEW WORK RCP	
	TYPE	ARCHITECTURE	
	FILE NAME		
	FLOOR NO.	2ND FLOOR	
	DRAWN BY	AM	SHEET SIZE: 24 X 36
	CHECKED BY	SH	DATE: 09.24.20
	DRAWING NO.	A101	
	SHEET	6	OF 21



**1** 2ND LEVEL PARTIAL DEMO RCP  
US. BANKRUPTCY CLERK'S OFFICE RECEPTION DESK  
SCALE: 1/4"=1'-0" NORTH



**2** 2ND LEVEL PARTIAL NEW WORK RCP  
US. BANKRUPTCY CLERK'S OFFICE RECEPTION DESK  
SCALE: 1/4"=1'-0" NORTH

**DEMOLITION GENERAL NOTES**


- REMOVE AND LEGALLY DISPOSE OFF SITE THOSE ITEMS INDICATED TO BE REMOVED. REMOVE AND DISPOSE OF DEMOLITION DEBRIS DAILY, AFTER GOVERNMENT OCCUPIED HOURS.
- CONTRACTORS TO USE CARE WHEN PERFORMING WORK ABOVE CEILINGS TO AVOID DAMAGE TO EXISTING UTILITIES AND OTHER MATERIALS TO REMAIN.
- ALL DEMOLITION TO BE DONE NEATLY AND WITHOUT DAMAGE TO EXISTING CONSTRUCTION. PROTECT CONSTRUCTION TO REMAIN. PROMPTLY REPAIR DAMAGES CAUSED TO ADJACENT FACILITIES AT NO COST TO THE GOVERNMENT. SEE SPECIFICATION SECTION 01 73 20 SELECTIVE DEMOLITION.
- ERECT AND MAINTAIN DUST-PROOF PARTITIONS AND CLOSURES AS REQUIRED TO PREVENT SPREAD OF DUST OR FUMES.
- THIS DRAWING IS PRIMARILY FOR ARCHITECTURAL DEMOLITION SCOPE. REFER TO MECHANICAL, ELECTRICAL, AND PLUMBING FOR ADDITIONAL DEMOLITION REQUIREMENTS.
- ALL CONTRACTORS EXPECTED TO RECYCLE CONSTRUCTION WASTE AND DEMOLITION MATERIALS AND TO SUBMIT TO GSA CERTIFICATES FOR ALL MATERIALS DIVERTED FROM LANDFILL. CONTRACTORS ARE ALLOWED TO BRING ADDITIONAL DUMPSTERS. ALL DEMOLITION WASTE REMOVAL SHOULD BE COORDINATED WITH THE PROPERTY MANAGER. SEE SPECIFICATION SECTION 01 74 19.
- ALL CONTRACTORS ARE REQUIRED TO MAKE A SITE VISIT TO VERIFY EXISTING CONDITIONS PRIOR TO SUBMITTING BIDS.
- THE CONTRACTOR IS REQUIRED TO FOLLOW ALL BUILDING SPECIFIC WORK RESTRICTIONS- SEE SPECIFICATIONS SECTION 01 14 00.
- WHERE DEMOLITION OCCURS, REMOVE AND CAP UTILITIES AT THEIR SOURCE UNLESS NOTED OTHERWISE.
- PLANS ARE DIAGRAMMATIC AND PROVIDED TO SHOW INTENT ONLY. UNLESS NOTED OTHERWISE ALL PARTITION ASSEMBLIES INDICATED TO BE DEMOLISHED SHALL BE DEMOLISHED COMPLETELY, INCLUDING FINISHES GYP. BD., METAL FRAMING, FASTENING DEVICES ETC.
- AREA OF DEMOLITION/REMOVAL IN CORRIDOR, CONTRACTOR SHALL REPAIR FLOORS, WALLS AND FINISHED CEILINGS AS REQUIRED TO MATCH EXISTING AND TO BE FLUSH AND SMOOTH WITH ADJACENT.
- CONTRACTOR TO INSPECT ABOVE CEILING FOR CONTINUITY OF PLENUM ENCLOSURE. NOTIFY ARCHITECT OF ANY EXISTING DEFECTS /GAPS/ OPENINGS PRIOR TO PROCEEDING

**DEMOLITION KEYNOTES:**

- EXISTING COUNTERTOP CABLE PERFORATION AND GROMMET TO REMAIN, SALVAGE
- REMOVE AND FILL EXISTING COUNTERTOP CABLE PERFORATION. REMOVE AND RELOCATE GROMMET, FROM EXISTING HEIGHT DOWN TO 2'-8" HEIGHT. SEE NEW WORK PLAN FOR NEW COUNTERTOP HOLE AND GROMMET LOCATION
- MODIFY EXISTING PLASTIC LAMINATE COUNTERTOP AND BASE CABINET AS REQUIRED PER ADA REQUIREMENTS. REFER TO FLOOR PLAN
- MODIFY EXISTING PLASTIC LAMINATE COUNTERTOP AND WOOD BASE CABINET AS REQUIRED FOR NEW DOCUMENT TRAY DEPRESSED INTO COUNTER
- EXISTING PLASTIC LAMINATE COUNTERTOP AND BELOW SHELVING TO REMAIN
- EXISTING POWER OUTLETS TO BE LOWERED

**LEGEND**

- EXISTING DOOR AND FRAME TO BE DEMOLISHED
- EXISTING WALL TO REMAIN
- EXISTING DOOR AND FRAME TO REMAIN
- EXISTING WALL TO BE REMOVED
- EXISTING TO BE DEMOLISHED
- AREA N.I.C.
- INDICATES KEYNOTE APPLICABLE TO ENTIRE WORK AREA
- ROOM NAME ROOM # ROOM TAG

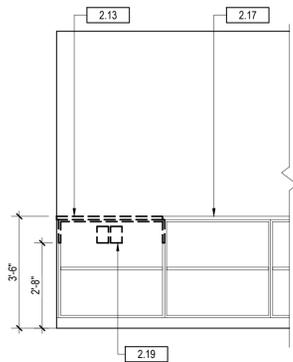

**2ND LEVEL PARTIAL DEMO ELEVATION  
US. DISTRICT COURT CLERK'S OFFICE**

3 SCALE: 3/8"=1'-0" ADA MOD. FROM EMPLOYEE SIDE SCALE: 3/8"=1'-0"

**NEW WORK PLAN GENERAL NOTES**


- CONTRACTOR SHALL VISIT SITE AND BECOME FAMILIAR WITH EXISTING CONDITIONS PRIOR TO COMMENCING WORK. EXISTING CONDITIONS SHOWN ARE FROM INFORMATION PROVIDED BY GOVERNMENT. VERIFY IN FIELD ALL EXISTING CONDITIONS, PRIOR TO PROCEEDING WITH THE WORK.
- CONTRACTOR SHALL NOTIFY ARCHITECT OF ANY AND ALL DISCREPANCIES BETWEEN CONTRACT DOCUMENTS AND EXISTING CONDITIONS PRIOR TO PROCEEDING WITH WORK.
- PATCH AND PREPARE EXISTING WALLS AS NECESSARY TO RECEIVE NEW FINISHES WHERE SCHEDULED.
- ROOM LAYOUTS AND CONFIGURATIONS FOR AREAS OUTSIDE OF CURRENT WORK ARE SHOWN FOR REFERENCE ONLY.

**KEYNOTES:**

- PROVIDE BLOCKING REINFORCEMENT UNDER COUNTERTOP AS REQUIRED TO SUPPORT NEW TEMPERED GLAZING WINDOW AND ALUMINUM FRAME
- EXISTING COUNTERTOP CABLE PERFORATION AND GROMMET
- NEW ADA 36" MAX HEIGHT AT PLASTIC LAMINATE COUNTERTOP
- NEW BREAK RESISTANT TEMPERED GLAZING WINDOW, FROM COUNTERTOP TO CEILING WITH ALUMINUM FRAME AT BOTH ENDS
- NEW SPEAKING PORTAL AT TRANSACTION WINDOW
- NEW DOCUMENT TRAY DEPRESSED INTO PLASTIC LAMINATE COUNTER
- NEW DOCUMENT TRAY DEPRESSED INTO PLASTIC LAMINATE COUNTER, ADA HEIGHT, 36" MAX
- NEW GYPSUM BOARD SOFFIT
- COMPUTER STATION


**LEGEND**

- AREA N.I.C.
- EXISTING WALL TO REMAIN
- NEW WALL
- EXISTING DOOR AND FRAME TO REMAIN
- EXISTING EQUIPMENT
- WINDOW TAG. SEE SCHEDULE, SHEET A900
- PARTITION TYPE TAG. SEE SHEET G002
- DOOR TAG. SEE SCHEDULE, SHEET A900
- ROOM NAME ROOM # ROOM TAG. SEE SCHEDULE, SHEET A901
- NEW DOOR AND FRAME

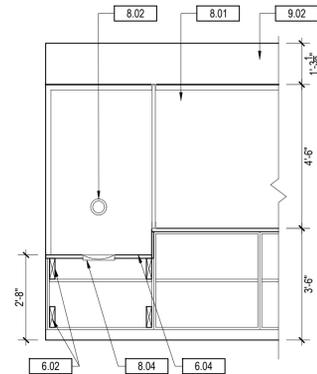


**2ND LEVEL PARTIAL NEW ELEVATION  
US. DISTRICT COURT CLERK'S OFFICE**

4 SCALE: 3/8"=1'-0" ADA MOD. FROM EMPLOYEE SIDE SCALE: 3/8"=1'-0"

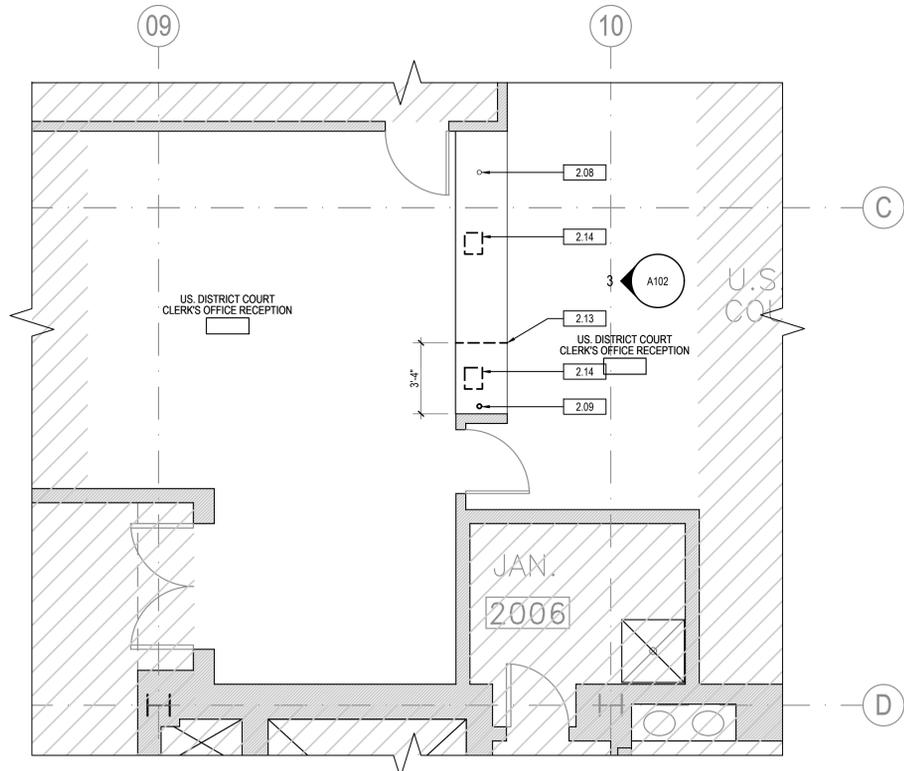


**2ND LEVEL PARTIAL DEMO FLOOR PLAN  
US. DISTRICT COURT CLERK'S OFFICE RECEPTION DESK**

1 SCALE: 1/4"=1'-0" NORTH

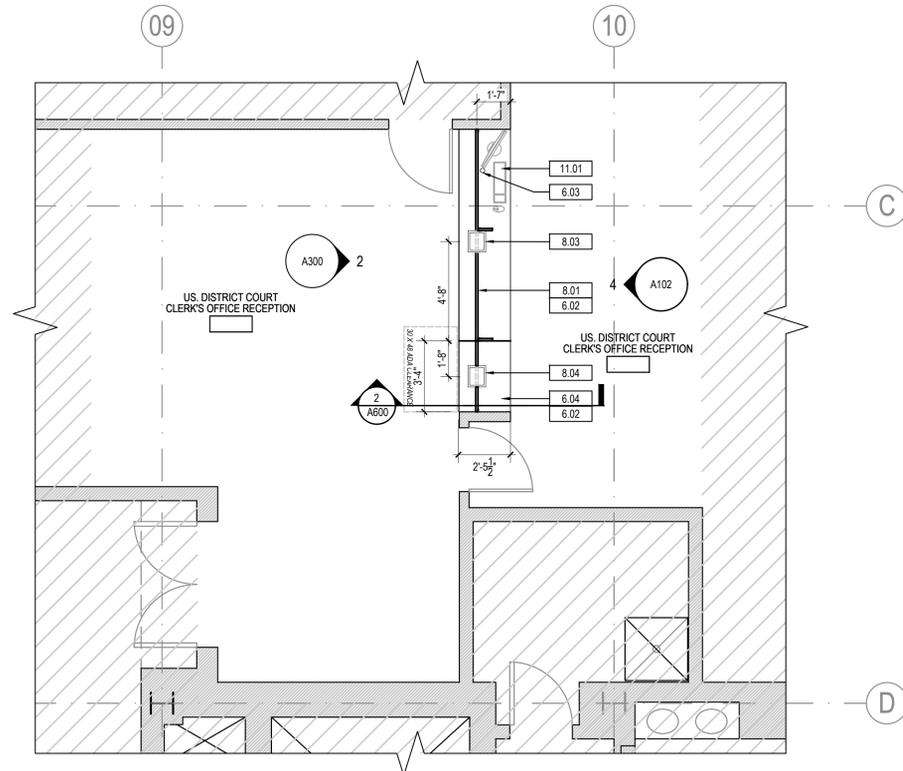

**2ND LEVEL PARTIAL NEW WORK FLOOR PLAN  
US. DISTRICT COURT CLERK'S OFFICE RECEPTION DESK**

2 SCALE: 1/4"=1'-0" NORTH

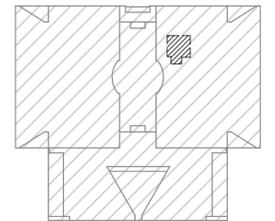

U.S. COURTHOUSE, 5400 FEDERAL PLAZA, HAMMOND, IN 46320-1839

**KEYPLAN**

2ND FLOOR N.T.S.

- AREA N.I.C.
- PROJECT AREA



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MARK	DESCRIPTION	DATE
	100% CD	10.28.2022

GENERAL SERVICES ADMINISTRATION REGION 5 CHICAGO, IL	
NAME	U.S. COURTHOUSE
STREET	5400 FEDERAL PLAZA
CITY/STREET/ZIP	HAMMOND, IN 46320-1839
BUILDING NO.	(IN0300ZZ)
OTHER	
BUILDING NOS.	
PROJECT DESCRIPTION	USDC & USBC TRANSACTION WINDOWS
PROJECT NO.	17005 - 020019 - 00
DRAWING TITLE	DEMO & NEW WORK PLAN
TYPE	ARCHITECTURE
FILE NAME	
FLOOR NO.	1ST FLOOR
DRAWN BY	AM SHEET SIZE: 24 X 36
CHECKED BY	SH DATE: 09.24.20
DRAWING NO.	A102
	SHEET 7 OF 21

**RCP DEMOLITION GENERAL NOTES**

- REMOVE AND LEGALLY DISPOSE OFF SITE THOSE ITEMS INDICATED TO BE REMOVED. REMOVE AND DISPOSE OF DEMOLITION DEBRIS DAILY, AFTER GOVERNMENT OCCUPIED HOURS.
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- CONTRACTOR TO INSPECT ABOVE CEILING FOR CONTINUITY OF PLENUM ENCLOSURE. NOTIFY ARCHITECT OF ANY EXISTING DEFECTS /GAPS/ OPENINGS PRIOR TO PROCEEDING

**DEMOLITION KEYNOTES:**

- EXISTING GYPSUM BOARD SOFFIT TO REMAIN. PREP FOR NEW TEMPERED GLAZING WINDOW, WITH ALUMINUM FRAME. PATCH AND REPAIR SOFFIT AS NEEDED TO MATCH ADJACENT

**RCP LEGEND**

- AREA NOT IN SCOPE OF WORK
- EXISTING WALL TO REMAIN
- EXISTING TO BE DEMOLISHED
- EXISTING 2x2 LIGHT FIXTURE TO BE REMOVED; REF. ELECTRICAL PLANS
- EXISTING MECH. SUPPLY DIFFUSER TO BE REMOVED; REF. MECHANICAL PLANS
- EXISTING MECH. RETURN DIFFUSER TO BE REMOVED; REF. MECHANICAL PLANS
- INDICATES KEYNOTE APPLICABLE FOR ENTIRE AREA
- EXISTING SPRINKLER TO BE REMOVED
- EXISTING FIRE ALARM TO BE REMOVED
- EXISTING OCC SENSOR TO BE REMOVED
- EXISTING 2X2 ACOUSTICAL CEILING TILES AND GRID TO REMAIN
- EXISTING 2X2 ACOUSTICAL CEILING TILES AND GRID TO BE REMOVED
- EXISTING 2X2 LIGHT FIXTURE TO BE REMOVED; REF. ELECTRICAL PLANS
- EXISTING 2X4 LIGHT FIXTURE TO BE REMOVED; REF. ELECTRICAL PLANS
- EXISTING GYP BOARD CEILING TO BE REMOVED

**RCP GENERAL NOTES**


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**KEYNOTES:**

- EXISTING GYPSUM BOARD SOFFIT. PATCH AND REPAIR SOFFIT AS NEEDED TO MATCH ADJACENT


**RCP LEGEND**

- AREA NOT IN SCOPE OF WORK
- EXISTING WALL TO REMAIN
- NEW WALL
- NEW 2x2 LIGHT FIXTURE; REF. ELECTRICAL PLANS
- NEW MECH. SUPPLY DIFFUSER; REF. MECHANICAL PLANS
- NEW MECH. RETURN DIFFUSER; REF. MECHANICAL PLANS
- INDICATES KEYNOTE APPLICABLE FOR ENTIRE AREA
- NEW SPRINKLERS
- NEW FIRE ALARM
- NEW OCC SENSOR
- NEW 2X2 ACOUSTICAL CEILING TILES AND GRID
- NEW 2X4 ACOUSTICAL CEILING TILES AND GRID
- NEW 2X2 SURFACE MOUNTED LIGHT FIXTURE; REF. ELECTRICAL PLANS
- NEW 2X4 SURFACE MOUNTED LIGHT FIXTURE; REF. ELECTRICAL PLANS
- NEW GYP BOARD CEILING

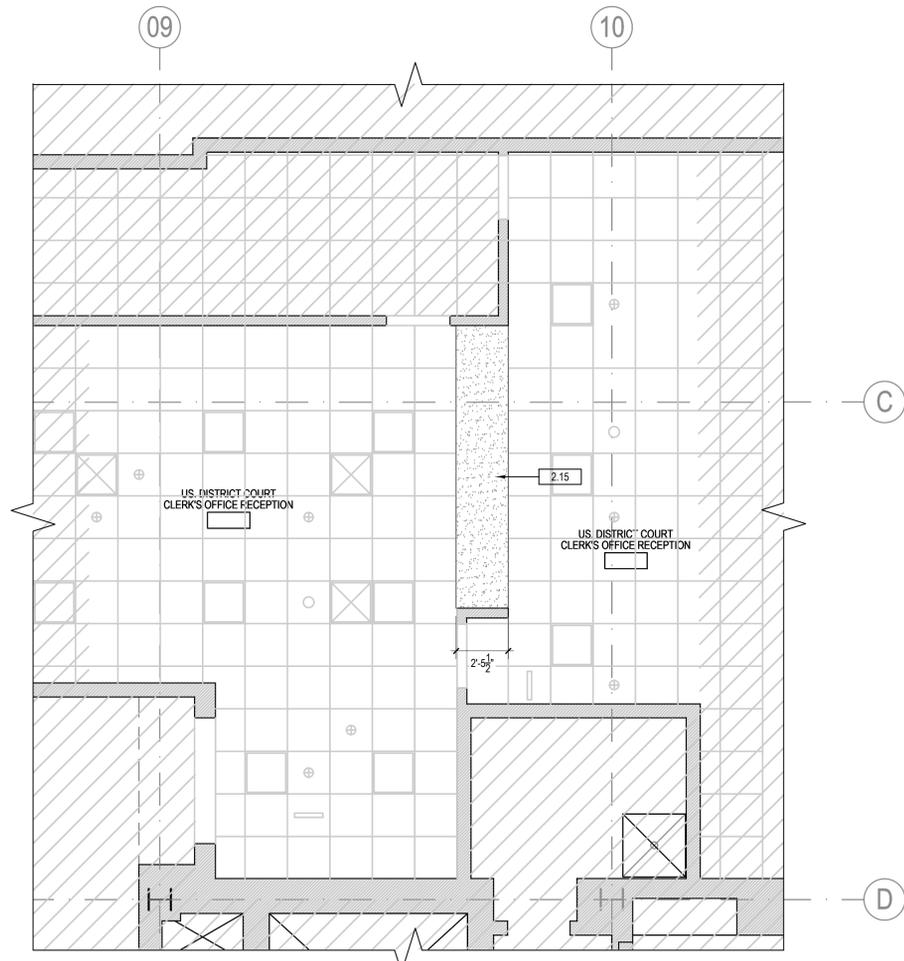


**2ND LEVEL PARTIAL DEMO RCP  
US. DISTRICT COURT CLERK'S OFFICE RECEPTION DESK**

SCALE: 1/4"=1'-0"

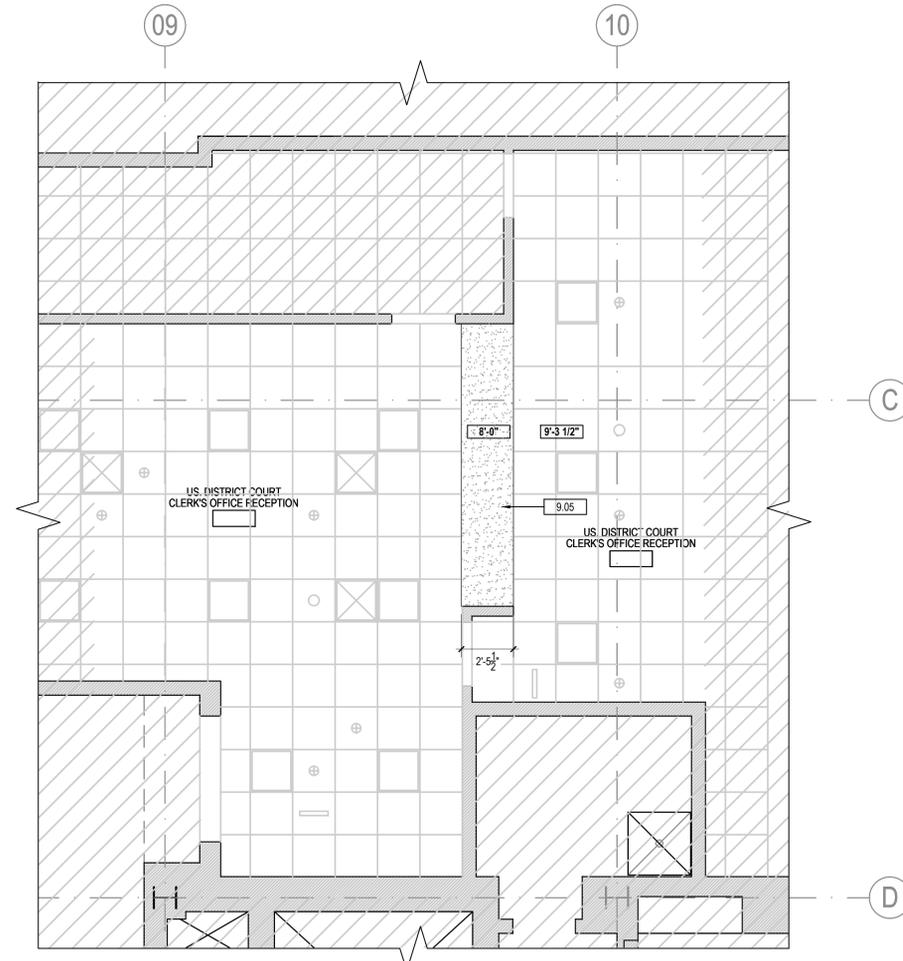


**2ND LEVEL PARTIAL NEW WORK RCP  
US. DISTRICT COURT CLERK'S OFFICE RECEPTION DESK**

SCALE: 1/4"=1'-0"

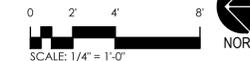

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U.S. COURTHOUSE, 5400 FEDERAL  
PLAZA, HAMMOND, IN 46320-1839

**KEYPLAN**  
2ND FLOOR N.T.S.

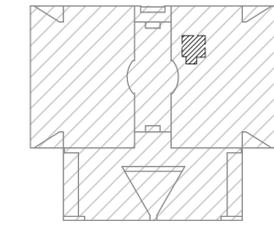- AREA N.I.C.
- PROJECT AREA



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MARK	DESCRIPTION	DATE
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GENERAL SERVICES ADMINISTRATION  
REGION 5 CHICAGO, IL

BUILDING	NAME	U.S. COURTHOUSE
	STREET	5400 FEDERAL PLAZA
CITY/STREET/ZIP	HAMMOND, IN 46320-1839	
BUILDING NO.	(IN0300ZZ)	
OTHER		
BUILDING NOs.		
PROJECT	DESCRIPTION	USDC & USBC TRANSACTION WINDOWS
	PROJECT NO.	17005 - 020019 - 00
DRAWING	TITLE	DEMO & NEW WORK RCP
	TYPE	ARCHITECTURE
FILE NAME		
FLOOR NO.	2ND FLOOR	
DRAWN BY	AM	SHEET SIZE: 24 X 36
CHECKED BY	SH	DATE: 09.24.20
DRAWING NO.	A103	
	SHEET 8	OF 21

**KEYNOTES:**

- 6.04 NEW ADA HEIGHT AT PLASTIC LAMINATE SERVICE COUNTERTOP. 36" MAX HEIGHT AT COUNTERTOP
- 8.01 NEW BREAK RESISTANT TEMPERED GLAZING WINDOW, FROM COUNTERTOP TO CEILING WITH ALUMINUM FRAME AT BOTH ENDS
- 8.02 NEW SPEAKING PORTAL AT TRANSACTION WINDOW
- 8.03 NEW DOCUMENT TRAY DEPRESSED INTO PLASTIC LAMINATE COUNTER
- 8.04 NEW DOCUMENT TRAY DEPRESSED INTO PLASTIC LAMINATE COUNTER, ADA HEIGHT, 36" MAX
- 9.02 NEW GYPSUM BOARD SOFFIT
- 9.05 EXISTING GYPSUM BOARD SOFFIT. PATCH AND REPAIR SOFFIT AS NEEDED TO MATCH ADJACENT
- 9.13 NEW VINYL DECAL FOR U.S. DISTRICT COURT CLERK'S OFFICES. GRAPHIC, SIZE AND LOCATION TO BE COORDINATED WITH GSA
- 11.01 COMPUTER STATION

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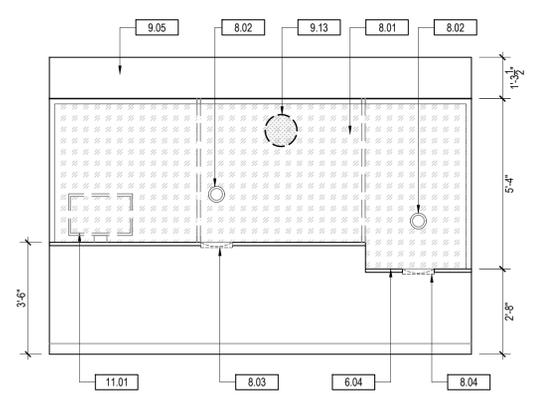
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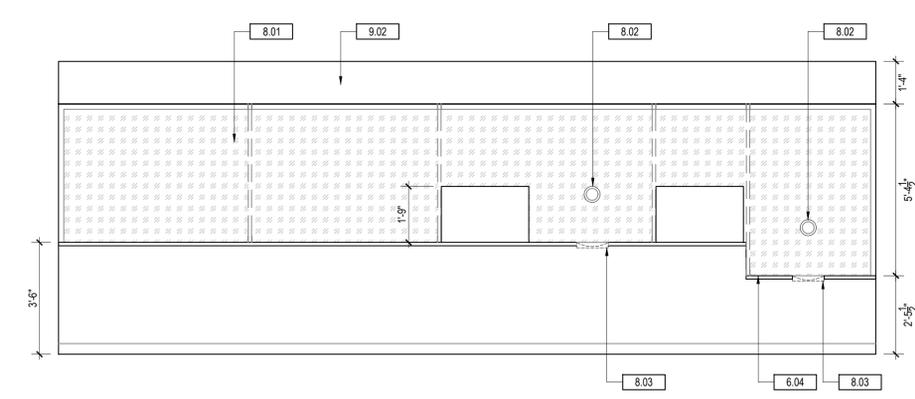
MARK	DESCRIPTION	DATE
	100% CD	10.28.2022

GENERAL SERVICES ADMINISTRATION  
REGION 5 CHICAGO, IL


BUILDING	NAME	U.S. COURTHOUSE,		
	STREET	5400 FEDERAL PLAZA,		
	CITY/STREET/ZIP	HAMMOND, IN 46320-1839		
	BUILDING NO.	(IN0300ZZ)		
PROJECT	OTHER			
	BUILDING NOS.			
	PROJECT DESCRIPTION	USDC & USBC TRANSACTION WINDOWS		
DRAWING	PROJECT NO.	17005 - 020019 - 00		
	DRAWING TITLE	INTERIOR ELEVATIONS		
DRAWING	TYPE	ARCHITECTURE		
	FILE NAME			
	FLOOR NO.			
	DRAWN BY	AM	SHEET SIZE: 24 X 36	
	CHECKED BY	SH	DATE: 09.24.20	
	DRAWING NO.	A300		
		SHEET	9 OF 21	



**2** 2ND LEVEL US. DISTRICT COURT  
CLERK'S OFFICE RECEPTION DESK INTERIOR ELEVATION  
SCALE: 3/8"=1'-0"



**1** 2ND LEVEL US. BANKRUPTCY  
CLERK'S OFFICE RECEPTION DESK INTERIOR ELEVATION  
SCALE: 3/8"=1'-0"

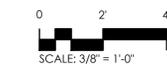



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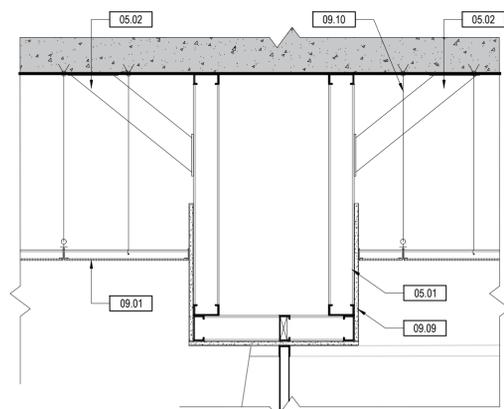
MARK	DESCRIPTION	DATE
	100% CD	10.28.2022

GENERAL SERVICES ADMINISTRATION  
REGION 5 CHICAGO, IL

BUILDING	NAME	U.S. COURTHOUSE	
	STREET	5400 FEDERAL PLAZA	
	CITY/STREET/ZIP	HAMMOND, IN 46320-1839	
BUILDING NO.	OTHER		
	BUILDING NOS.		
PROJECT DESCRIPTION	PROJECT	USDC & USBC TRANSACTION WINDOWS	
	PROJECT NO.	17005 - 020019 - 00	
DRAWING TITLE	DRAWING TITLE	SECTIONS AND DETAILS	
	TYPE	ARCHITECTURE	
DRAWN BY	FILE NAME		
	FLOOR NO.		
CHECKED BY	DRAWN BY	AM	SHEET SIZE: 24 X 36
	CHECKED BY	SH	DATE: 09.24.20
DRAWING NO.	DRAWING NO.	A600	
	SHEET	10	OF 21


KEYNOTES:

- 5.01 5/8" GWB ON 3 5/8" MTL STUDS @ 16" OC MAX
- 5.02 KICKER BRACING AS REQUIRED AT BOTH SIDES
- 6.02 PROVIDE BLOCKING REINFORCEMENT UNDER COUNTERTOP AS REQUIRED TO SUPPORT NEW TEMPERED GLAZING WINDOW AND ALUMINUM FRAME
- 6.04 NEW PLASTIC LAMINATE COUNTERTOP AT ADA 36" MAX HEIGHT
- 6.06 NEW VENEER CORE PLYWOOD PIECE AT SIDE OF ADA COUNTERTOP HEIGHT CHANGE. FINISH TO MATCH ADJACENT CASEWORK
- 8.01 NEW BREAK RESISTANT TEMPERED GLAZING WINDOW, FROM COUNTERTOP TO CEILING WITH ALUMINUM FRAME AT BOTH ENDS
- 8.02 NEW SPEAKING PORTAL AT TRANSACTION WINDOW
- 8.04 NEW DOCUMENT TRAY DEPRESSED INTO PLASTIC LAMINATE COUNTER, ADA HEIGHT, 36" MAX
- 9.01 INSTALL NEW ACT CEILING TILES AS REQUIRED. REINSTALL SALVAGED ACT AS REQUIRED UPON MECHANICAL SCOPE COMPLETION
- 9.02 NEW GYPSUM BOARD SOFFIT
- 9.09 5/8" GYPSUM BOARD
- 9.10 SUSPENSION CABLE
- 9.12 PLASTIC LAMINATE CLAD ON EDGE FINISH OF COUNTERTOP. MATCH COUNTERTOP COLOR




TYP. NEW SOFFIT & ACT CONNECTION WITH ABOVE SLAB DETAIL

SCALE: 1"=1'-0"

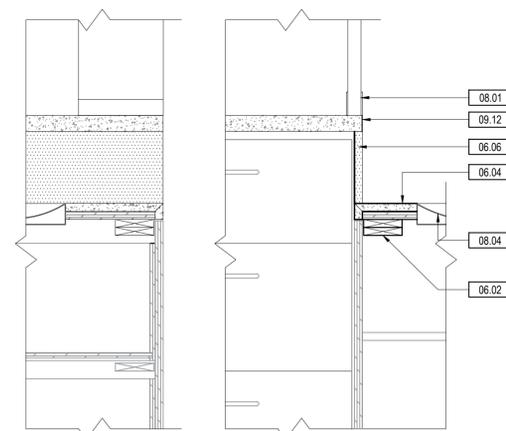


TYP. SIDE PANEL AT ADA HEIGHT CHANGE SECTION OF COUNTER DETAIL

SCALE: 1"=1'-0"

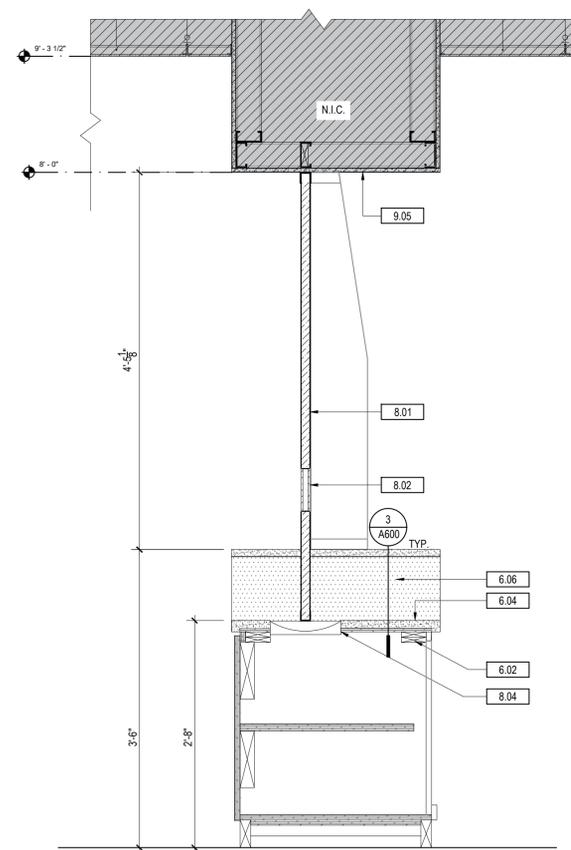

2ND LEVEL PARTIAL SECTION US. D.C. OFFICE RECEPTION DESK

SCALE: 1"=1'-0"

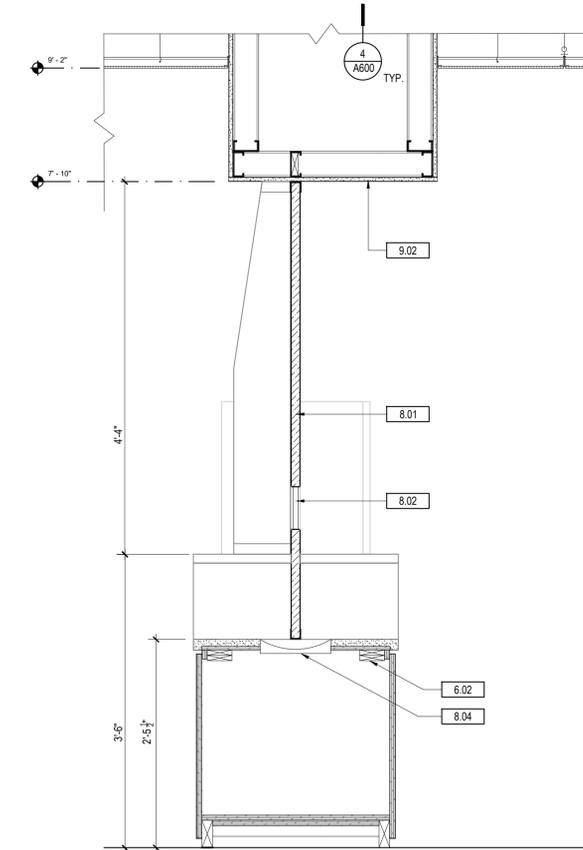

2ND LEVEL PARTIAL SECTION US. B.C. OFFICE RECEPTION DESK

SCALE: 1"=1'-0"



4

3

2

1


SCOPE OF WORK  
NONE

KEYNOTES

02.01 SPRINKLER HEADS TO REMAIN.

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U.S. COURTHOUSE, 5400 FEDERAL  
PLAZA, HAMMOND, IN 46320-1839

KEYPLAN  
2ND FLOOR N.T.S.  
NORTH

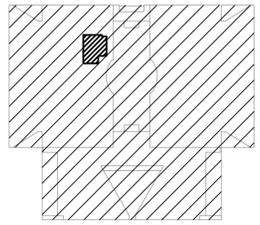

*Key W. Locke*  
signature

10/28/2022  
date

license expires on 07-31-2023




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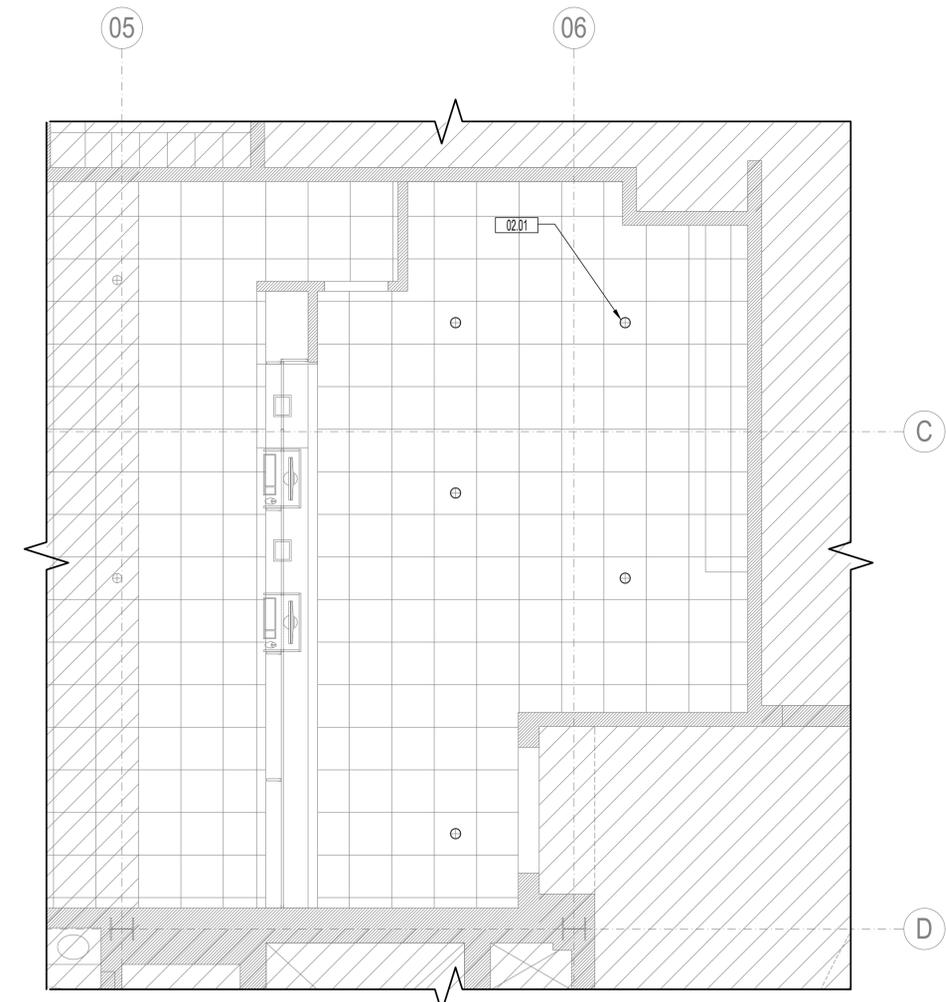
MARK	DESCRIPTION	DATE
	100% CD	10.28.22

GENERAL SERVICE ADMINISTRATION  
REGION 5 CHICAGO, IL

BUILDING	NAME	U.S. COURTHOUSE,
	STREET	5400 FEDERAL PLAZA, HAMMOND, IN
	CITY/STREET/ZIP	46320-1839
BUILDING NO.		(IN0300ZZ)
	OTHER	
PROJECT	PROJECT	USDC & USBC TRANSACTION WINDOWS
	DESCRIPTION	
DRAWING TITLE	PROJECT NO.	17005 - 020019 - 00
	TYPE	FIRE PROTECTION
DRAWING	FILE NAME	FP110
	FLOOR NO.	
DRAWING	DRAWN BY	JPB SHEET SIZE: 24 X 36
	CHECKED BY	KWL DATE: 10.28.22
DRAWING NO.		FP110
	SHEET	11 OF 21



2ND LEVEL PARTIAL DEMO FIRE PROTECTION PLAN  
US. BANKRUPTCY CLERK'S OFFICE RECEPTION DESK  
SCALE: 1/4"=1'-0" NORTH

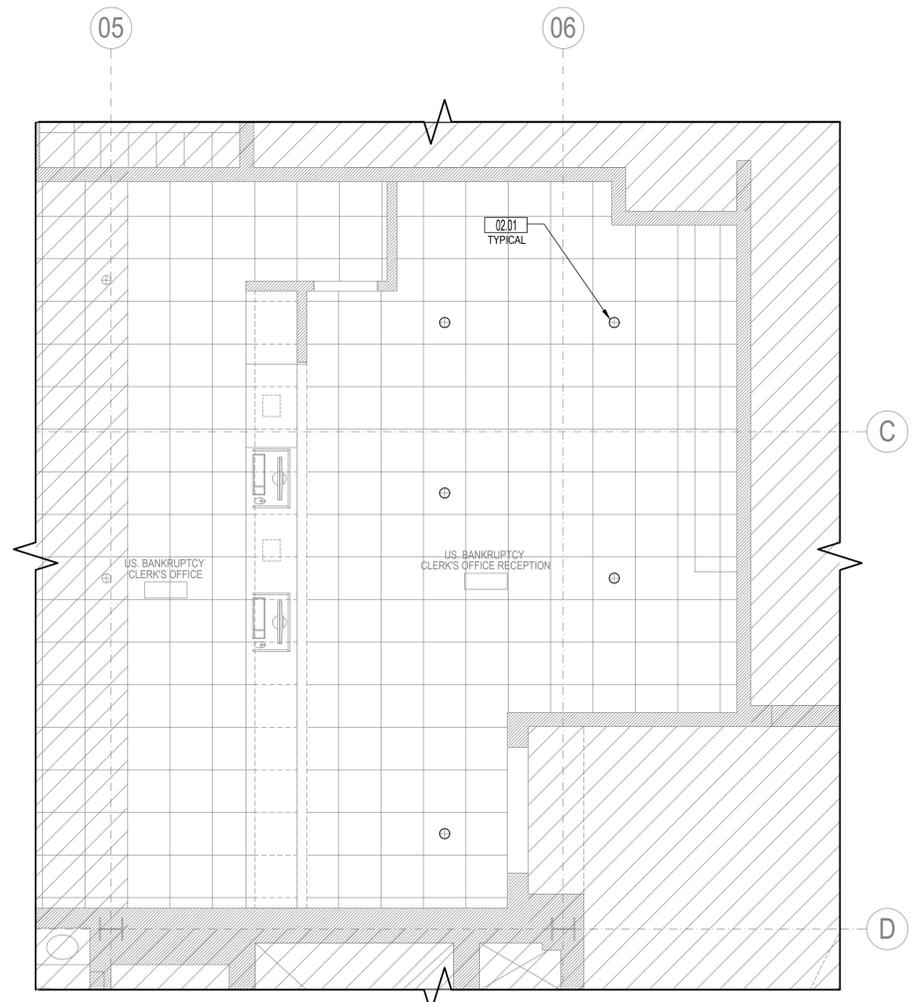

2ND LEVEL PARTIAL NEW WORK FIRE PROTECTION PLAN  
US. BANKRUPTCY CLERK'S OFFICE RECEPTION DESK  
SCALE: 1/4"=1'-0" NORTH


SCOPE OF WORK  
NONE

KEYNOTES

02.01 EXISTING SPRINKLER HEAD TO REMAIN.

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U.S. COURTHOUSE, 5400 FEDERAL  
PLAZA, HAMMOND, IN 46320-1839

KEYPLAN  
2ND FLOOR N.T.S.  
NORTH

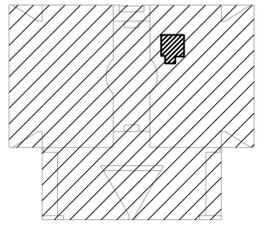

*Key W. Locke, Jr.*  
signature

10/28/2022  
date

license expires on 07-31-2023




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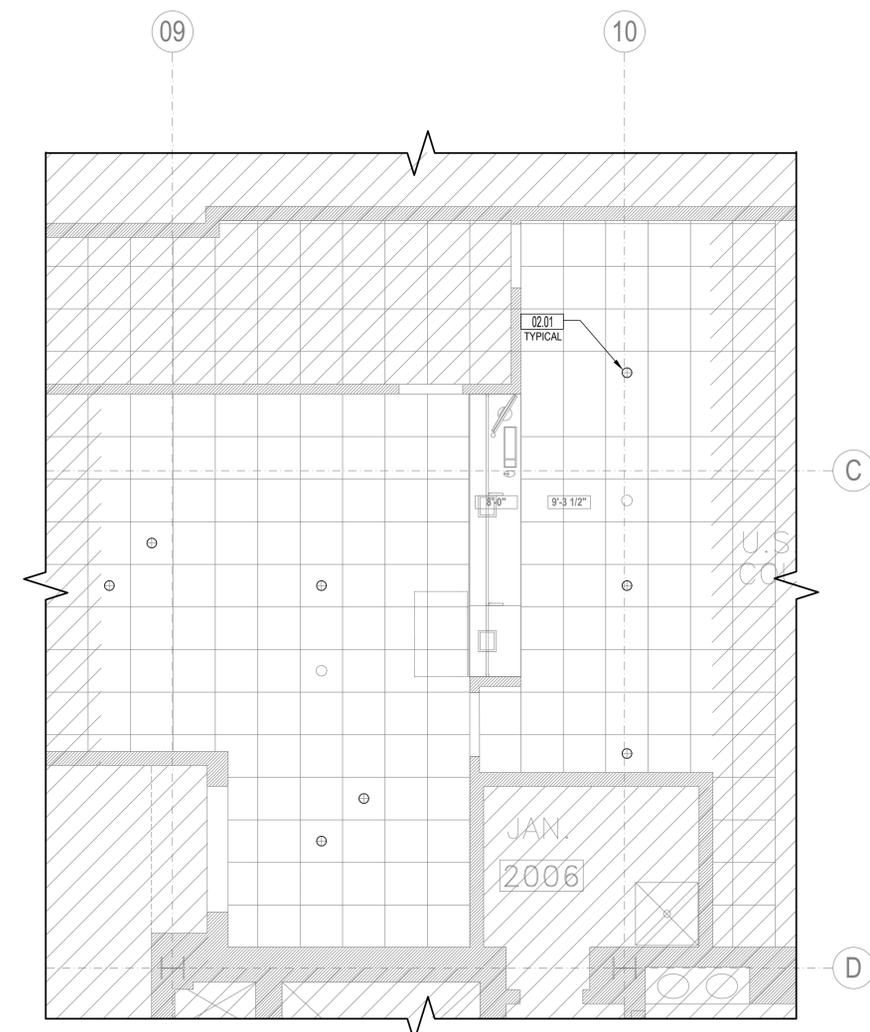
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	100% CD	10.28.22

GENERAL SERVICE ADMINISTRATION  
REGION 5 CHICAGO, IL

BUILDING	NAME	U.S. COURTHOUSE, 5400 FEDERAL PLAZA, HAMMOND, IN 46320-1839	
	CITY/STREET/ZIP		
	BUILDING NO.	(IN0300ZZ)	
	OTHER BUILDING NOS.		
PROJECT DESCRIPTION	PROJECT	USDC & USBC TRANSACTION WINDOWS	
	PROJECT NO.	17005 - 020019 - 00	
DRAWING TITLE	TYPE	FIRE PROTECTION	
	FILE NAME	M111	
DRAWING	FLOOR NO.		
	DRAWN BY	JPB	SHEET SIZE: 24 X 36
	CHECKED BY	KWL	DATE: 10.28.22
DRAWING NO.	<b>FP111</b>		
	SHEET	12	OF 21



1 2ND LEVEL PARTIAL DEMO RCP  
US. DISTRICT COURT CLERK'S OFFICE RECEPTION DESK  
SCALE: 1/4"=1'-0"  
0 2' 4' 8'  
SCALE: 1/4"=1'-0" NORTH

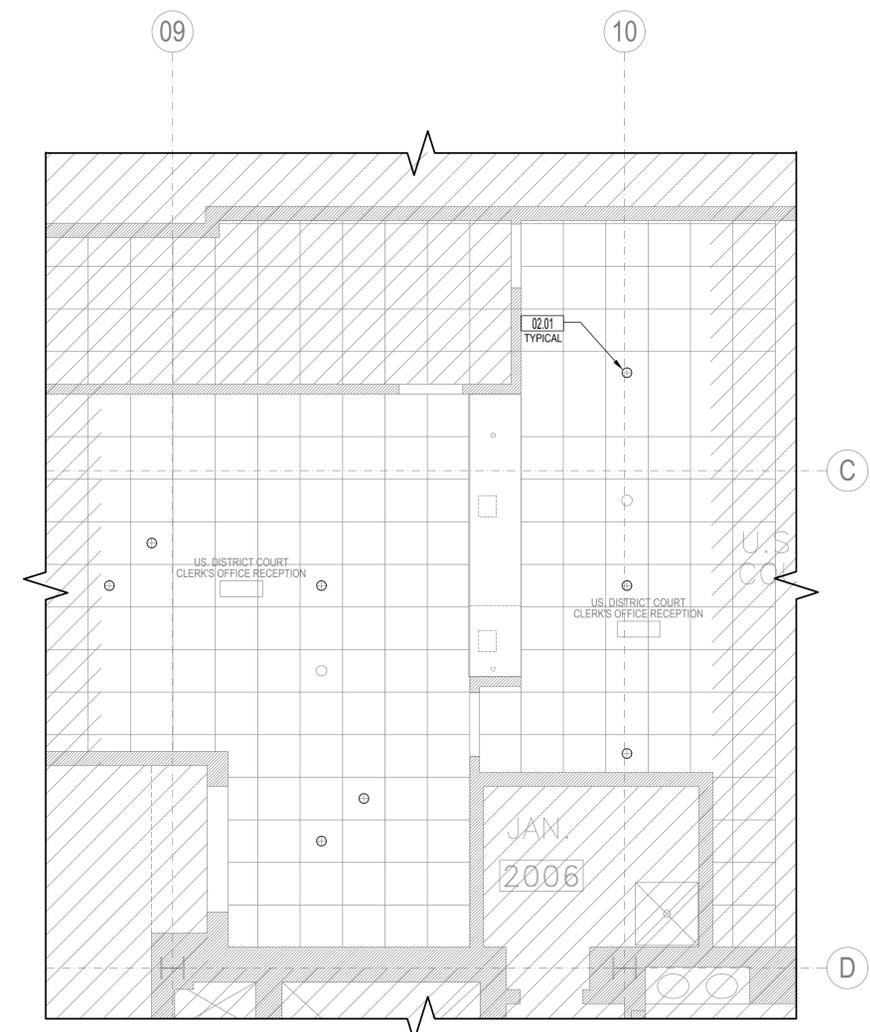


1 2ND LEVEL PARTIAL NEW WORK RCP  
US. DISTRICT COURT CLERK'S OFFICE RECEPTION DESK  
SCALE: 1/4"=1'-0"  
0 2' 4' 8'  
SCALE: 1/4"=1'-0" NORTH


AD	ACCESS DOOR	MBH	THOUSANDS BRITISH THERMAL UNITS PER HOUR
AH	AIR HANDLING SYSTEM	MAN.	MANUAL
AMP	AMPERE	MAX.	MAXIMUM
BOD	BOTTOM OF DUCT	MIN.	MINIMUM
BTU	BRITISH THERMAL UNIT	NC	NOISE CRITERIA
BTUH	BRITISH THERMAL UNITS PER HOUR	N.C.	NORMALLY CLOSED
CC	COOLING COIL	NIC	NOT IN CONTRACT
CCP	CENTRAL CONTROL PANEL	NK	NECK
CFM	CUBIC FEET PER MINUTE	NO	NUMBER
CL	CENTER LINE	N.O.	NORMALLY OPEN
CLG	CEILING	NTS	NOT TO SCALE
CONC	CONCRETE	OA	OUTSIDE AIR
COT	COMPRESSION TANK	OAI	OUTSIDE AIR INTAKE
CR	CEILING REGISTER	1 PH	SINGLE PHASE
DB	DECIBEL	3 PH	THREE PHASE
DBT	DRY BULB TEMPERATURE	PRESS	PRESSURE
DFL	DEFLECTION	PSIA	POUNDS PER SQUARE INCH ABSOLUTE
DIA	DIAMETER	PSIG	POUNDS PER SQUARE INCH GAUGE
DIFF	DIFFUSER	RA	RETURN AIR
DWG	DRAWING	REG	REGISTER
E	EXHAUST FAN	REQD	REQUIRED
EAT	ENTERING AIR TEMPERATURE	RET	RETURN
EFF	EFFICIENCY	RH	RELATIVE HUMIDITY
EL	ELEVATION	RPM	REVOLUTIONS PER MINUTE
ETR	EXISTING TO REMAIN	RO	ROOF OPENING
EWT	ENTERING WATER TEMPERATURE	RM	ROOM
EXH	EXHAUST	SA	SUPPLY AIR
°F	DEGREES FAHRENHEIT	SCRD	SCREWED
FC	FAN COIL UNIT	SP	STATIC PRESSURE
FL	FLOOR	SPD	SPLITTER DAMPER
FLEX	FLEXIBLE	SPEC	SPECIFICATION
FPM	FEET PER MINUTE	STD	STANDARD
FT	FOOT	TIA	TRANSFER AIR
GA	GAGE OR GAUGE	TSP	TOTAL STATIC PRESSURE
GPM	GALLONS PER MINUTE	TYP	TYPICAL
GR	GRILLE	UH	UNIT HEATER
HZ	HERTZ	VA	VALVE
HC	HEATING COIL	VAV	VARIABLE AIR VOLUME
HP	HORSEPOWER	VD	VOLUME DAMPER
HTG	HEATING	VEL	VELOCITY
ID	INSIDE DIAMETER	VPT	VELOCITY PRESSURE TRANS
IN	INCH	W	WATT
INSUL	INSULATION	WI	WITH
KW	KILOWATT	WB	WET BULB TEMPERATURE
KWH	KILOWATT HOUR	WC	WATER COLUMN
LAT	LEAVING AIR TEMPERATURE	WH	WATER HEATER
LD	LINED DUCT	WMS	WIRE MESH SCREEN
LWT	LEAVING WATER TEMPERATURE	Z	ZONE
MAT	MIXED AIR TEMPERATURE		



### SYMBOLS + ABBREVIATIONS

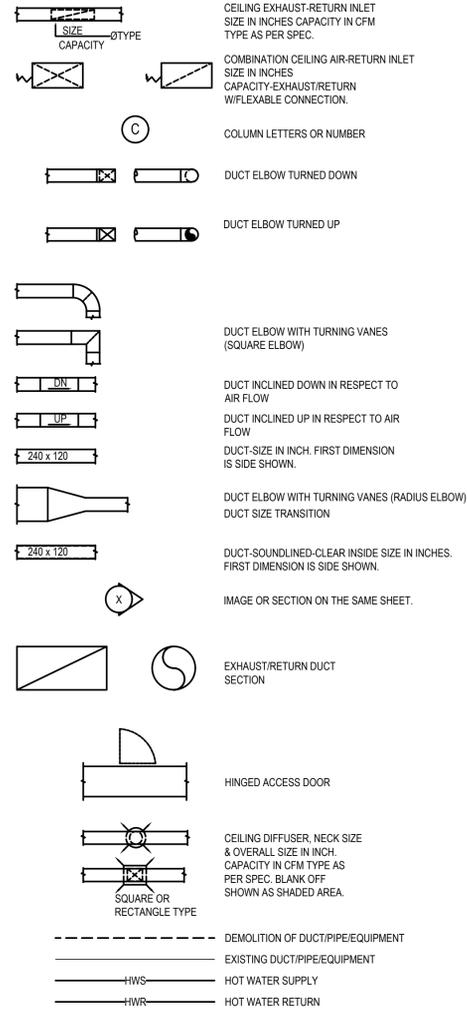

### HVAC CONTROL SYMBOLS

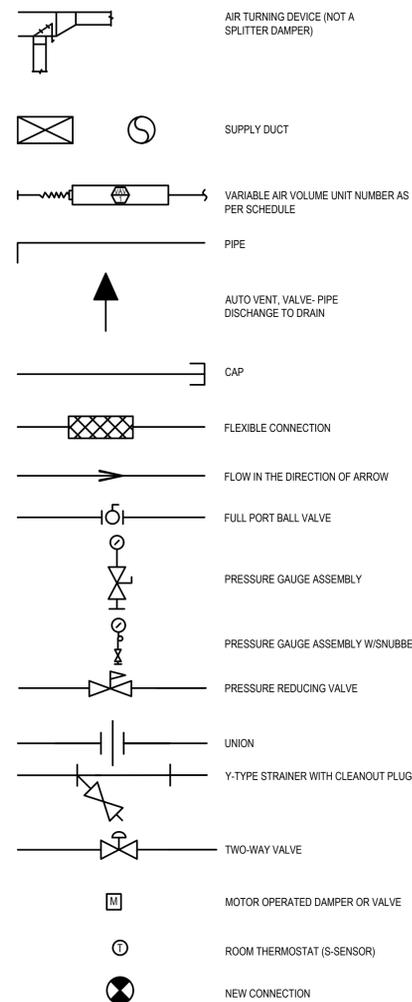

### PRE-ALTERATION TESTING NOTES

THE CONTRACTOR SHALL PERFORM TESTING AND INVESTIGATION OF THE EXISTING SYSTEMS DESCRIBED WITHIN THE DOCUMENTS. SCHEDULE AND PERFORM TESTING OF SYSTEMS SUCH THAT TESTING HAS BEEN SATISFACTORILY EXECUTED PRIOR TO THE SHEET OF DEMOLITION. PROVIDE ALL NECESSARY PORTS FOR DUCTS, PIPES, ETC.

- PERFORM TESTING EFFORT ON AIRFLOW DISTRIBUTION SYSTEM. PERFORM TESTING TO DETERMINE FLOW AT DIFFUSERS, GRILLES.
  - A. VAV BOXES:
    - AIR FLOW AT BAS
    - TOTAL AIRFLOW AIR OUTLETS

### GENERAL NOTES:

- ALL DUCT SIZES NOTED ON DRAWINGS REFER TO ACTUAL AIRWAY SIZES (SOUND LINING AND/OR INSULATION IS NOT INCLUDED).
- ALL DUCT COVERINGS AND LININGS SHALL HAVE A FLAME SPREAD RATINGS NOT TO EXCEED 25 AND A SMOKE DEVELOPMENT RATING NOT MORE THAN 50.
- COORDINATE ALL FINAL LOCATIONS OF SUPPLY AIR DIFFUSERS, RELIEF AIR GRILLES, THERMOSTATS, SENSORS, ETC. WITH ARCHITECT AND ARCHITECTURAL REFLECTED CEILING PLANS.
- MECHANICAL CONTRACTOR TO COORDINATE WITH ALL OTHER TRADES INVOLVED, ALL WORK WHICH IS IN THE CEILING SPACE AS INDICATED ON THE DRAWINGS WITHOUT CONFLICT AND TO REVISE HIS WORK TO AVOID CONFLICTS AND OBSTRUCTIONS AS NECESSARY AND AS REQUIRED.
- ALL DUCTS PENETRATING FULL HEIGHT WALLS ABOVE CEILING SHALL BE SEALED TO WITHIN 1/8" OF DUCT WITH WALL MATERIAL ON EACH SIDE OF WALL.
- COORDINATE EXACT LOCATIONS OF TEMPERATURE SENSORS FOR HVAC EQUIPMENT WITH FINAL INTERIOR DESIGN/ARCHITECTURAL DRAWINGS.
- ALL ROOM THERMOSTATS SHALL HAVE CENTERS ALIGNED WITH LIGHT SWITCHES.
- DUCT CONSTRUCTION AND INSTALLATION SHALL COMPLY WITH LATEST SMACNA STANDARDS. DUCTS SHALL BE CONSTRUCTED OF GALVANIZED SHEET STEEL.
- PROVIDE 1" THICK FLEXIBLE ELASTOMERIC SOUND LINING FOR Z DUCT TRANSFER DUCTS. FIBERGLASS LINER IS NOT ALLOWED PER GSA P100. PROVIDE 1" THICK FIBERGLASS WRAP FOR ALL SUPPLY DUCTWORK.
- ALL CONSTRUCTION DOCUMENTS, INSTALLATION MANUALS, MANUFACTURERS CATALOG CUTSHEETS ARE TO BE SUBMITTED TO THE GSA AND LANDLORD. ALL MATERIALS AND EQUIPMENT ARE TO BE LISTED AND LABELED AND SUITABLE FOR USE.
- EXISTING HVAC SYSTEMS SHALL BE REBALANCED FOR NEW CAPACITIES ACCORDING TO HVAC PLANS AND SCHEDULES
- LOCATIONS OF EXISTING DUCT WORK, PIPING, THERMOSTATS, DIFFUSERS, ETC. SHOWN ON THIS DRAWING ARE BASED ON PREVIOUS DESIGN WORKING DRAWINGS AND DO NOT NECESSARILY INDICATE THE ACTUAL LOCATIONS. REVISE NEW DUCTWORK, PIPING, ETC., AS REQUIRED TO CONNECT TO EXISTING WORK. CONTRACTOR TO VERIFY TO VERIFY AND COVER NECESSARY WORK IN BID.
- FIRE CAULK ALL DUCT SYSTEMS WHICH PENETRATE THROUGH FIRE RESISTANCE RATED WALLS, PARTITIONS, FLOORS, OR CEILINGS TO MAINTAIN 1 HOUR RATING.
- HVAC SYSTEMS SHALL BE BALANCED ACCORDING TO HVAC PLANS AND SCHEDULES. SUBMIT WRITTEN REPORT TO GSA. BALANCING CONTRACTOR TO DETERMINE STATIC PRESSURE SETPOINT OF EXISTING DUCT SYSTEM. INDICATE SPEED OF FAN DURING SYSTEM BALANCE. PRETEST EXISTING DIFFUSERS CONNECTED TO RELOCATED VAV BOX.
- INSTALL ALL EQUIPMENT AND ASSOCIATED MATERIALS AND ACCESSORIES PER MANUFACTURER'S INSTALLATION INSTRUCTIONS.
- COORDINATE LOCATION OF NEW VAV BOX PENETRATION WITH EXISTING WALL CONSTRUCTION. PROVIDE LINTELS AT BLOCK WALLS. PROVIDE OFFSETS TO AVOID EXISTING TRADES, WALL STRUCTURE, AND BUILDING STRUCTURE.
- EXTEND EXISTING SCHNEIDER ELECTRIC DDC SYSTEM TO ACCOMMODATE CONNECTION OF NEW EQUIPMENT. GRAPHICS AND SEQUENCE FOR NEW EQUIPMENT TO MATCH EXISTING. COORDINATE WITH PROPERTY MANAGEMENT.
- THE CONTRACTOR SHALL BE FAMILIAR WITH GSA SECURITY CLEARANCE AND OBTAINING SAID CLEARANCE. COSTS TO OBTAIN CLEARANCES FOR PERSONNEL WORKING ON SITE ARE THE RESPONSIBILITY OF THE CONTRACTOR.

### SCOPE OF WORK

- THE CONTRACTOR SHALL PROVIDE COMPLETE AND OPERATING SYSTEMS THAT COMPLY WITH P100 AND THE INTERNATIONAL BUILDING CODE.
- SUBMIT QUALIFICATION DATA, SAMPLE TEST AND BALANCE FORMS, TESTING PLAN, AND SAMPLES.
- OBTAIN SECURITY CLEARANCES REQUIRED TO EXECUTE WORK. END USER HAS STRINGENT, SPECIFIC SECURITY REQUIREMENTS, IN ORDER TO EXECUTE CONTROLS THE CONTRACTOR REQUIRES ENT CLEARANCE. COORDINATE WITH GSA IT STAKEHOLDER.
- PERFORM PRE-ALTERATION TESTING OF AIR HANDLING UNIT AND VAV EQUIPMENT. SUBMIT REPORT.
- SCHEDULE EFFORTS IN AREAS OUTSIDE OF THE BUILDOUT AREA WITH PROPERTY MANAGEMENT. EFFORTS SHALL BE PERFORMED OFF HOURS. THE CONTRACTOR SHALL CLEAN THE SPACE AND LEAVE THE EQUIPMENT IN WORKING ORDER AT THE START IF NORMAL BUSINESS HOURS.
- EXECUTE DEMOLITION EFFORTS. RECYCLE SHEET METAL.
- PROVIDE COORDINATION DRAWINGS THAT ARE COORDINATED WITH OTHER TRADES, EXISTING CONDITIONS AND EQUIPMENT CLEARANCES. SUBMIT FOR APPROVAL. INCLUDE ALL-TRADES SIGN OFF.
- PROVIDE PRODUCT DATA SUBMITTALS FOR REVIEW AND COMMENT. NOTE THAT PRODUCT DATA IS NOT A COORDINATED SHOP DRAWING.
- PROVIDE SHEET METAL DUCTS, DUCT INSULATION, CONTROLS, SUPPORTS AND TESTING TO COMPLETE INSTALLATION.
- PROVIDE MODIFICATIONS TO THE BUILDING AUTOMATION SYSTEM TO ACCOMMODATE NEW THERMOSTAT LOCATIONS.
- PERFORM TESTING AND BALANCING OF EQUIPMENT AND CONTROLS. SYSTEMS SHALL INTEGRATE WITH BAS AND PERFORM AS SPECIFIED.
- PROVIDE OPERATIONS AND MAINTENANCE MANUAL. INCLUDE AS-BUILDS, TESTING, WARRANTY, CONTROLS, AND TRAINING. SUBMIT GSA SIGN OFF THAT EQUIPMENT IS VISIBLE FROM FRONT END

**signature**  
*Kurt W. Locke*  
10/28/2022  
date  
license expires on 07-31-2023

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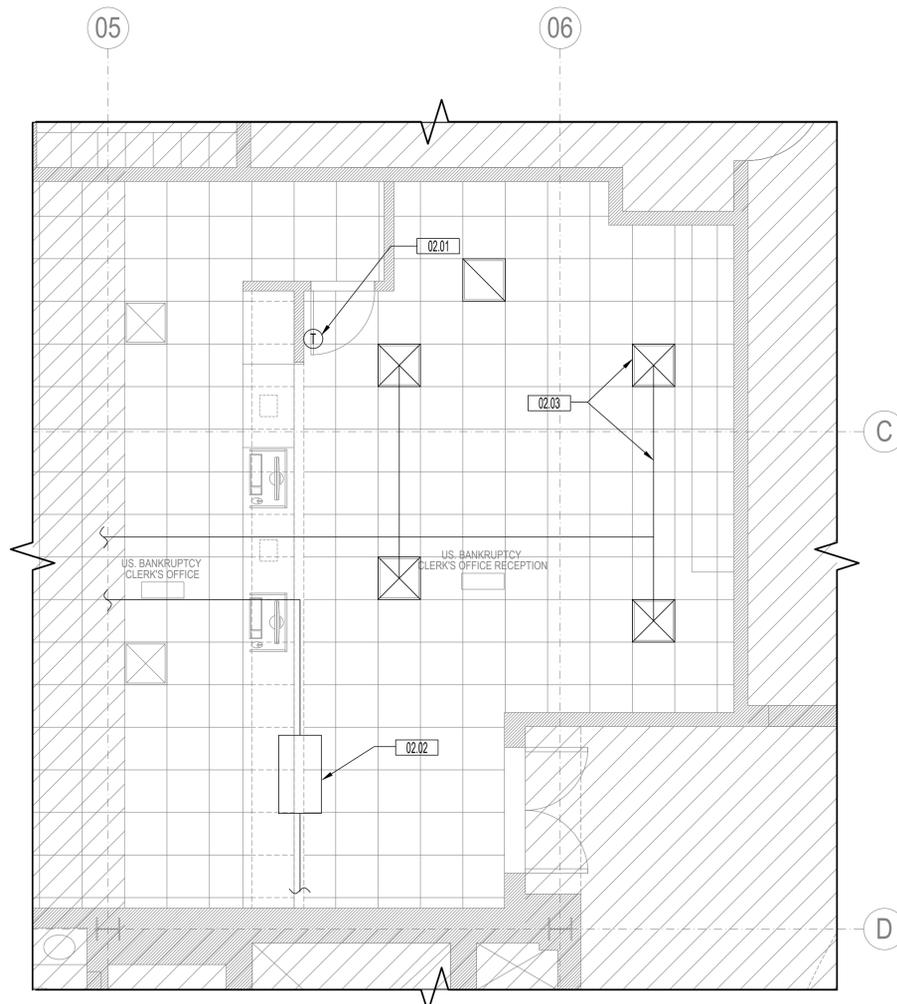
GENERAL SERVICE ADMINISTRATION REGION 5 CHICAGO, IL	
BUILDING NAME	U.S. COURTHOUSE,
BUILDING STREET	5400 FEDERAL PLAZA, HAMMOND, IN
BUILDING CITY/STREET/ZIP	46320-1839
BUILDING NO.	(IN0300ZZ)
OTHER BUILDING NOs.	
PROJECT DESCRIPTION	USDC & USBC TRANSACTION WINDOWS
PROJECT NO.	17005 - 020019 - 00
DRAWING TITLE	MECHANICAL STANDARDS
TYPE	
FILE NAME	M000
FLOOR NO.	
DRAWN BY	JPB SHEET SIZE: 24 X 36
CHECKED BY	KWL DATE: 10.28.22
DRAWING NO.	M000
SHEET	13 OF 21

**SCOPE OF WORK**

- DETERMINE IF VAV BOX NEEDS TO BE RELOCATED DUE TO WALL SUPPORT.


**KEYNOTES**

- 02.01 THERMOSTAT WITH PLASTIC COVER TO REMAIN.
- 02.02 VAV BOX TO REMAIN.
- 02.03 DUCTWORK AND DIFFUSERS TO REMAIN.





**2ND LEVEL PARTIAL DEMO MECHANICAL PLAN  
US. BANKRUPTCY CLERK'S OFFICE RECEPTION DESK**

SCALE: 1/4"=1'-0"

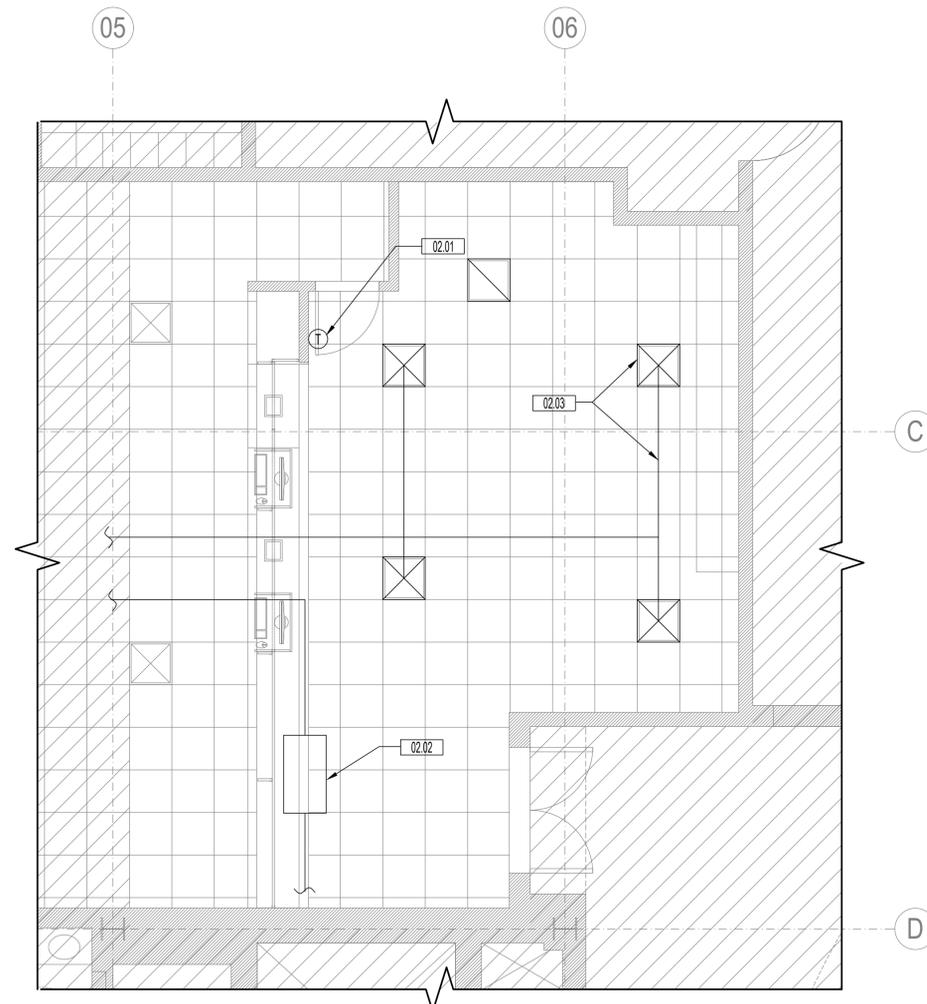

**2ND LEVEL PARTIAL NEW WORK MECHANICAL PLAN  
US. BANKRUPTCY CLERK'S OFFICE RECEPTION DESK**

SCALE: 1/4"=1'-0"

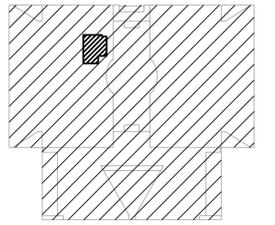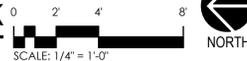

U.S. COURTHOUSE, 5400 FEDERAL  
PLAZA, HAMMOND, IN 46320-1839

**KEYPLAN**  
2ND FLOOR N.T.S.  
NORTH



*Kelly W. Locke*  
signature

10/28/2022  
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**GENERAL SERVICE ADMINISTRATION  
REGION 5 CHICAGO, IL**


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	STREET	5400 FEDERAL PLAZA, HAMMOND, IN	
BUILDING NO.	CITY/STREET/ZIP	46320-1839	
	OTHER	(IN0300ZZ)	
PROJECT DESCRIPTION	PROJECT	USDC & USBC TRANSACTION WINDOWS	
	PROJECT NO.	17005 - 020019 - 00	
DRAWING TITLE	TYPE	MECHANICAL PLANS	
	FILE NAME	MECHANICAL	
DRAWING	FLOOR NO.	M110	
	DRAWN BY	JPB	SHEET SIZE: 24 X 36
DRAWING	CHECKED BY	KWL	DATE: 10.28.22
	DRAWING NO.	M110	
SHEET		14	OF 21

SCOPE OF WORK  
NONE

KEYNOTES  
02.01 DUCTWORK AND DIFFUSERS TO REMAIN.

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PLAZA, HAMMOND, IN 46320-1839

KEYPLAN  
2ND FLOOR N.T.S.  
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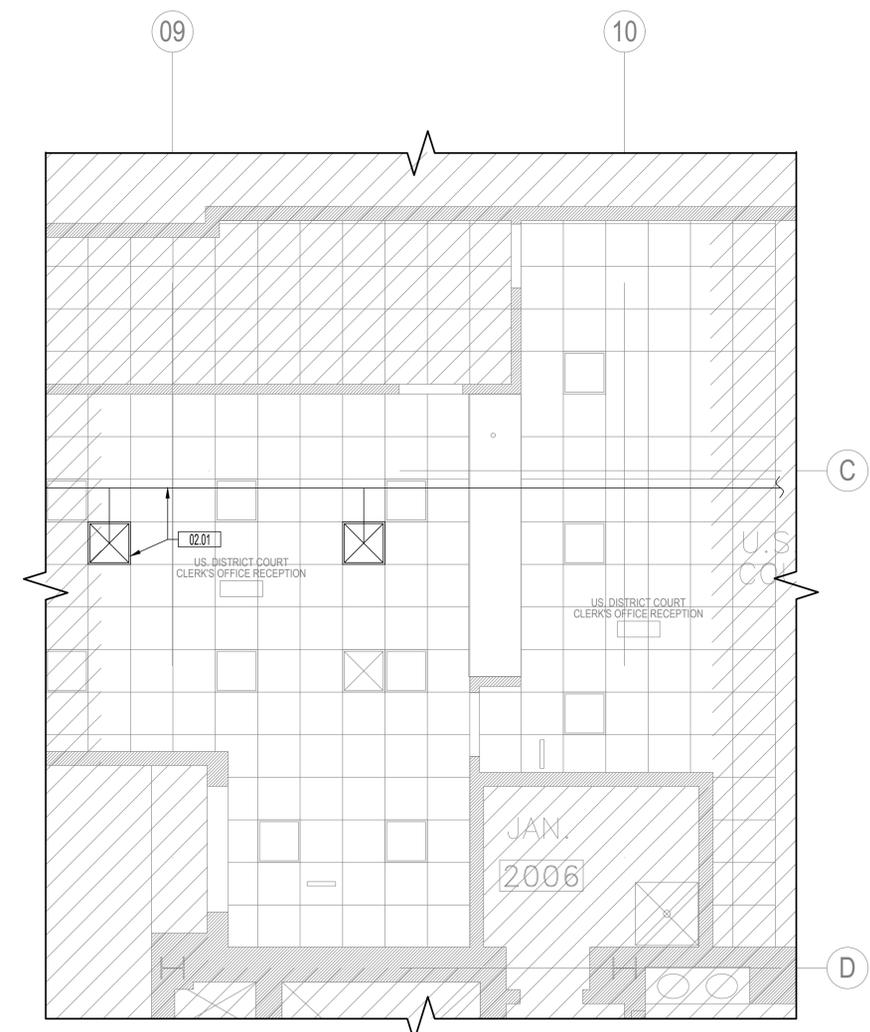

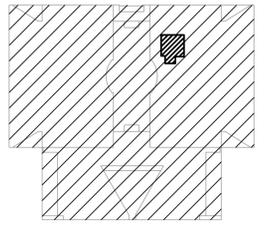
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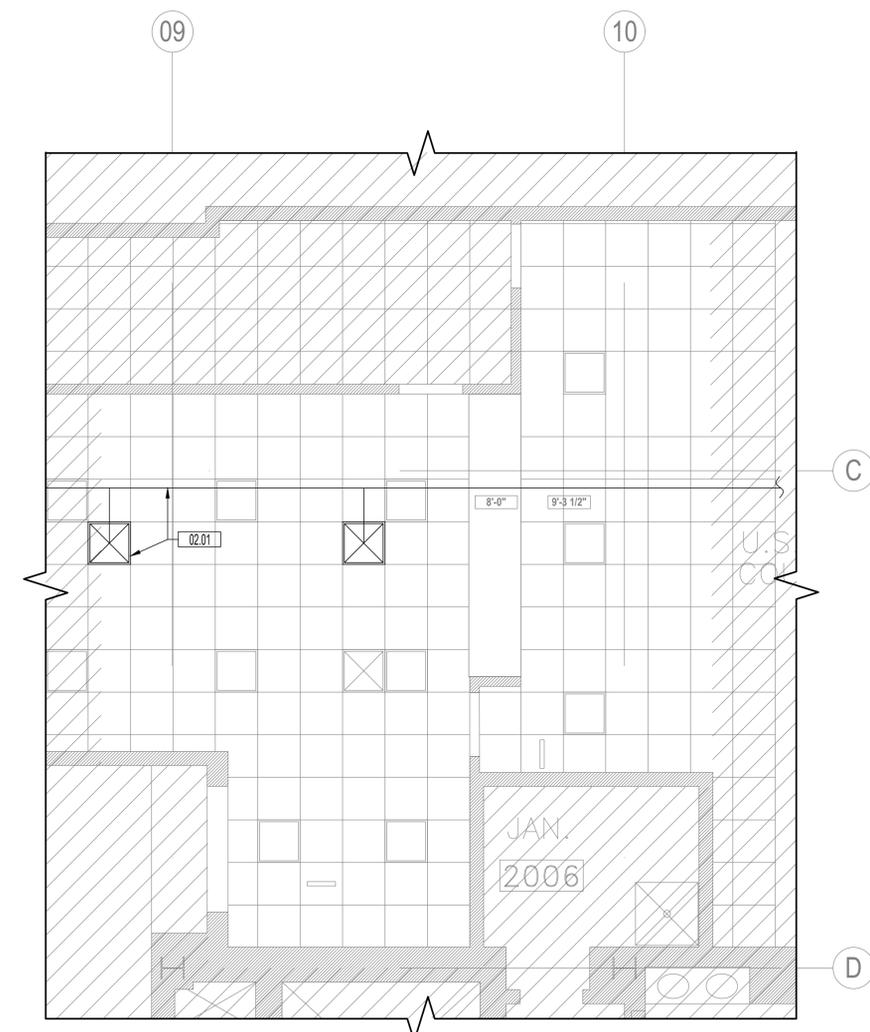
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	100% CD	10.28.22

GENERAL SERVICE ADMINISTRATION REGION 5 CHICAGO, IL	
BUILDING NAME	U.S. COURTHOUSE, 5400 FEDERAL PLAZA, HAMMOND, IN 46320-1839
BUILDING NO.	(IN0300ZZ)
OTHER BUILDING NOS.	
PROJECT DESCRIPTION	USDC & USBC TRANSACTION WINDOWS
PROJECT NO.	17005 - 020019 - 00
DRAWING TITLE	MECHANICAL PLANS
TYPE	MECHANICAL
FILE NAME	M111
FLOOR NO.	
DRAWN BY	JPB SHEET SIZE: 24 X 36
CHECKED BY	KWL DATE: 10.28.22
DRAWING NO.	<b>M111</b>
SHEET	15 OF 21



1 2ND LEVEL PARTIAL DEMO MECHANICAL RCP  
US. DISTRICT COURT CLERK'S OFFICE RECEPTION DESK  
SCALE: 1/4"=1'-0"  
0 2' 4' 8'  
SCALE: 1/4"=1'-0" NORTH



1 2ND LEVEL PARTIAL NEW WORK MECHANICAL RCP  
US. DISTRICT COURT CLERK'S OFFICE RECEPTION DESK  
SCALE: 1/4"=1'-0"  
0 2' 4' 8'  
SCALE: 1/4"=1'-0" NORTH

**ABBREVIATIONS**

AFF	ABOVE FINISHED FLOOR	MEP	MECHANICAL, ELECTRICAL, PLUMBING
AMP OR A	AMPERE	MFR	MANUFACTURER
CCT	CIRCUIT	MIN	MINIMUM
CLG	CEILING	NIC	NOT IN CONTRACT
D	DIMMER	NL	NIGHT LIGHT
DISC	DISCONNECT	NTS	NOT TO SCALE
EC	ELECTRICAL CONTRACTOR	PH OR Ø	PHASE
ELECT	ELECTRICAL	RECEP	RECEPTACLE
EM	EMERGENCY	XFMR	TRANSFORMER
EXIST	EXISTING	TYP	TYPICAL
FA	FIRE ALARM	U.N.O.	UNLESS NOTED OTHERWISE
FLA	FULL LOAD AMPERE	V	VOLT
GFI OR GFCI	GROUND FAULT CIRCUIT INTERRUPTER	W	WATT OR WIRE
GRD	GROUND, GROUNDING	X	DENOTES EXISTING ITEM TO REMAIN, NO CHANGES, U.N.O.
HP	HORSEPOWER	XN	DENOTES EXISTING ITEM IN ITS NEW LOCATION
JB	JUNCTION BOX	XR	DENOTES EXISTING ITEM TO BE REMOVED
KVA	KILOVOLT AMPERE	XRR	DENOTES EXISTING ITEM TO BE REMOVED AND RELOCATED/REINSTALLED
KW	KILOWATT		
MC	MECHANICAL CONTRACTOR		

**SECURITY SYMBOL LIST**

	DOOR SWITCH OR DOOR CONTACT
	DOOR ELECTRIC STRIKE
	CARD READER
	PASSIVE INFRARED SENSOR
	HIGH SECURITY LEVEL 2 MAGNETIC CONTACT SENSOR
	IDS HEAD END PANEL
	CCTV CAMERA
	MONITOR FOR CCTV
	ROTATING LIGHT
	DURESS BUTTON
	DOOR RELEASE BUTTON

**SYMBOLS**

	DUPLX 20A RECEPTACLE, MOUNTED AT 18" AFF U.N.O. (SUBSCRIPT "F" - OUTLET AT SYSTEMS FURNITURE).
	QUADPLEX 20A RECEPTACLE, MOUNTED 18" AFF U.N.O.
	DUPLX 20A RECEPTACLE, MOUNTED 6" ABOVE COUNTER UNLESS OTHERWISE NOTED
	QUADPLEX 20A RECEPTACLE, MOUNTED 6" ABOVE COUNTER UNLESS OTHERWISE NOTED
	DUPLX 20A GFI RECEPTACLE, MOUNTED 18" AFF U.N.O.
	DUPLX 20A GFI RECEPTACLE, MOUNTED 6" ABOVE COUNTER UNLESS OTHERWISE NOTED
	QUADPLEX 20A GFI RECEPTACLE, MOUNTED 6" ABOVE COUNTER UNLESS OTHERWISE NOTED
	DUPLX 20A ISOLATED GROUND RECEPTACLE, MOUNTED AT 18" AFF U.N.O.
	DUPLX 20A ISOLATED GROUND RECEPTACLE, MOUNTED 6" ABOVE COUNTER UNLESS OTHERWISE NOTED
	QUADPLEX 20A ISOLATED GROUND RECEPTACLE, MOUNTED 6" ABOVE COUNTER U.N.O.
	SPECIAL USE RECEPTACLE, SIZED AS INDICATED OR AS REQUIRED. NUMBER OF OUTLETS IS INDICATED BY A SUBSCRIPT NUMBER.
	SPECIAL USE RECEPTACLE, SIZED AS INDICATED OR AS REQUIRED. NUMBER OF OUTLETS IS INDICATED BY A SUBSCRIPT NUMBER. MOUNTED 6" ABOVE COUNTER UNLESS OTHERWISE NOTED
	DUPLX 20A RECEPTACLE, FLUSH MOUNTED IN CEILING
	FLOOR MOUNTED BOX FOR POWER OUTLET(S), DUPLX UNLESS NUMBER OF OUTLETS IS INDICATED BY A SUBSCRIPT NUMBER. REFER TO THE DRAWINGS FOR TYPE OF FLOOR BOX OR INSTALLATION REQUIREMENTS.
	WALL MOUNTED JUNCTION BOX, SIZED AS REQUIRED (4 INCHES SQUARE BY 2-1/8 INCHES DEEP)
	JUNCTION BOX, SIZED AS REQUIRED
	FLEXIBLE METAL CONDUIT CONNECTION (WHIP)
	MOTOR CONNECTION, 1/8 OR 3/8 AS INDICATED
	FLUSH MOUNTED FLOOR BOX FOR DATA OUTLET(S), MINIMUM TWO (2) DATA DROPS/OUTLETS UNLESS OTHERWISE NOTED. REFER TO THE DRAWINGS FOR TYPE OF FLOOR BOX OR INSTALLATION REQUIREMENTS.
	VOICE/DATA OUTLET, MOUNTED AT 18" AFF U.N.O. TWO (2)-VOICE, TWO (2)-DATA DROPS/OUTLETS/JACKS UNLESS OTHERWISE NOTED. (SUBSCRIPT "F" - OUTLET AT SYSTEMS FURNITURE).
	ANALOG VOICE OUTLET, MOUNTED AT 18" AFF U.N.O. TWO (2) ANALOG VOICE DROPS/OUTLETS/JACKS UNLESS OTHERWISE NOTED.
	ANALOG VOICE OUTLET, MOUNTED ABOVE-COUNTER OR AT 48" AFF U.N.O. TWO (2) ANALOG VOICE DROPS/OUTLETS/JACKS UNLESS OTHERWISE NOTED.
	DATA OUTLET, MOUNTED AT 18" AFF U.N.O. TWO (2) DATA DROPS/OUTLETS/JACKS UNLESS OTHERWISE NOTED (SUBSCRIPT "F" - OUTLET AT SYSTEMS FURNITURE).
	DATA OUTLET, MOUNTED ABOVE-COUNTER (SUBSCRIPT FB - BELT-LINE, OUTLET AT SYSTEMS FURNITURE) UNLESS OTHERWISE NOTED. TWO (2) DATA DROPS/OUTLETS/JACKS UNLESS OTHERWISE NOTED.
	FLUSH MOUNTED DATA OUTLET IN CEILING
	SIPRNET, RED SHIELDED CAT6E WITH RED JACKS.
	NIPRNET, GREEN SHIELDED CAT6E WITH GREEN JACKS
	TOGGLE SWITCH, MOUNTED AT 48" AFF, U.N.O. (SUBSCRIPT "K" DEMOTES KEY OPERATED, "T" THERMAL OVERLOAD)
	TOGGLE SWITCH, DIMMABLE, MOUNTED AT 48" AFF, U.N.O. ("3W" DENOTES 3-WAY)
	TOGGLE SWITCH WITH INTEGRAL INFRARED OCCUPANCY SENSOR, MOUNTED AT 44" AFF, U.N.O. (SUBSCRIPT "2" DENOTES DUAL CIRCUIT OCCUPANCY SENSING SWITCH, "D" DENOTES 0-10V DIMMING CAPABILITY)
	TOGGLE SWITCH WITH INTEGRAL DUAL-TECHNOLOGY OCCUPANCY SENSOR, MOUNTED AT 44" AFF, U.N.O. (SUBSCRIPT "2" DENOTES DUAL CIRCUIT OCCUPANCY SENSING SWITCH, "D" DENOTES 0-10V DIMMING CAPABILITY)
	360° CEILING MOUNTED INFRARED OCCUPANCY SENSOR COMPLETE WITH POWER PACK
	360° CEILING MOUNTED DUAL-TECHNOLOGY OCCUPANCY SENSOR COMPLETE WITH POWER PACK
	360° CEILING MOUNTED ULTRASONIC OCCUPANCY SENSOR COMPLETE WITH POWER PACK
	CEILING MOUNTED BI-DIRECTIONAL HALLWAY OCCUPANCY SENSOR COMPLETE WITH POWER PACK
	100° CEILING MOUNTED DUAL-TECHNOLOGY OCCUPANCY SENSOR COMPLETE WITH POWER PACK
	DAYLIGHT HARVESTING PHOTOCCELL
	CEILING MOUNTED SPEAKER
	VOICE COMMUNICATION SPEAKER, CEILING MOUNTED
	VOICE COMMUNICATION SPEAKER WITH VISUAL/STROBE ALARM DEVICE, WALL MOUNTED
	VOICE COMMUNICATION SPEAKER, CEILING MOUNTED
	VOICE COMMUNICATION SPEAKER WITH VISUAL/STROBE ALARM DEVICE, WALL MOUNTED
	VISUAL/STROBE ALARM DEVICE, CEILING MOUNTED
	DUAL-ACTION MANUAL PULL STATION, MOUNTED AT 44" AFF
	CARD READER
	DOOR CONTACT
	ELECTRIC STRIKE
	DURESS ALARM BUTTON
	REMOTE DOOR RELEASE
	REQUEST TO EXIT BAR
	INDICATES COMPONENT TO BE REMOVED
	INDICATES EXISTING TO REMAIN
	INDICATES NEW

**GENERAL NOTES:**

- CONTRACTOR TO FAMILIARIZE HIMSELF WITH THE EXISTING SITE CONDITIONS, CONDITIONS OF CONTRACT, THE SCOPE OF WORK & THE INTENT OF DESIGN BEFORE SUBMITTING A BID. REQUESTS FOR EXTRA PAYMENTS WILL NOT BE APPROVED AFTER CONTRACT AWARD.
- ALL WORK SHALL BE PERFORMED IN COMPLIANCE WITH REQUIREMENTS OF GSA PBS 100 & OTHER CODES, STANDARDS & REGULATIONS REFERENCED BY SUCH AUTHORITY. IN CASE OF CONFLICT BETWEEN TWO CODES, THE MOST STRINGENT PROVISION SHALL BE FOLLOWED. GC MUST GET C.O. APPROVAL PRIOR TO ANY MODIFICATION TO ANY CONTRACTING DOCUMENTS.
- COORDINATE ELECTRICAL INSTALLATION WITH WORK BY OTHER TRADES BEFORE STARTING WORK. PERFORM ALL WORK IN COOPERATION WITH THE USING AGENCY, G.C. & OTHER TRADES.
- ALL NEW MATERIAL/EQUIPMENT SHALL BE U.L. LISTED, WITHOUT DEFECT OR DAMAGE AND SHALL BE A STANDARD PRODUCT OF A MANUFACTURER WITH A WELL KNOWN BRAND NAME. WIRING DEVICES SHALL BE SPECIFICATION GRADE. FINISH OF ALL ITEMS INSTALLED IN FINISHED AREAS SHALL BE PER ARCHITECT.
- ELECTRICAL DWGS ARE SCHEMATIC IN NATURE. THEY DO NOT INTEND TO SHOW EVERY DETAIL, LOCATION, SIZE, ROUTE ETC. FURNISH ALL MATERIAL, EQUIPMENT, INCIDENTALS & SERVICES TO PROVIDE A SATISFACTORY, COMPLETE & OPERATIONAL INSTALLATION IN CONFORMANCE WITH THE INTENT OF THE DESIGN. REFER TO ARCHITECTURAL DWGS. FOR DIMENSIONAL ACCURACY.
- PROVIDE TEMPORARY ELECTRICAL WIRING AS REQUIRED PER G.C. TO PROVIDE LIGHTING & POWER FOR USE BY ALL TRADES DURING CONSTRUCTION.
- ARCHITECT MAY REVIEW SUBMITTAL OF AN ALTERNATE PRODUCT PROVIDED IT HIGHLIGHTS ALL THE FEATURES & DATA TO CLEARLY ILLUSTRATE THAT IT IS A BONAFIDE EQUIVALENT PRODUCT IN MAKE & PERFORMANCE. ARCHITECT SHALL NOT REVIEW A SUBMITTAL NOT DEEMED RESPONSIVE IN THIS REGARD.
- ALL ENCLOSURES SHALL BE NEMA-1, IN GENERAL. GFI RECEPTACLES SHALL BE USED IF SPECIFIED OR CODE REQUIRED. WIRING DEVICES SHALL BE SPECIFICATION GRADE. NAMEPLATES SHALL BE PHENOLIC WITH BLACK LETTERS ON WHITE OR TRANSPARENT BACKGROUND LABELS, SECURED WITH SCREWS ON THE ENCLOSURES.
- USE MINIMUM 3/4" EMT WITH COMPRESSION TYPE FITTINGS. USE TYPE THHN/THWN, COPPER WIRE IN MINIMUM #12 AWG FOR BRANCH CIRCUITS. FLEXIBLE CONDUIT SHALL BE LIQUID-TIGHT. USE MINIMUM SIZE "0" STARTERS. FUSES SHALL BE TIME DELAY DUAL ELEMENT REJECTION TYPE.
- SEAL PENETRATIONS THROUGH VAPOR & FIRE BARRIERS CAUSED BY THE ELECTRICAL WORK WITH U.L. LISTED SEALS TO RETAIN THE INTEGRITY OF THE RESPECTIVE BARRIERS.
- ALL INSTALLATION (INCLUDING COMMUNICATION AND FIRE ALARM WIRING) IN CEILING SPACE SHALL BE SUPPORTED FROM THE STRUCTURAL STEEL & NOT BY THE DROPPED CEILING MEMBERS. CONDUITS SHALL RUN SNUUG UNDER STRUCTURAL CEILING EITHER PARALLEL OR PERPENDICULAR TO THE CEILING, COLUMNS & STRAIGHT WALLS. INSTALL ALL NECESSARY PULL BOXES PER CODE. INSTALL PULL LINES IN EMPTY RACEWAYS & CAP THEM.
- ALL EXISTING TO REMAIN AND ALL NEW LOW VOLTAGE CABLING (INCLUDING BUT NOT LIMITED TO TELEPHONE/DATA/VOIP, CARD ACCESS, CCTV, INTRUSION DETECTION, AND/OR FIRE ALARM SYSTEM CABLING) SHALL NOT BE STRAPPED, TAPED, OR ATTACHED BY ANY MEANS TO THE EXTERIOR OF ANY CONDUIT OR OTHER RACEWAYS AS A MEANS OF SUPPORT. PROVIDE PROPER INDEPENDENT SUPPORT ATTACHED TO THE BUILDING STRUCTURE AS REQUIRED.
- INSTALLATION SHALL BE PERFORMED IN A MANNER CONSISTENT WITH INDUSTRY STANDARD FOR GOOD WORKMANSHIP. PROVIDE NECESSARY CUTTING, PATCHING, & CLEANING FOR ELECTRICAL WORK TO LEAVE THE AREA READY FOR FINAL FINISH BY OTHERS.
- PROGRESS YOUR WORK IN TIMELY MANNER TO ENABLE THE OWNER TO FINISH THE WORK PER SCHEDULE. SAFEGUARD YOUR WORK & SUPPLIES. MAINTAIN ORDERLY & NEAT OPERATION. REMOVE DEBRIS GENERATED FROM YOUR WORK PER G.C. & OWNER. LEAVE THE SITE IN CLEAN, MOVE-IN CONDITION AT ACCEPTANCE.
- ORGANIZE ALL WARRANTIES, GUARANTEES & PRODUCT LITERATURE IN A FILE AND HAND OVER THESE TO THE OWNER AT THE TIME OF ACCEPTANCE. PROVIDE FULL & UNCONDITIONAL GUARANTEE OF YOUR WORK (MATERIAL PLUS LABOR) FOR A PERIOD OF 12 MONTHS FROM ACCEPTANCE. REFER TO ARCHITECT'S REQUIREMENTS FOR "WARRANTIES & GUARANTEES" AND "PROJECT CLOSE-OUT".
- CONDUCT TESTING TO ALL BRANCH CIRCUIT/RECEPTACLES AND ENSURE THAT NEW AND EXISTING ELECTRICAL WORK ARE IN GOOD WORKING CONDITION.
- IN GENERAL, CONNECT EMERGENCY FIXTURES AND EXIT SIGNS TO THE UNSWITCHED LEG OF THE LOCAL LIGHTING CIRCUIT.
- ALL WORK AND MODIFICATIONS TO THE SECURITY SYSTEM SHALL BE DONE BY ANY OF THE 8 SECURITY VENDORS APPROVED BY USMS, SEE LIST OF VENDORS ON THIS SHEET.
- COORDINATE ALL LIGHTING WORK WITH ARCHITECTURAL AND MECHANICAL WORK.
- IN LOCATION(S) WHERE EXISTING FIRE ALARM DEVICE(S)/APPLIANCE(S) ARE RELOCATED, ELECTRICAL CONTRACTOR TO ARRANGE AND PAY FOR ON-SITE TESTING/PROGRAMMING BY MANUFACTURER'S REPRESENTATIVE TO ENSURE THAT EXISTING FIRE ALARM SYSTEM AND RELOCATED DEVICE(S)/APPLIANCE(S) SHALL FUNCTION AS ONE SYSTEM.

**LIGHTING SCHEDULE**

TYPE	LAMP QTY.	LAMP TYPE	MOUNTING	VOLTAGE	WATTS	MANUFACTURER AND MODEL	DESCRIPTION
	EXISTING	EXISTING	RECESSED	EXISTING	EXISTING	EXISTING	EXISTING 2X4 LIGHTING FIXTURES TO REMAIN OR TO BE RELOCATED AS INDICATED ON THE DRAWINGS.
	NA	LED	RECESSED	UNV	34	FOCAL POINT: LUNA FLUL SERIES HUBBELL/COLUMBIA LTG: LTR22Z SERIES HE WILLIAMS: PT SERIES LITHONIA LTG: ZBLT2 SERIES	NEW RECESSED 2X2 LED LUMINAIRE WITH PERFORATED CENTER BASKET, POLYESTER POWDER COAT FINISH, 3500M.ECOSYSTEM DIMMING, 3000 LUMENS, PLENUM RATED, WITH ADDRESSABLE LED DRIVER BY LUTRON.
	EXISTING	EXISTING	RECESSED	EXISTING	EXISTING	EXISTING	EXISTING EXIT SIGN TO REMAIN OR TO BE RELOCATED AS INDICATED ON THE DRAWINGS.


**LIST OF USMS APPROVED SECURITY VENDORS**

Company	Name	Title	Role	Email	Phone
Williams Electric	Katy Smith	GSA Program Manager	USMS Program Manager	katy.smith@parsons.com	850-812-3632
Williams Electric	Damon Williams	GSA Project Manager	USMS Project Manager	damon.williams@parsons.com	850-582-2081
Williams Electric	Brie Troquet	Principle Contracts Administrator	USMS Contracts Manager	brie.troquet@parsons.com	850-812-3618
Converged Solutions Program					
Williams Electric	Dan Rucker	Converged Solutions Program Director	Director	dan.rucker@parsons.com	850-812-3619
Versar	Yuwana Neogi	Contracts Manager	Contracts	yneogi@versar.com	240-252-6797
Versar	Elizabeth Miller	VP Strategic Programs	Business Development	emiller@versar.com	703-725-1830
Versar	Christopher Rummage	Security Systems Engineer	Business Development	crummage@versar.com	240-315-6758
Versar	Joe Williams	Sr. Program Manager	Program Manager	jwilliams@versar.com	240-281-9416
TIC	Roger Echeandia	CEO	Contract Admin / BO	roger.echeandia@TICSecurity.com	240-575-8260
TIC	Derek Radoski	President	Contract Admin / BO	radoski@TICSecurity.com	703-447-1504
TIC	Kate Fisher	Analyst	Admin Support / Analyst	kate.fisher@TICSecurity.com	833-227-7034
JCSS	Kevin Romer	Sr. Program Manager	Manager - USMS Program	kevin.romer@jci.com	703-231-3167
JCSS	Justin Choo	Program Manager	Manager - Design/Estimating	justin.choo@jci.com	571-243-9745
JCSS	Ravin Wijeratne	Program Manager	Manager - Project Delivery	ravin@vijeratne@jci.com	571-212-2430
JCSS	Tim Epler	Sr. Account Manager	Sr. Account Manager	tim.epler@jci.com	571-437-8598
M.C. Dean	David Sealock	Operations Manager	Operations Manager	david.sealock@mcdean.com	703-932-3593
M.C. Dean	Julaine Simmons	Operations Manager	Operations Manager	julaine.simmons@mcdean.com	703-982-8336
M.C. Dean	Gerard Skinner	Program Manager	Program Manager	gerard.skinner@mcdean.com	571-436-7137
M.C. Dean	Patrick Hayes	Proposal Manager	Proposal Manager	patrick.hayes@mcdean.com	301-788-8168
M.C. Dean	Beate Ritz	Contracts Manager	Contracts Manager	beate.ritz@mcdean.com	711-849-5000
eVigilant	Denise Cole	Prossal Manager	Backup	dcole@evigilant.com	703-889-9276
eVigilant	Sahib (Gursahib) Singh	Proposal Assistant	Lead	gsingh@evigilant.com	703-889-9293
eVigilant	Darien S. Boutchyard	Director of Operations	Lead	dboutchyard@evigilant.com	TBD
eVigilant	Eric Hyes	Director of Engineering	Backup	ehyes@evigilant.com	703-889-9285
eVigilant	Michael Oehring	Sr. Engineer	Lead	moehring@evigilant.com	703-889-9284
eVigilant	Jason Tibbetts	President	Authorized Signatore	jtibbetts@evigilant.com	703-889-9275
eVigilant	David Spay	CAD Drafter	Lead Drafter	dspay@evigilant.com	703-889-9283
KBR	Jessica Botticher	Sr. Contract Specialist	Contracts	jessica.botticher@us.kbr.com	843-806-6727
KBR	Steve Meredith	Program Manager	PM	stephen.meredith@us.kbr.com	760-608-6610
KBR	Dave Dougherty	Director	PM	david.dougherty@us.kbr.com	303-829-8821
KBR	Beth Armistead	Manager, Technical Solutions	BO	beth.armistead@us.kbr.com	757-630-1641
Executive Vice President and General Manager					
Signet	Gary Harmon	Manager	Executive Sponsor	gary.harmon@signetinc.com	919.255.8511 mobile
Signet	Dan Burnell	Director of Programs	Program Director	dan.burnell@signetinc.com	217.671.8660 mobile
Director of Capture and Contract Administration					
Signet	Melissa Bulluck	Administration	Contracts and Proposals	melissa.bulluck@signetinc.com	804.640.1423 mobile
Signet	Precious Johnson	Proposal and Contracts Administrator	Contracts and Proposals	precious.johnson@signetinc.com	240.482.5501 mobile
Signet	Angie Royal	Proposal Manager	Proposal Management	angie.royal@signetinc.com	202.255.1414 mobile
Signet	Botto Mandow	Director of Engineering	Director of Engineering	Botto.Mandow@signetinc.com	202.413.3951 mobile
Signet	Clint Leisear	Director of Project Management	Director of Project Management	Clint.Leisear@signetinc.com	240.832.2900 mobile

**GENERAL DEMOLITION NOTES:**

- EXISTING ELECTRICAL SYSTEMS SHOWN ON THE DRAWINGS ARE BASED ON VISUAL INSPECTION AND EXISTING DRAWINGS. BUT THEY MAY NOT REFLECT THE EXISTING CONDITION IN EVERY CASE. THE CONTRACTOR SHALL VISIT THE SITE PRIOR TO SUBMITTING A BID AND VERIFY EXISTING CONDITIONS.
- THE BUILDING WHERE THE WORK TO BE DONE IS IN USE. SCHEDULE ANY ELECTRICAL WORK (ESPECIALLY ELECTRICAL SYSTEM DISCONNECTS OR RECONNECTION WITH THE CONTRACTING OFFICER AND BUILDING MANAGEMENT. MAKE ARRANGEMENTS AT LEAST TWO (2) WEEKS PRIOR TO PROPOSED SCHEDULE OF WORKS. ARRANGE WORK SO AS NOT TO INTERRUPT ANY ELECTRICAL POWER, TELEPHONE, FIRE, COMMUNICATION, AND OTHER SYSTEMS DURING NORMAL WORKING HOURS.
  - WHERE CORE DRILLING AND CUTTING OF FLOORS OR WALLS IS REQUIRED, USE METAL DETECTORS OR OTHER APPROVED DEVICES TO DETERMINE AND AVOID INTERFERENCE WITH EXISTING CONCEALED CONDUITS & PIPES.
  - USE GREAT DILIGENCE AND CARE IN DISCONNECTING VARIOUS SYSTEMS. RECONNECT SYSTEMS AND RESTORE ALL THAT SERVE ADJACENT AREAS IF SUCH SYSTEMS HAVE BEEN DISRUPTED DURING DEMOLITION WORK WITHOUT ANY EXPENSE FOR THE AFFECTED USING AGENCY OR THE BUILDING. EXTEND CONDUIT & WIRING AS REQUIRED TO MAINTAIN OPERATION OF REMOVED EQUIPMENT OR DEVICES.
  - COORDINATE ALL DEMOLITION WORK WITH OTHER TRADES AS REQUIRED.
- ELECTRICAL ITEMS REMOVED AND NOT RELOCATED SUCH AS LIGHTING FIXTURES, SWITCHES, RECEPTACLES, BREAKERS, WIRE, ET. REMAIN THE PROPERTY OF THE OWNER AND SHALL BE STORED OR DISPOSED OF AS DIRECTED BY OWNER.
- ALL UNUSED CONDUITS OR ANY ELECTRICAL ITEMS THAT ARE ABANDONED AND WHERE ELECTRICAL ITEMS ARE BEING REMOVED SHALL HAVE ALL WIRING REMOVED BACK TO THE SOURCE OR FEEDER JUNCTION BOX SERVING THE DEVICE OR BACK TO THE FIRST OUTLET WHICH IS LEFT UNAFFECTED BY THE CHANGES. STUBS SHALL BE PLUGGED FLUSH WITH FLOOR, CEILING SLABS, OR WALLS. ALL EXPOSED LOW VOLTAGE CABLING, CONDUITS AND FITTINGS, INCLUDING ABOVE DROP CEILINGS THAT ARE ABANDONED (NOT USED) SHALL BE REMOVED UNLESS OTHERWISE NOTED ON THE DRAWINGS OR DIRECTED BY THE BUILDING MANAGEMENT AND CONTRACTING OFFICER.
- WHERE EXISTING ELECTRICAL ITEMS (POWER, COMMUNICATION, FIRE ALARM EQUIPMENT, DEVICES, LIGHTING FIXTURES, ETC) THAT ARE INSIDE OR OUTSIDE THE CONTRACT LIMITS OF CONSTRUCTION ARE TO REMAIN BUT ARE AFFECTED BY THE EXECUTION OF ELECTRICAL WORK SUCH AS REMOVAL, MOVING, OR RECONDITIONING OF WALLS AND CEILINGS SHALL BE DISCONNECTED, REMOVED, CLEANED, REWORKED AND REINSTALLED IN-LINE WITH NEW WALLS OR CEILINGS. PROVIDE ALL NECESSARY MATERIALS AND LABOR AND REWIRE IN ACCORDANCE WITH PRESENT CODE REQUIREMENTS. CONTRACTOR SHALL BE HELD RESPONSIBLE FOR THE USE OF GREAT DILIGENCE AND CARE IN DISCONNECTING VARIOUS SYSTEMS. RECONNECT SYSTEMS THAT SERVE ADJACENT AREAS OR FLOOR ABOVE OR BELOW IF SUCH SYSTEMS HAVE BEEN DISRUPTED DURING DEMOLITION WORK.
- ENSURE THAT ALL EXISTING LOW VOLTAGE CABLING EXPOSED ABOVE CEILING THAT WILL REMAIN IN OPERATION SHALL BE PROPERLY MAINTAINED. IF ANY LOW VOLTAGE CABLING (INCLUDING BUT NOT LIMITED TO TELEPHONE/DATA/VOIP, CARD ACCESS, CCTV, INTRUSION DETECTION, AND/OR FIRE ALARM SYSTEM CABLING) IS FOUND TO BE STRAPPED, TAPED, OR ATTACHED BY ANY MEANS TO THE EXTERIOR OF ANY CONDUIT OR OTHER RACEWAYS AS A MEANS OF SUPPORT, PROVIDE PROPER INDEPENDENT SUPPORT ATTACHED TO THE BUILDING STRUCTURE AS REQUIRED.
- LAMPS THAT CONTAIN MERCURY AND BALLASTS MANUFACTURED PRIOR TO 1980 THAT CONTAINS PCBs SHALL BE DISPOSED OF BY FEDERAL OR STATED E.P.A. APPROVED METHOD AND IN ACCORDANCE WITH SPECIFICATIONS.
- EXISTING FIRE ALARM SYSTEM IS TO REMAIN. SOME OF THE EXISTING FIRE ALARM DEVICES WILL BE RELOCATED. EXTEND CONDUIT AND WIRING AS REQUIRED. ARRANGE FOR THE ON-SITE INSPECTION AND GUIDANCE OF THE MANUFACTURER'S TECHNICAL REPRESENTATIVE DURING THE EXECUTION OF ALL FIRE ALARM SYSTEM WORKS.

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signature 10/28/2022 date license expires on 07-31-2023		
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MARK	DESCRIPTION	DATE
	100% CD	10.28.22
GENERAL SERVICE ADMINISTRATION REGION 5 CHICAGO, IL		
BUILDING	NAME	U.S. COURTHOUSE,
	STREET	5400 FEDERAL PLAZA, HAMMOND, IN
P.L.C.	CITY/STREET/ZIP	46320-1839
	BUILDING NO.	(IN0300Z)
OTHER	BUILDING NOs.	
	PROJECT	USDC & USBC TRANSACTION WINDOWS
DESCRIPTION	PROJECT NO.	17005 - 020019 - 00
	DRAWING TITLE	ELECTRICAL SYMBOLS & ABB.
DRAWING	TYPE	
	FILE NAME	E000
DRAWING	FLOOR NO.	
	DRAWN BY	JPB SHEET SIZE: 24 X 36
DRAWING	CHECKED BY	KWL DATE: 10.28.22
	DRAWING NO.	E000
SHEET		16 OF 21

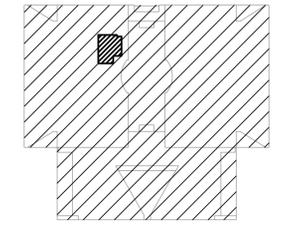

U.S. COURTHOUSE, 5400 FEDERAL  
PLAZA, HAMMOND, IN 46320-1839

**KEYPLAN**  
2ND FLOOR N.T.S.  
NORTH



*Key W. Locke, Jr.*  
signature  
10/28/2022  
date  
license expires on 07-31-2023

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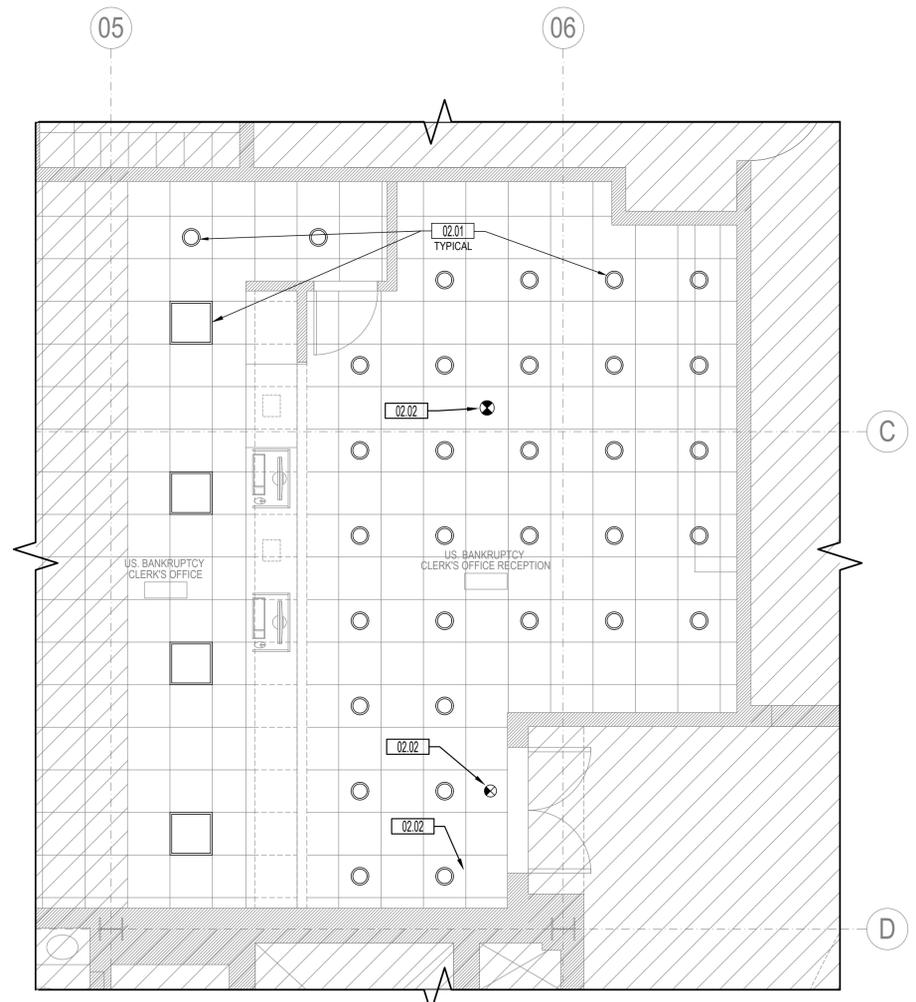
MARK	DESCRIPTION	DATE
	100% CD	10.28.22

GENERAL SERVICE ADMINISTRATION  
REGION 5 CHICAGO, IL


BUILDING	NAME	U.S. COURTHOUSE,	
	STREET	5400 FEDERAL PLAZA, HAMMOND, IN	
PACT.	CITY/STREET/ZIP	46320-1839	
	BUILDING NO.	(IN0300ZZ)	
DRAWING	OTHER BUILDING NOS.		
	PROJECT DESCRIPTION	USDC & USBC TRANSACTION WINDOWS	
	PROJECT NO.	17005 - 020019 - 00	
	DRAWING TITLE	LIGHTING PLANS	
DRAWING	TYPE	ELECTRICAL	
	FILE NAME	E110	
DRAWING	FLOOR NO.		
	DRAWN BY	JPB	SHEET SIZE: 24 X 36
DRAWING	CHECKED BY	KWL	DATE: 10.28.22
	DRAWING NO.	E110	
SHEET		17	OF 21

**KEYNOTES**


- 02.01 EXISTING LIGHT FIXTURE TO REMAIN.
- 02.02 EXISTING EXIT SIGN TO REMAIN.
- 26.01 EXISTING TO REMAIN.



**2ND LEVEL PARTIAL DEMO LIGHTING PLAN**  
**US. BANKRUPTCY CLERK'S OFFICE RECEPTION DESK**  
SCALE: 1/4"=1'-0" NORTH

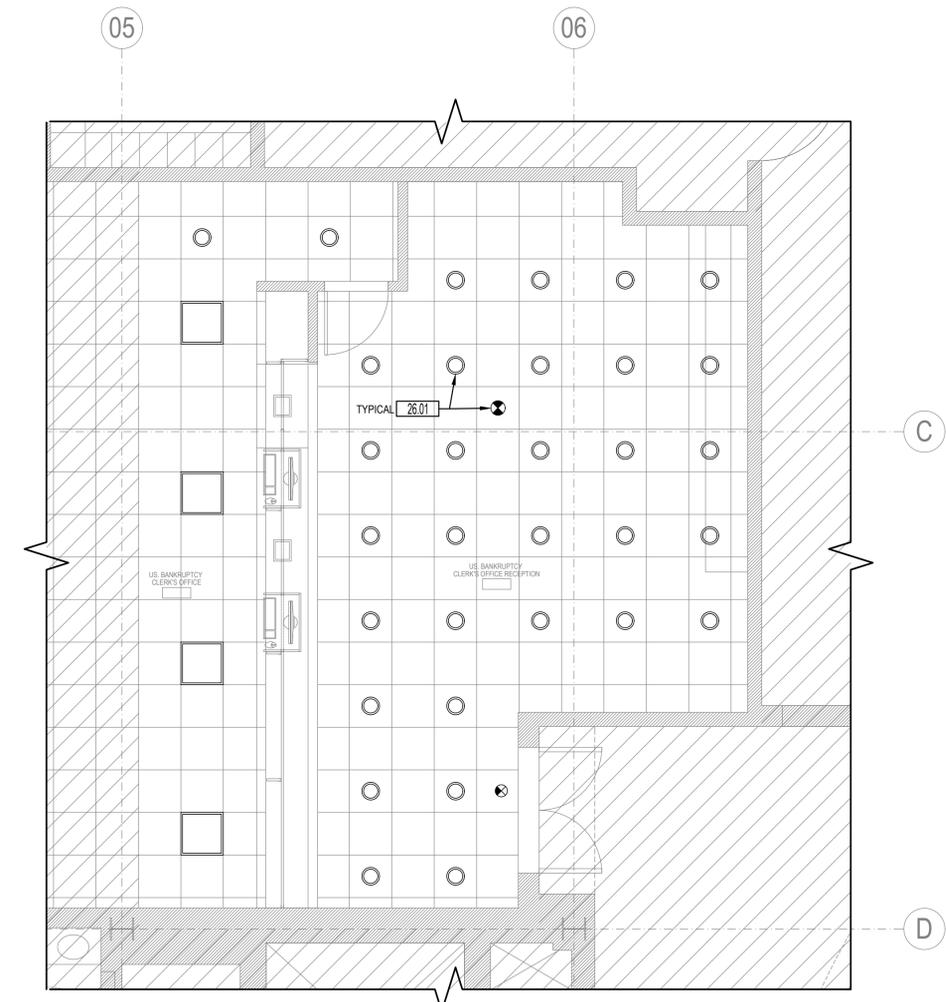

**2ND LEVEL PARTIAL NEW WORK LIGHTING PLAN**  
**US. BANKRUPTCY CLERK'S OFFICE RECEPTION DESK**  
SCALE: 1/4"=1'-0" NORTH

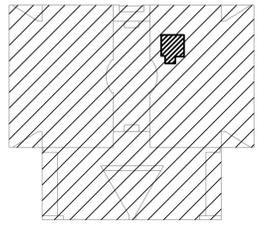

U.S. COURTHOUSE, 5400 FEDERAL  
PLAZA, HAMMOND, IN 46320-1839

**KEYPLAN**  
2ND FLOOR N.T.S.  
NORTH



*Kelly W. Locke*  
signature  
10/28/2022  
date  
license expires on 07-31-2023

**bailey edward**  
35 East Wacker Dr  
Suite 2800  
Chicago, IL  
60601-2308  
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Design Firm License No. 184-001962


MARK	DESCRIPTION	DATE
	100% CD	10.28.22

GENERAL SERVICE ADMINISTRATION  
REGION 5 CHICAGO, IL


BUILDING NAME	U.S. COURTHOUSE, 5400 FEDERAL PLAZA, HAMMOND, IN 46320-1839	
BUILDING STREET	5400 FEDERAL PLAZA, HAMMOND, IN 46320-1839	
BUILDING CITY/STREET/ZIP	5400 FEDERAL PLAZA, HAMMOND, IN 46320-1839	
BUILDING NO.	(IN0300ZZ)	
OTHER BUILDING NOS.		
PROJECT DESCRIPTION	USDC & USBC TRANSACTION WINDOWS	
PROJECT NO.	17005 - 020019 - 00	
DRAWING TITLE	LIGHTING PLANS	
TYPE	ELECTRICAL	
FILE NAME	E111	
FLOOR NO.		
DRAWN BY	JPB	SHEET SIZE: 24 X 36
CHECKED BY	KWL	DATE: 10.28.22
DRAWING NO.	E111	
SHEET	18	OF 21

**KEYNOTES**


- 02.01 EXISTING LIGHT FIXTURE TO REMAIN.
- 02.02 EXISTING EXIT SIGN TO REMAIN.
- 26.01 EXISTING TO REMAIN.

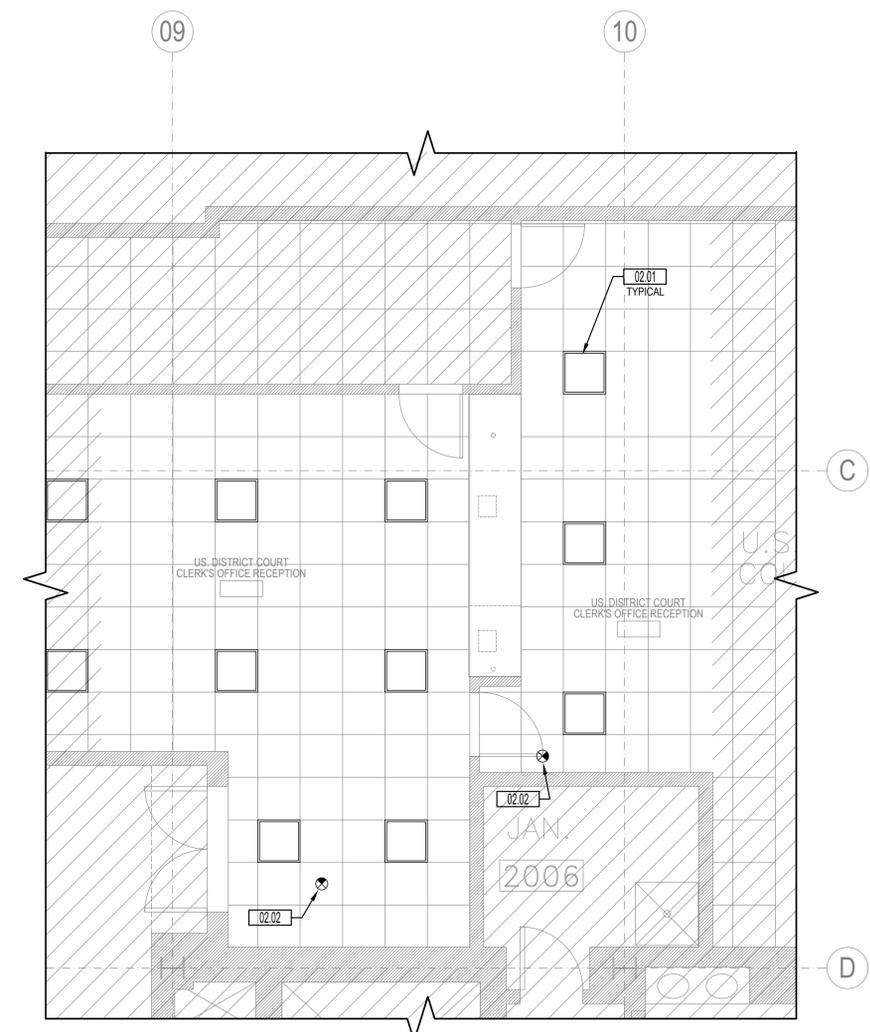

**1** 2ND LEVEL PARTIAL DEMO LIGHTING PLAN  
US. DISTRICT COURT CLERK'S OFFICE RECEPTION DESK  
SCALE: 1/4"=1'-0"  
0 2' 4' 8'  
SCALE: 1/4"=1'-0"  
NORTH

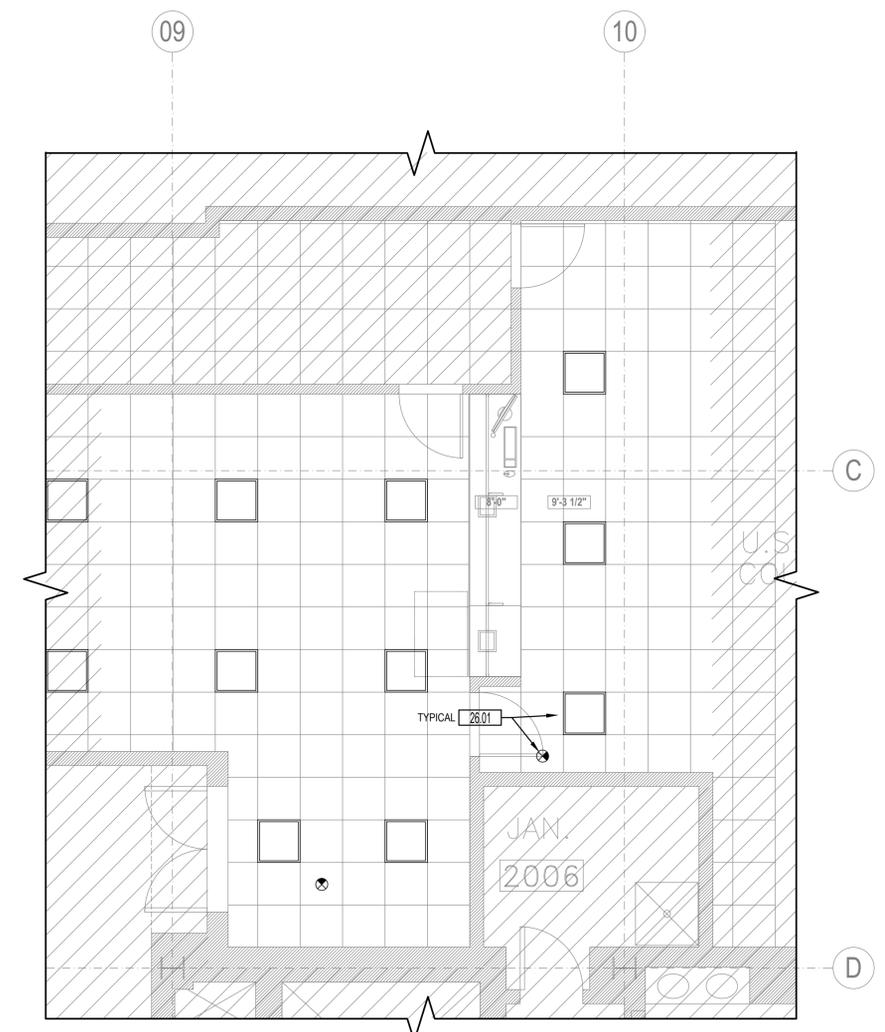

**1** 2ND LEVEL PARTIAL NEW WORK LIGHTING PLAN  
US. DISTRICT COURT CLERK'S OFFICE RECEPTION DESK  
SCALE: 1/4"=1'-0"  
0 2' 4' 8'  
SCALE: 1/4"=1'-0"  
NORTH

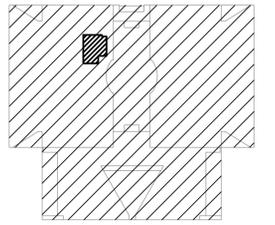

U.S. COURTHOUSE, 5400 FEDERAL PLAZA, HAMMOND, IN 46320-1839

**KEYPLAN**  
2ND FLOOR N.T.S.  
NORTH



*Kyle W. Locke, Jr.*  
signature

10/28/2022  
date  
license expires on 07-31-2023



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MARK	DESCRIPTION	DATE
	100% CD	10.28.22

GENERAL SERVICE ADMINISTRATION  
REGION 5 CHICAGO, IL


BUILDING	NAME	U.S. COURTHOUSE, 5400 FEDERAL PLAZA, HAMMOND, IN 46320-1839	
	STREET	5400 FEDERAL PLAZA, HAMMOND, IN 46320-1839	
P.C.T.	CITY/STREET/ZIP	CITY/STREET/ZIP	
	BUILDING NO.	(IN0300ZZ)	
DRAWING	OTHER BUILDING NOs.		
	PROJECT DESCRIPTION	USDC & USBC TRANSACTION WINDOWS	
DRAWING	PROJECT NO.	17005 - 020019 - 00	
	DRAWING TITLE	POWER AND SYSTEM PLANS	
DRAWING	TYPE	ELECTRICAL	
	FILE NAME	E112	
DRAWING	FLOOR NO.		
	DRAWN BY	JPB	SHEET SIZE: 24 X 36
DRAWING	CHECKED BY	KWL	DATE: 10.28.22
	DRAWING NO.	E112	
SHEET		19	OF 21

**SHEET NOTES**


- E.C. TO COORDINATE CLOSELY WITH COMMUNICATIONS AND SECURITY CONTRACTORS AND PROVIDE INFRASTRUCTURE ONLY (CONDUIT WITH PULL STRING AND BACK BOXES) FOR COMMUNICATIONS, AND SECURITY SYSTEMS. E.C. SHALL STUB CONDUITS INTO ACCESSIBLE CEILING SPACE THROUGH THE NEAREST FEASIBLE WALL AND PROVIDE RACEWAYS IN THE MILLWORK IN COORDINATION WITH MILLWORK CONTRACTOR. COMMUNICATIONS CONTRACTOR SHALL PROVIDE EQUIPMENT, HORIZONTAL CABLING AND COMMUNICATIONS OUTLETS ON A SEPARATE CONTRACT. SECURITY CONTRACTOR SHALL PROVIDE SECURITY EQUIPMENT, SECURITY DEVICES AND WIRING ON A SEPARATE CONTRACT.
- COMMUNICATIONS AND SECURITY WIRING MAY BE RUN EXPOSED IN THE ACCESSIBLE CEILING OF TENANT'S SPACE. ANY WIRING OR HORIZONTAL CABLING OUTSIDE OF TENANT'S SPACE BEGINNING AT LEAST 3 FEET PRIOR TO LEAVING SUCH SPACE SHALL BE IN CONDUIT. REFER ALSO TO SHEET E200 FOR ADDITIONAL INFORMATION ON CONDUIT ROUTES.
- COORDINATE ALL WORK WITH ARCHITECTURAL DRAWINGS AND ELEVATIONS.
- ALL WORK AND MODIFICATIONS TO THE SECURITY SYSTEM SHALL BE PERFORMED BY ONE OF THE 8 VENDORS APPROVED BY USMS. SEE LIST ON SHEET E000.
- ELECTRICAL CONTRACTOR TO CONFIRM WITH TENANT IF THERE IS ADDITIONAL REMOTE RELEASE REQUIRED. PROVIDE INFRASTRUCTURE AS REQUIRED.

**KEYNOTES**


- 02.01 EXISTING CARD READER TO BE REMOVED AND TO BE REPLACED WITH NEW.
- 02.02 EXISTING FIRE ALARM DEVICE TO BE REMOVED AND TO BE RELOCATED.
- 02.03 EXISTING WALL CLOCK TO BE REMOVED AND TO BE RELOCATED.
- 02.04 EXISTING DATA AND POWER OUTLETS TO REMAIN.
- 02.05 EXISTING DURESS BUTTON TO REMAIN.
- 26.01 PROVIDE NEW REPLACEMENT CARD READER.
- 26.02 NEW LOCATION OF FIRE ALARM DEVICE, EXTEND CONDUIT AND WIRING AS REQUIRED.
- 26.03 NEW LOCATION OF WALL CLOCK, EXTEND CONDUIT AND WIRING AS REQUIRED.
- 26.04 PROVIDE NEW GROMMET(S) FOR DATA AND POWER WIRING AS REQUIRED, COORDINATE WITH MILLWORK.
- 26.05 PROVIDE CONDUIT PROVISION WITH PULL STRING ON THE NEAREST WALL STUBBED UP INTO ACCESSIBLE CEILING SPACE FOR NEW REMOTE DOOR RELEASE. COORDINATE WITH TENANT AND MILLWORK EXACT LOCATION OF DEVICE AND ROUTE OF CONDUITS.

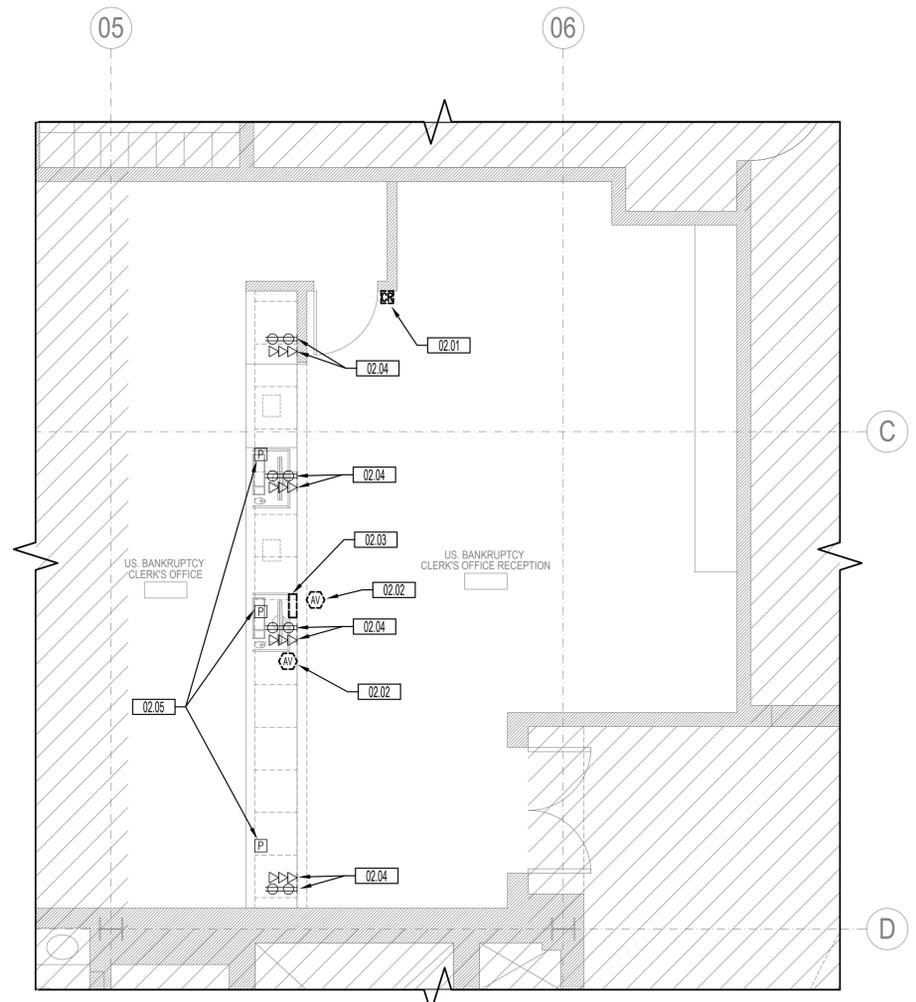

**2ND LEVEL PARTIAL DEMO POWER AND SYSTEM PLAN  
US. BANKRUPTCY CLERK'S OFFICE RECEPTION DESK**  
SCALE: 1/4"=1'-0" NORTH

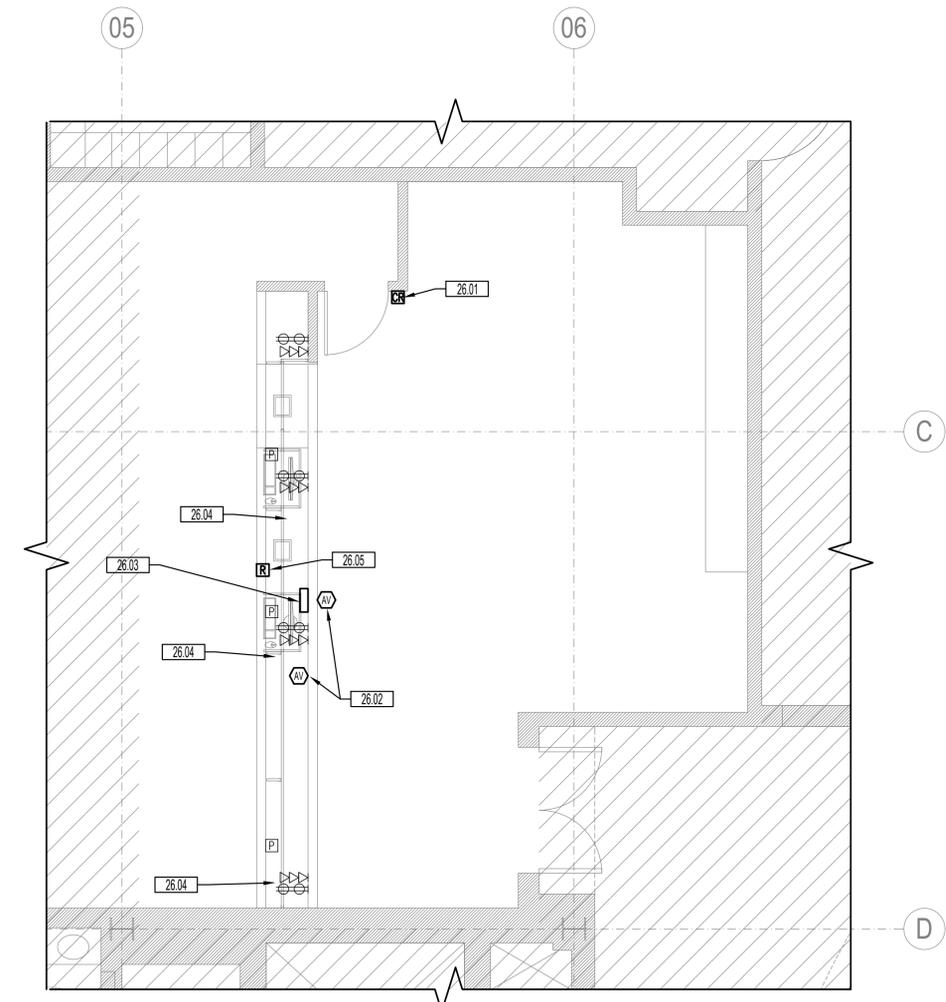

**2ND LEVEL PARTIAL NEW WORK POWER AND SYSTEM PLAN  
US. BANKRUPTCY CLERK'S OFFICE RECEPTION DESK**  
SCALE: 1/4"=1'-0" NORTH

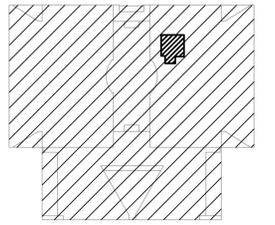

U.S. COURTHOUSE, 5400 FEDERAL PLAZA, HAMMOND, IN 46320-1839

KEYPLAN  
2ND FLOOR N.T.S.  
NORTH

signature  
10/28/2022  
date  
license expires on 07-31-2023

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60601-2308

MARK	DESCRIPTION	DATE
	100% CD	10.28.22


GENERAL SERVICE ADMINISTRATION REGION 5 CHICAGO, IL	
BUILDING NAME	U.S. COURTHOUSE, 5400 FEDERAL PLAZA, HAMMOND, IN 46320-1839
BUILDING CITY/STREET/ZIP	(IN0300ZZ)
BUILDING NO.	
OTHER BUILDING NOS.	
PROJECT DESCRIPTION	USDC & USBC TRANSACTION WINDOWS
PROJECT NO.	17005 - 020019 - 00
DRAWING TITLE	POWER AND SYSTEM PLANS
TYPE	ELECTRICAL
FILE NAME	E113
FLOOR NO.	
DRAWN BY	JPB SHEET SIZE: 24 X 36
CHECKED BY	KWL DATE: 10.28.22
DRAWING NO.	E113
SHEET	20 OF 21

**SHEET NOTES**


- E.C. TO COORDINATE CLOSELY WITH COMMUNICATIONS AND SECURITY CONTRACTORS AND PROVIDE INFRASTRUCTURE ONLY (CONDUIT WITH PULL STRING AND BACK BOXES) FOR COMMUNICATIONS, AND SECURITY SYSTEMS. E.C. SHALL STUB CONDUITS INTO ACCESSIBLE CEILING SPACE THROUGH THE NEAREST FEASIBLE WALL AND PROVIDE RACEWAYS IN THE MILLWORK IN COORDINATION WITH MILLWORK CONTRACTOR. COMMUNICATIONS CONTRACTOR SHALL PROVIDE EQUIPMENT, HORIZONTAL CABLING AND COMMUNICATIONS OUTLETS ON A SEPARATE CONTRACT. SECURITY CONTRACTOR SHALL PROVIDE SECURITY EQUIPMENT, SECURITY DEVICES AND WIRING ON A SEPARATE CONTRACT.
- COMMUNICATIONS AND SECURITY WIRING MAY BE RUN EXPOSED IN THE ACCESSIBLE CEILING OF TENANT'S SPACE. ANY WIRING OR HORIZONTAL CABLING OUTSIDE OF TENANT'S SPACE BEGINNING AT LEAST 3 FEET PRIOR TO LEAVING SUCH SPACE SHALL BE IN CONDUIT. REFER ALSO TO SHEET E200 FOR ADDITIONAL INFORMATION ON CONDUIT ROUTES.
- COORDINATE ALL WORK WITH ARCHITECTURAL DRAWINGS AND ELEVATIONS.
- ALL WORK AND MODIFICATIONS TO THE SECURITY SYSTEM SHALL BE PERFORMED BY ONE OF THE VENDORS APPROVED BY USMS. SEE LIST ON SHEET E000.
- ELECTRICAL CONTRACTOR TO CONFIRM WITH TENANT IF THERE IS ADDITIONAL REMOTE RELEASE REQUIRED. PROVIDE INFRASTRUCTURE AS REQUIRED.

**KEYNOTES**


- 02.01 EXISTING CARD READER TO BE REMOVED AND TO BE REPLACED WITH NEW.
- 02.02 EXISTING DATA AND POWER OUTLETS TO REMAIN.
- 02.03 EXISTING DURESS BUTTON TO BE RELOCATED AS REQUIRED FOR THE ADA REQUIRED MODIFICATION OF COUNTER.
- 02.04 EXISTING DATA & POWER OUTLETS TO BE LOWERED IN-LINE WITH THE ADA-REQUIRED MODIFICATION OF COUNTER.
- 02.05 EXISTING DURESS BUTTON TO REMAIN.
- 26.01 PROVIDE NEW REPLACEMENT CARD READER.
- 26.02 PROVIDE NEW GROMMET(S) FOR DATA AND POWER WIRING AS REQUIRED. COORDINATE WITH MILLWORK.
- 26.03 PROVIDE CONDUIT PROVISION WITH PULL STRING ON THE NEAREST WALL STUBBED UP INTO ACCESSIBLE CEILING SPACE FOR NEW REMOTE DOOR RELEASE. COORDINATE WITH TENANT AND MILLWORK EXACT LOCATION OF DEVICE AND ROUTE OF CONDUITS.
- 26.04 REINSTALL/RELOCATE UNDERCOUNTER DURESS BUTTON IN-LINE WITH NEW MODIFIED COUNTER. COORDINATE INSTALLATION WITH MILLWORK AND TENANT AND EXTEND RACEWAY AS REQUIRED.
- 26.05 REINSTALL/RELOCATE DATA & POWER OUTLETS IN-LINE WITH NEW MODIFIED COUNTER. COORDINATE INSTALLATION WITH MILLWORK AND TENANT.
- 26.06 E.C. TO CONFIRM WITH TENANT THAT THE CREDIT CARD MACHINE IS POWERED OVER ETHERNET (POE) USING A USB CABLE PLUGGED INTO THE COMPUTER SO THAT A GROMMET (LOCATION TO BE COORDINATED WITH TENANT AND ARCHITECT) FOR THIS CABLE SHALL BE PROVIDED. OTHERWISE, PROVIDE ADDITIONAL DUPLEX OUTLET BELOW COUNTER FOR THE POWER OF THE CREDIT CARD MACHINE.

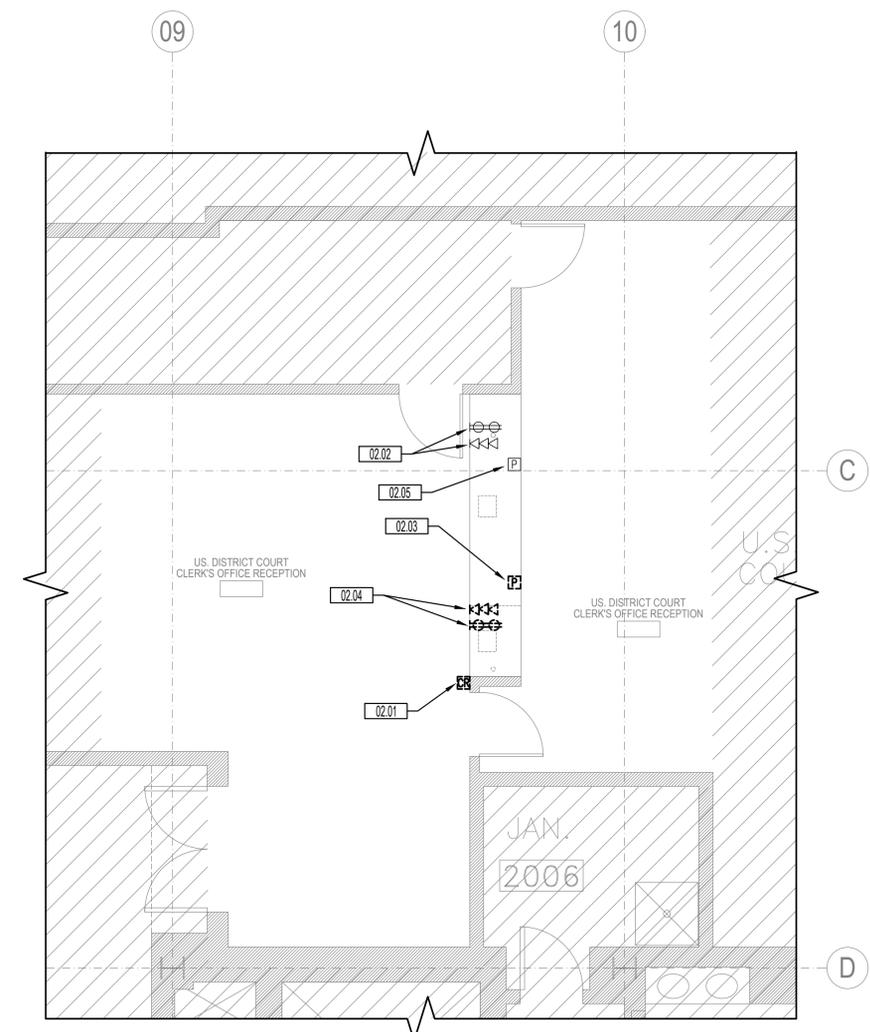

1 2ND LEVEL PARTIAL DEMO POWER AND SYSTEM PLAN  
US. DISTRICT COURT CLERK'S OFFICE RECEPTION DESK  
SCALE: 1/4"=1'-0"  
0 2' 4' 8'  
SCALE: 1/4"=1'-0" NORTH

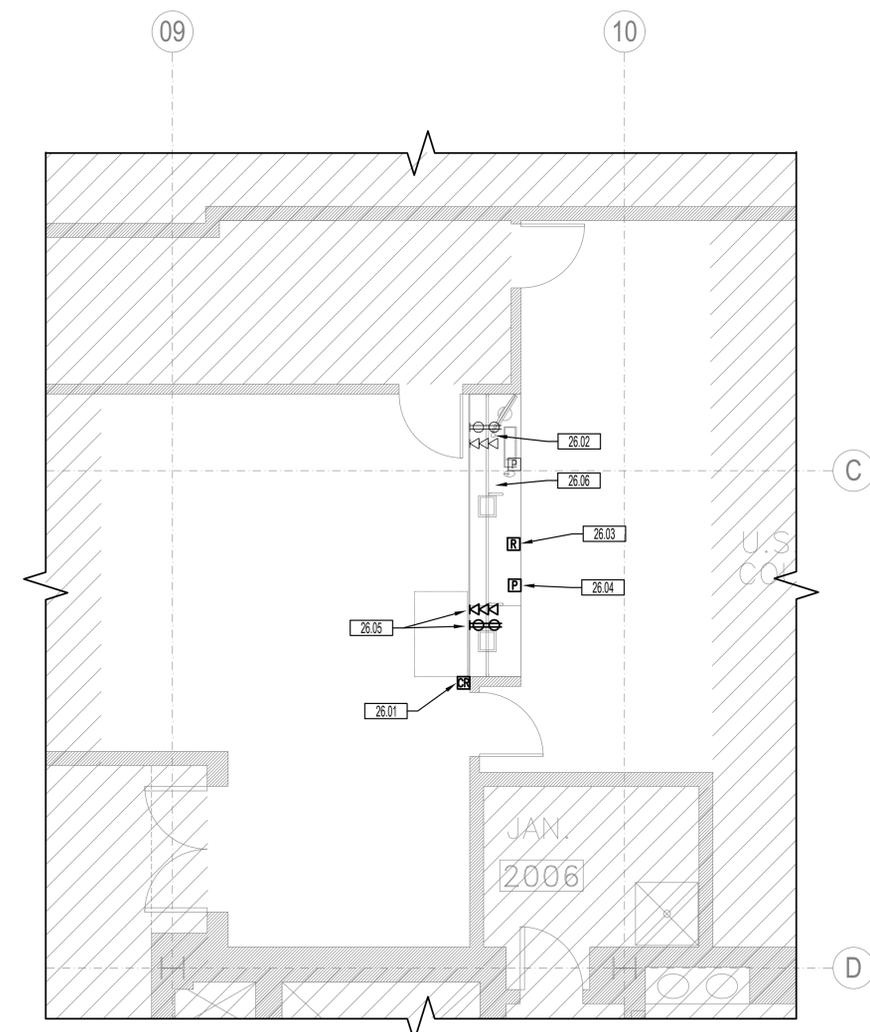

1 2ND LEVEL PARTIAL NEW WORK POWER AND SYSTEM PLAN  
US. DISTRICT COURT CLERK'S OFFICE RECEPTION DESK  
SCALE: 1/4"=1'-0"  
0 2' 4' 8'  
SCALE: 1/4"=1'-0" NORTH

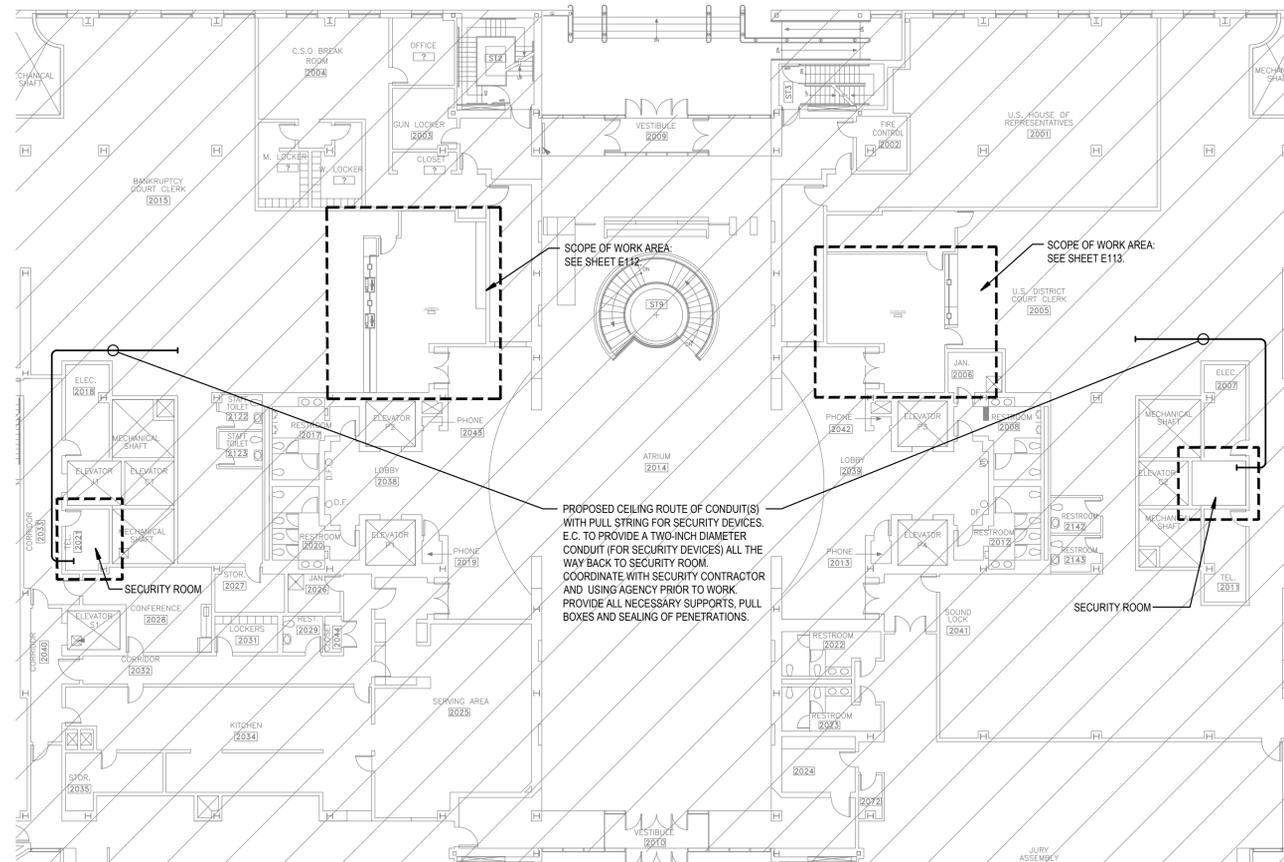

1 U.S. COURTHOUSE  
 5400 FEDERAL PLAZA, HAMMOND, IN 46320-1839  
 SCALE: 1/16"=1'-0"



*Keith W. Locke, Jr.*  
 signature  
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 date  
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 Chicago, IL  
 60601-2308

MARK	DESCRIPTION	DATE
	100% CD	10.28.22

GENERAL SERVICE ADMINISTRATION  
 REGION 5 CHICAGO, IL

BUILDING	NAME	U.S. COURTHOUSE,		
	STREET	5400 FEDERAL PLAZA, HAMMOND, IN		
	CITY/STREET/ZIP	46320-1839		
	BUILDING NO.	(IN0300ZZ)		
P.C.T.	OTHER BUILDING NOS.			
	PROJECT DESCRIPTION	USDC & USBC TRANSACTION WINDOWS		
	PROJECT NO.	17005 - 020019 - 00		
	DRAWING TITLE	ELECTRICAL CONDUIT ROUTE PLANS		
DRAWING	TYPE			
	FILE NAME	E200		
	FLOOR NO.			
	DRAWN BY	JPB	SHEET SIZE: 24 X 36	
	CHECKED BY	KWL	DATE: 10.28.22	
	DRAWING NO.	E200		
SHEET 21 OF 21				