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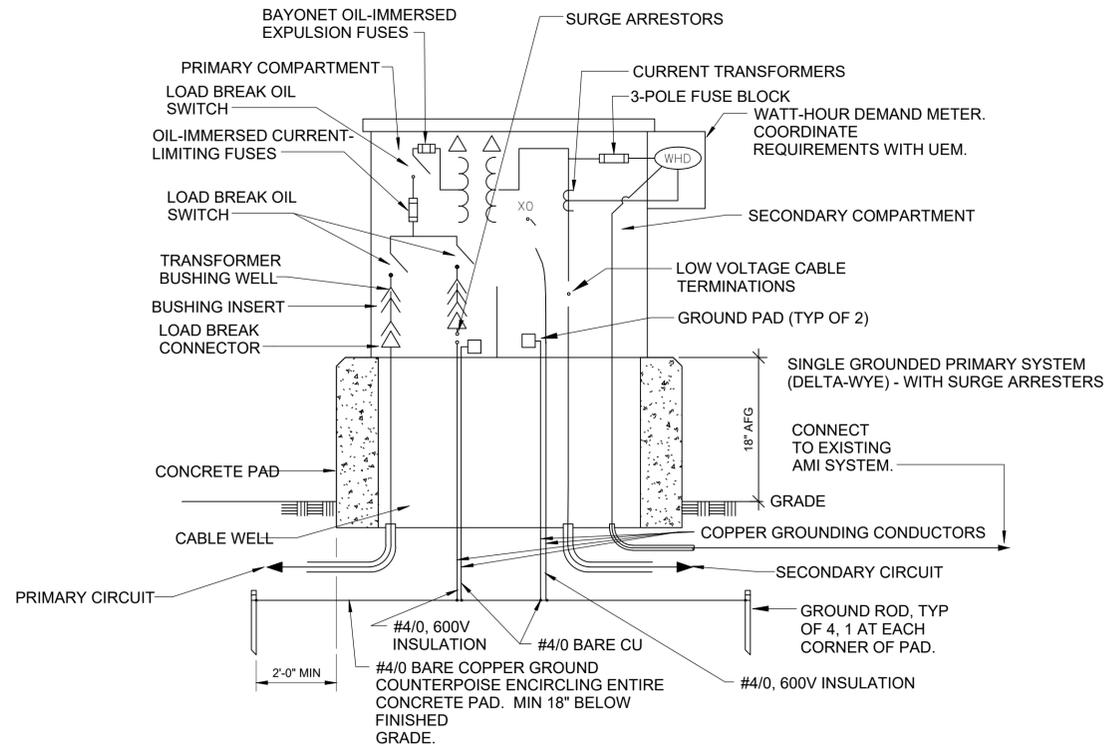
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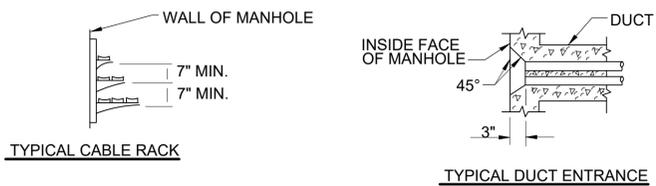
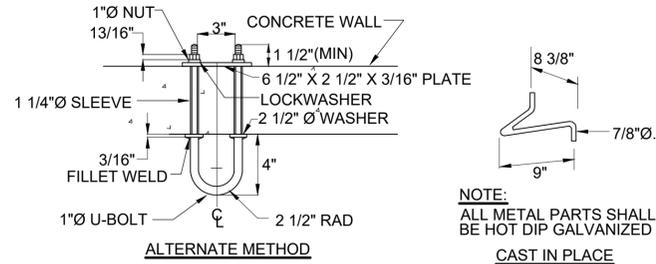
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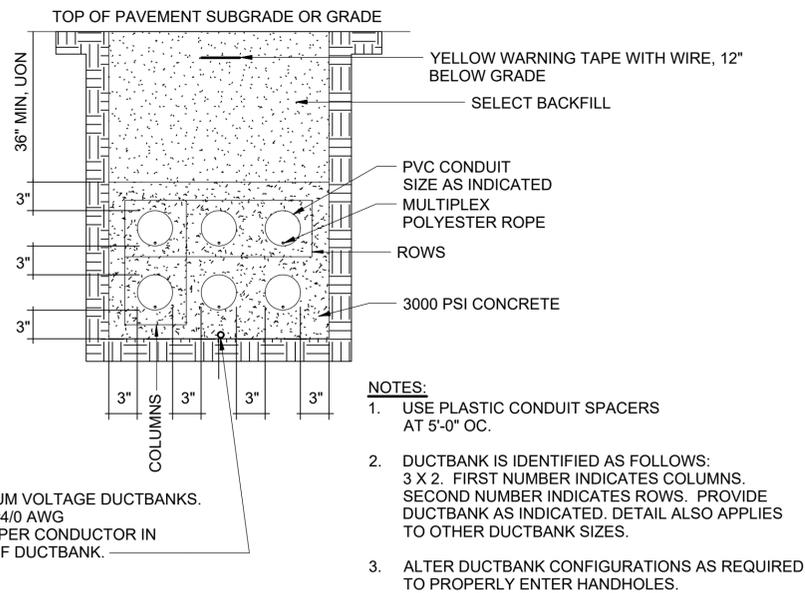
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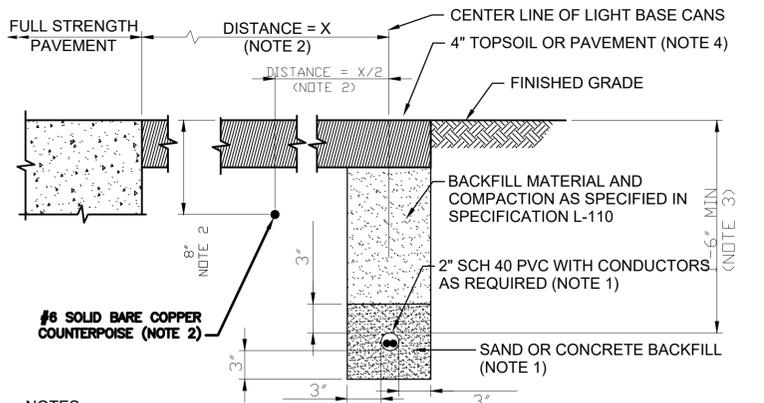
C1 THREE PHASE PAD-MOUNTED TRANSFORMER
NOT TO SCALE



C3 PULLING-IN IRONS, CABLE RACK AND DUCT ENTRANCE
NOT TO SCALE




A1 TYPICAL CONCRETE ENCASED DUCT BANK
NOT TO SCALE



- NOTES:**
- SEE PLANS FOR NUMBER OF CONDUITS TO BE PROVIDED WHERE DUCTS ARE UNDER FULL STRENGTH PAVEMENT. WHERE TWO OR MORE CONDUITS ARE INSTALLED IN ONE TRENCH, PROVIDE PLASTIC CONDUIT SPACERS AT 5' OC LONGITUDINALLY TO ENSURE UNIFORM SPACING BETWEEN CONDUITS. ENSURE SPACERS ARE SECURED IN TRENCH TO PREVENT MISALIGNMENT. CONDUITS MAY BE SPACED VERTICALLY OR HORIZONTALLY. SPACING BETWEEN CONDUITS SHALL BE 3" MINIMUM WITH A 3" THICKNESS OF CONCRETE SURROUNDING THE GROUP OF CONDUITS AS SHOWN. PROVIDE MINIMUM CONDUIT SLOPE OF 0.5 PERCENT WHERE POSSIBLE.
 - ENSURE COUPLINGS OF ADJACENT CONDUITS ARE STAGGERED A MINIMUM OF 12" APART FOR CONDUITS 2" DIAMETER OR SMALLER AND 24" APART FOR CONDUITS LARGER THAN 2" DIAMETER.
 - ENSURE ALL EMPTY DUCTS OVER 15' IN LENGTH ARE PROVIDED WITH A 200 LB. TENSILE STRENGTH POLYPROPYLENE PULL ROPE.
 - CONDUITS MAY BE PLACED IN A SINGLE LAYER WHEN NECESSARY TO MEET VERTICAL CLEARANCES.

A3 TYPICAL EDGE CONDUIT DUCTBANK

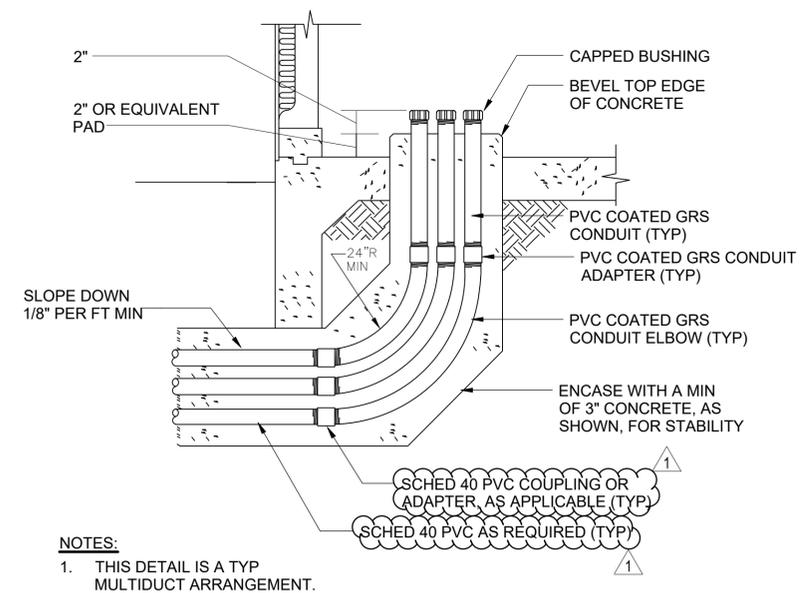

A4 TYPICAL CONCRETE ENCASED DUCT BANK RISER

DATE	APPR
04/15/2023	
9/26/2022	
SYM	DESCRIPTION
1	AMENDMENT 005
0	ISSUE FOR CONSTRUCTION

COMMONWEALTH OF VIRGINIA
JIMMY CLARK HIGGINS
Lic. No. 0402057076
9/26/2022
PROFESSIONAL ENGINEER

WileyWilson | BURNS & MCDONNELL
JOINT VENTURE

APPROVED

FOR COMMANDER NAVFAC

ACTIVITY

SATISFACTORY TO DATE

DES: JCH DRW: JCH CHK: PO

PM/CM

BRANCH MANAGER

CHIEF ENGINEER

FIRE PROTECTION

NAVFACILITIES ENGINEERING COMMAND
WASHINGTON WASHINGTON DC
NAVAL FACILITIES ENGINEERING COMMAND - WASHINGTON WASHINGTON DC
CAMP SPRINGS, MD
JOINT BASE ANDREWS NAVAL AIR FACILITY
P-3002 RELOCATE HAZARDOUS CARGO PAD AND EOD PROFICIENCY RANGE
ELECTRICAL DETAILS

SCALE: AS NOTED
PROJECT NO: 1396650
CONSTR. CONTR. NO: N40080-15-D-0452
NAVFAC DRAWING NO: 13132535
SHEET 190 OF 212
E-504
DRAWING REVISION: 06 APRIL 2017

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