
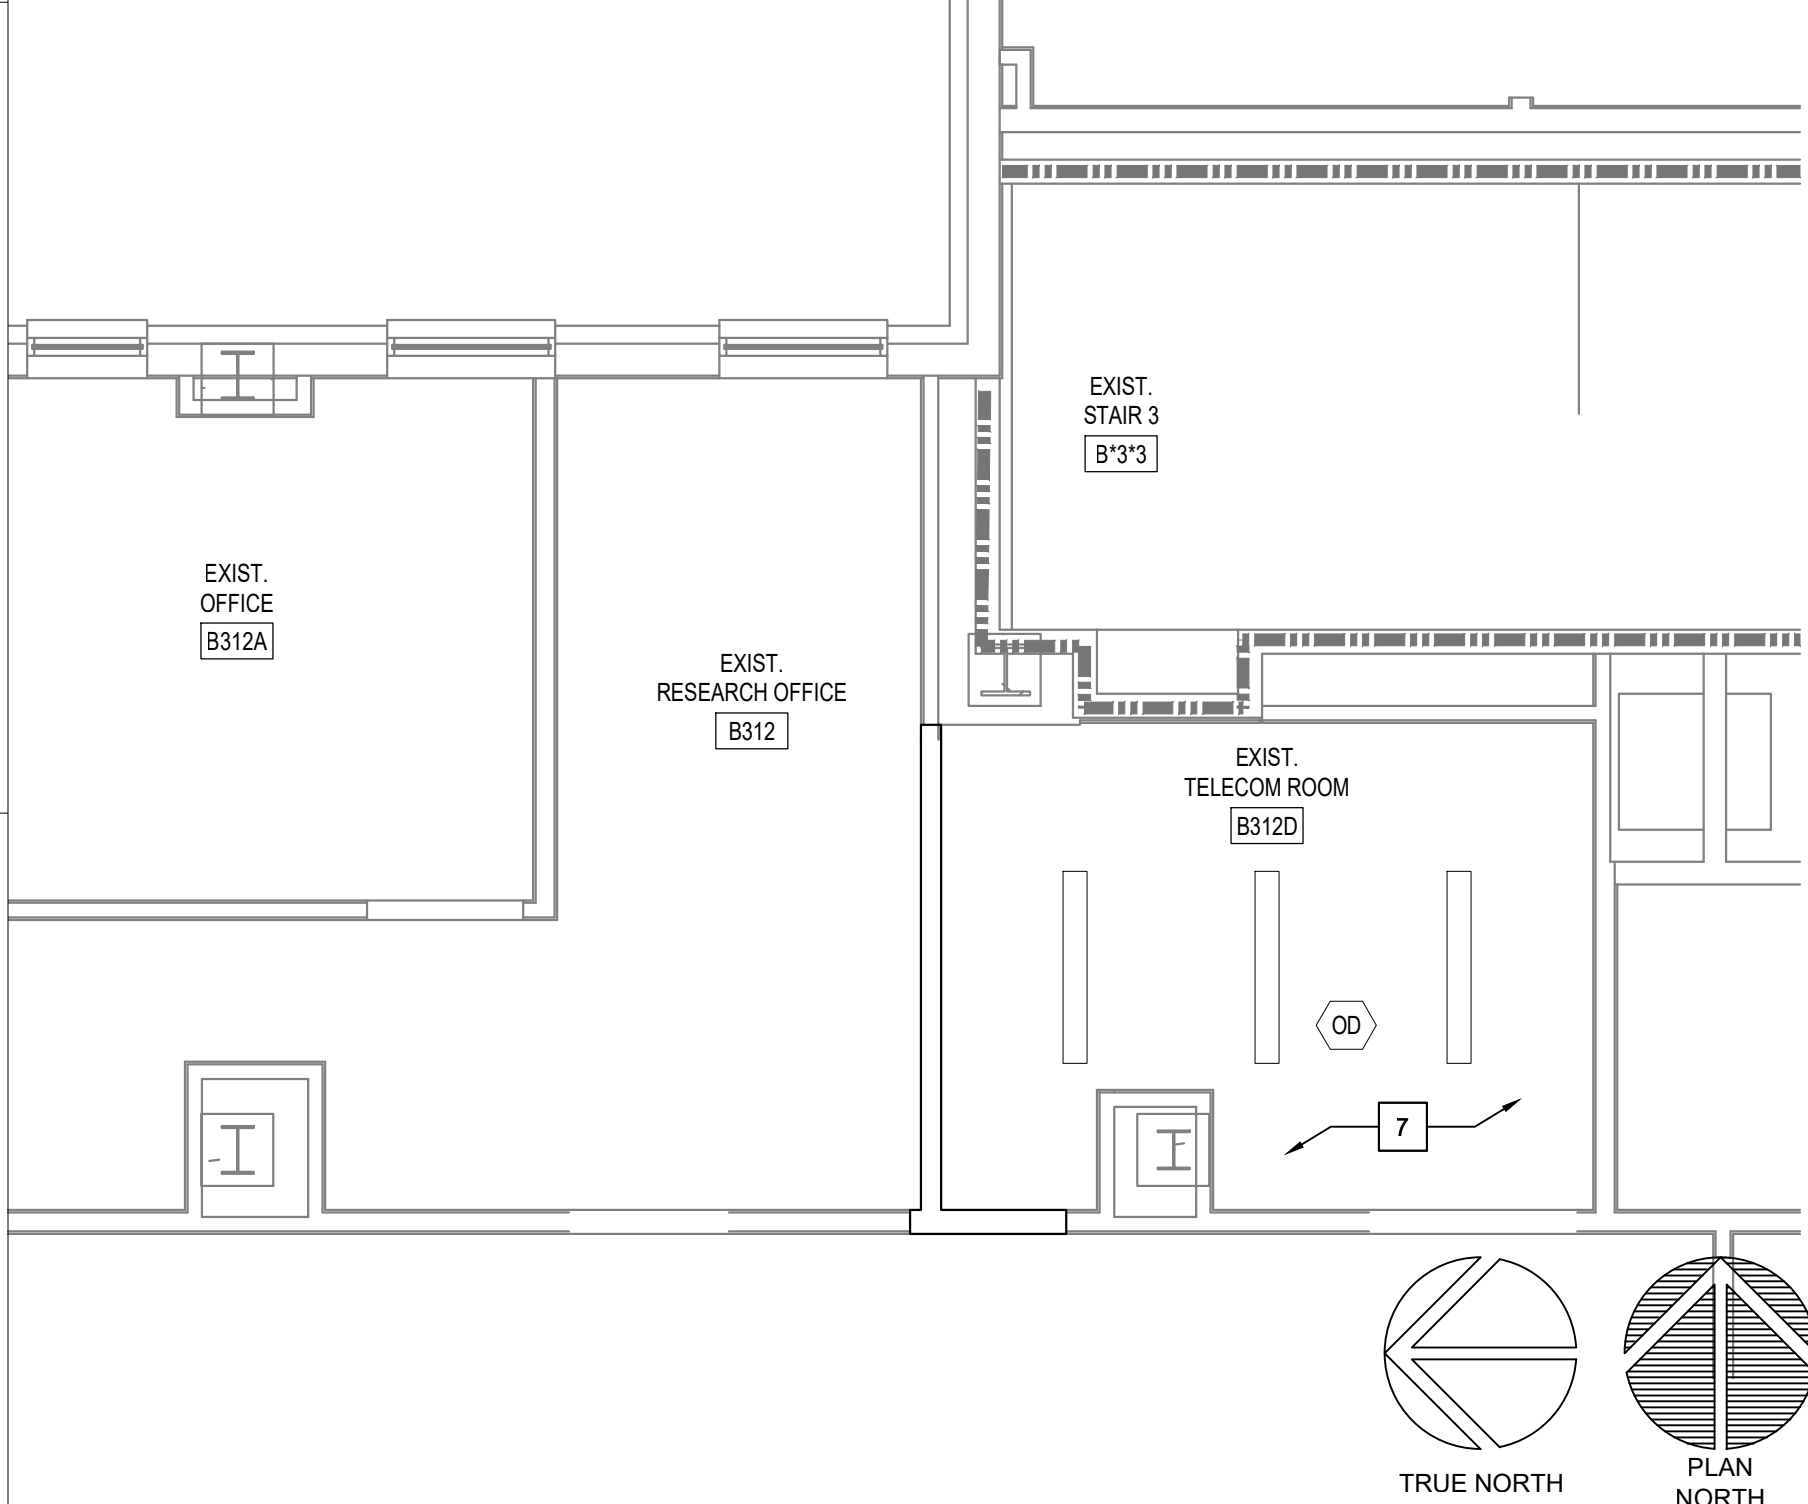


1 EXISTING TELECOM ROOM B312D - ROOM RENOVATION  
SCALE: 1/4" = 1'-0"

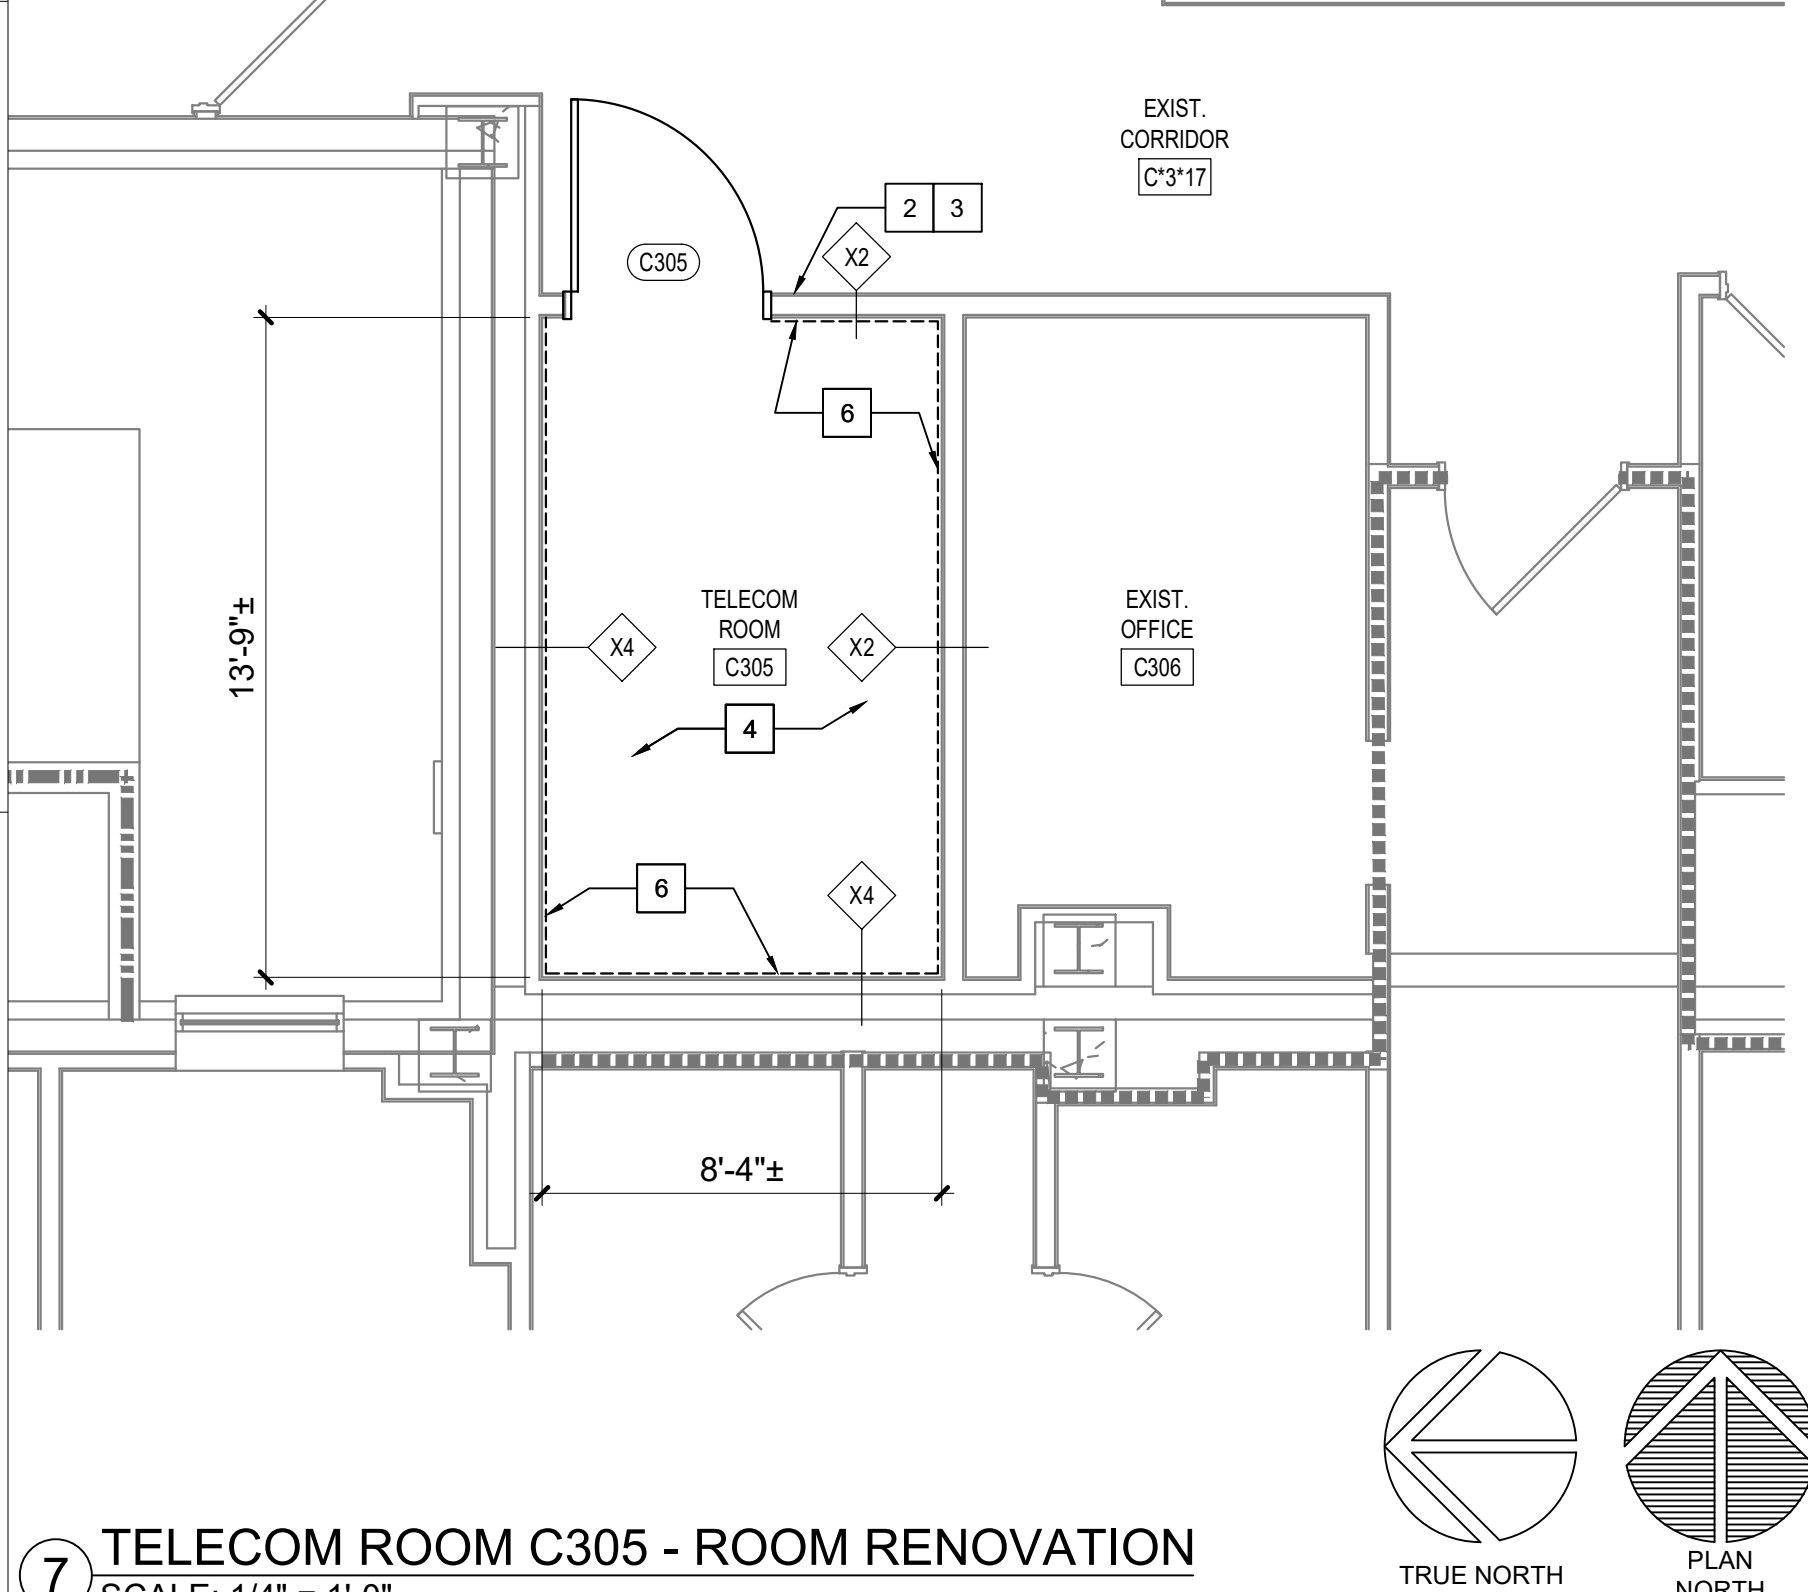


2 EXISTING TELECOM ROOM B312D - CEILING RENOVATION  
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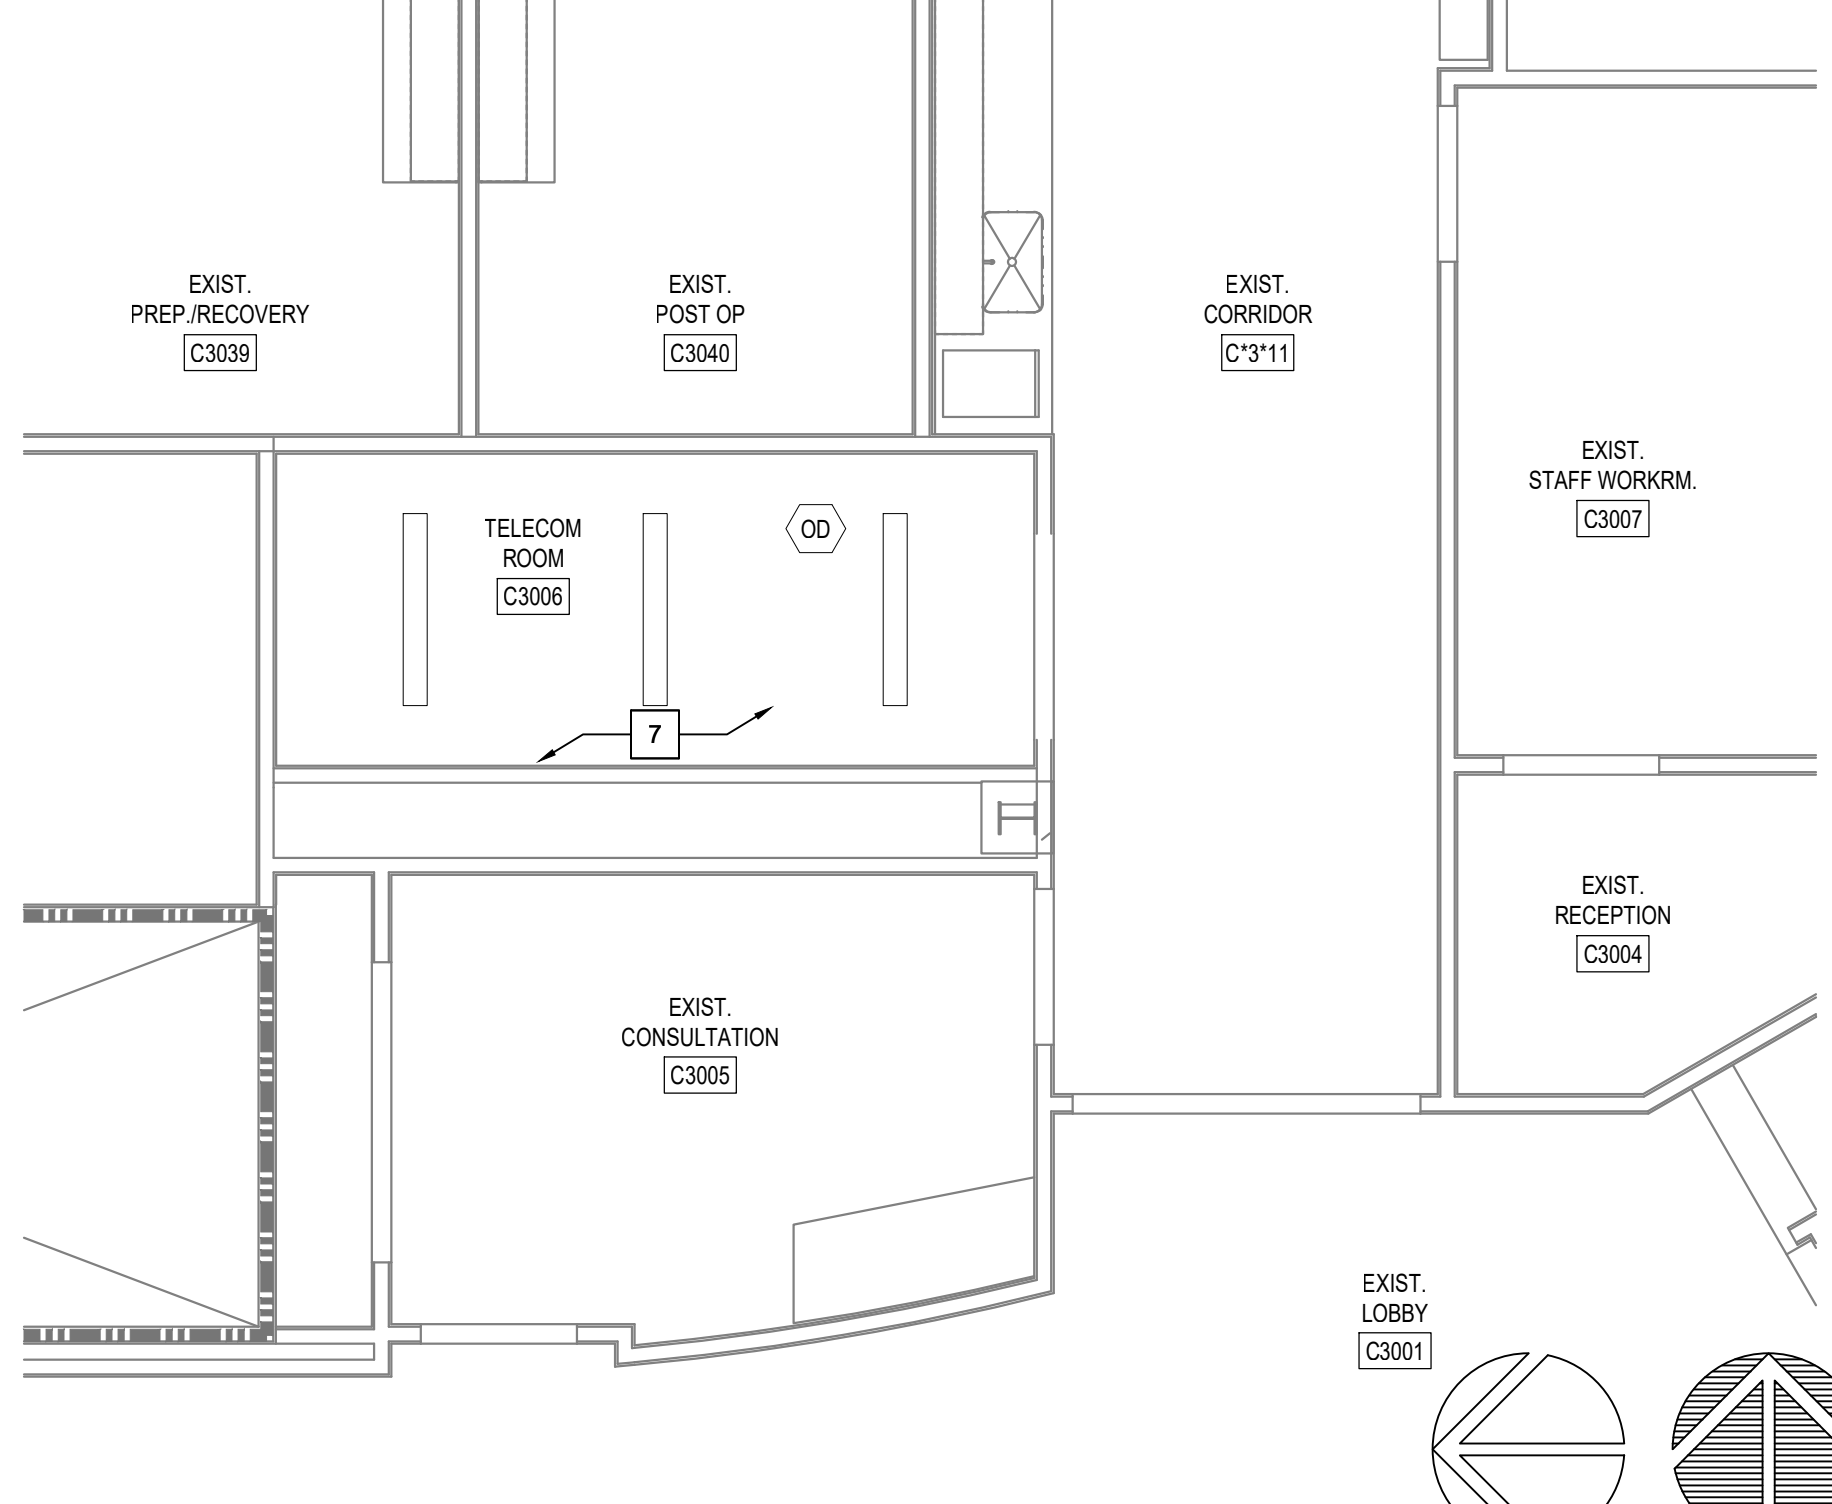


7 TELECOM ROOM C305 - ROOM RENOVATION  
SCALE: 1/4" = 1'-0"


Revisions:	Date:

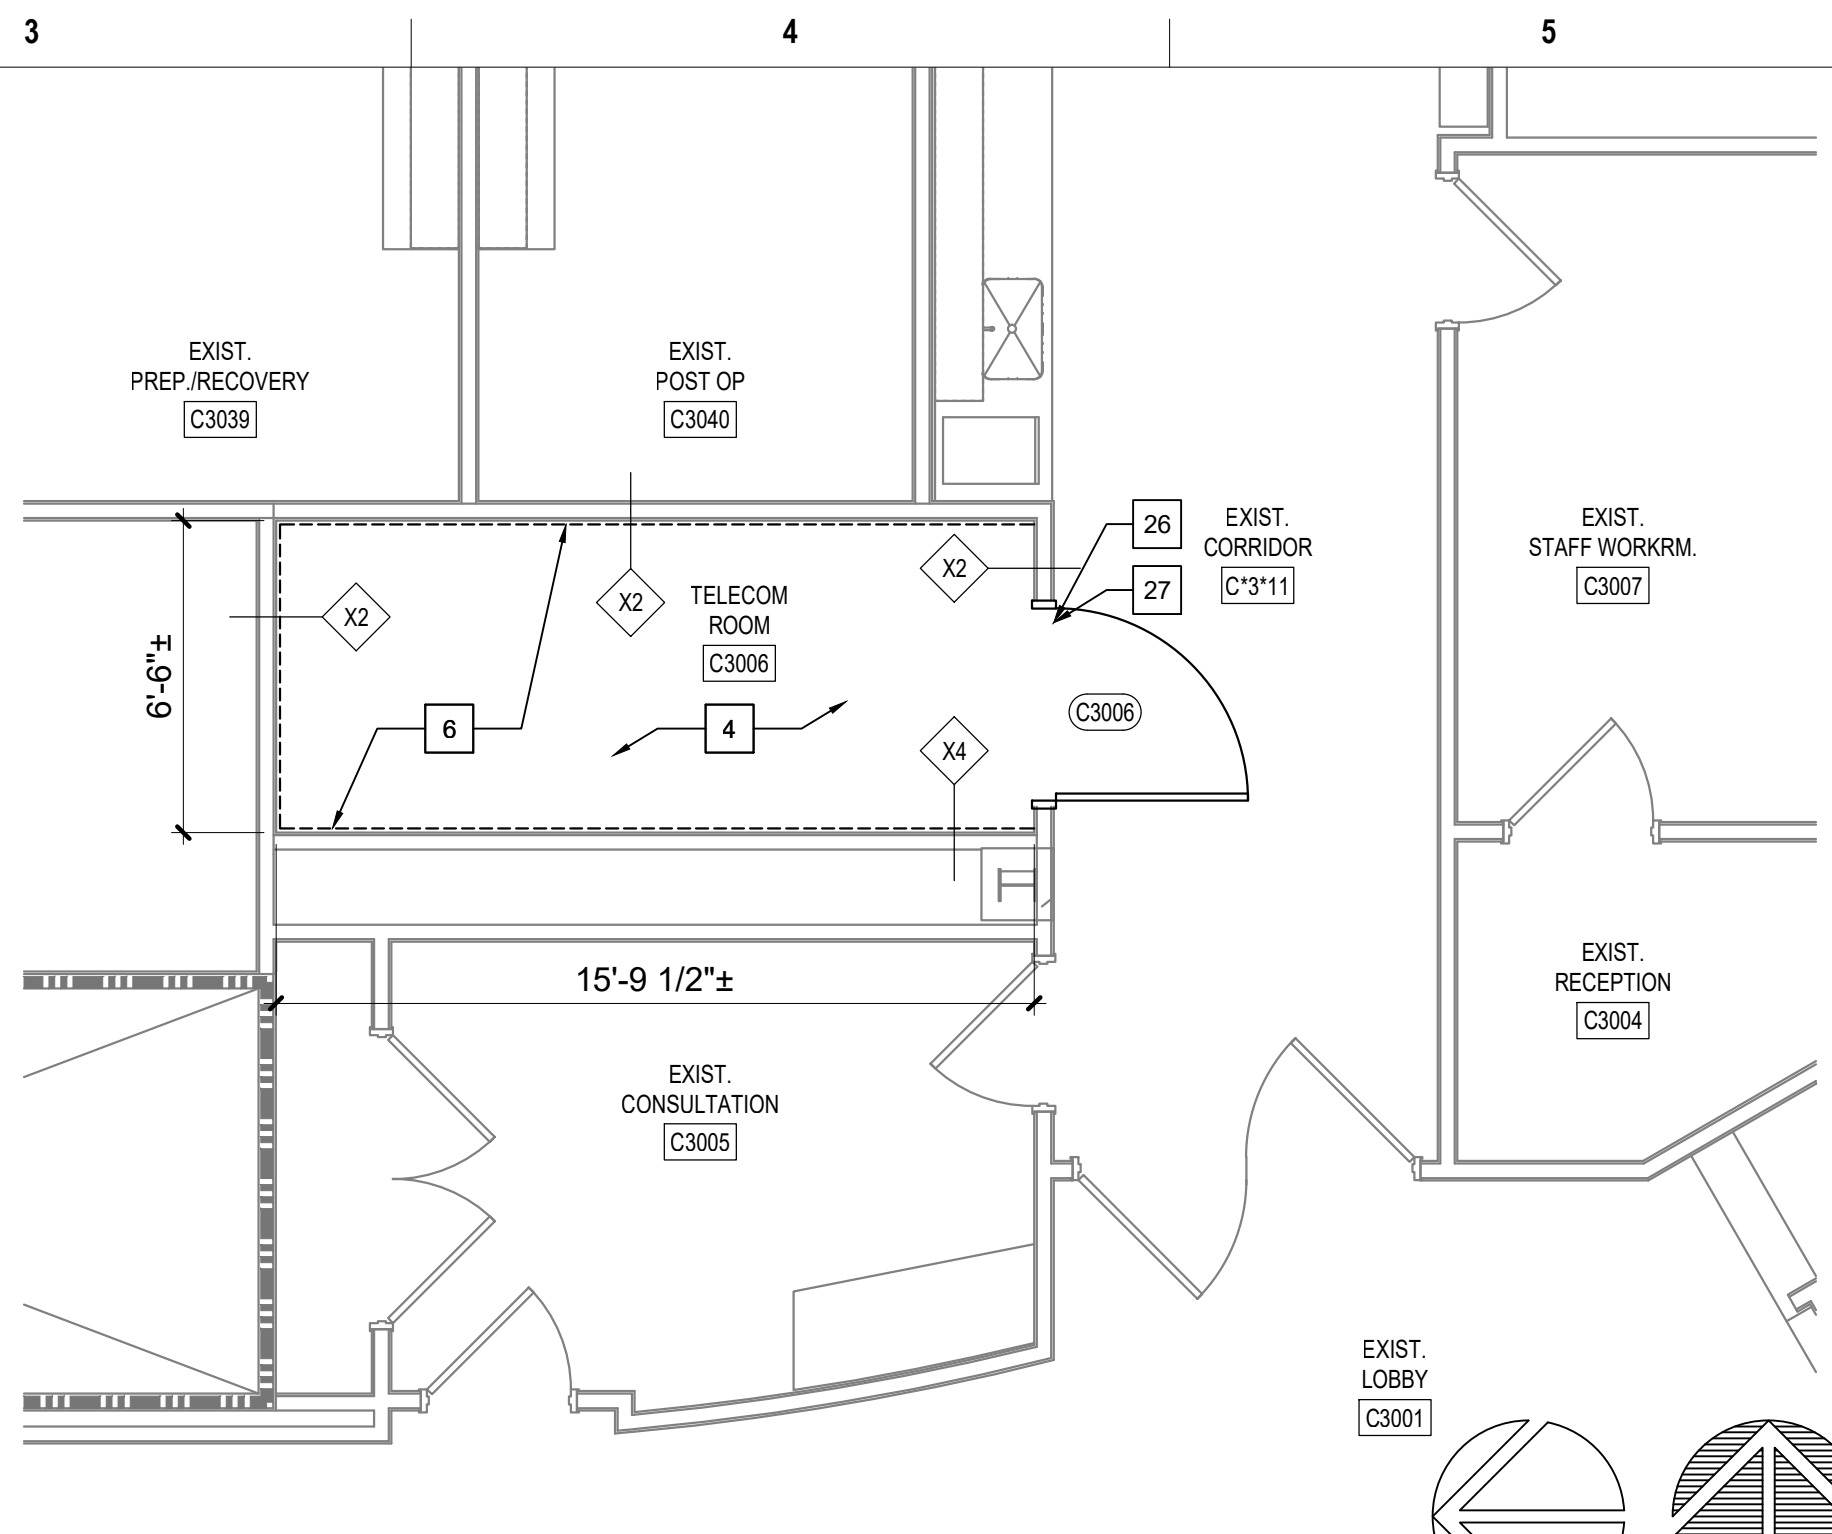

3 TELECOM ROOM C3006 - ROOM RENOVATION  
SCALE: 1/4" = 1'-0"



4 TELECOM ROOM C3006 - CEILING RENOVATION  
SCALE: 1/4" = 1'-0"

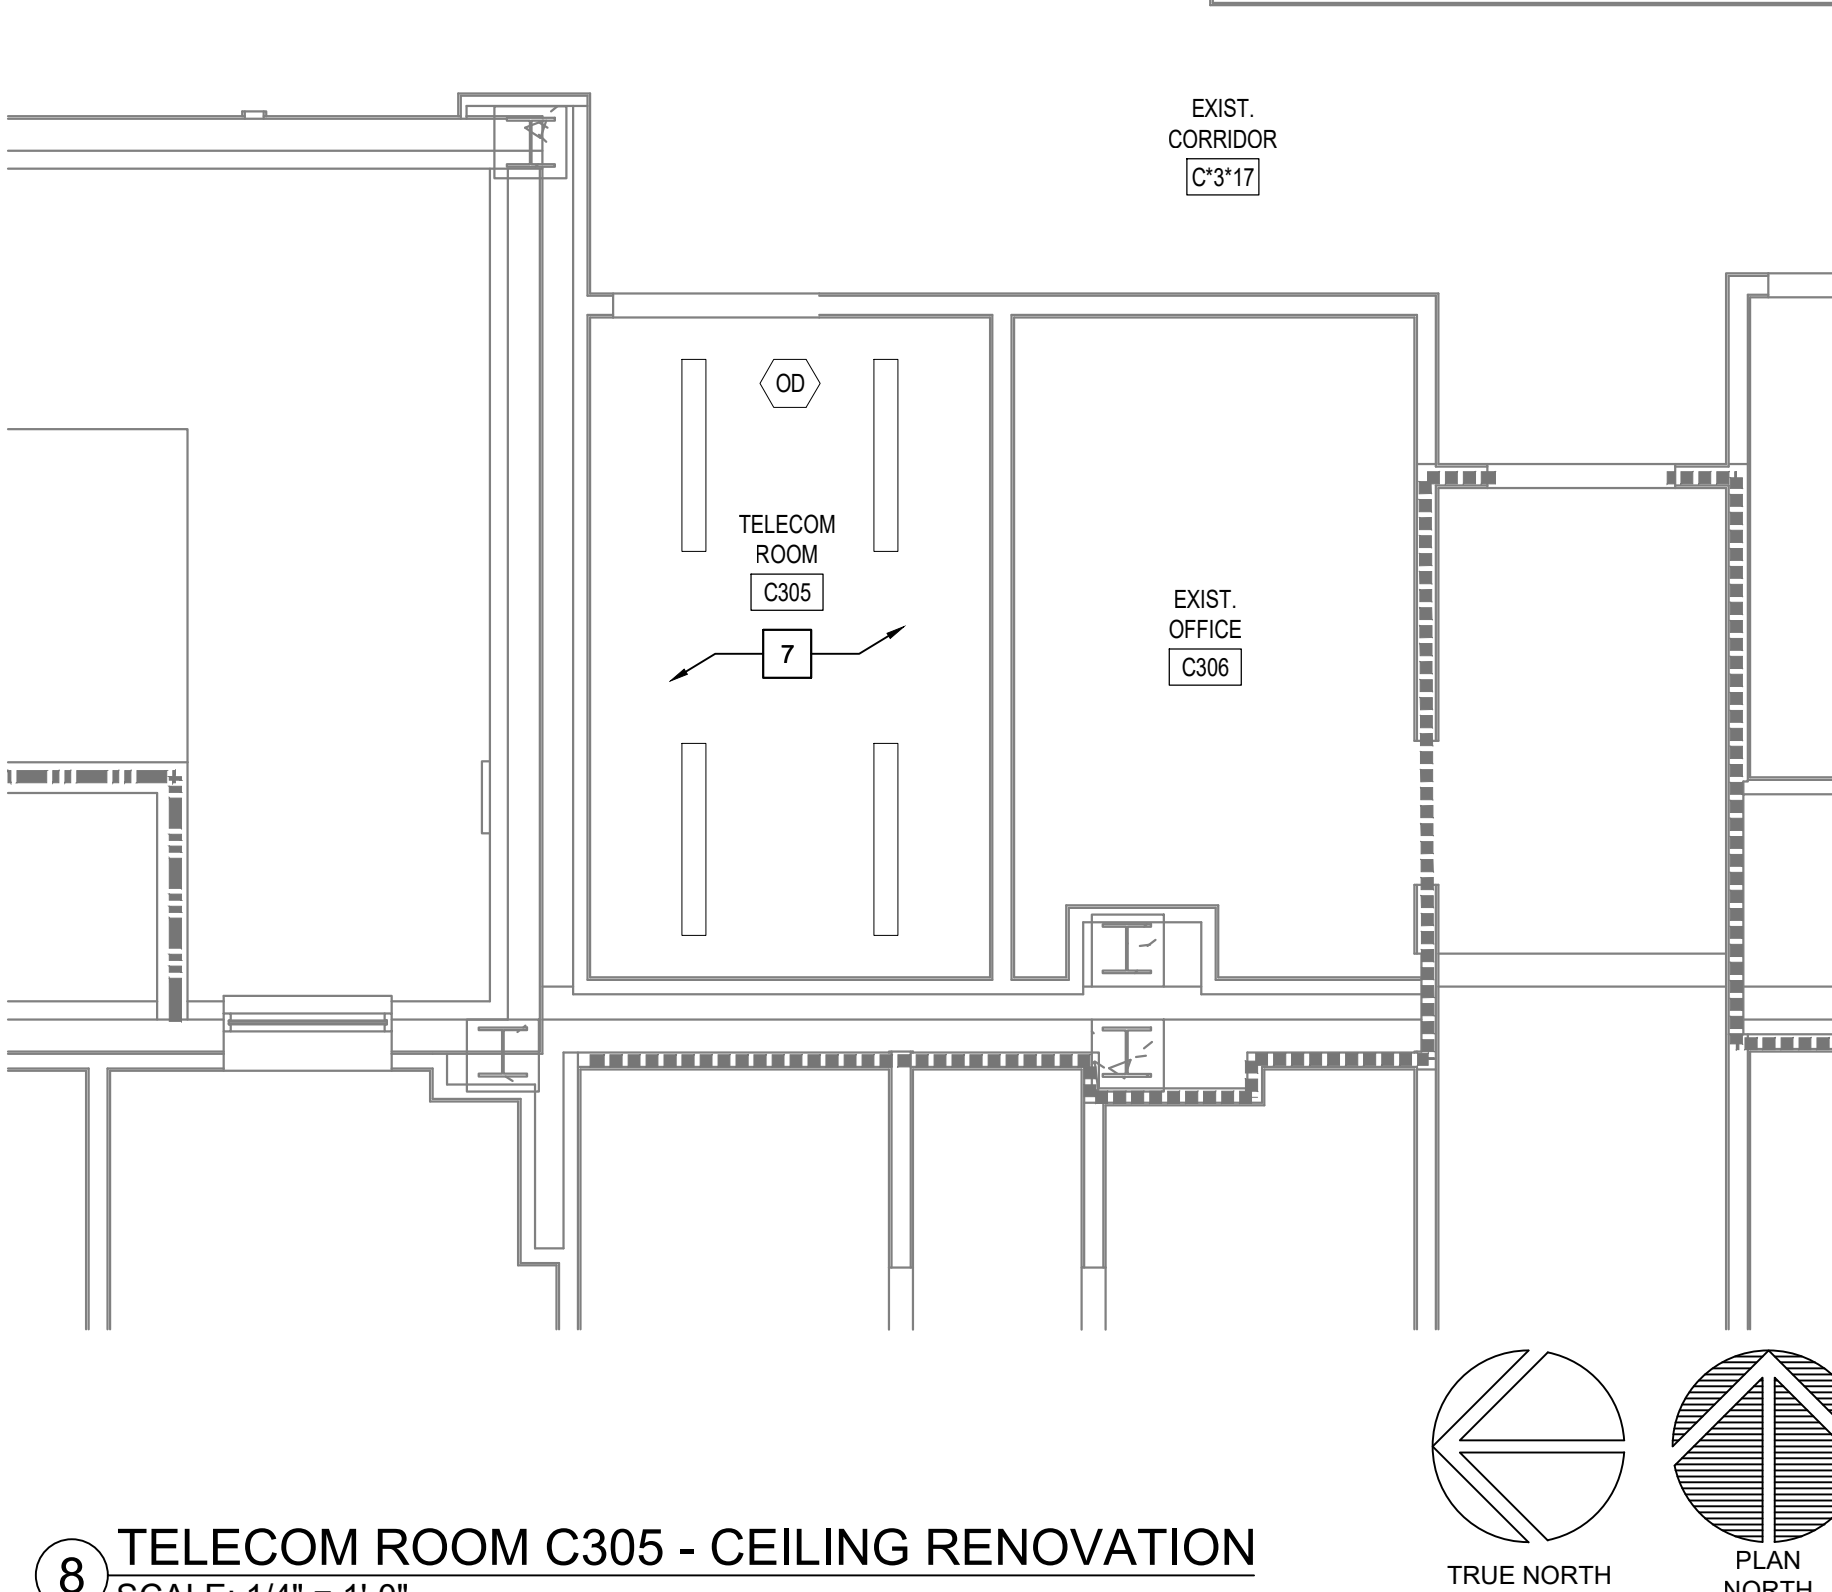

8 TELECOM ROOM C305 - CEILING RENOVATION  
SCALE: 1/4" = 1'-0"

**CONSULTANT**

**HFS**

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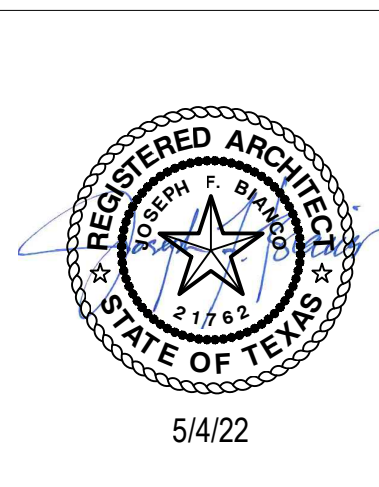
**PROJECT MANAGEMENT**

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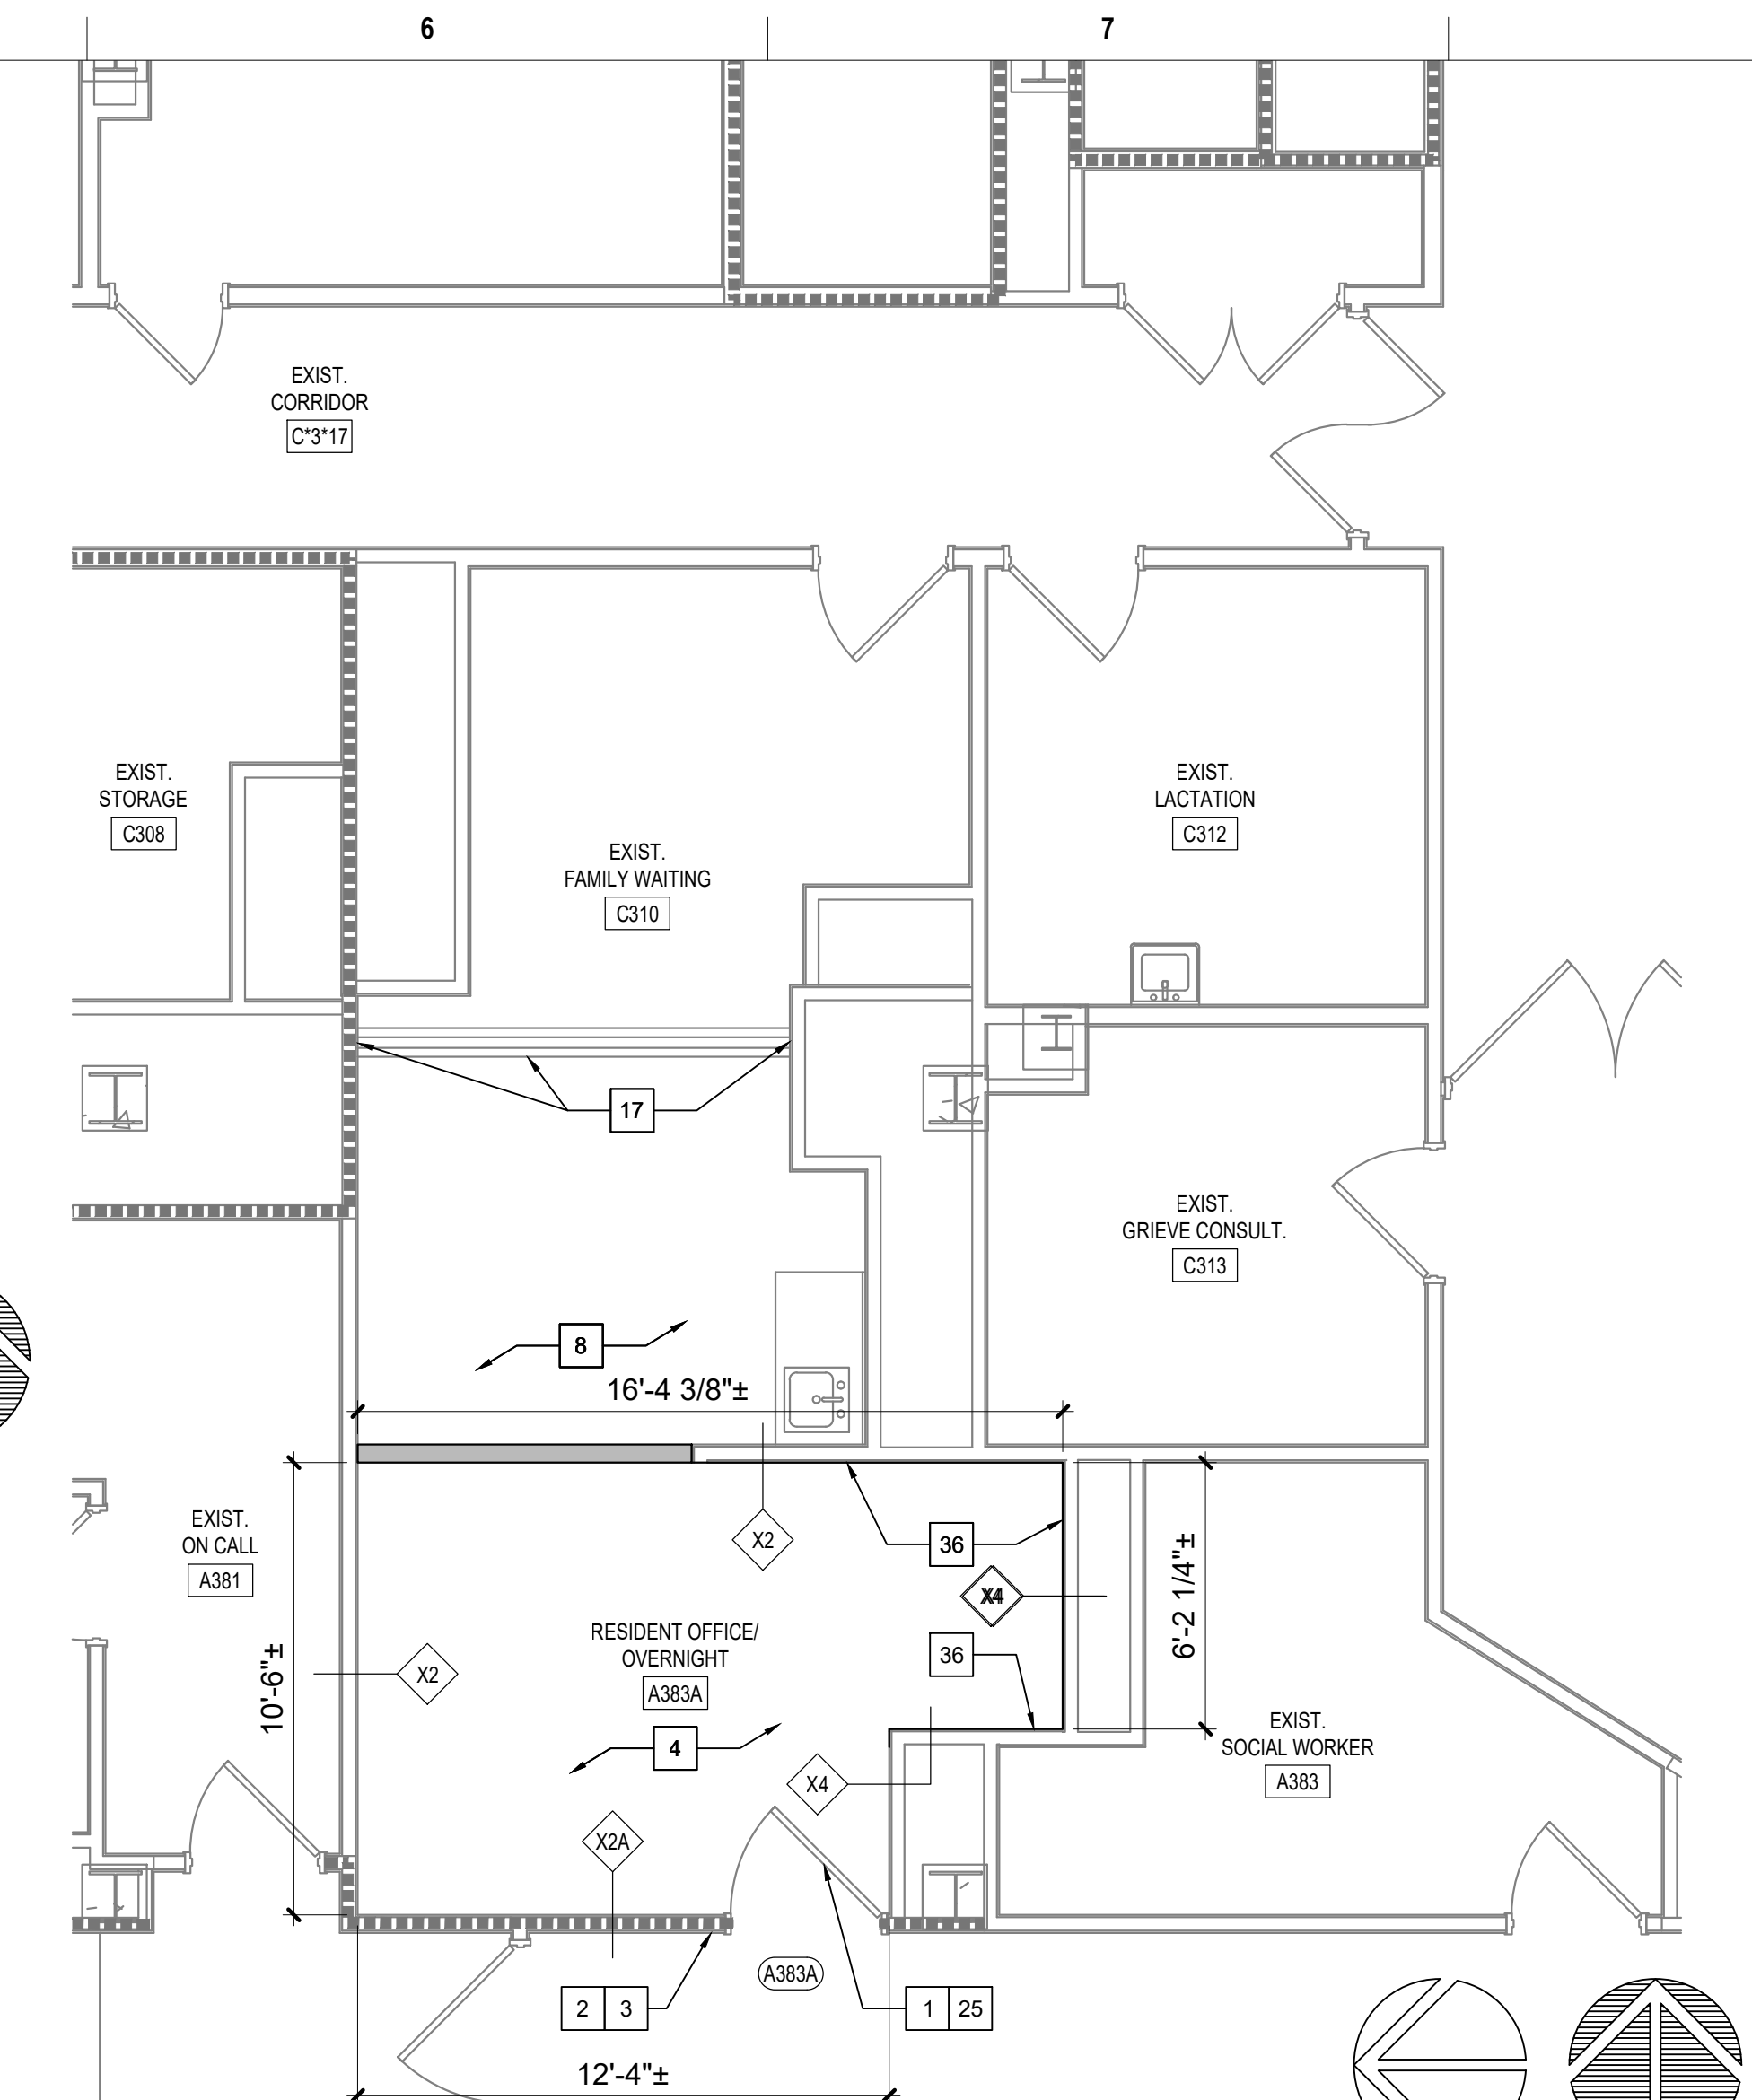


**Construction and Facilities Management**


**VA** U.S. Department of Veterans Affairs

Drawing Title  
**ENLARGED FLOOR PLANS - 3RD FLOOR RENOVATION**

Approved: Project Director



5 RESIDENT OFFICE/OVERNIGHT A383A- ROOM RENOVATION  
SCALE: 1/4" = 1'-0"

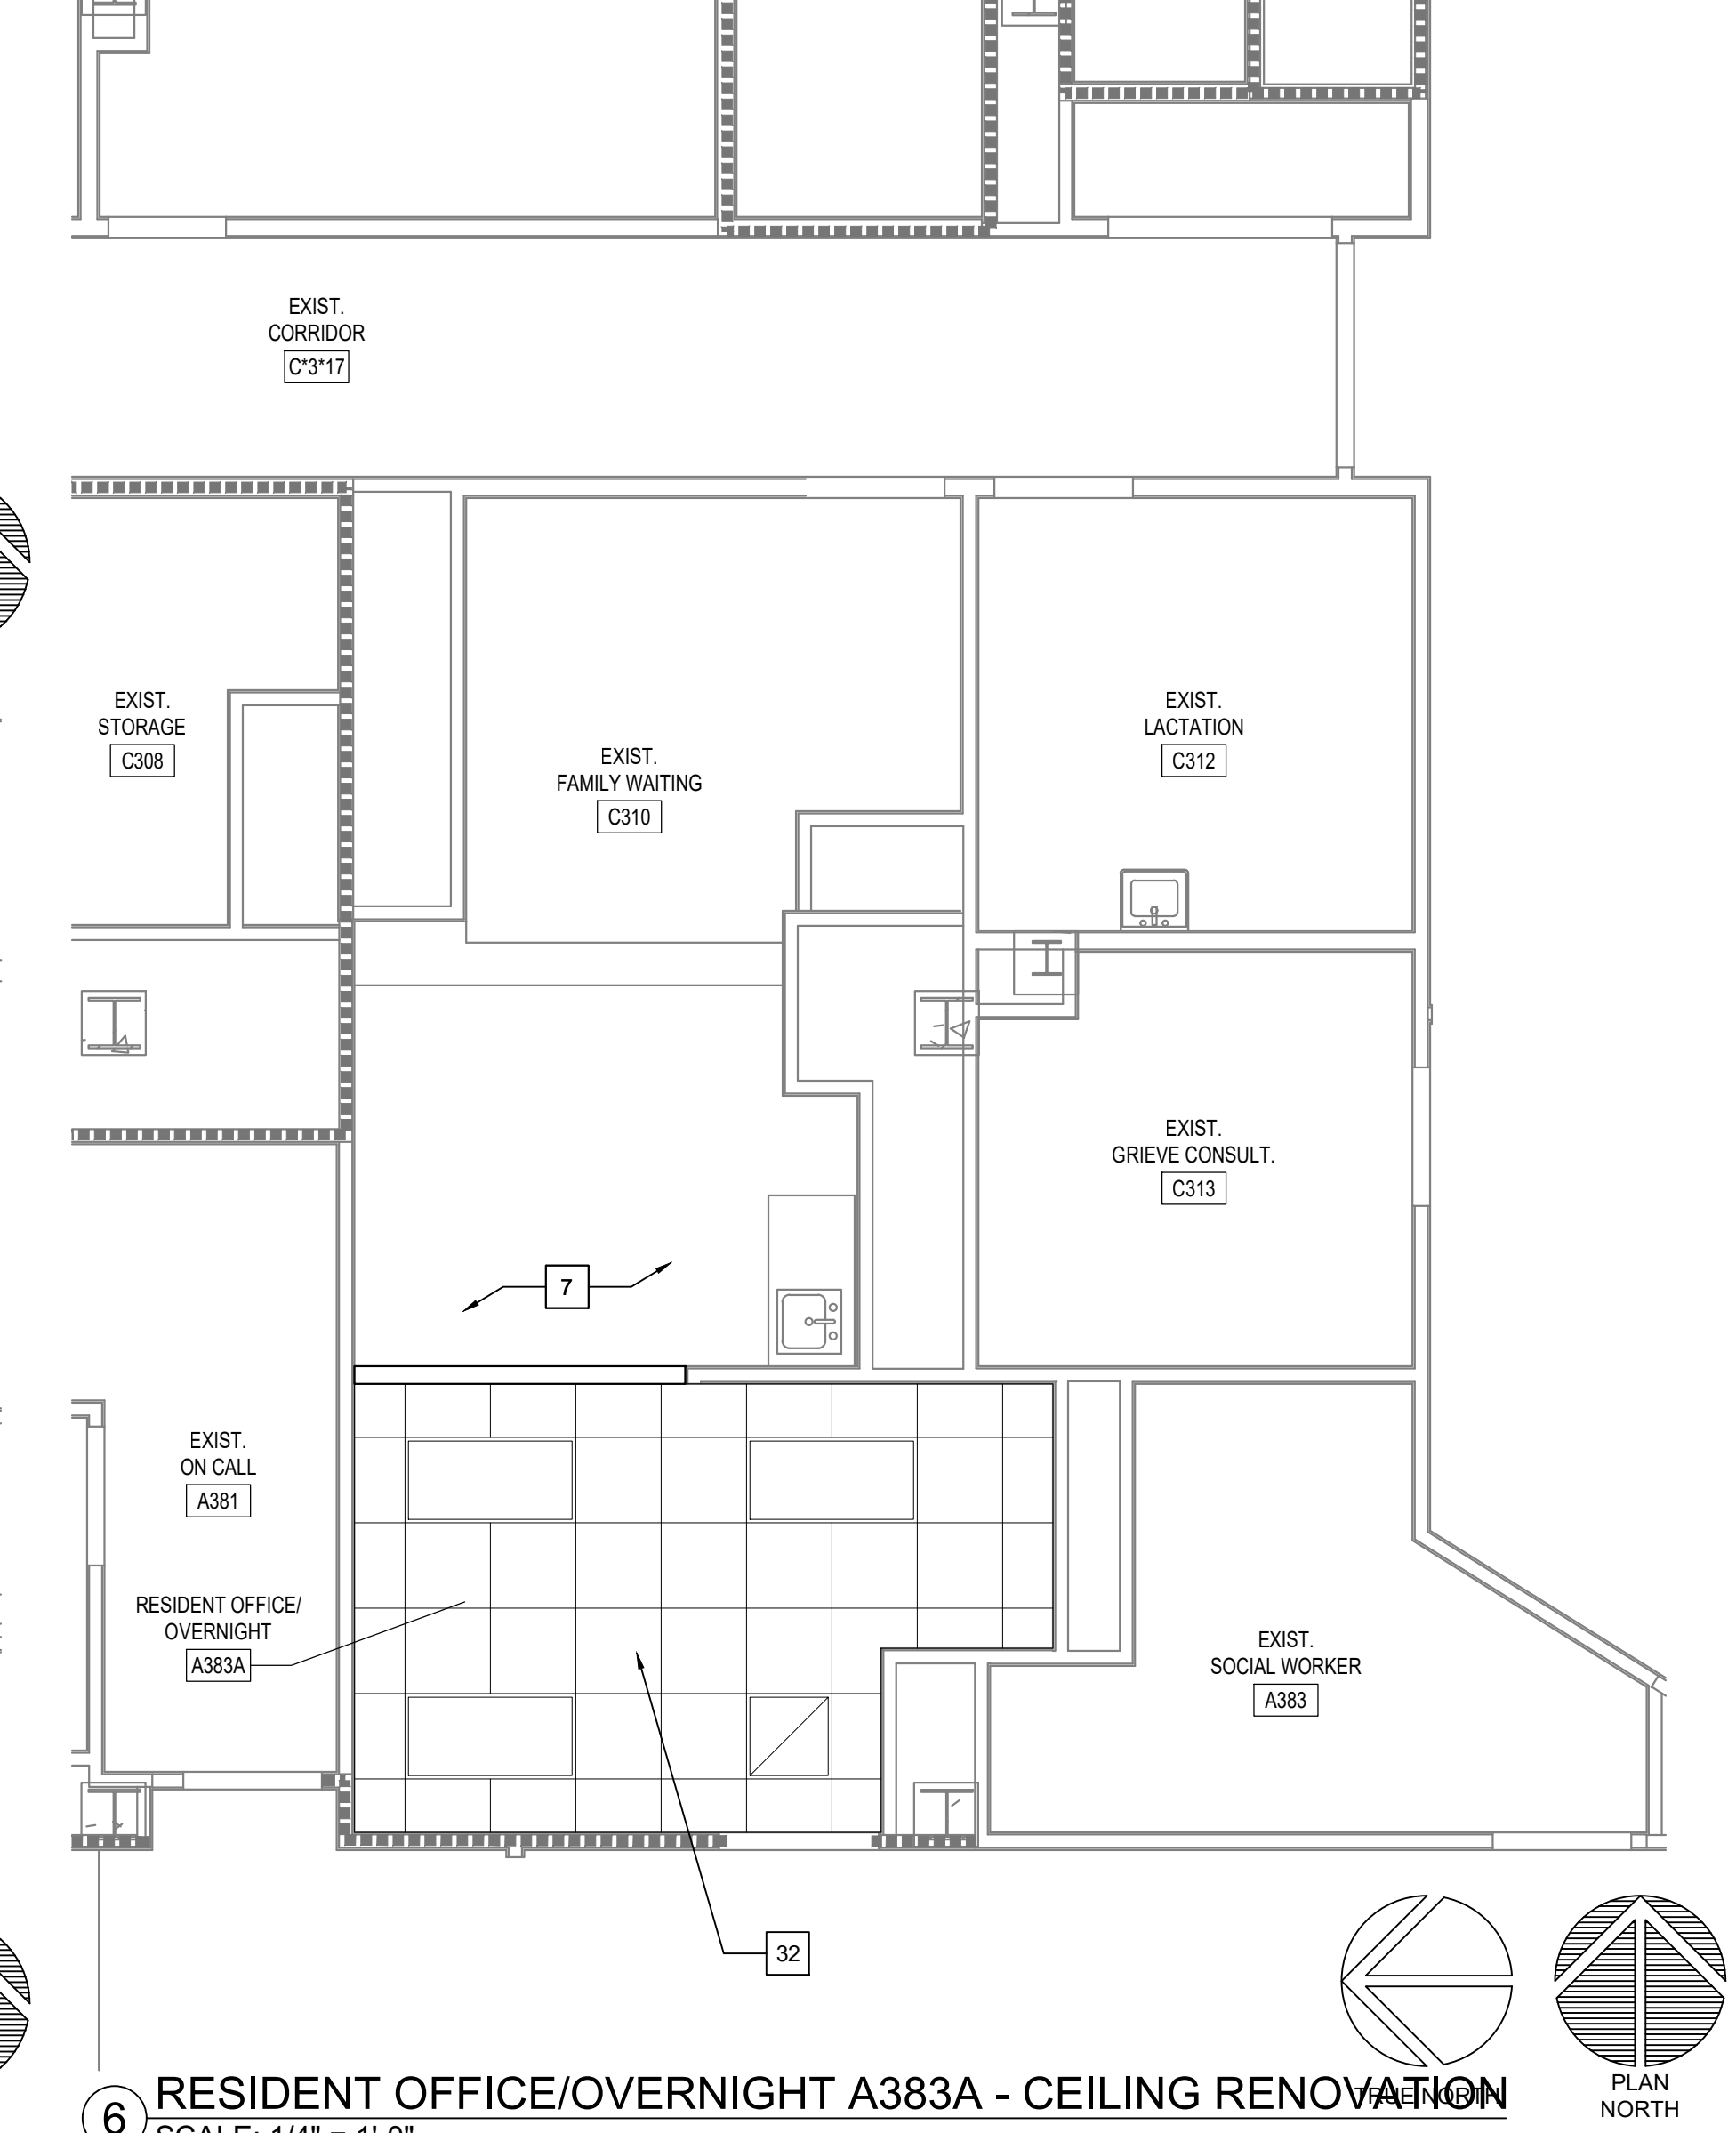

6 RESIDENT OFFICE/OVERNIGHT A383A - CEILING RENOVATION  
SCALE: 1/4" = 1'-0"

## KEYED NOTES - RENOVATION

- EXISTING DOOR/FRAME ASSEMBLY TO REMAIN.
- PROVIDE CARD READER.
- PROVIDE ROOM SIGNAGE.
- PROVIDE NEW FLOORING AND BASE AS SCHEDULED.
- REFERENCE MEP AND TECHNOLOGY DRAWINGS FOR WORK SCOPE IN THIS ROOM THAT MAY REQUIRE MINOR DEMOLITION, PATCHING AND REPAIR OF EXISTING FLOOR SUBSTRATE, WALL OR MISCELLANEOUS ASSEMBLIES.
- PROVIDE 8"x4"x3/4" AC FACED FIRE-RATED PLYWOOD VERTICALLY ON ALL WALLS AS INDICATED. PAINT WITH 2 COATS MIN. FIRE-RATED PAINT. COORDINATE EXACT LOCATION A.F.F. WITH TECHNOLOGY AND ELECTRICAL DRAWINGS AND EXISTING CONDITIONS.
- REFERENCE MEP AND TECHNOLOGY DRAWINGS FOR WORK SCOPE OF EXISTING AND NEW COMPONENTS AT CEILING LEVEL.
- EXISTING FLOOR AND BASE TO REMAIN. REPAIR AS NECESSARY TO MATCH EXISTING CONDITIONS OR BETTER.
- EXISTING VCT FLOORING AND RUBBER BASE TO REMAIN.
- RELOCATED EXISTING MARKER BOARD.
- RELOCATED EXISTING MILLWORK.
- CEILING FUR-DOWN ABOVE.
- NEW GYPSUM BOARD/METAL STUD FRAMED FUR-DOWN TO MATCH EXISTING HEIGHT. NO JOINTS UNLESS NOTED OTHERWISE.
- RELOCATED EXISTING LIGHT FIXTURE.
- RELOCATED EXISTING TV MONITOR.
- EXISTING ALUMINUM FLOOR AND WALL (EACH SIDE) EXPANSION JOINT COVERS TO REMAIN.
- EXISTING GYPSUM BOARD/METAL STUD FRAMED FUR-DOWN TO REMAIN.
- RELOCATED EXISTING FIRE EXTINGUISHER.
- EXISTING EXTERIOR WINDOW TO REMAIN.
- REINSTALL EXISTING SALVAGED WOOD BASE AND CHAIR RAIL. PROVIDE BALANCE OF MATERIAL AS NEEDED TO COMPLETE JOB. PAINT ALL BASE AND CHAIR RAIL IN ENTIRE ROOM.
- EXISTING PLASTER ON CMU TO UNDERSIDE OF EXISTING STRUCTURE (4" OR 8" CMU PER WALL THICKNESS DEPICTED GRAPHICALLY). FIRE-RATED WALL. CONTRACTOR VERIFY.
- EXISTING ROOM SIGNAGE.
- EXISTING CARD READER.
- REFERENCE DOOR SCHEDULE.
- PAINT INTERIOR SIDE OF EXISTING WINDOW GLAZING ONLY "FLAT BLACK".
- REINSTALLED EXISTING ROOM SIGNAGE.
- REINSTALLED EXISTING CARD READER.
- PLASTER ASSEMBLY INFILL AT EXISTING WALL AS DETAILED AT EXISTING WINDOW OPENING.
- ENSURE EXISTING WALL VENT IS SECURELY CLOSED SHUT PRIOR TO COVER-UP.
- PROVIDE WALL PROTECTION TO MATCH EXISTING.
- PROVIDE NEW CEILING AS SCHEDULED.
- PROVIDE GYPSUM BOARD/STEEL STUD FRAMED FUR-DOWN AS DETAILED.
- PROVIDE 2" X 2" RAISED FLOOR SYSTEM AT 10" ABOVE THE 4TH FLOOR LEVEL.
- ELECTRICAL CONDUITS AND MECHANICAL PIPING PER MEP DRAWINGS.
- PROVIDE 5/8" GYPSUM BOARD WHERE EXISTING TILE WAINSCOT AND SUBSTRATE WAS REMOVED. TEXTURE AND FINISH TO MATCH EXISTING ADJACENT WALLS (4'-0"± HIGH. LOCATE AS INDICATED BY HEAVY LINE).
- TEXTURE AND FINISH EXISTING GYPSUM BOARD SUBSTRATE TO MATCH EXISTING ADJACENT WALLS.
- GYPSUM BOARD ASSEMBLY INFILL AS DETAILED AT EXISTING WINDOW OPENING.
- PROVIDE INFILL PER KEYED NOTE 29 AT VOID LEFT BY HEATER REMOVED.
- PROVIDE 1" THICK MINIMUM CONCRETE INFILL FLUSH WITH EXISTING CONCRETE TOPPING WHERE PORTIONS OF EXISTING CMU WALLS ARE REMOVED.
- PROVIDE PAINTED WOOD CHAIR RAIL TO MATCH EXISTING.
- REINSTALLED EXISTING SHELF.
- PROVIDE GYPSUM BOARD/METAL STUD FRAMED CHASE FROM FLOORS ABOVE. MINIMIZE SIZE AND REFERENCE MEP DRAWINGS FOR COMPONENTS TO BE IN CHASE.
- RAMP AND RAILS BY RAISED FLOOR SYSTEM MANUFACTURER.
- ROOM PERIMETER WALLS TO BE FULLY SEALED TOP AND BOTTOM ON BOTH SIDES OF WALL. EXTERIOR WALL SEAL INTERIOR SIDE ONLY.

## GENERAL NOTES - RENOVATION

- REFERENCE GENERAL NOTES ON SHEET GI-004.
- UNLESS NOTED OTHERWISE, ALL EXISTING WALLS ARE 5/8" GYPSUM BOARD/3 5/8" METAL STUD FRAMED TO UNDERSIDE OF PRIMARY BUILDING FRAMING STRUCTURE (1 HR. FIRE RATED - CONSTRUCTION SIMILAR TO U.I. DESIGN NO. U465). CONTRACTOR TO VERIFY.
- UNLESS NOTED OTHERWISE, ALL EXISTING DOOR ASSEMBLIES ARE SOLID CORE WOOD DOORS/HOLLOW METAL FRAME TYPICAL (3'-0" X 7'-0").
- UNLESS NOTED OTHERWISE ALL EXISTING LAY-IN CEILING ASSEMBLIES ARE 2" X 2" STANDARD GRID WITH FISSURED TILES AT 8'-0" A.F.F. TYPICAL.
- UNLESS NOTED OTHERWISE, ALL EXISTING STEEL COLUMN FUR-OUTS ARE GYPSUM BOARD/METAL STUD FRAMED TYPICAL.
- PARTIAL OR ENTIRE RECONSTRUCTION OF SOME EXISTING CEILING ASSEMBLIES THOUGH OUT THE ENTIRE BUILDING(S), ESPECIALLY IN CORRIDORS, WILL BE NECESSARY. REFERENCE ALL DISCIPLINE DEMOLITION DRAWINGS. RECONSTRUCTION IS TO INCLUDE MISCELLANEOUS PATCHING /REPAIR TO MATCH EXISTING OR BETTER CONDITIONS.
- EXISTING FIRE-RATED WALL IDENTIFICATION INDICATED ONLY FOR IMMEDIATE AFFECTED ROOM WALLS. CONTRACTOR SHALL VERIFY FULL EXTENT OF EXISTING FIRE-RATED WALLS AT ADJACENT AREAS.
- ALL NEW WALLS SHALL BE PARTITION TYPE "1" UNLESS OTHERWISE NOTED.
- UNLESS NOTED OTHERWISE AT ALL ROOMS WHERE EXISTING CEILING ASSEMBLIES THOUGH OUT THE ENTIRE BUILDING(S), ESPECIALLY IN CORRIDORS, WILL BE NECESSARY. REFERENCE ALL DISCIPLINE DEMOLITION DRAWINGS. RECONSTRUCTION IS TO INCLUDE MISCELLANEOUS PATCHING /REPAIR TO MATCH EXISTING OR BETTER CONDITIONS.

## KEYED NOTES - RENOVATION (CONT.)

- TEMPORARY ALUMINUM RAMP BY CONTRACTOR TO BE RETURNED TO OWNER AT END OF JOB.
- MODULAR BRICK INFILL ON EXTERIOR TO MATCH EXISTING. TOOTH-IN AND MATCH MORTAR.

## LEGEND - RENOVATION

- |  |   |
|--|---|
|  | EXISTING WALL TO REMAIN   |
|  | NEW WALL CONSTRUCTION   |
|  | EXISTING DOOR/FRAME ASSEMBLY TO REMAIN                          |
|  | NEW DOOR/FRAME ASSEMBLY   |
|  | EXISTING WINDOW ASSEMBLY TO REMAIN                              |
|  | NEW WINDOW ASSEMBLY   |
|  | 1 HR. FIRE-RATED WALL (EXISTING)                                |
|  | 2 HR. FIRE-RATED WALL (EXISTING)                                |
|  | FIRE-RATED WALL (NEW OR EXISTING 1 HOUR UNLESS NOTED OTHERWISE) |

Phase  
**100% CONSTRUCTION DOCUMENTS**

**FULLY SPRINKLERED**

Project Title  
**CINCINNATI VAMC EHRM INFRASTRUCTURE UPGRADES**

Location  
3200 VINE ST., CINCINNATI, OH

Issue Date  
4-MAY-2022

Checked


Drawn  
JAR

Project Number  
539-21-701

Building Number  
C1


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**AS-403-C.1.3**



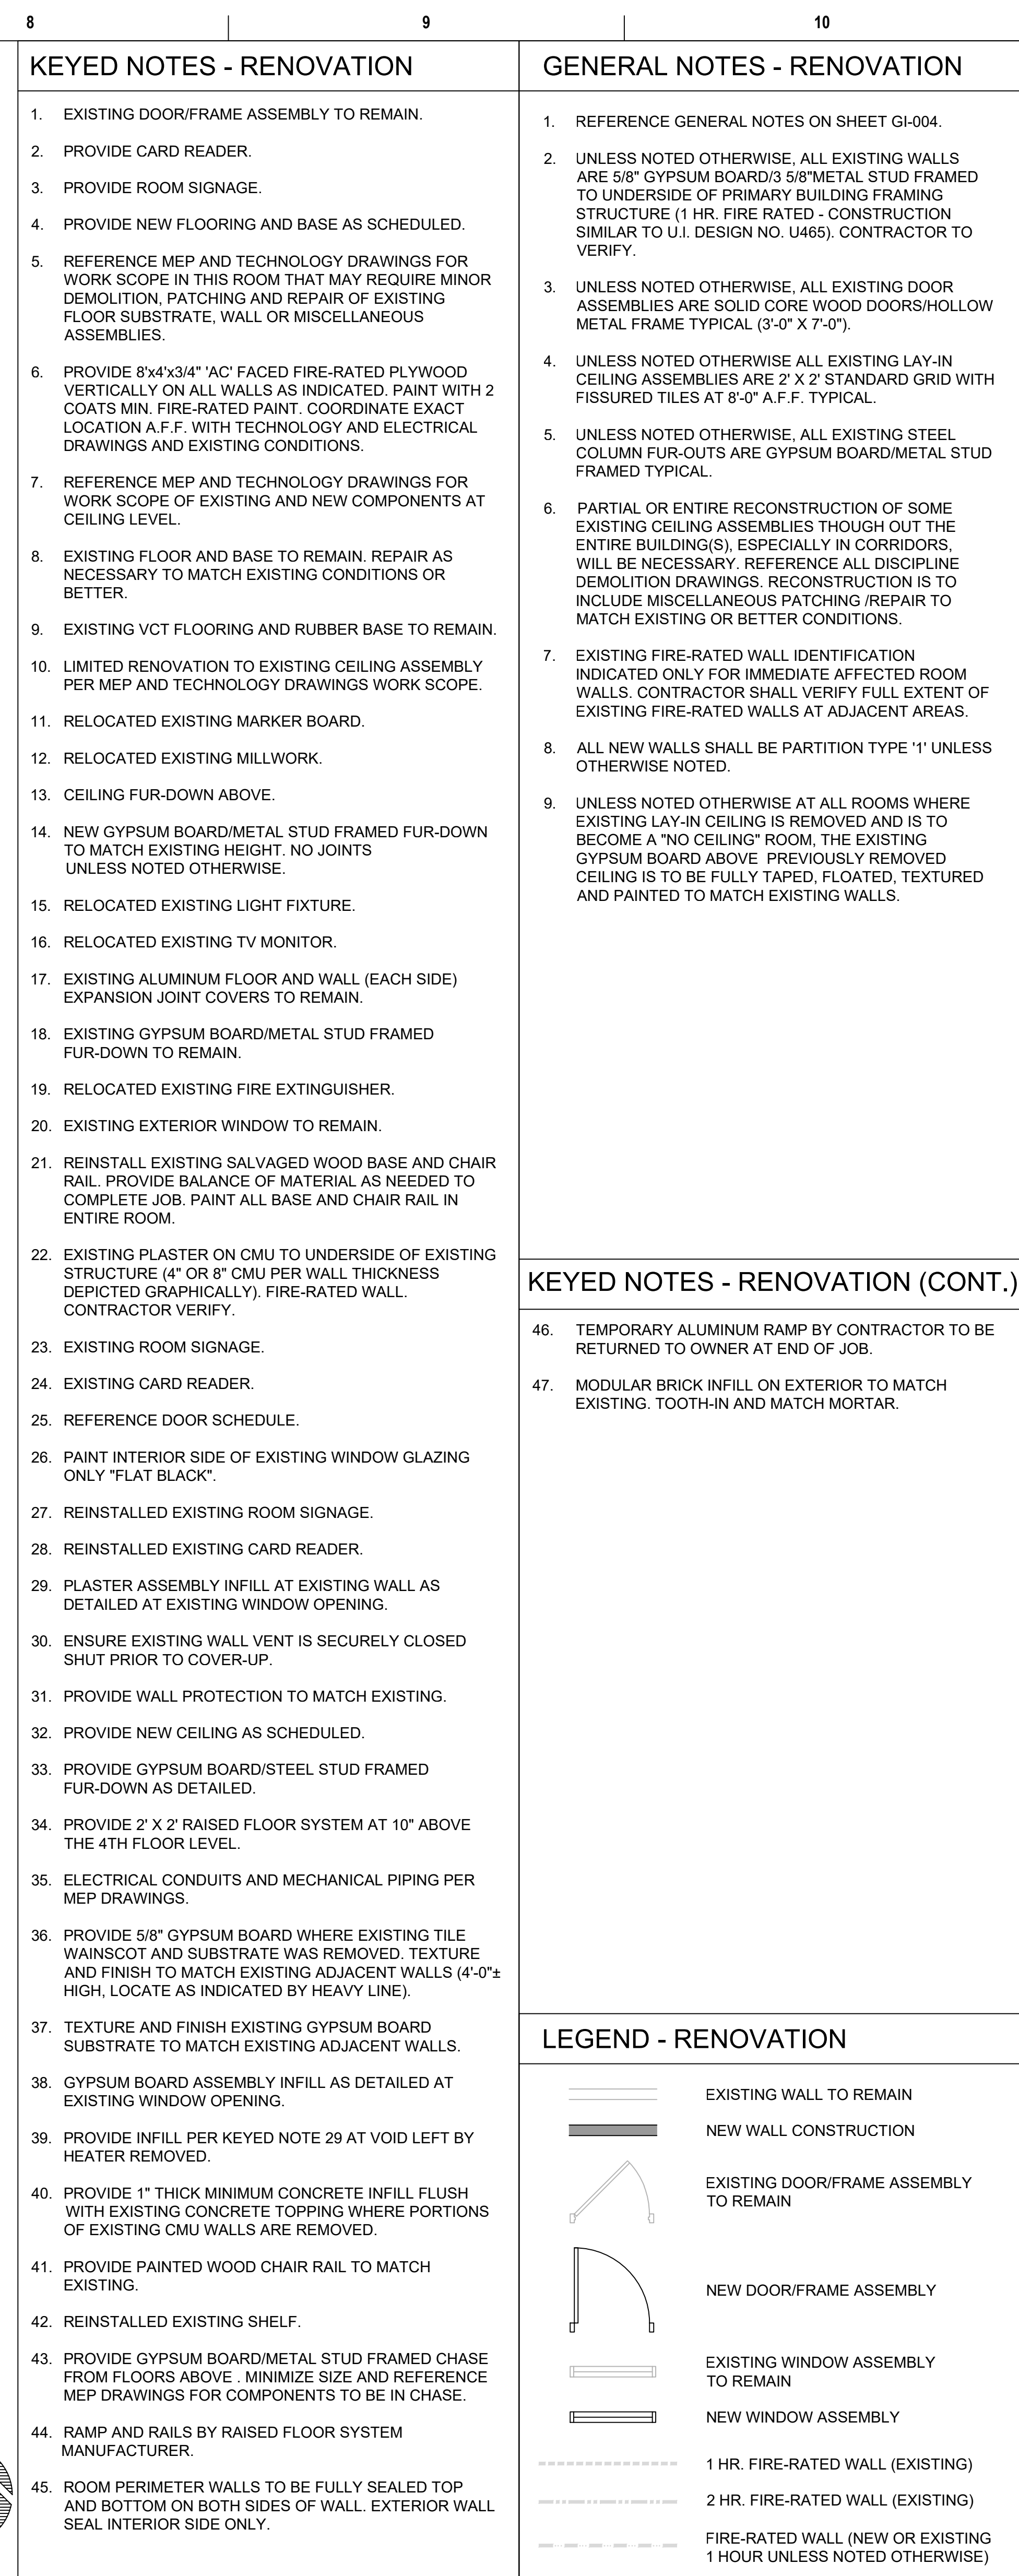


Project Number	539-21-701
Building Number	1
Drawing Number	AS-404-C.1.4



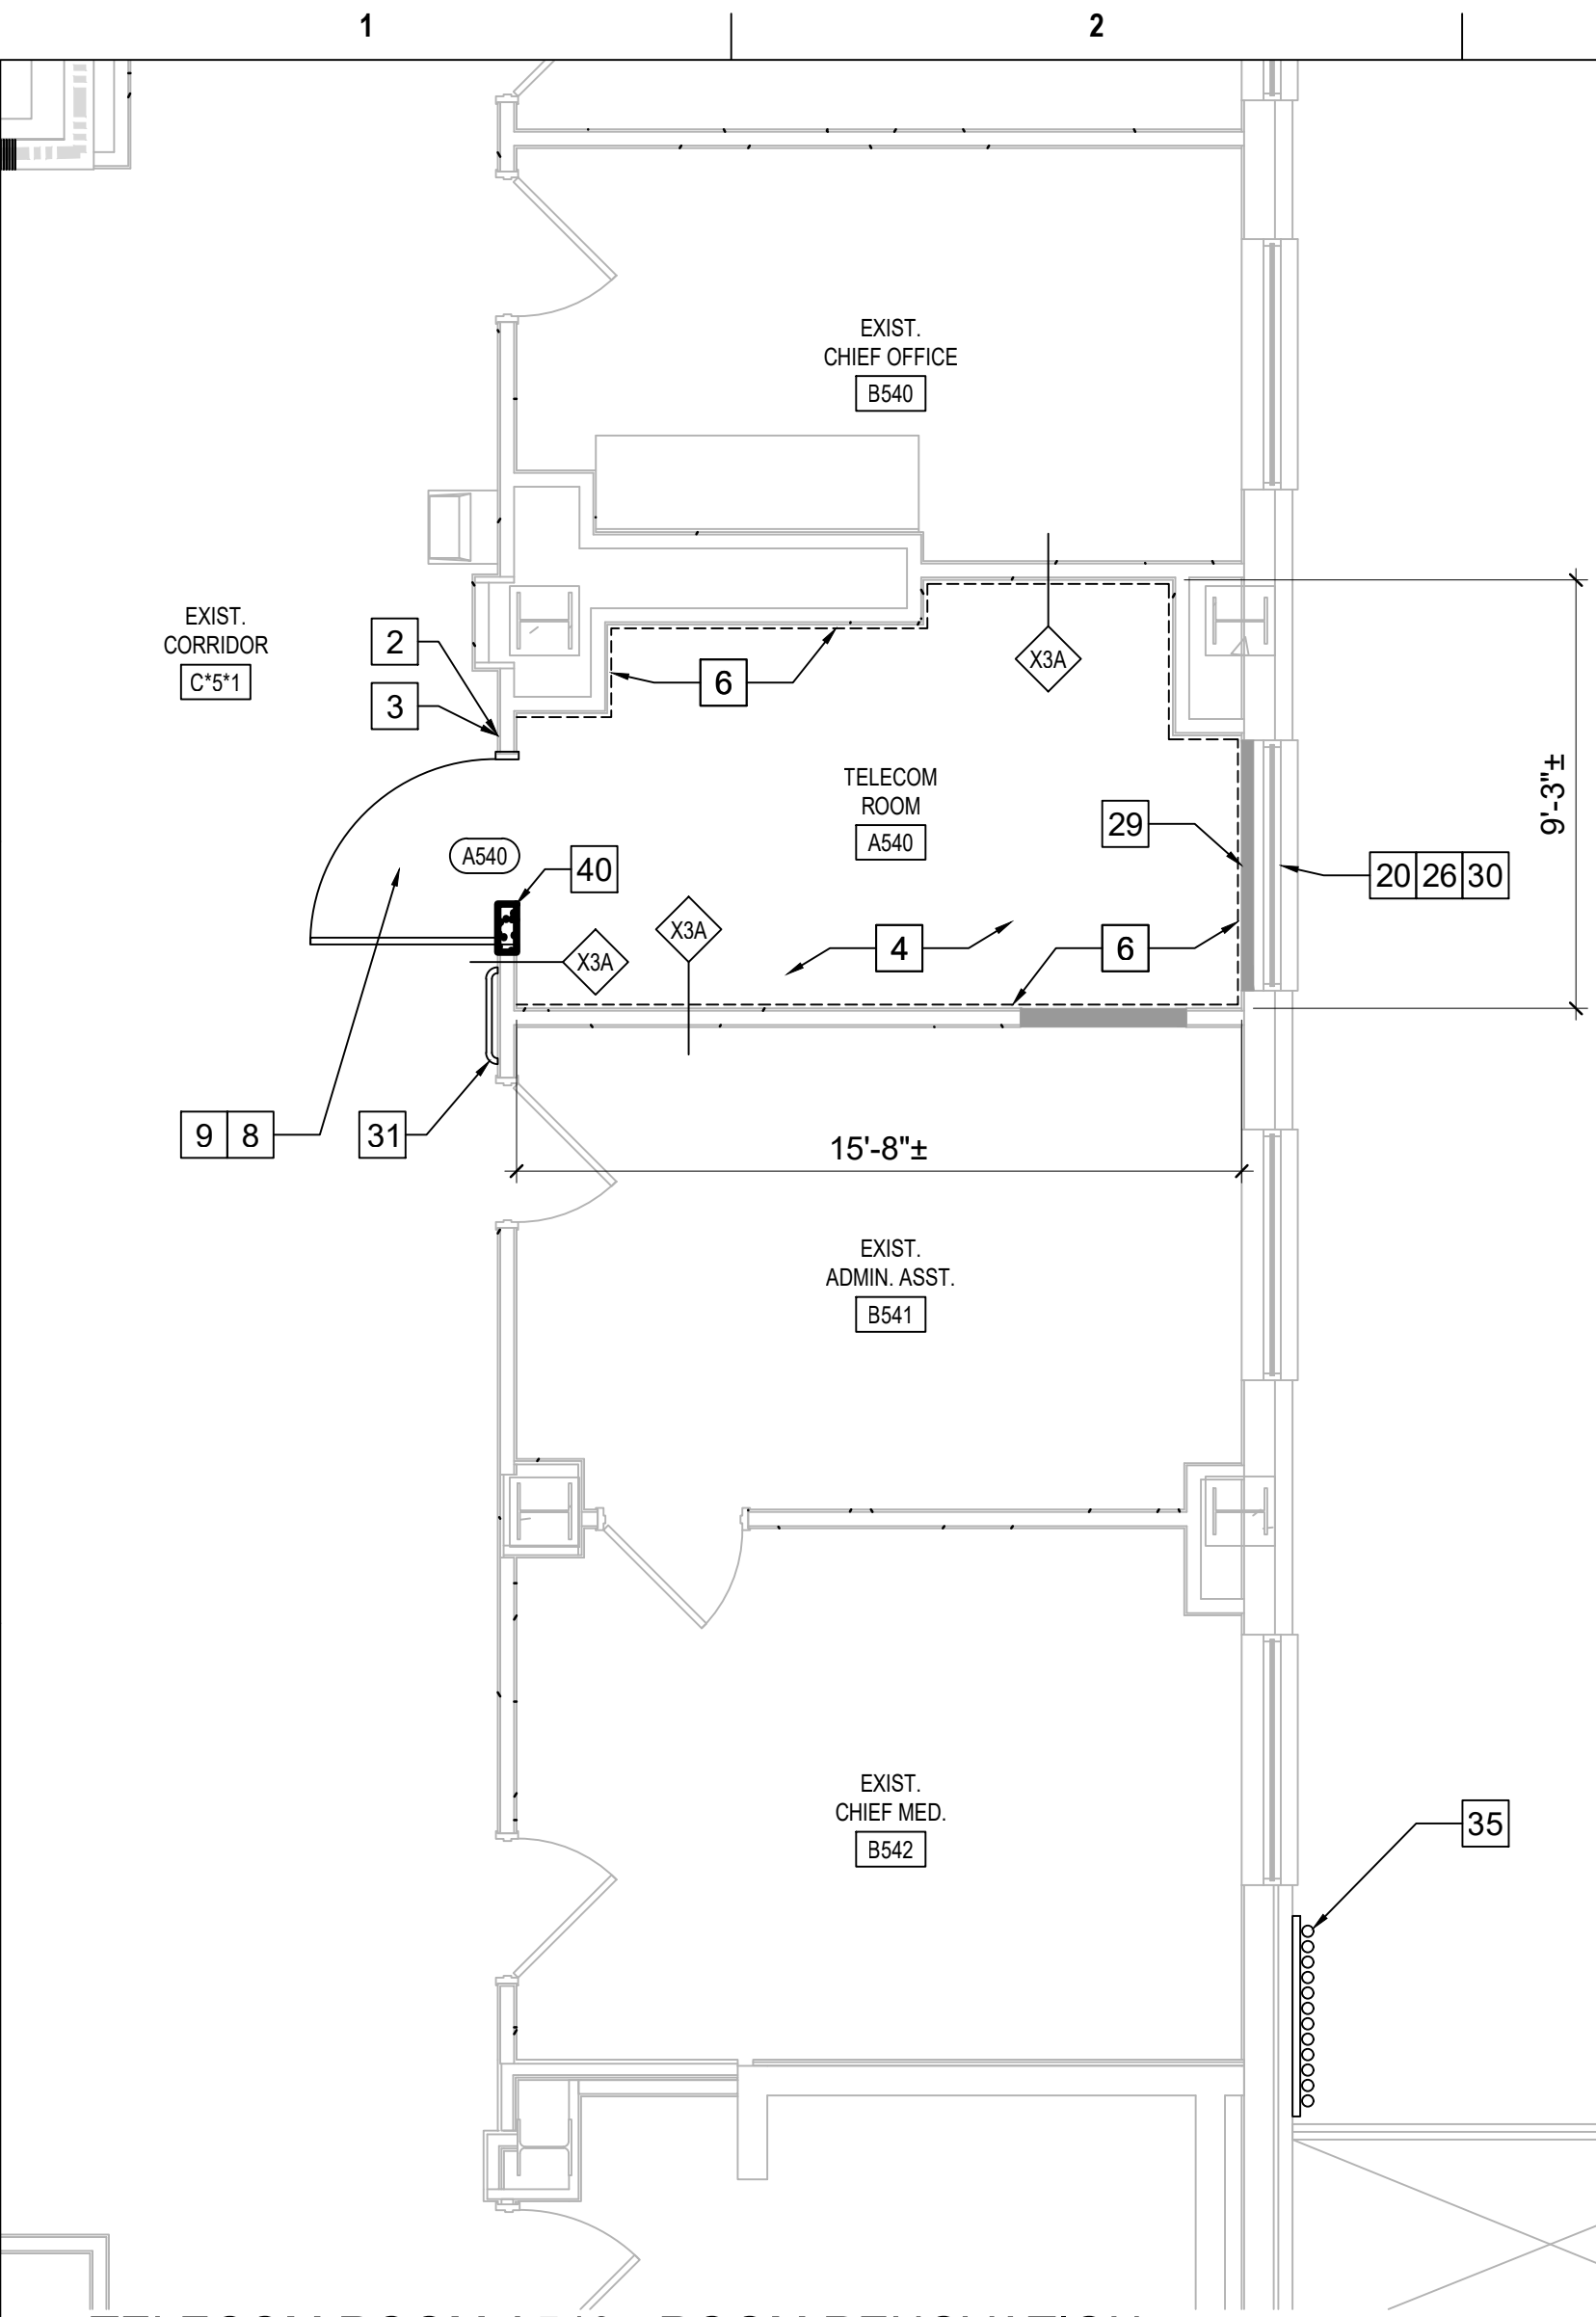

1 TELECOM ROOM A540 - ROOM RENOVATION  
SCALE: 1/4" = 1'-0"

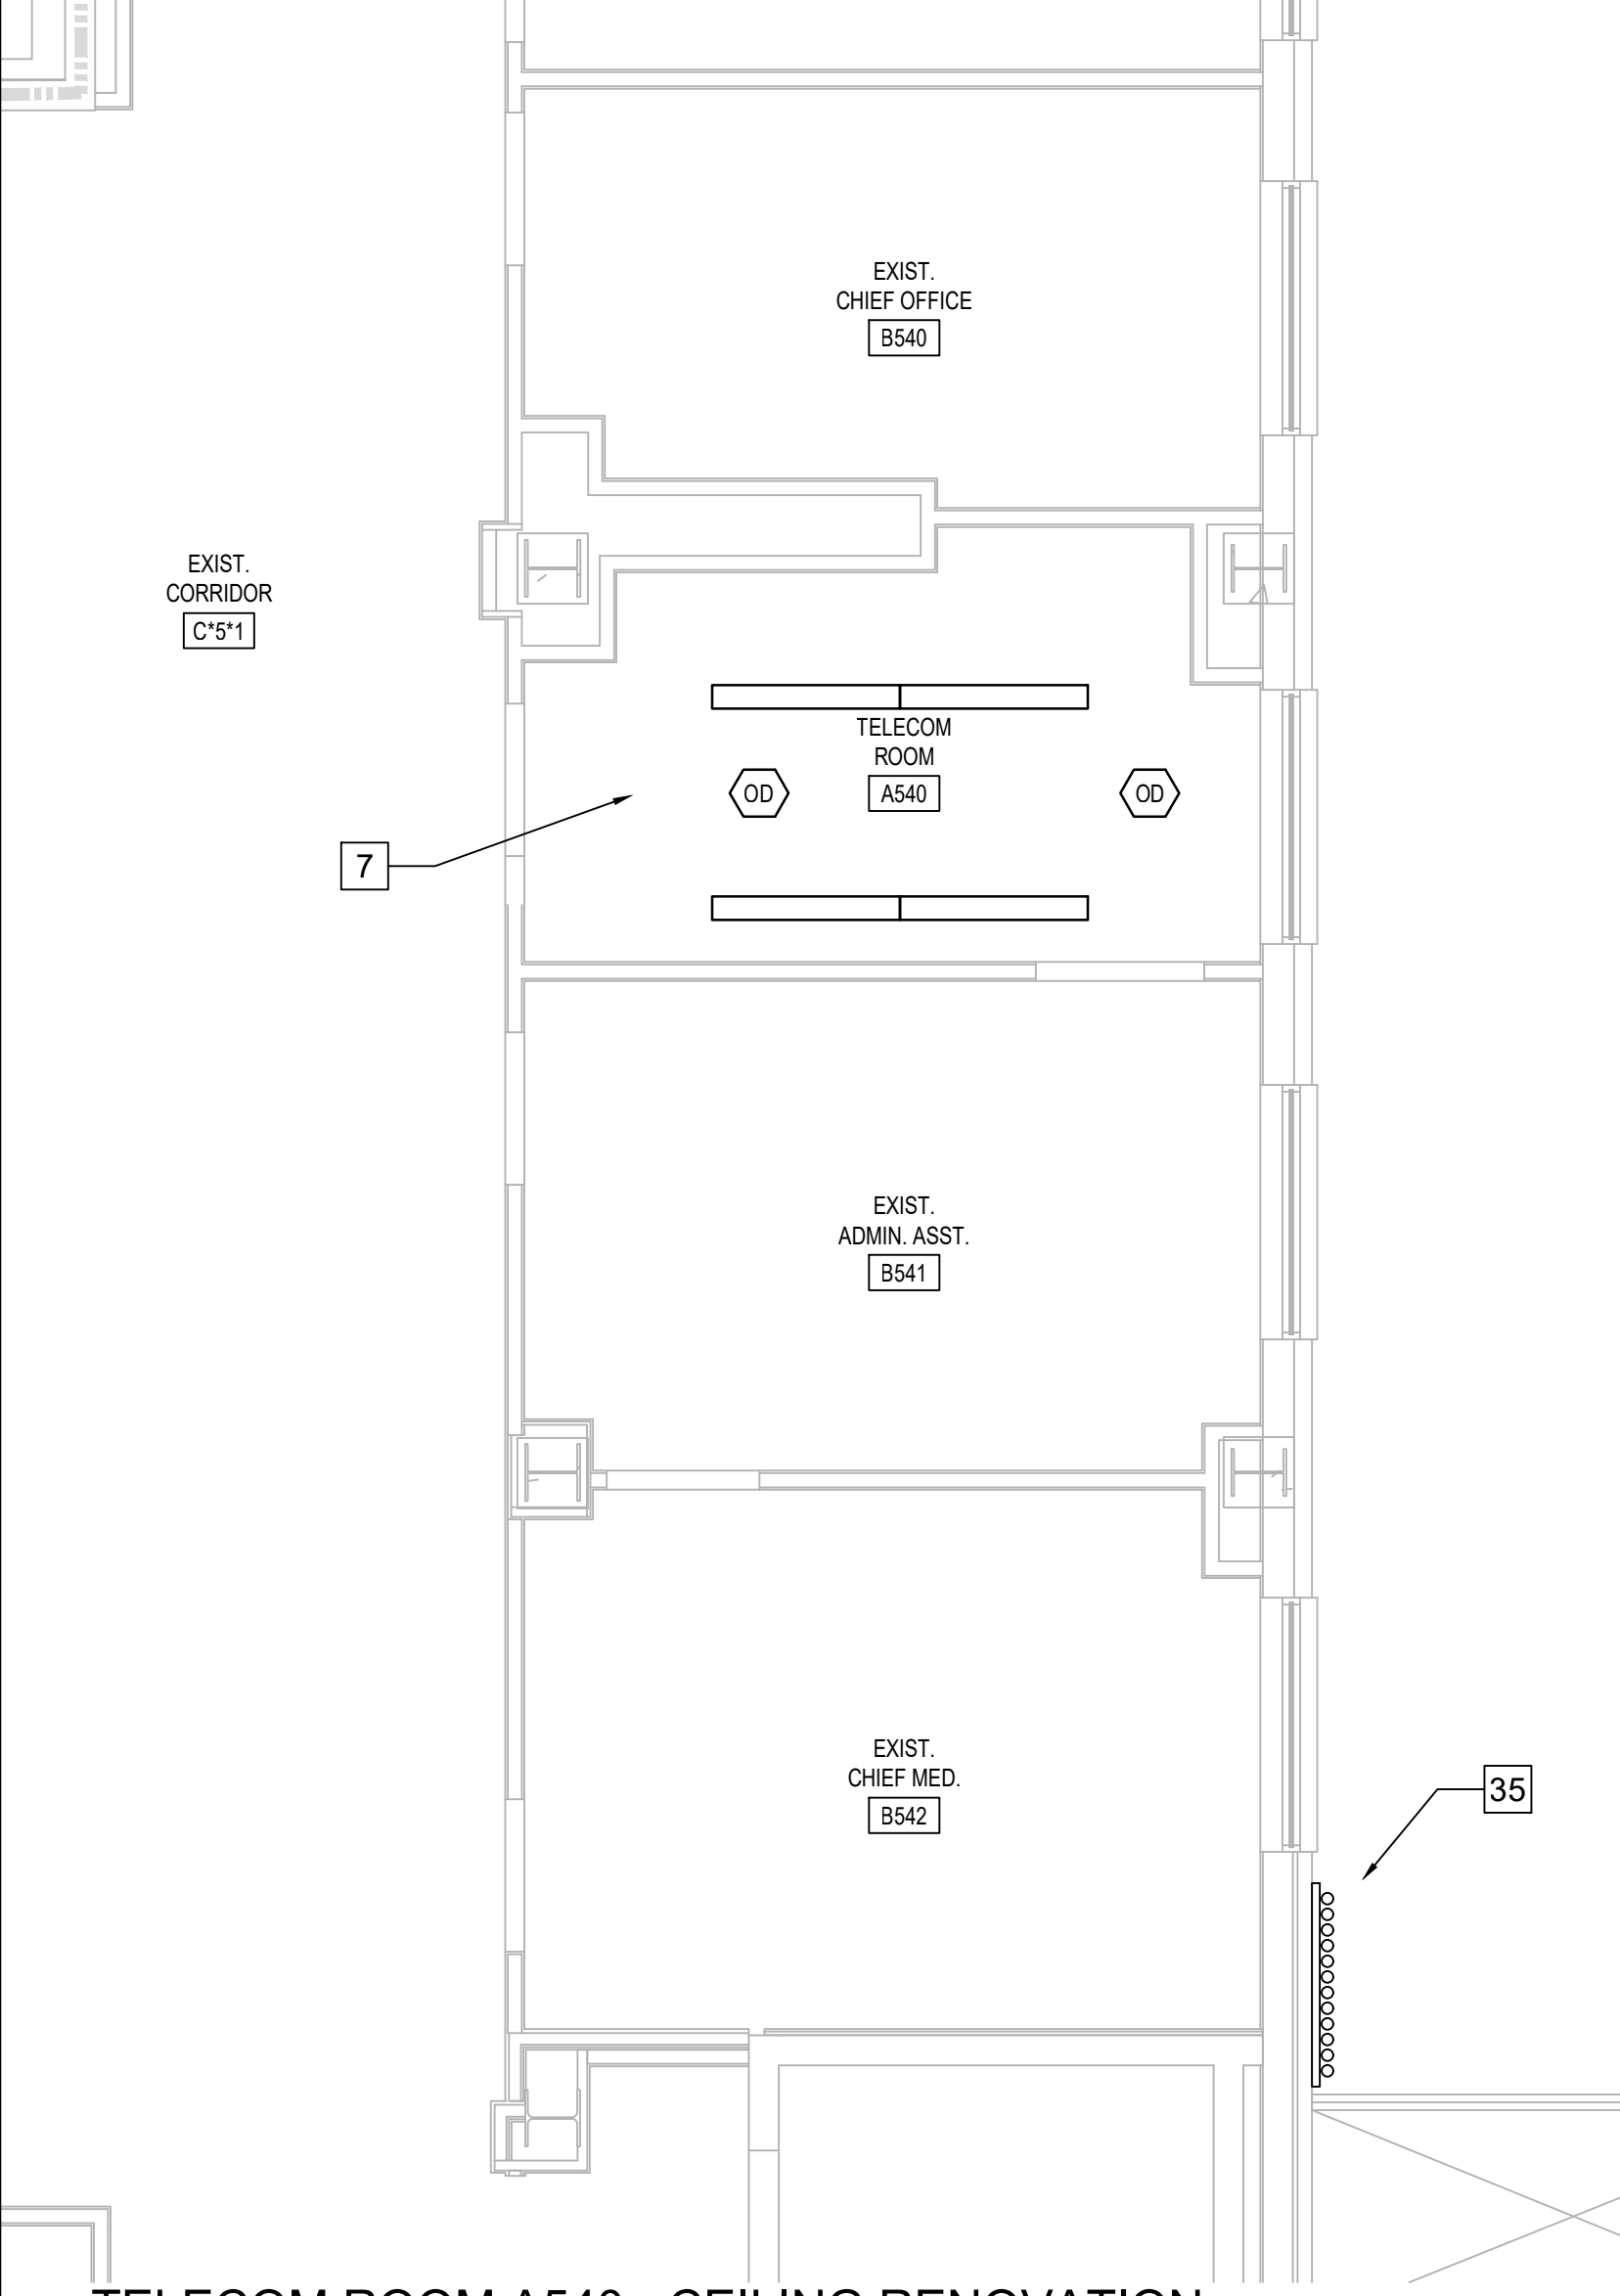

2 TELECOM ROOM A540 - CEILING RENOVATION  
SCALE: 1/4" = 1'-0"

Revisions:	Date:

CONSULTANT



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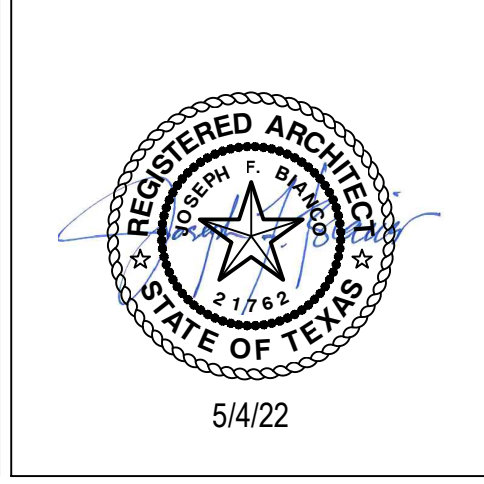
PROJECT MANAGEMENT




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Construction  
and Facilities  
Management

 U.S. Department  
of Veterans Affairs

Drawing Title

ENLARGED FLOOR PLAN -  
FIFTH FLOOR - RENOVATION

Approved: Project Director

Phase

100% CONSTRUCTION  
DOCUMENTS

FULLY SPRINKLERED

Project Title

CINCINNATI VAMC EHRM  
INFRASTRUCTURE UPGRADES

Location

3200 VINE ST., CINCINNATI, OH

Issue Date

4-MAY-2022

Checked

IAR, JFB

Drawn

IAR

Project Number

539-21-701

Building Number

1

Drawing Number

AS-405-C.1.5

- KEYED NOTES - RENOVATION
1. EXISTING DOOR/FRAME ASSEMBLY TO REMAIN.

2. PROVIDE CARD READER.

3. PROVIDE ROOM SIGNAGE.

4. PROVIDE NEW FLOORING AND BASE AS SCHEDULED.

5. REFERENCE MEP AND TECHNOLOGY DRAWINGS FOR WORK SCOPE IN THIS ROOM THAT MAY REQUIRE MINOR DEMOLITION, PATCHING AND REPAIR OF EXISTING FLOOR SUBSTRATE, WALL OR MISCELLANEOUS ASSEMBLIES.

6. PROVIDE 8"x4"x3/4" AC FACED FIRE-RATED PLYWOOD VERTICALLY ON ALL WALLS AS INDICATED. PAINT WITH 2 COATS MIN. FIRE-RATED PAINT. COORDINATE EXACT LOCATION A.F.F. WITH TECHNOLOGY AND ELECTRICAL DRAWINGS AND EXISTING CONDITIONS.

7. REFERENCE MEP AND TECHNOLOGY DRAWINGS FOR WORK SCOPE OF EXISTING AND NEW COMPONENTS AT CEILING LEVEL.

8. EXISTING FLOOR AND BASE TO REMAIN. REPAIR AS NECESSARY TO MATCH EXISTING CONDITIONS OR BETTER.

9. EXISTING VCT FLOORING AND RUBBER BASE TO REMAIN.

10. LIMITED RENOVATION TO EXISTING CEILING ASSEMBLY PER MEP AND TECHNOLOGY DRAWINGS WORK SCOPE.

11. RELOCATED EXISTING MARKER BOARD.

12. RELOCATED EXISTING MILLWORK.

13. CEILING FUR-DOWN ABOVE.

14. NEW GYPSUM BOARD/METAL STUD FRAMED FUR-DOWN TO MATCH EXISTING HEIGHT. NO JOINTS UNLESS NOTED OTHERWISE.

15. RELOCATED EXISTING LIGHT FIXTURE.

16. RELOCATED EXISTING TV MONITOR.

17. EXISTING ALUMINUM FLOOR AND WALL (EACH SIDE) EXPANSION JOINT COVERS TO REMAIN.

18. EXISTING GYPSUM BOARD/METAL STUD FRAMED FUR-DOWN TO REMAIN.

19. RELOCATED EXISTING FIRE EXTINGUISHER.

20. EXISTING EXTERIOR WINDOW TO REMAIN.

21. REINSTALL EXISTING SALVAGED WOOD BASE AND CHAIR RAIL. PROVIDE BALANCE OF MATERIAL AS NEEDED TO COMPLETE JOB. PAINT ALL BASE AND CHAIR RAIL IN ENTIRE ROOM.

22. EXISTING PLASTER ON CMU TO UNDERSIDE OF EXISTING STRUCTURE (4" OR 8" CMU PER WALL THICKNESS DEPICTED GRAPHICALLY). FIRE-RATED WALL. CONTRACTOR VERIFY.

23. EXISTING ROOM SIGNAGE.

24. EXISTING CARD READER.

25. REFERENCE DOOR SCHEDULE.

26. PAINT INTERIOR SIDE OF EXISTING WINDOW GLAZING ONLY "FLAT BLACK".

27. REINSTALLED EXISTING ROOM SIGNAGE.

28. REINSTALLED EXISTING CARD READER.

29. PLASTER ASSEMBLY INFILL AT EXISTING WALL AS DETAILED AT EXISTING WINDOW OPENING.

30. ENSURE EXISTING WALL VENT IS SECURELY CLOSED SHUT PRIOR TO COVER-UP.

31. PROVIDE WALL PROTECTION TO MATCH EXISTING.

32. PROVIDE NEW CEILING AS SCHEDULED.

33. PROVIDE GYPSUM BOARD/STEEL STUD FRAMED FUR-DOWN AS DETAILED.

34. PROVIDE 2' X 2' RAISED FLOOR SYSTEM AT 10" ABOVE THE 4TH FLOOR LEVEL.

35. ELECTRICAL CONDUITS AND MECHANICAL PIPING PER MEP DRAWINGS.

36. PROVIDE 5/8" GYPSUM BOARD WHERE EXISTING TILE WAINSCOT AND SUBSTRATE WAS REMOVED. TEXTURE AND FINISH TO MATCH EXISTING ADJACENT WALLS (4'-0"± HIGH, LOCATE AS INDICATED BY HEAVY LINE).

37. TEXTURE AND FINISH EXISTING GYPSUM BOARD SUBSTRATE TO MATCH EXISTING ADJACENT WALLS.

38. GYPSUM BOARD ASSEMBLY INFILL AS DETAILED AT EXISTING WINDOW OPENING.

39. PROVIDE INFILL PER KEYED NOTE 29 AT VOID LEFT BY HEATER REMOVED.

40. PROVIDE 1" THICK MINIMUM CONCRETE INFILL FLUSH WITH EXISTING CONCRETE TOPPING WHERE PORTIONS OF EXISTING CMU WALLS ARE REMOVED.

41. PROVIDE PAINTED WOOD CHAIR RAIL TO MATCH EXISTING.

42. REINSTALLED EXISTING SHELF.

43. PROVIDE GYPSUM BOARD/METAL STUD FRAMED CHASE FROM FLOORS ABOVE. MINIMIZE SIZE AND REFERENCE MEP DRAWINGS FOR COMPONENTS TO BE IN CHASE.

44. RAMP AND RAILS BY RAISED FLOOR SYSTEM MANUFACTURER.

45. ROOM PERIMETER WALLS TO BE FULLY SEALED TOP AND BOTTOM ON BOTH SIDES OF WALL. EXTERIOR WALL SEAL INTERIOR SIDE ONLY.

- GENERAL NOTES - RENOVATION
1. REFERENCE GENERAL NOTES ON SHEET GI-004.

2. UNLESS NOTED OTHERWISE, ALL EXISTING WALLS ARE 5/8" GYPSUM BOARD/3 5/8" METAL STUD FRAMED TO UNDERSIDE OF PRIMARY BUILDING FRAMING STRUCTURE (1 HR. FIRE RATED - CONSTRUCTION SIMILAR TO U.I. DESIGN NO. U465). CONTRACTOR TO VERIFY.

3. UNLESS NOTED OTHERWISE, ALL EXISTING DOOR ASSEMBLIES ARE SOLID CORE WOOD DOORS/HOLLOW METAL FRAME TYPICAL (3'-0" X 7'-0").

4. UNLESS NOTED OTHERWISE ALL EXISTING LAY-IN CEILING ASSEMBLIES ARE 2' X 2' STANDARD GRID WITH FISSURED TILES AT 8'-0" A.F.F. TYPICAL.

5. UNLESS NOTED OTHERWISE, ALL EXISTING STEEL COLUMN FUR-OUTS ARE GYPSUM BOARD/METAL STUD FRAMED TYPICAL.

6. PARTIAL OR ENTIRE RECONSTRUCTION OF SOME EXISTING CEILING ASSEMBLIES THROUGH OUT THE ENTIRE BUILDING(S), ESPECIALLY IN CORRIDORS, WILL BE NECESSARY. REFERENCE ALL DISCIPLINE DEMOLITION DRAWINGS. RECONSTRUCTION IS TO INCLUDE MISCELLANEOUS PATCHING /REPAIR TO MATCH EXISTING OR BETTER CONDITIONS.

7. EXISTING FIRE-RATED WALL IDENTIFICATION INDICATED ONLY FOR IMMEDIATE AFFECTED ROOM WALLS. CONTRACTOR SHALL VERIFY FULL EXTENT OF EXISTING FIRE-RATED WALLS AT ADJACENT AREAS.

8. ALL NEW WALLS SHALL BE PARTITION TYPE "1" UNLESS OTHERWISE NOTED.


9. UNLESS NOTED OTHERWISE AT ALL ROOMS WHERE EXISTING LAY-IN CEILING IS REMOVED AND IS TO BECOME A "NO CEILING" ROOM, THE EXISTING GYPSUM BOARD ABOVE PREVIOUSLY REMOVED CEILING IS TO BE FULLY TAPED, FLOATED, TEXTURED AND PAINTED TO MATCH EXISTING WALLS.


KEYED NOTES - RENOVATION (CONT.)


46. TEMPORARY ALUMINUM RAMP BY CONTRACTOR TO BE RETURNED TO OWNER AT END OF JOB.


47. MODULAR BRICK INFILL ON EXTERIOR TO MATCH EXISTING. TOOTH-IN AND MATCH MORTAR.


LEGEND - RENOVATION


 EXISTING WALL TO REMAIN


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
 EXISTING DOOR/FRAME ASSEMBLY TO REMAIN


 NEW DOOR/FRAME ASSEMBLY

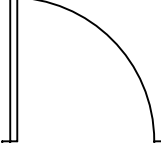 EXISTING WINDOW ASSEMBLY TO REMAIN

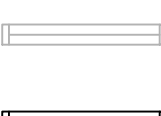
 NEW WINDOW ASSEMBLY

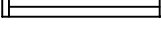 1 HR. FIRE-RATED WALL (EXISTING)

 2 HR. FIRE-RATED WALL (EXISTING)

 FIRE-RATED WALL (NEW OR EXISTING 1 HOUR UNLESS NOTED OTHERWISE)



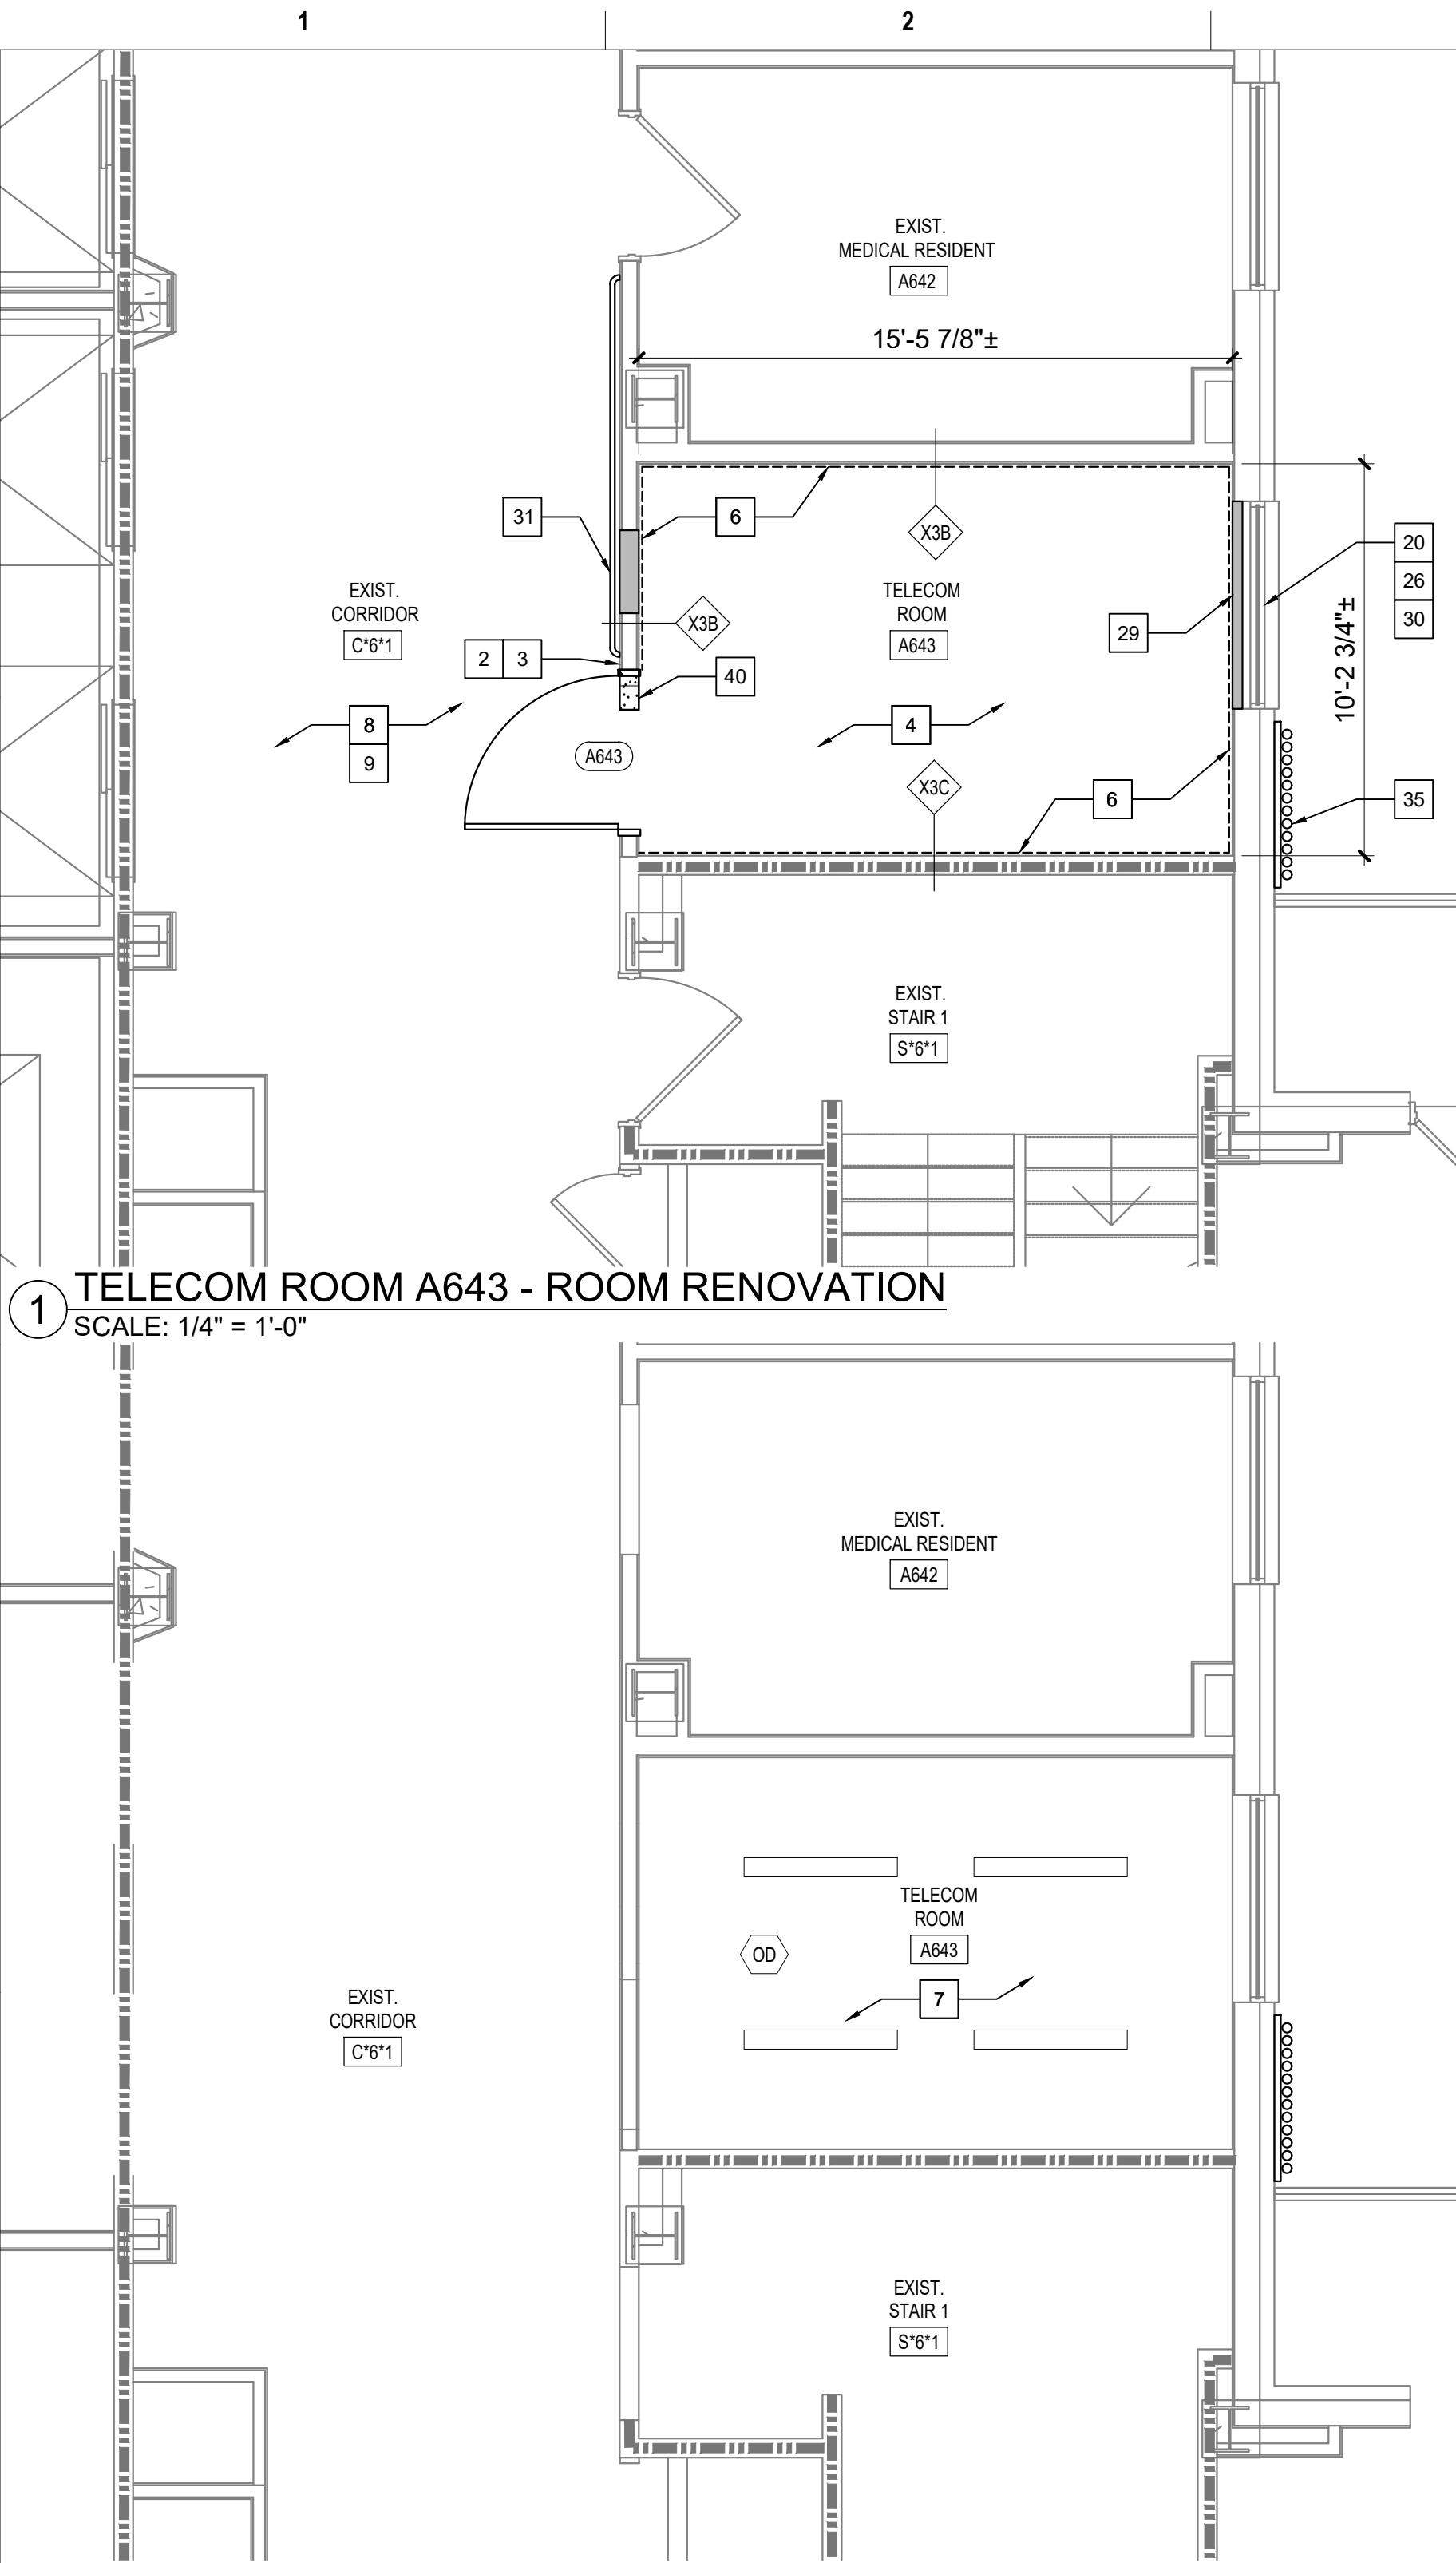

2 TELECOM ROOM A643 - CEILING RENOVATION  
SCALE: 1/4" = 1'-0"

KEYED NOTES - RENOVATION

- EXISTING DOOR/FRAME ASSEMBLY TO REMAIN.
- PROVIDE CARD READER.
- PROVIDE ROOM SIGNAGE.
- PROVIDE NEW FLOORING AND BASE AS SCHEDULED.
- REFERENCE MEP AND TECHNOLOGY DRAWINGS FOR WORK SCOPE IN THIS ROOM THAT MAY REQUIRE MINOR DEMOLITION, PATCHING AND REPAIR OF EXISTING FLOOR SUBSTRATE, WALL OR MISCELLANEOUS ASSEMBLIES.
- PROVIDE 8"x4"x3/4" AC FACED FIRE-RATED PLYWOOD VERTICALLY ON ALL WALLS AS INDICATED. PAINT WITH 2 COATS MIN. FIRE-RATED PAINT. COORDINATE EXACT LOCATION A.F.F. WITH TECHNOLOGY AND ELECTRICAL DRAWINGS AND EXISTING CONDITIONS.
- REFERENCE MEP AND TECHNOLOGY DRAWINGS FOR WORK SCOPE OF EXISTING AND NEW COMPONENTS AT CEILING LEVEL.
- EXISTING FLOOR AND BASE TO REMAIN. REPAIR AS NECESSARY TO MATCH EXISTING CONDITIONS OR BETTER.
- EXISTING VCT FLOORING AND RUBBER BASE TO REMAIN.
- LIMITED RENOVATION TO EXISTING CEILING ASSEMBLY PER MEP AND TECHNOLOGY DRAWINGS WORK SCOPE.
- RELOCATED EXISTING MARKER BOARD.
- RELOCATED EXISTING MILLWORK.
- CEILING FUR-DOWN ABOVE.
- NEW GYPSUM BOARD/METAL STUD FRAMED FUR-DOWN TO MATCH EXISTING HEIGHT. NO JOINTS UNLESS NOTED OTHERWISE.
- RELOCATED EXISTING LIGHT FIXTURE.
- RELOCATED EXISTING TV MONITOR.
- EXISTING ALUMINUM FLOOR AND WALL (EACH SIDE) EXPANSION JOINT COVERS TO REMAIN.
- EXISTING GYPSUM BOARD/METAL STUD FRAMED FUR-DOWN TO REMAIN.
- RELOCATED EXISTING FIRE EXTINGUISHER.
- EXISTING EXTERIOR WINDOW TO REMAIN.
- REINSTALL EXISTING SALVAGED WOOD BASE AND CHAIR RAIL. PROVIDE BALANCE OF MATERIAL AS NEEDED TO COMPLETE JOB. PAINT ALL BASE AND CHAIR RAIL IN ENTIRE ROOM.
- EXISTING PLASTER ON CMU TO UNDERSIDE OF EXISTING STRUCTURE (4" OR 8" CMU PER WALL THICKNESS DEPICTED GRAPHICALLY). FIRE-RATED WALL. CONTRACTOR VERIFY.
- EXISTING ROOM SIGNAGE.
- EXISTING CARD READER.
- REFERENCE DOOR SCHEDULE.
- PAINT INTERIOR SIDE OF EXISTING WINDOW GLAZING ONLY "FLAT BLACK".
- REINSTALLED EXISTING ROOM SIGNAGE.
- REINSTALLED EXISTING CARD READER.
- PLASTER ASSEMBLY INFILL AT EXISTING WALL AS DETAILED AT EXISTING WINDOW OPENING.
- ENSURE EXISTING WALL VENT IS SECURELY CLOSED SHUT PRIOR TO COVER-UP.
- PROVIDE WALL PROTECTION TO MATCH EXISTING.
- PROVIDE NEW CEILING AS SCHEDULED.
- PROVIDE GYPSUM BOARD/STEEL STUD FRAMED FUR-DOWN AS DETAILED.
- PROVIDE 2' X 2' RAISED FLOOR SYSTEM AT 10" ABOVE THE 4TH FLOOR LEVEL.
- ELECTRICAL CONDUITS AND MECHANICAL PIPING PER MEP DRAWINGS.
- PROVIDE 5/8" GYPSUM BOARD WHERE EXISTING TILE WAINSCOT AND SUBSTRATE WAS REMOVED. TEXTURE AND FINISH TO MATCH EXISTING ADJACENT WALLS (4'-0"± HIGH, LOCATE AS INDICATED BY HEAVY LINE).
- TEXTURE AND FINISH EXISTING GYPSUM BOARD SUBSTRATE TO MATCH EXISTING ADJACENT WALLS.
- GYPSUM BOARD ASSEMBLY INFILL AS DETAILED AT EXISTING WINDOW OPENING.
- PROVIDE INFILL PER KEYED NOTE 29 AT VOID LEFT BY HEATER REMOVED.
- PROVIDE 1" THICK MINIMUM CONCRETE INFILL FLUSH WITH EXISTING CONCRETE TOPPING WHERE PORTIONS OF EXISTING CMU WALLS ARE REMOVED.
- PROVIDE PAINTED WOOD CHAIR RAIL TO MATCH EXISTING.
- REINSTALLED EXISTING SHELF.
- PROVIDE GYPSUM BOARD/METAL STUD FRAMED CHASE FROM FLOORS ABOVE. MINIMIZE SIZE AND REFERENCE MEP DRAWINGS FOR COMPONENTS TO BE IN CHASE.
- RAMP AND RAILS BY RAISED FLOOR SYSTEM MANUFACTURER.
- ROOM PERIMETER WALLS TO BE FULLY SEALED TOP AND BOTTOM ON BOTH SIDES OF WALL. EXTERIOR WALL SEAL INTERIOR SIDE ONLY.

GENERAL NOTES - RENOVATION

- REFERENCE GENERAL NOTES ON SHEET GI-004.
- UNLESS NOTED OTHERWISE, ALL EXISTING WALLS ARE 5/8" GYPSUM BOARD/3 5/8" METAL STUD FRAMED TO UNDERSIDE OF PRIMARY BUILDING FRAMING STRUCTURE (1 HR. FIRE RATED - CONSTRUCTION SIMILAR TO U.I. DESIGN NO. U465). CONTRACTOR TO VERIFY.
- UNLESS NOTED OTHERWISE, ALL EXISTING DOOR ASSEMBLIES ARE SOLID CORE WOOD DOORS/HOLLOW METAL FRAME TYPICAL (3'-0" X 7'-0").
- UNLESS NOTED OTHERWISE ALL EXISTING LAY-IN CEILING ASSEMBLIES ARE 2' X 2' STANDARD GRID WITH FISSURED TILES AT 8'-0" A.F.F. TYPICAL.
- UNLESS NOTED OTHERWISE, ALL EXISTING STEEL COLUMN FUR-OUTS ARE GYPSUM BOARD/METAL STUD FRAMED TYPICAL.
- PARTIAL OR ENTIRE RECONSTRUCTION OF SOME EXISTING CEILING ASSEMBLIES THROUGHOUT THE ENTIRE BUILDING(S), ESPECIALLY IN CORRIDORS, WILL BE NECESSARY. REFERENCE ALL DISCIPLINE DEMOLITION DRAWINGS. RECONSTRUCTION IS TO INCLUDE MISCELLANEOUS PATCHING /REPAIR TO MATCH EXISTING OR BETTER CONDITIONS.
- EXISTING FIRE-RATED WALL IDENTIFICATION INDICATED ONLY FOR IMMEDIATE AFFECTED ROOM WALLS. CONTRACTOR SHALL VERIFY FULL EXTENT OF EXISTING FIRE-RATED WALLS AT ADJACENT AREAS.
- ALL NEW WALLS SHALL BE PARTITION TYPE "1" UNLESS OTHERWISE NOTED.
- UNLESS NOTED OTHERWISE AT ALL ROOMS WHERE EXISTING LAY-IN CEILING IS REMOVED AND IS TO BECOME A "NO CEILING" ROOM, THE EXISTING GYPSUM BOARD ABOVE PREVIOUSLY REMOVED CEILING IS TO BE FULLY TAPED, FLOATED, TEXTURED AND PAINTED TO MATCH EXISTING WALLS.

KEYED NOTES - RENOVATION (CONT.)

- TEMPORARY ALUMINUM RAMP BY CONTRACTOR TO BE RETURNED TO OWNER AT END OF JOB.
- MODULAR BRICK INFILL ON EXTERIOR TO MATCH EXISTING. TOOTH-IN AND MATCH MORTAR.

LEGEND - RENOVATION

- EXISTING WALL TO REMAIN
- NEW WALL CONSTRUCTION
- EXISTING DOOR/FRAME ASSEMBLY TO REMAIN
- NEW DOOR/FRAME ASSEMBLY
- EXISTING WINDOW ASSEMBLY TO REMAIN
- NEW WINDOW ASSEMBLY
- 1 HR. FIRE-RATED WALL (EXISTING)
- 2 HR. FIRE-RATED WALL (EXISTING)
- FIRE-RATED WALL (NEW OR EXISTING 1 HOUR UNLESS NOTED OTHERWISE)

Revisions:	Date:

CONSULTANT

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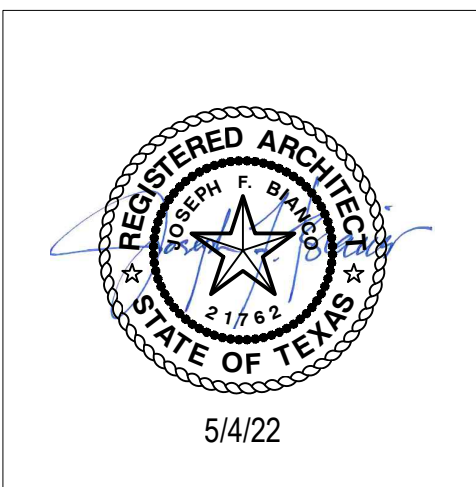
PROJECT MANAGEMENT

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Construction and Facilities Management

**VA** U.S. Department of Veterans Affairs

Drawing Title

ENLARGED FLOOR PLANS - 6TH FLOOR RENOVATION

Approved: Project Director

Phase

100% CONSTRUCTION DOCUMENTS

FULLY SPRINKLERED

Project Title

CINCINNATI VAMC EHRM INFRASTRUCTURE UPGRADES

Location  
3200 VINE ST., CINCINNATI, OH

Issue Date  
4-MAY-2022

Checked


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Project Number  
539-21-701


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Drawing Number  
AS-406-C.1.6







1 STORAGE A702A & STORAGE A704A - ROOM RENOVATION  
SCALE: 1/4" = 1'-0"

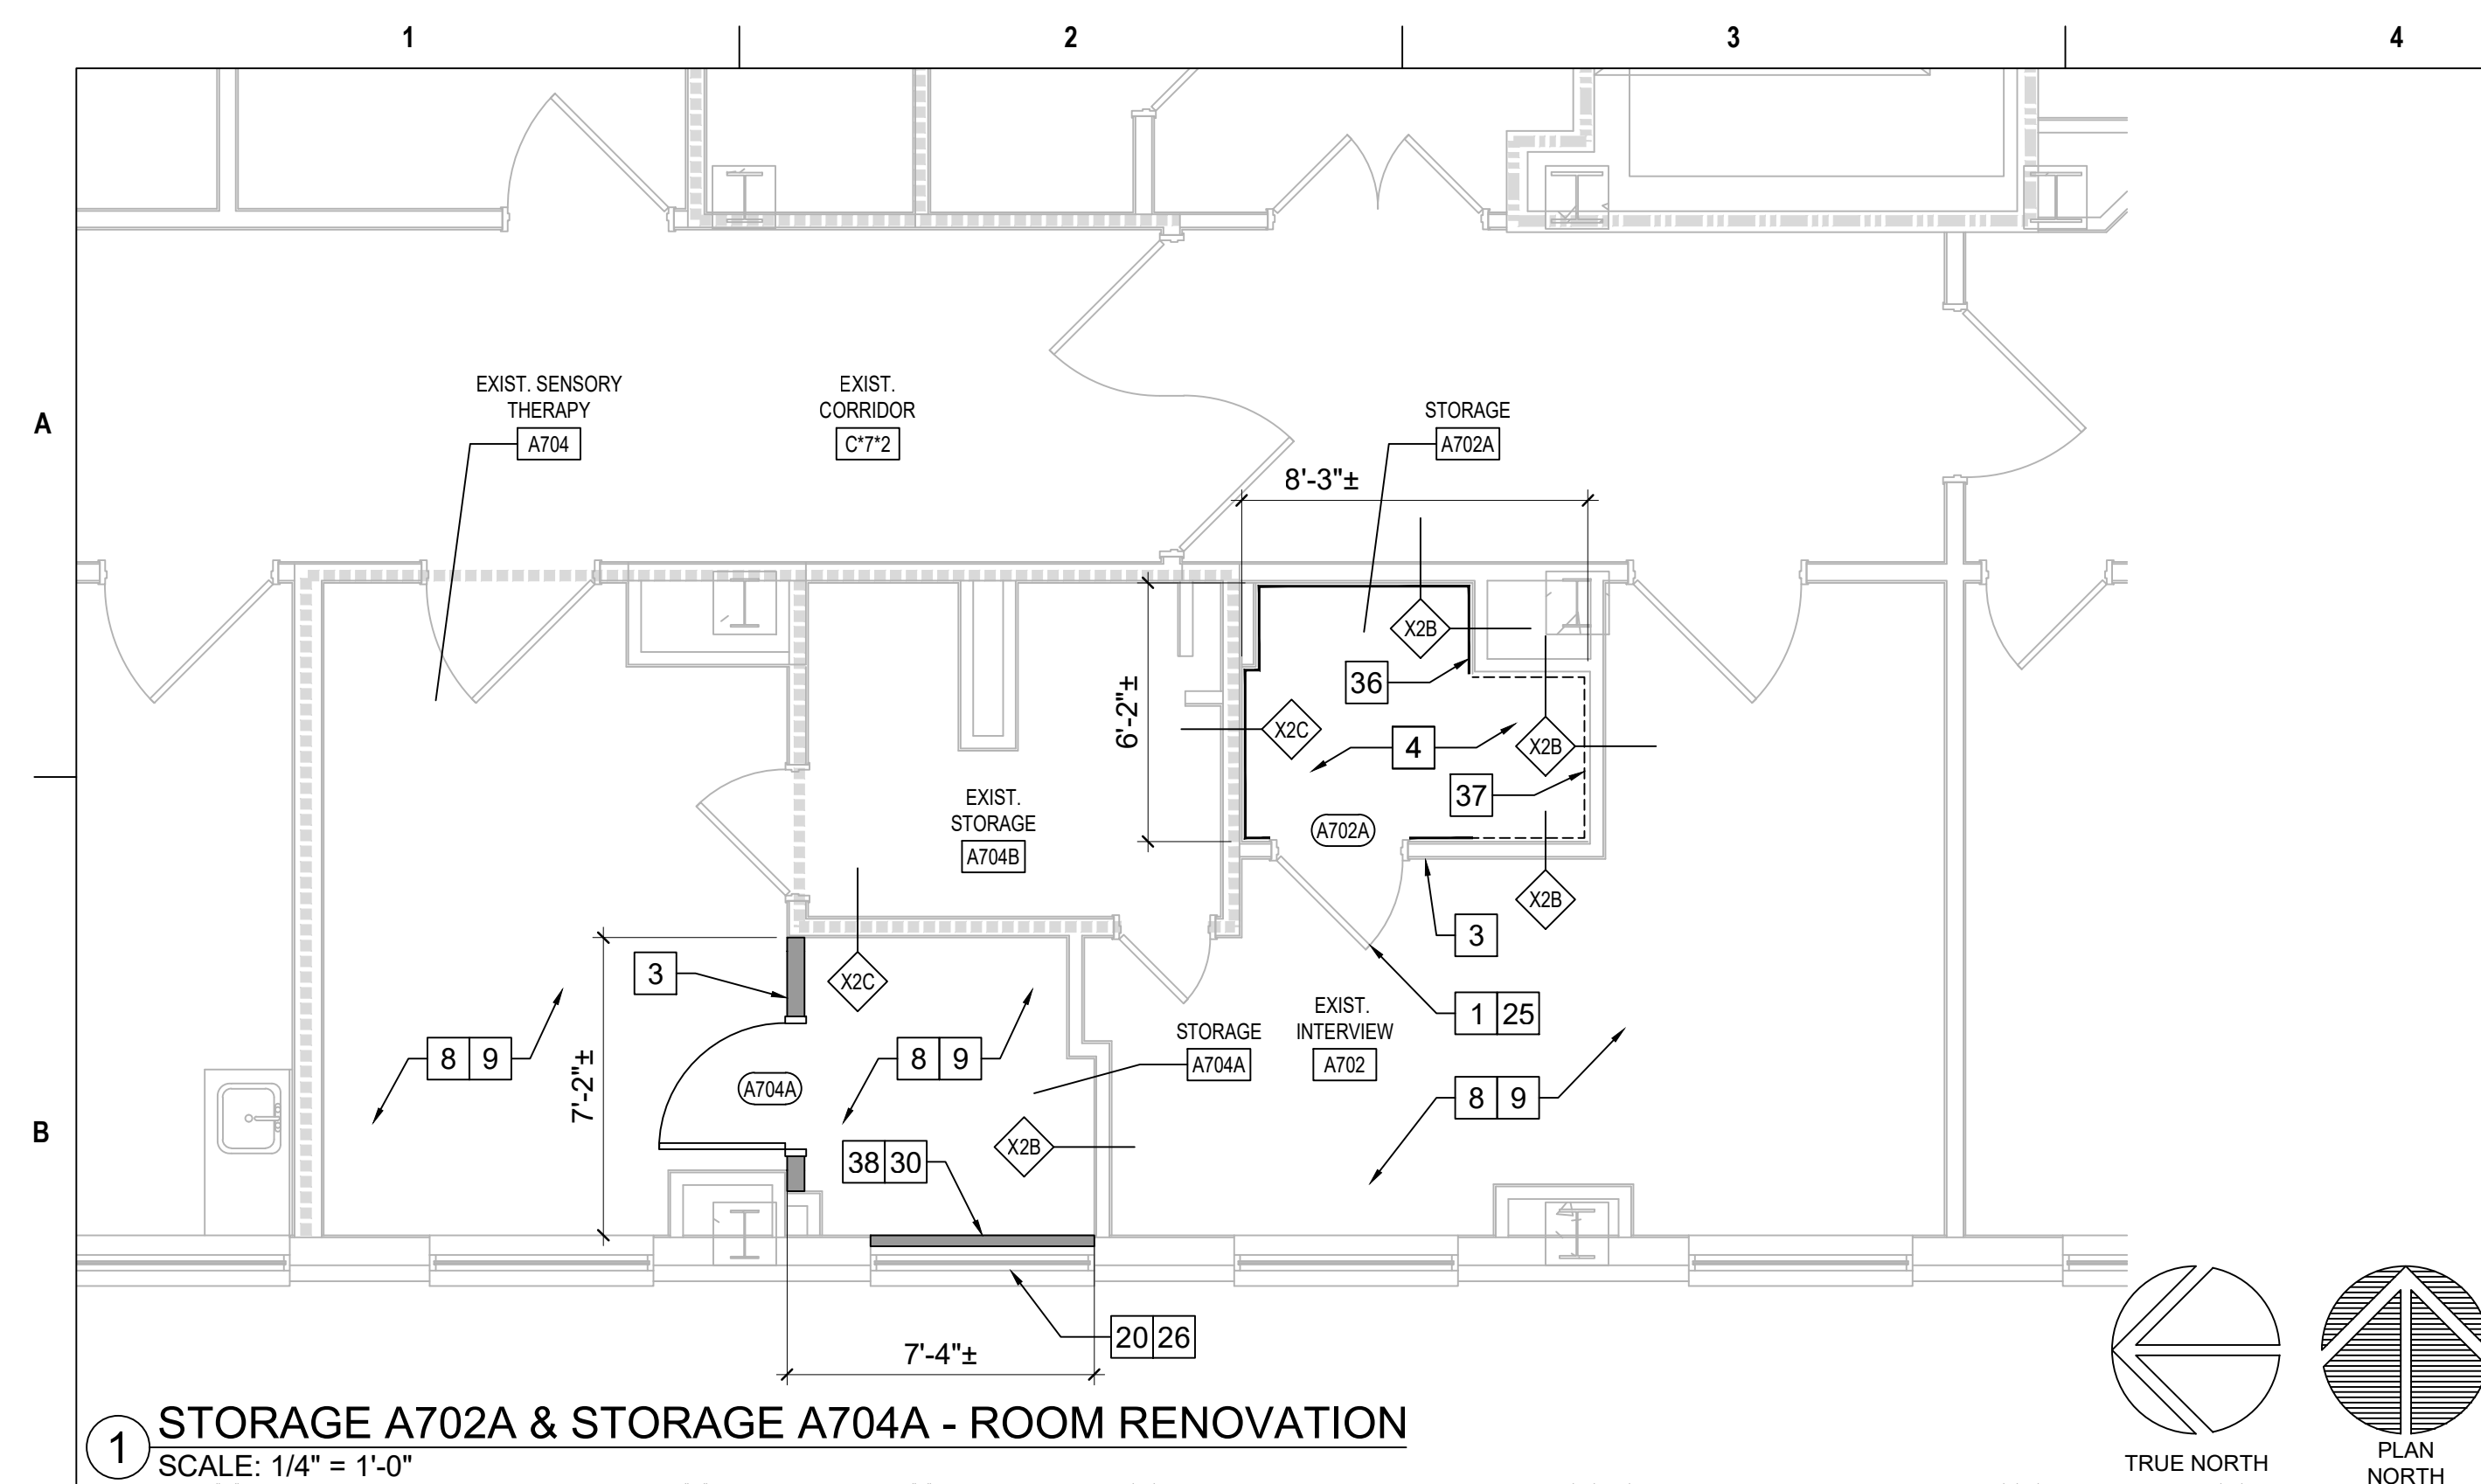

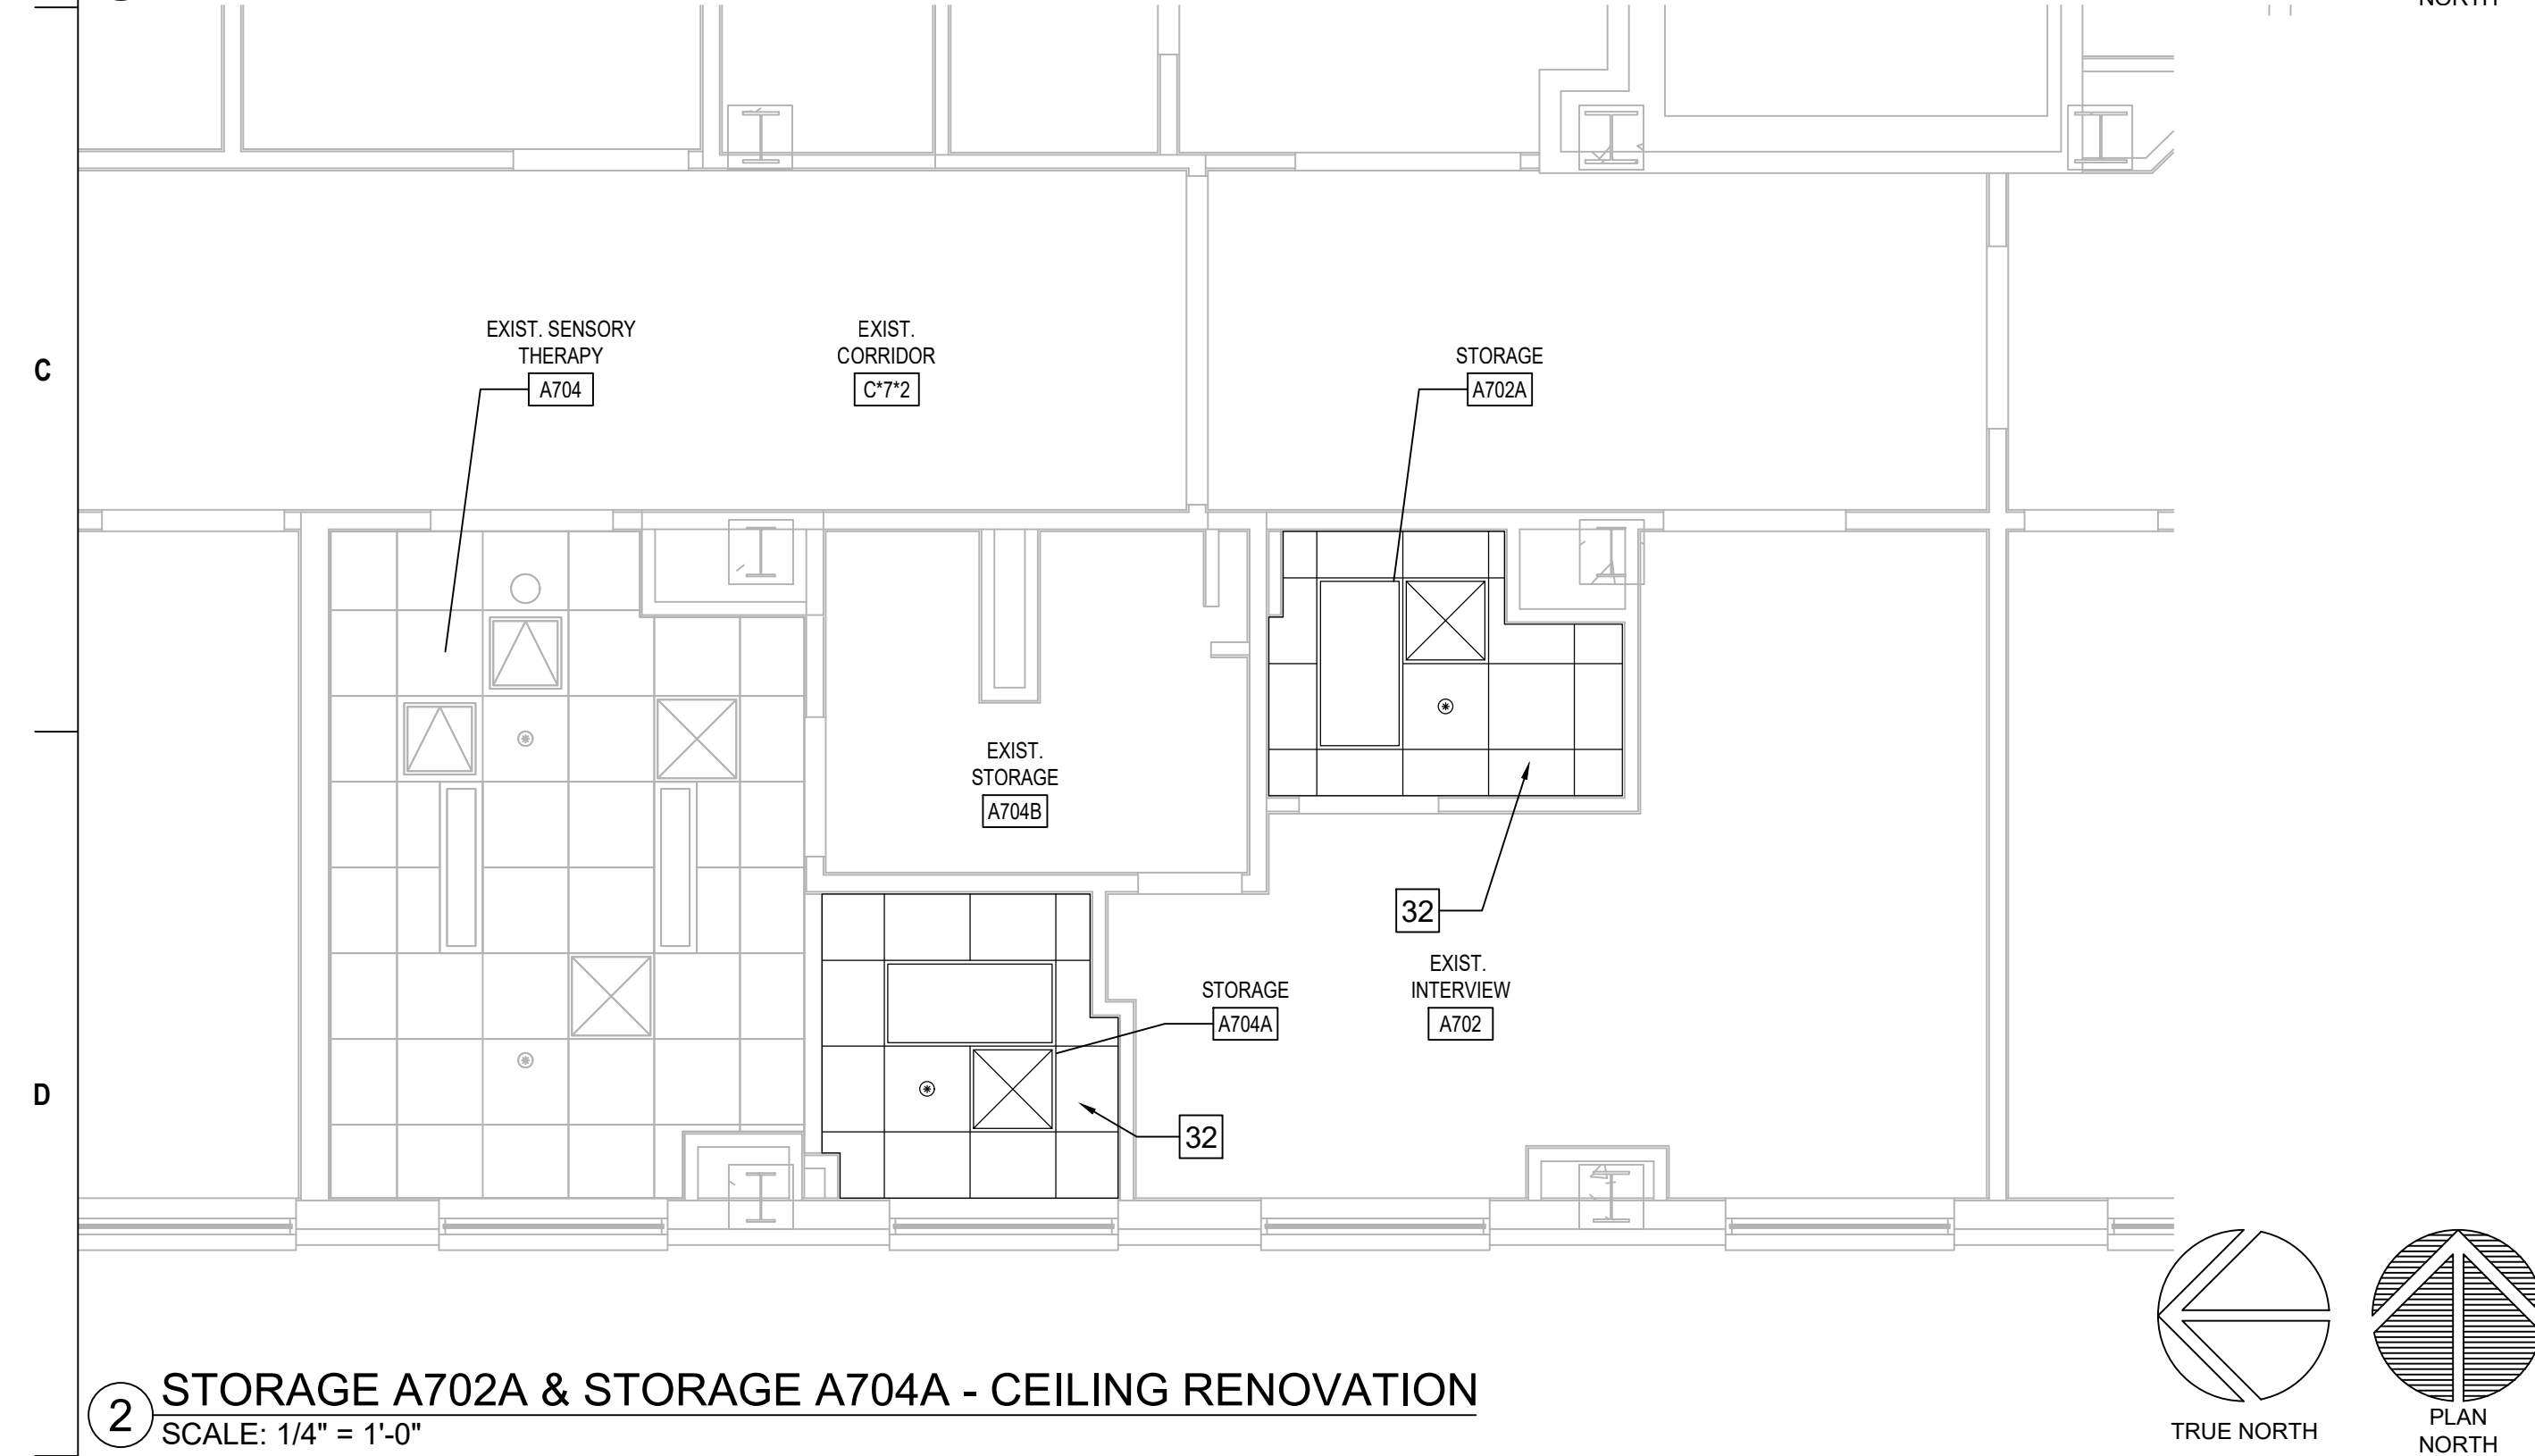2 STORAGE A702A & STORAGE A704A - CEILING RENOVATION  
SCALE: 1/4" = 1'-0"

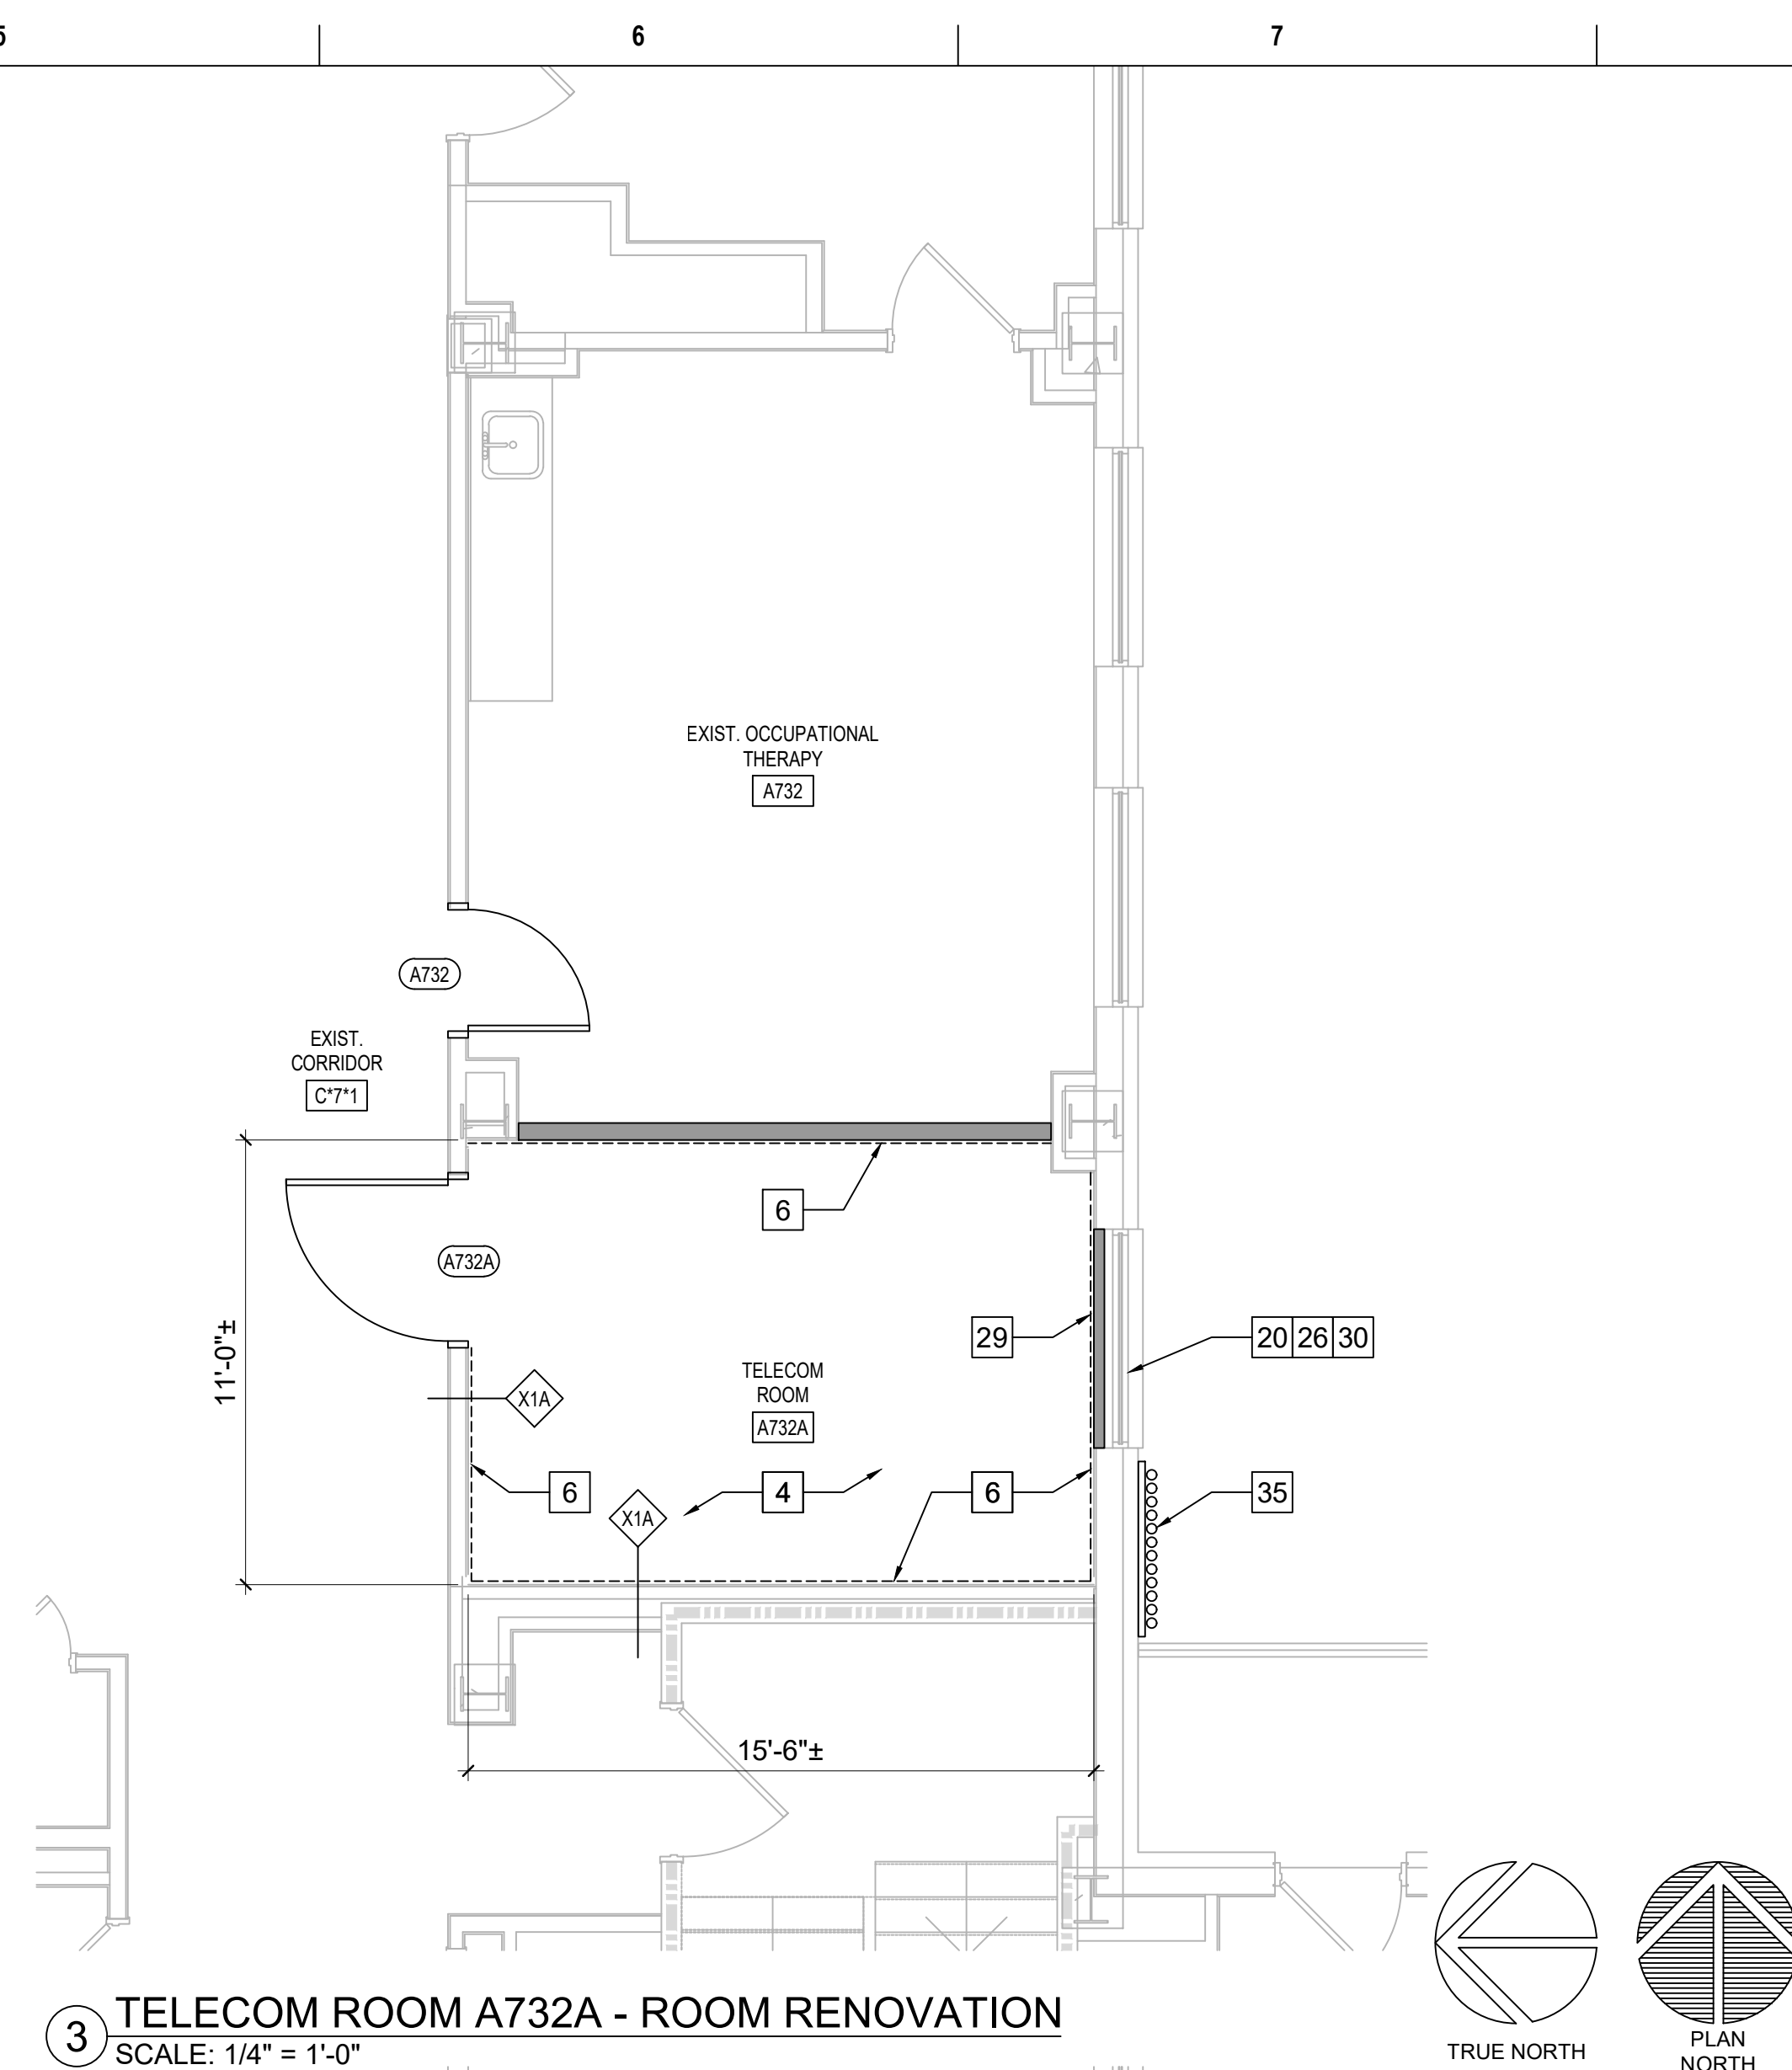

3 TELECOM ROOM A732A - ROOM RENOVATION  
SCALE: 1/4" = 1'-0"

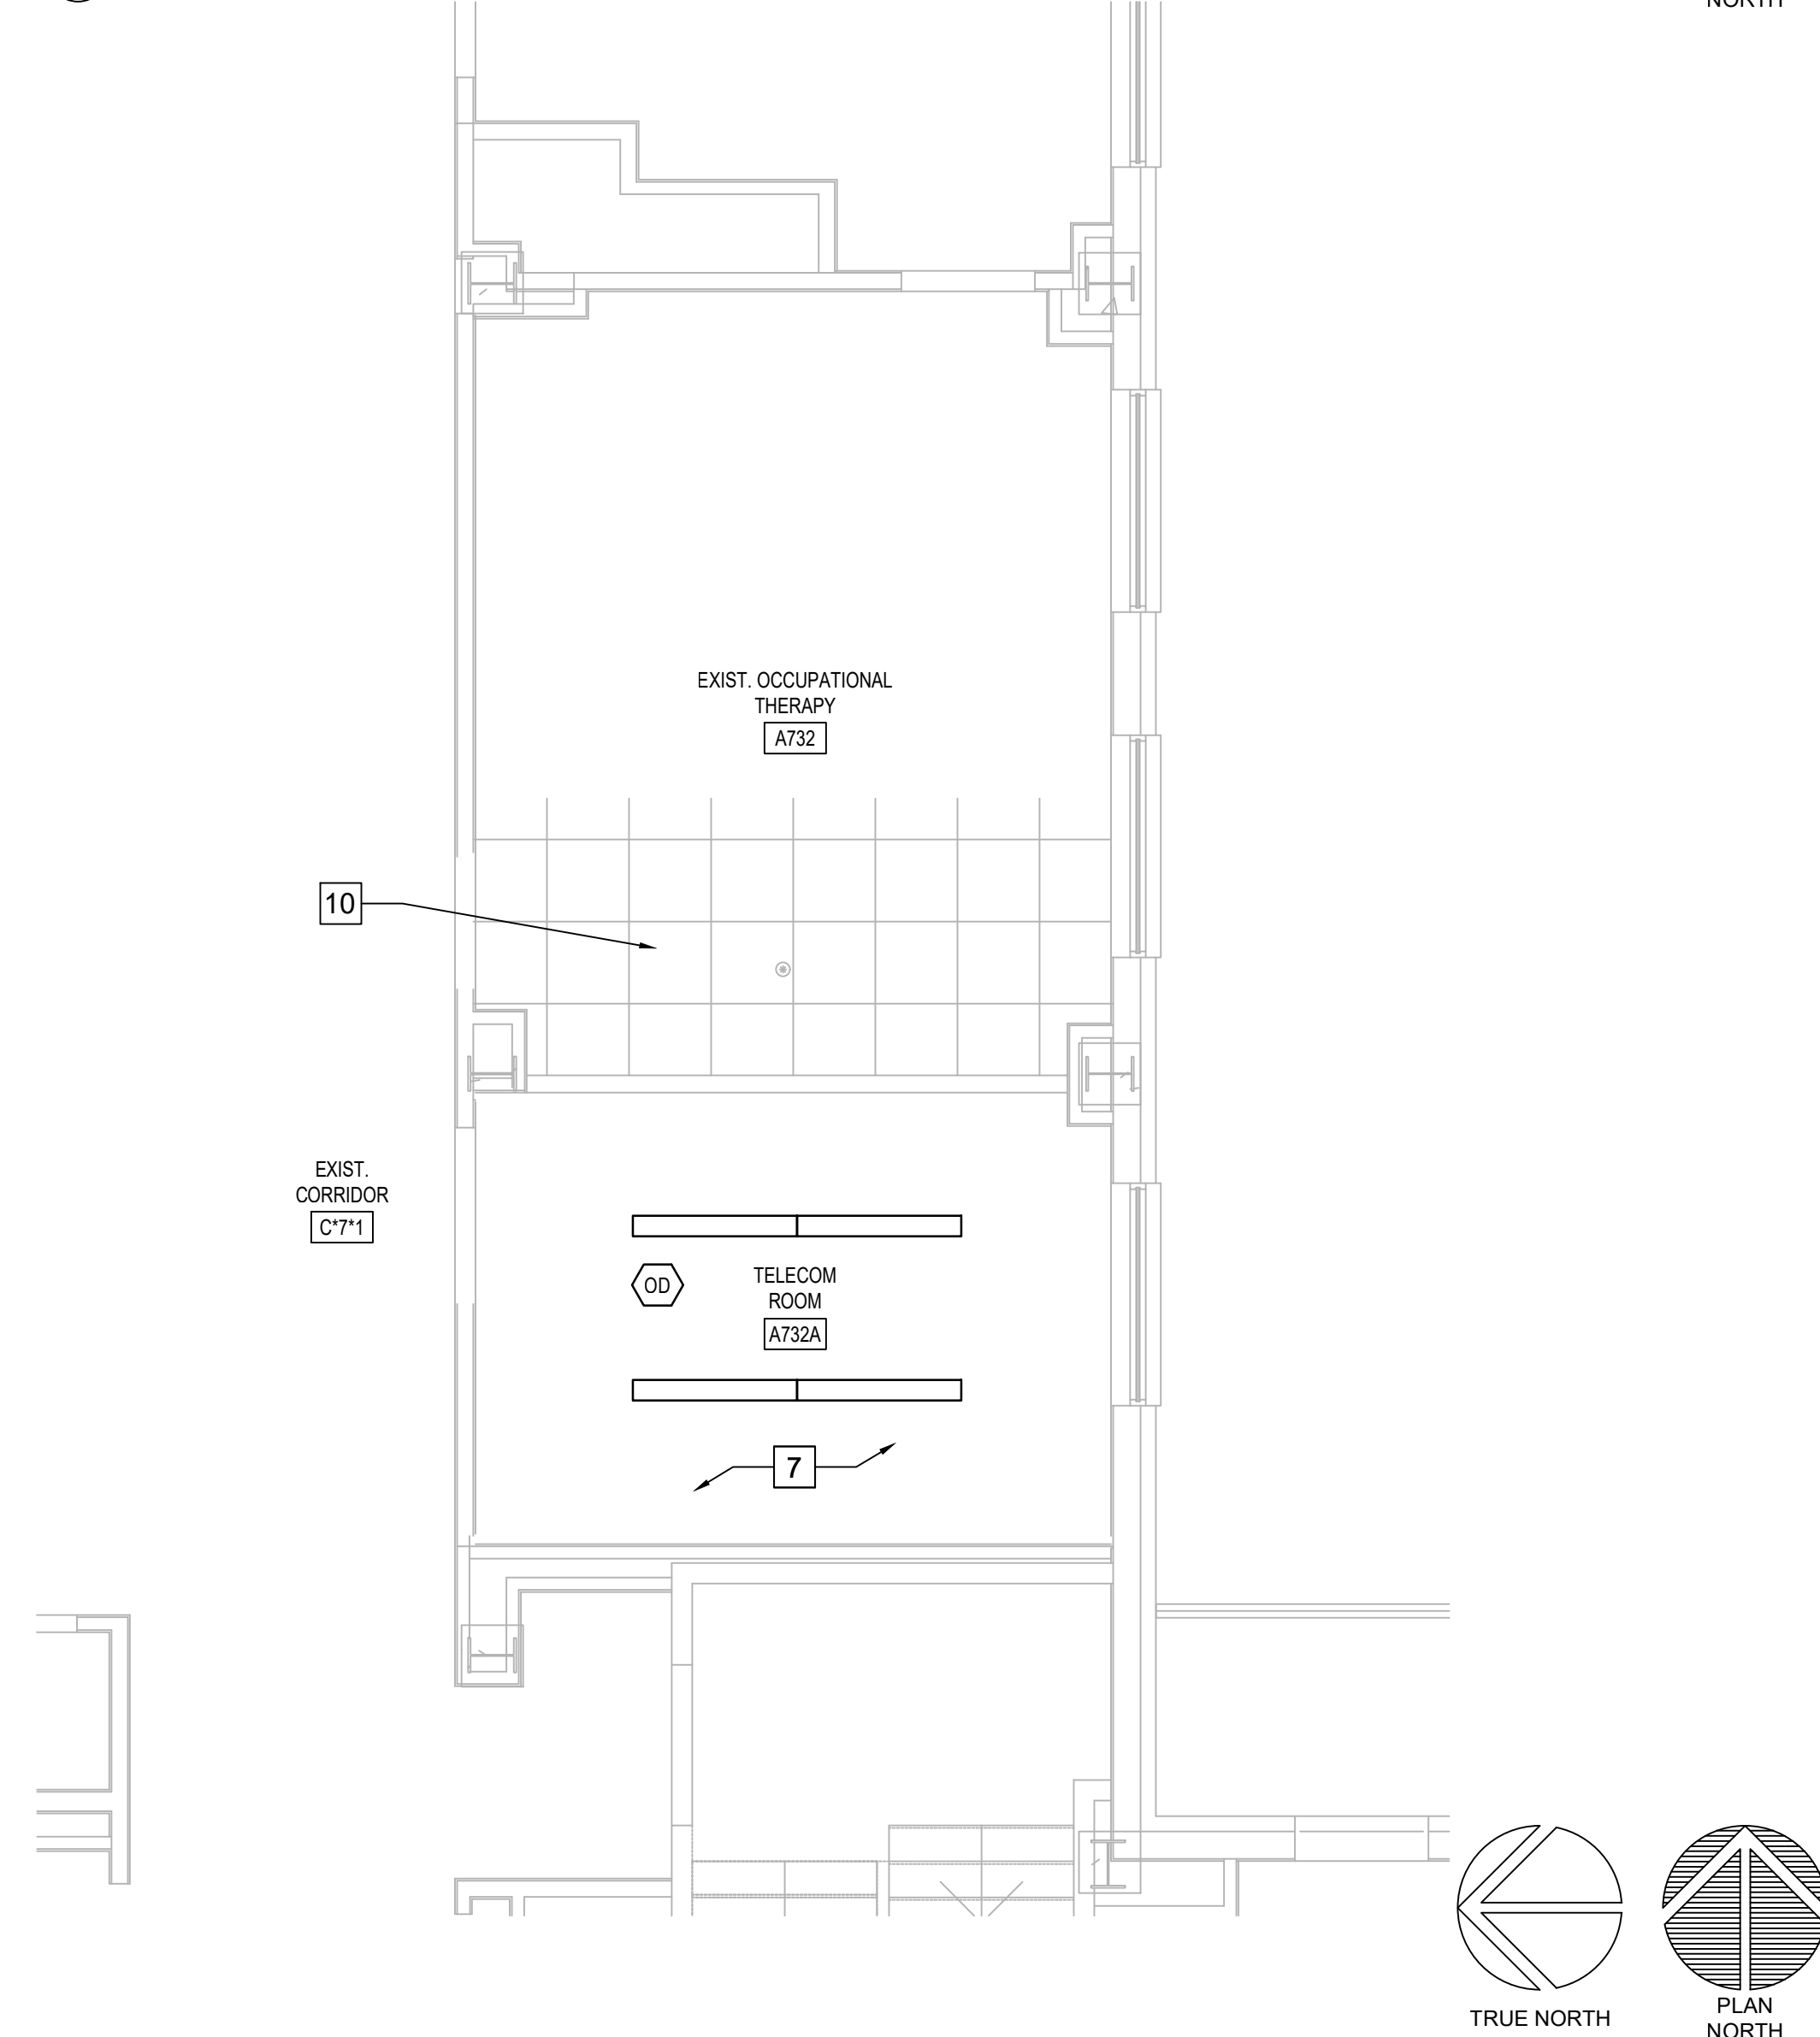

4 TELECOM ROOM A732A - CEILING RENOVATION  
SCALE: 1/4" = 1'-0"

KEYED NOTES - RENOVATION

1. EXISTING DOOR/FRAME ASSEMBLY TO REMAIN.
2. PROVIDE CARD READER.
3. PROVIDE ROOM SIGNAGE.
4. PROVIDE NEW FLOORING AND BASE AS SCHEDULED.
5. REFERENCE MEP AND TECHNOLOGY DRAWINGS FOR WORK SCOPE IN THIS ROOM THAT MAY REQUIRE MINOR DEMOLITION, PATCHING AND REPAIR OF EXISTING FLOOR SUBSTRATE, WALL OR MISCELLANEOUS ASSEMBLIES.
6. PROVIDE 8"x4 3/4" "AC" FACED FIRE-RATED PLYWOOD VERTICALLY ON ALL WALLS AS INDICATED. PAINT WITH 2 COATS MIN. FIRE-RATED PAINT. COORDINATE EXACT LOCATION A.F.F. WITH TECHNOLOGY AND ELECTRICAL DRAWINGS AND EXISTING CONDITIONS.
7. REFERENCE MEP AND TECHNOLOGY DRAWINGS FOR WORK SCOPE OF EXISTING AND NEW COMPONENTS AT CEILING LEVEL.
8. EXISTING FLOOR AND BASE TO REMAIN. REPAIR AS NECESSARY TO MATCH EXISTING CONDITIONS OR BETTER.
9. EXISTING VCT FLOORING AND RUBBER BASE TO REMAIN.
10. LIMITED RENOVATION TO EXISTING CEILING ASSEMBLY PER MEP AND TECHNOLOGY DRAWINGS WORK SCOPE.
11. RELOCATED EXISTING MARKER BOARD.
12. RELOCATED EXISTING MILLWORK.
13. CEILING FUR-DOWN ABOVE.
14. NEW GYPSUM BOARD/METAL STUD FRAMED FUR-DOWN TO MATCH EXISTING HEIGHT, NO JOINTS UNLESS NOTED OTHERWISE.
15. RELOCATED EXISTING LIGHT FIXTURE.
16. RELOCATED EXISTING TV MONITOR.
17. EXISTING ALUMINUM FLOOR AND WALL (EACH SIDE) EXPANSION JOINT COVERS TO REMAIN.
18. EXISTING GYPSUM BOARD/METAL STUD FRAMED FUR-DOWN TO REMAIN.
19. RELOCATED EXISTING FIRE EXTINGUISHER.
20. EXISTING EXTERIOR WINDOW TO REMAIN.
21. REINSTALL EXISTING SALVAGED WOOD BASE AND CHAIR RAIL PROVIDE BALANCE OF MATERIAL AS NEEDED TO COMPLETE JOB. PAINT ALL BASE AND CHAIR RAIL IN ENTIRE ROOM.
22. EXISTING PLASTER ON CMU TO UNDERSIDE OF EXISTING STRUCTURE (8" CMU PER WALL THICKNESS DEPICTED GRAPHICALLY), FIRE-RATED WALL. CONTRACTOR VERIFY.



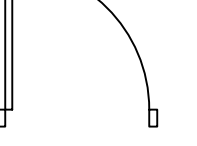




### GENERAL NOTES - RENOVATION

1. REFERENCE GENERAL NOTES ON SHEET GI-004.
2. UNLESS NOTED OTHERWISE, ALL EXISTING WALLS ARE 5/8" GYPSUM BOARD/3 5/8" METAL STUD FRAMED TO UNDERSIDE OF PRIMARY BUILDING FRAMING STRUCTURE (1 HR. FIRE RATED - CONSTRUCTION SIMILAR TO U.I. DESIGN NO. U465). CONTRACTOR TO VERIFY.
3. UNLESS NOTED OTHERWISE, ALL EXISTING DOOR ASSEMBLIES ARE SOLID CORE WOOD DOOR/SHOLLOW METAL FRAME TYPICAL (3'-0" X 7'-0").
4. UNLESS NOTED OTHERWISE ALL EXISTING LAY-IN CEILING ASSEMBLIES ARE 2' X 2' STANDARD GRID WITH FISSIONED TILES AT 8" O.C. TYPICAL.
5. UNLESS NOTED OTHERWISE, ALL EXISTING STEEL COLUMN FUR-OUTS ARE GYPSUM BOARD/METAL STUD FRAMED TYPICAL.
6. PARTIAL OR ENTIRE RECONSTRUCTION OF SOME EXISTING CEILING ASSEMBLIES THOUGH OUT THE ENTIRE BUILDING(S), ESPECIALLY IN CORRIDORS, WILL BE NECESSARY. REFERENCE ALL DISCIPLINE DEMOLITION DRAWINGS. RECONSTRUCTION IS TO INCLUDE MISCELLANEOUS PATCHING/REPAIR TO MATCH EXISTING OR BETTER CONDITIONS.
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8. ALL NEW WALLS SHALL BE PARTITION TYPE "1" UNLESS OTHERWISE NOTED.
9. UNLESS NOTED OTHERWISE AT ALL ROOMS WHERE EXISTING LAY-IN CEILING IS REMOVED AND IS TO BE REPLACED, A TWO CEILING DESIGN NO. 1045 EXISTING GYPSUM BOARD ABOVE PREVIOUSLY REMOVED CEILING IS TO BE FULLY TAPED, FLOATED, TEXTURED AND PAINTED TO MATCH EXISTING WALLS.

KEYED NOTES - RENOVATION (CONT.)

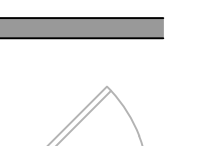
46. TEMPORARY ALUMINUM RAMP BY CONTRACTOR TO BE RETURNED TO OWNER AT END OF JOB.
47. MODULAR BRICK INFILL ON EXTERIOR TO MATCH EXISTING. TOOTH-IN AND MATCH MORTAR.

LEGEND - RENOVATION

	<p>EXISTING WALL TO REMAIN</p> <p>NEW WALL CONSTRUCTION</p>
	<p>EXISTING DOOR/FRAME ASSEMBLY TO REMAIN</p>
	<p>NEW DOOR/FRAME ASSEMBLY</p>
	<p>EXISTING WINDOW ASSEMBLY TO REMAIN</p>
	<p>NEW WINDOW ASSEMBLY</p>
	<p>1 HR. FIRE-RATED WALL (EXISTING)</p>
	<p>2 HR. FIRE-RATED WALL (EXISTING)</p>
	<p>FIRE-RATED WALL (NEW OR EXISTING 1 HOUR UNLESS NOTED OTHERWISE)</p>

[illegible]

The logo for HFS CONSULTANT. It features the letters 'HFS' in a large, bold, sans-serif font. The 'H' is red, and the 'F' and 'S' are grey. Below the letters, the word 'CONSULTANT' is written in a smaller, black, sans-serif font. The entire logo is set against a white background.

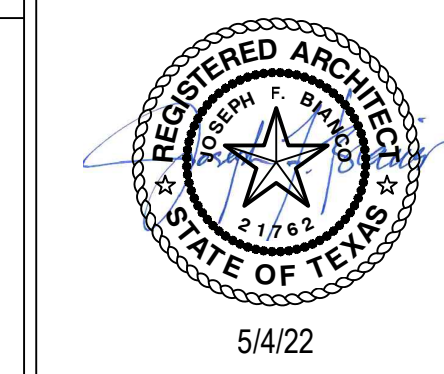

Construction  
and Facilities  
Management

**VA** | U.S. Department  
of Veterans Affairs

Drawing Title

**ENLARGED FLOOR PLAN -  
SEVENTH FLOOR - RENOVATION**





Approved: Project Director

Phase	100% CONSTRUCTION DOCUMENTS
ON	FULLY SPRINKLERED

Project Title		
CINCINNATI VAMC EHRM INFRASTRUCTURE UPGRADES		
Location		
3200 VINE ST., CINCINNATI, OH		
Issue Date	Checked	Drawn
4-MAY-2022	IAR, JFB	IAR

Project Number	539-21-701
Building Number	1
Drawing Number	AS-407-C.1.7



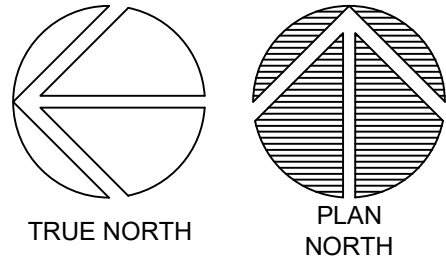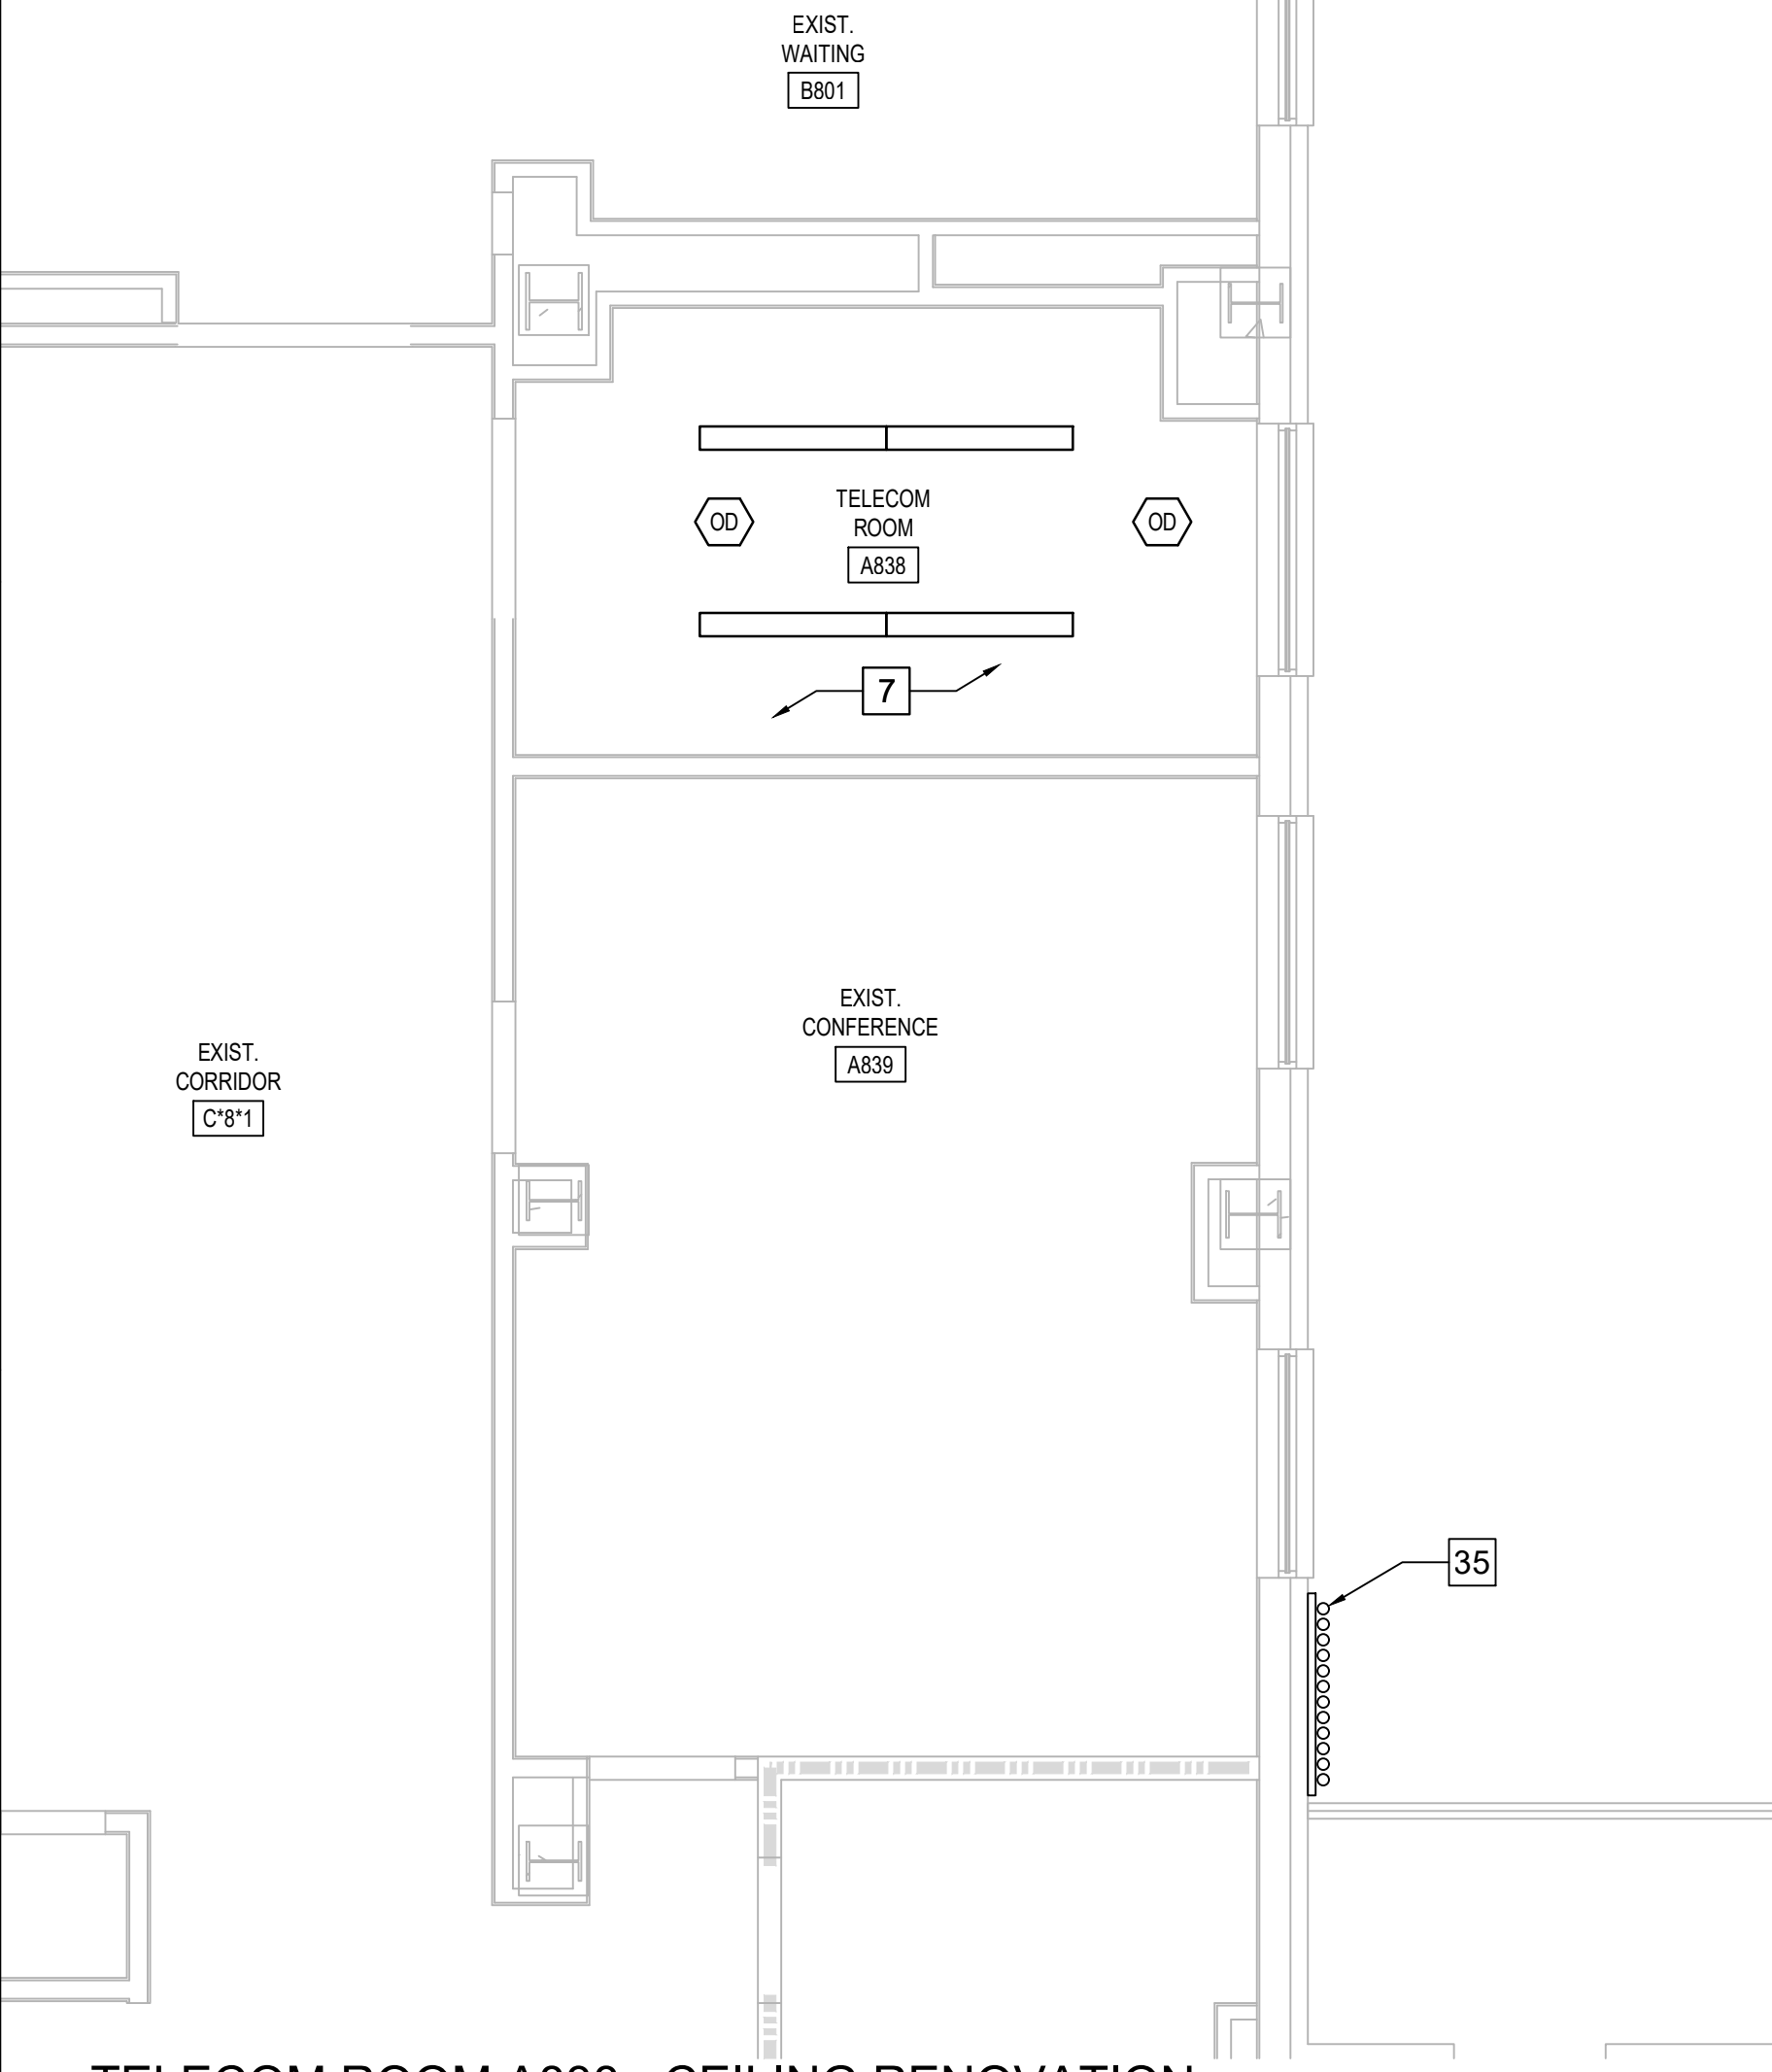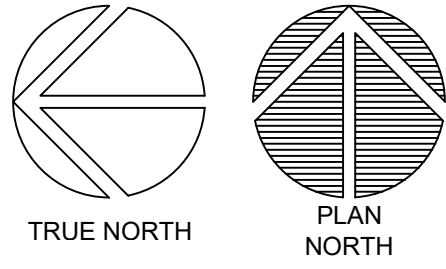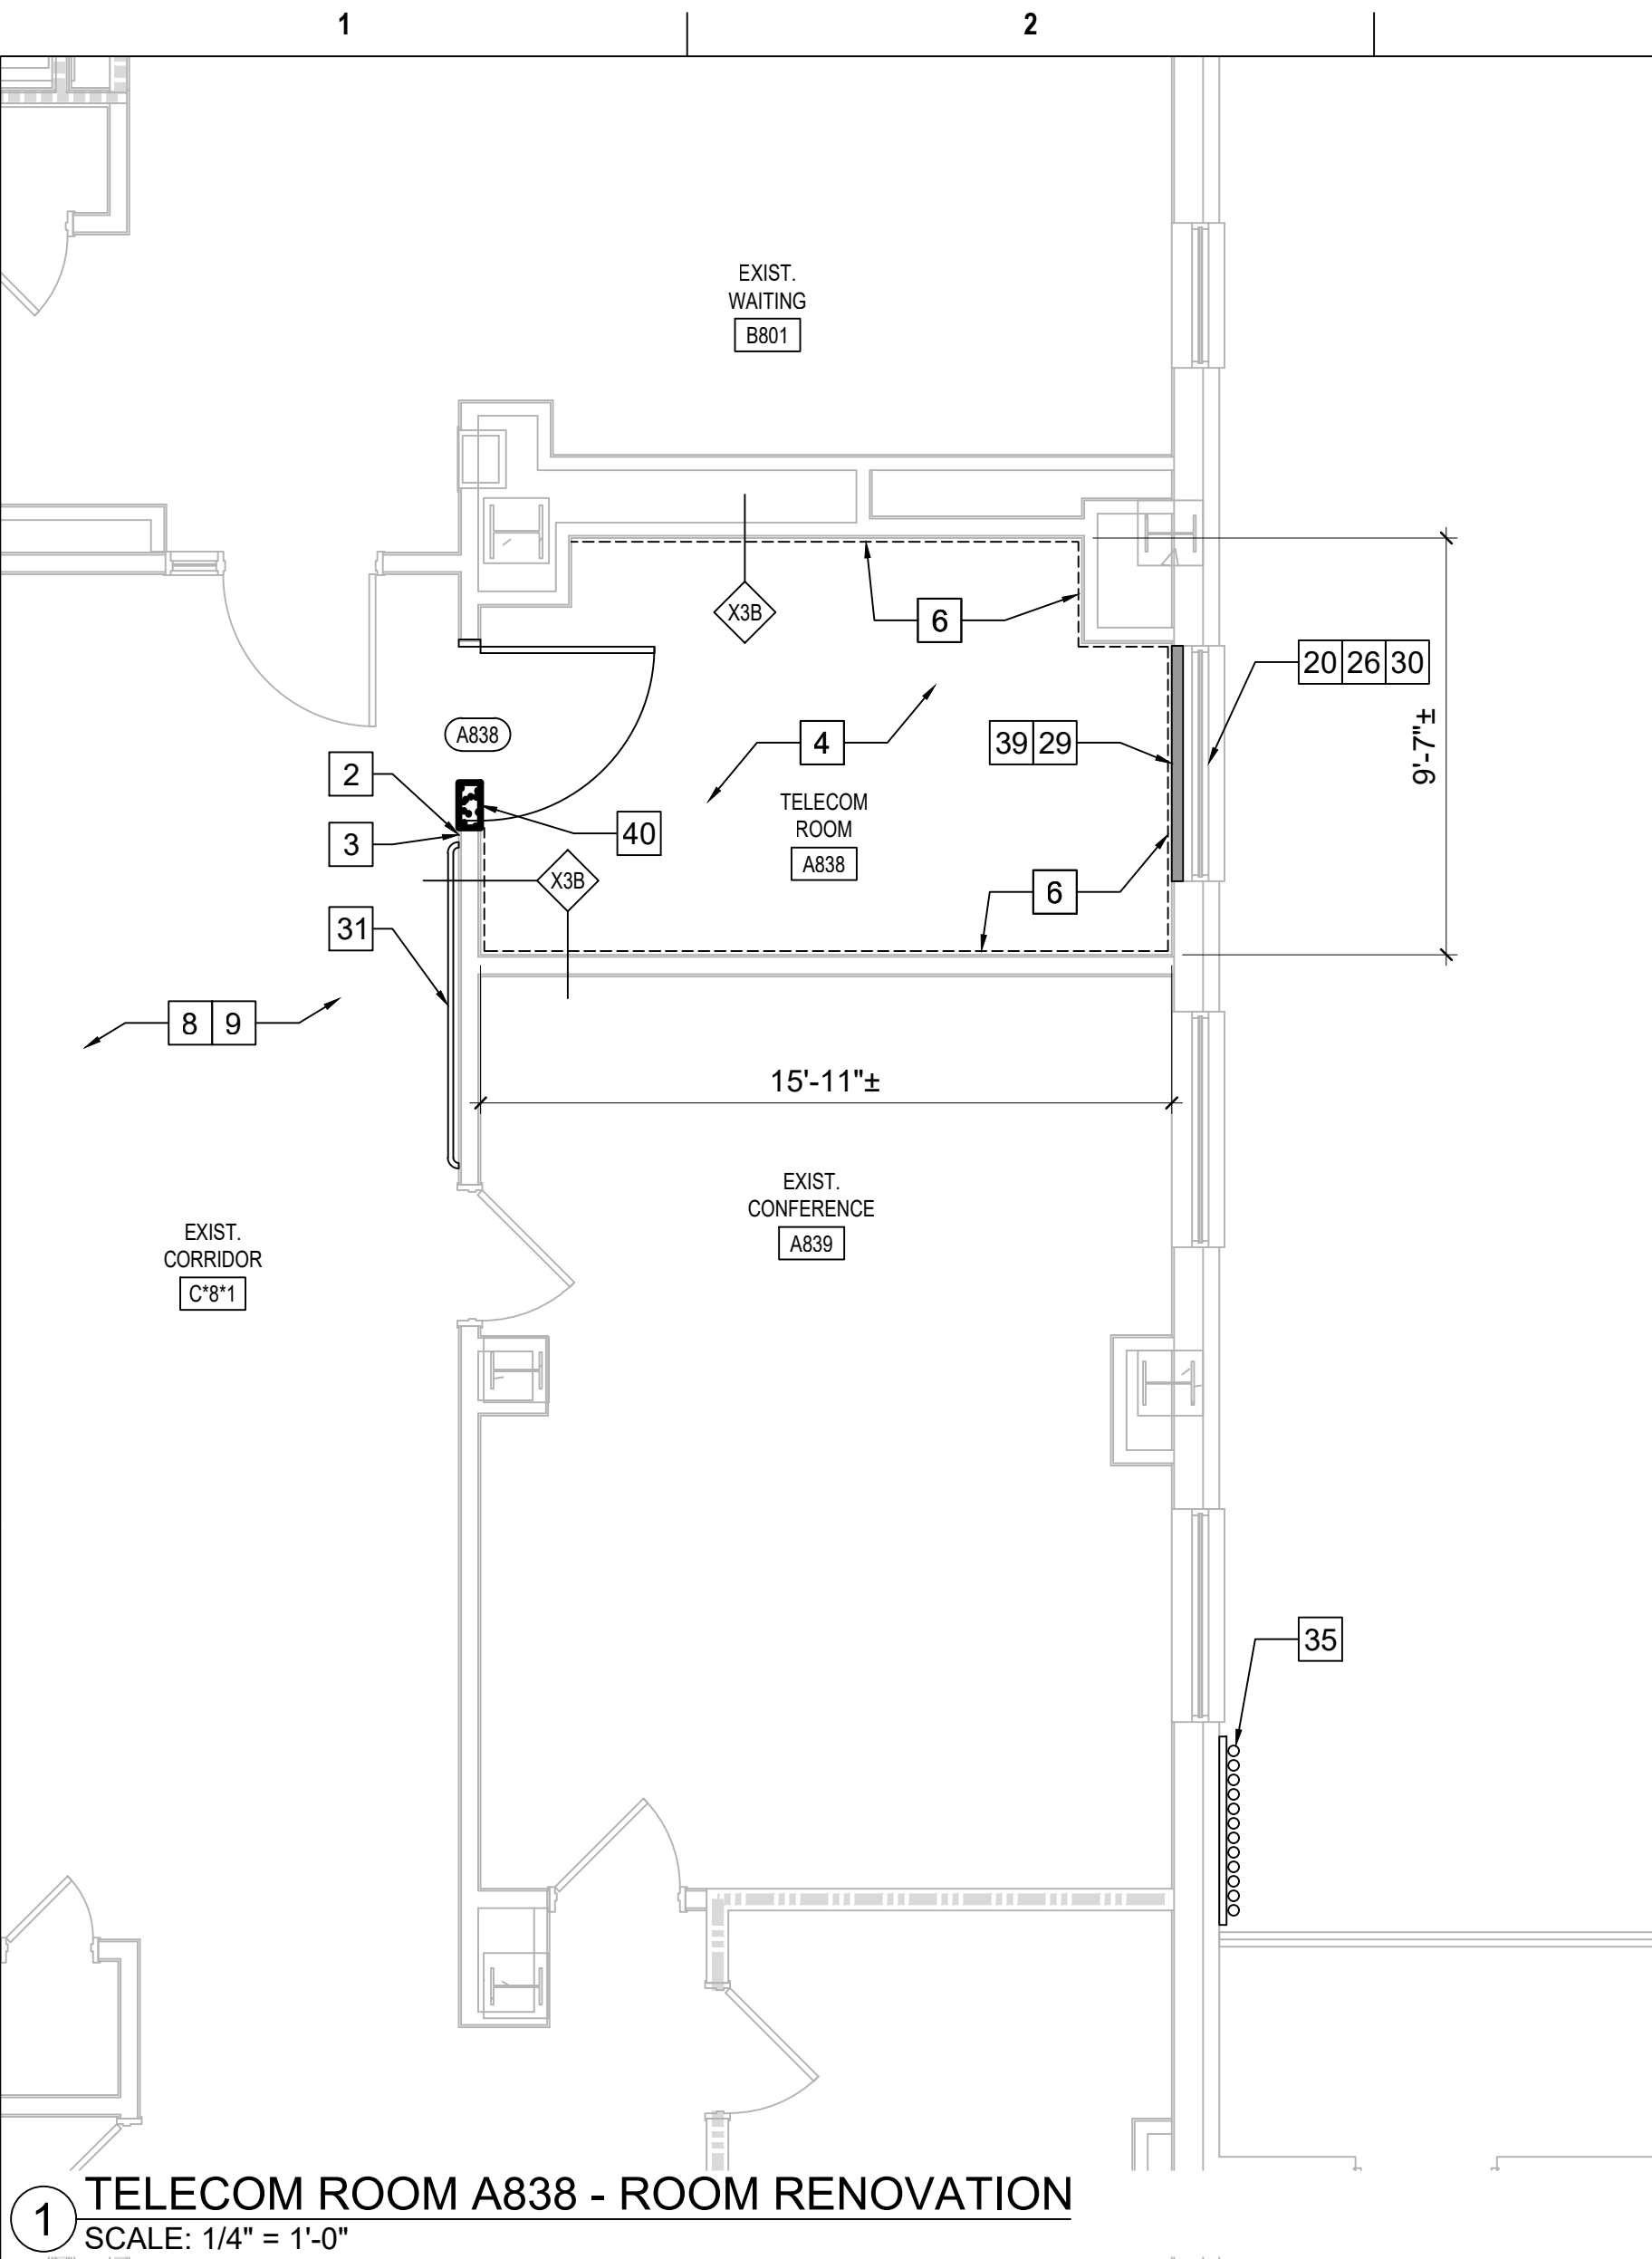

Revisions:	Date:

CONSULTANT



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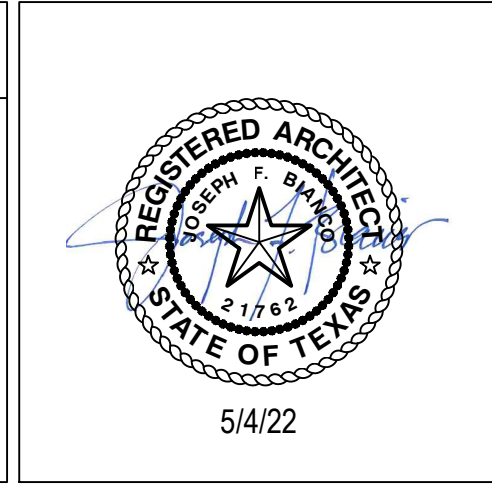
PROJECT MANAGEMENT



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Construction  
and Facilities  
Management

 U.S. Department  
of Veterans Affairs

Drawing Title

ENLARGED FLOOR PLAN -  
EIGHTH FLOOR - RENOVATION

Approved: Project Director

Phase

100% CONSTRUCTION  
DOCUMENTS

FULLY SPRINKLERED

Project Title

CINCINNATI VAMC EHRM  
INFRASTRUCTURE UPGRADES

Location

3200 VINE ST., CINCINNATI, OH

Issue Date

4-MAY-2022

Checked

IAR, JFB

Drawn

IAR

Project Number

539-21-701

Building Number

1

Drawing Number

AS-408-C.1.8

- KEYED NOTES - RENOVATION
1. EXISTING DOOR/FRAME ASSEMBLY TO REMAIN.

2. PROVIDE CARD READER.

3. PROVIDE ROOM SIGNAGE.

4. PROVIDE NEW FLOORING AND BASE AS SCHEDULED.

5. REFERENCE MEP AND TECHNOLOGY DRAWINGS FOR WORK SCOPE IN THIS ROOM THAT MAY REQUIRE MINOR DEMOLITION, PATCHING AND REPAIR OF EXISTING FLOOR SUBSTRATE, WALL OR MISCELLANEOUS ASSEMBLIES.

6. PROVIDE 8"x4"x3/4" AC FACED FIRE-RATED PLYWOOD VERTICALLY ON ALL WALLS AS INDICATED. PAINT WITH 2 COATS MIN. FIRE-RATED PAINT. COORDINATE EXACT LOCATION A.F.F. WITH TECHNOLOGY AND ELECTRICAL DRAWINGS AND EXISTING CONDITIONS.

7. REFERENCE MEP AND TECHNOLOGY DRAWINGS FOR WORK SCOPE OF EXISTING AND NEW COMPONENTS AT CEILING LEVEL.

8. EXISTING FLOOR AND BASE TO REMAIN. REPAIR AS NECESSARY TO MATCH EXISTING CONDITIONS OR BETTER.

9. EXISTING VCT FLOORING AND RUBBER BASE TO REMAIN.

10. LIMITED RENOVATION TO EXISTING CEILING ASSEMBLY PER MEP AND TECHNOLOGY DRAWINGS WORK SCOPE.

11. RELOCATED EXISTING MARKER BOARD.

12. RELOCATED EXISTING MILLWORK.

13. CEILING FUR-DOWN ABOVE.

14. NEW GYPSUM BOARD/METAL STUD FRAMED FUR-DOWN TO MATCH EXISTING HEIGHT. NO JOINTS UNLESS NOTED OTHERWISE.

15. RELOCATED EXISTING LIGHT FIXTURE.

16. RELOCATED EXISTING TV MONITOR.

17. EXISTING ALUMINUM FLOOR AND WALL (EACH SIDE) EXPANSION JOINT COVERS TO REMAIN.

18. EXISTING GYPSUM BOARD/METAL STUD FRAMED FUR-DOWN TO REMAIN.

19. RELOCATED EXISTING FIRE EXTINGUISHER.

20. EXISTING EXTERIOR WINDOW TO REMAIN.

21. REINSTALL EXISTING SALVAGED WOOD BASE AND CHAIR RAIL. PROVIDE BALANCE OF MATERIAL AS NEEDED TO COMPLETE JOB. PAINT ALL BASE AND CHAIR RAIL IN ENTIRE ROOM.

22. EXISTING PLASTER ON CMU TO UNDERSIDE OF EXISTING STRUCTURE (4" OR 8" CMU PER WALL THICKNESS DEPICTED GRAPHICALLY). FIRE-RATED WALL. CONTRACTOR VERIFY.

23. EXISTING ROOM SIGNAGE.

24. EXISTING CARD READER.

25. REFERENCE DOOR SCHEDULE.

26. PAINT INTERIOR SIDE OF EXISTING WINDOW GLAZING ONLY "FLAT BLACK".

27. REINSTALLED EXISTING ROOM SIGNAGE.

28. REINSTALLED EXISTING CARD READER.

29. PLASTER ASSEMBLY INFILL AT EXISTING WALL AS DETAILED AT EXISTING WINDOW OPENING.

30. ENSURE EXISTING WALL VENT IS SECURELY CLOSED SHUT PRIOR TO COVER-UP.

31. PROVIDE WALL PROTECTION TO MATCH EXISTING.

32. PROVIDE NEW CEILING AS SCHEDULED.

33. PROVIDE GYPSUM BOARD/STEEL STUD FRAMED FUR-DOWN AS DETAILED.

34. PROVIDE 2' X 2' RAISED FLOOR SYSTEM AT 10" ABOVE THE 4TH FLOOR LEVEL.

35. ELECTRICAL CONDUITS AND MECHANICAL PIPING PER MEP DRAWINGS.

36. PROVIDE 5/8" GYPSUM BOARD WHERE EXISTING TILE WAINSCOT AND SUBSTRATE WAS REMOVED. TEXTURE AND FINISH TO MATCH EXISTING ADJACENT WALLS (4'-0"± HIGH, LOCATE AS INDICATED BY HEAVY LINE).

37. TEXTURE AND FINISH EXISTING GYPSUM BOARD SUBSTRATE TO MATCH EXISTING ADJACENT WALLS.

38. GYPSUM BOARD ASSEMBLY INFILL AS DETAILED AT EXISTING WINDOW OPENING.

39. PROVIDE INFILL PER KEYED NOTE 29 AT VOID LEFT BY HEATER REMOVED.

40. PROVIDE 1" THICK MINIMUM CONCRETE INFILL FLUSH WITH EXISTING CONCRETE TOPPING WHERE PORTIONS OF EXISTING CMU WALLS ARE REMOVED.

41. PROVIDE PAINTED WOOD CHAIR RAIL TO MATCH EXISTING.

42. REINSTALLED EXISTING SHELF.

43. PROVIDE GYPSUM BOARD/METAL STUD FRAMED CHASE FROM FLOORS ABOVE. MINIMIZE SIZE AND REFERENCE MEP DRAWINGS FOR COMPONENTS TO BE IN CHASE.

44. RAMP AND RAILS BY RAISED FLOOR SYSTEM MANUFACTURER.

45. ROOM PERIMETER WALLS TO BE FULLY SEALED TOP AND BOTTOM ON BOTH SIDES OF WALL. EXTERIOR WALL SEAL INTERIOR SIDE ONLY.

- GENERAL NOTES - RENOVATION
1. REFERENCE GENERAL NOTES ON SHEET GI-004.

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8. ALL NEW WALLS SHALL BE PARTITION TYPE "1" UNLESS OTHERWISE NOTED.


9. UNLESS NOTED OTHERWISE AT ALL ROOMS WHERE EXISTING LAY-IN CEILING IS REMOVED AND IS TO BECOME A "NO CEILING" ROOM, THE EXISTING GYPSUM BOARD ABOVE PREVIOUSLY REMOVED CEILING IS TO BE FULLY TAPED, FLOATED, TEXTURED AND PAINTED TO MATCH EXISTING WALLS.


KEYED NOTES - RENOVATION (CONT.)


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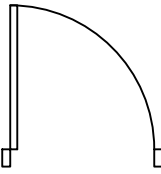
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
LEGEND - RENOVATION


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
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
 EXISTING DOOR/FRAME ASSEMBLY TO REMAIN


 NEW DOOR/FRAME ASSEMBLY

 EXISTING WINDOW ASSEMBLY TO REMAIN


 NEW WINDOW ASSEMBLY

 1 HR. FIRE-RATED WALL (EXISTING)

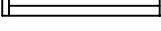
 2 HR. FIRE-RATED WALL (EXISTING)

 FIRE-RATED WALL (NEW OR EXISTING 1 HOUR UNLESS NOTED OTHERWISE)



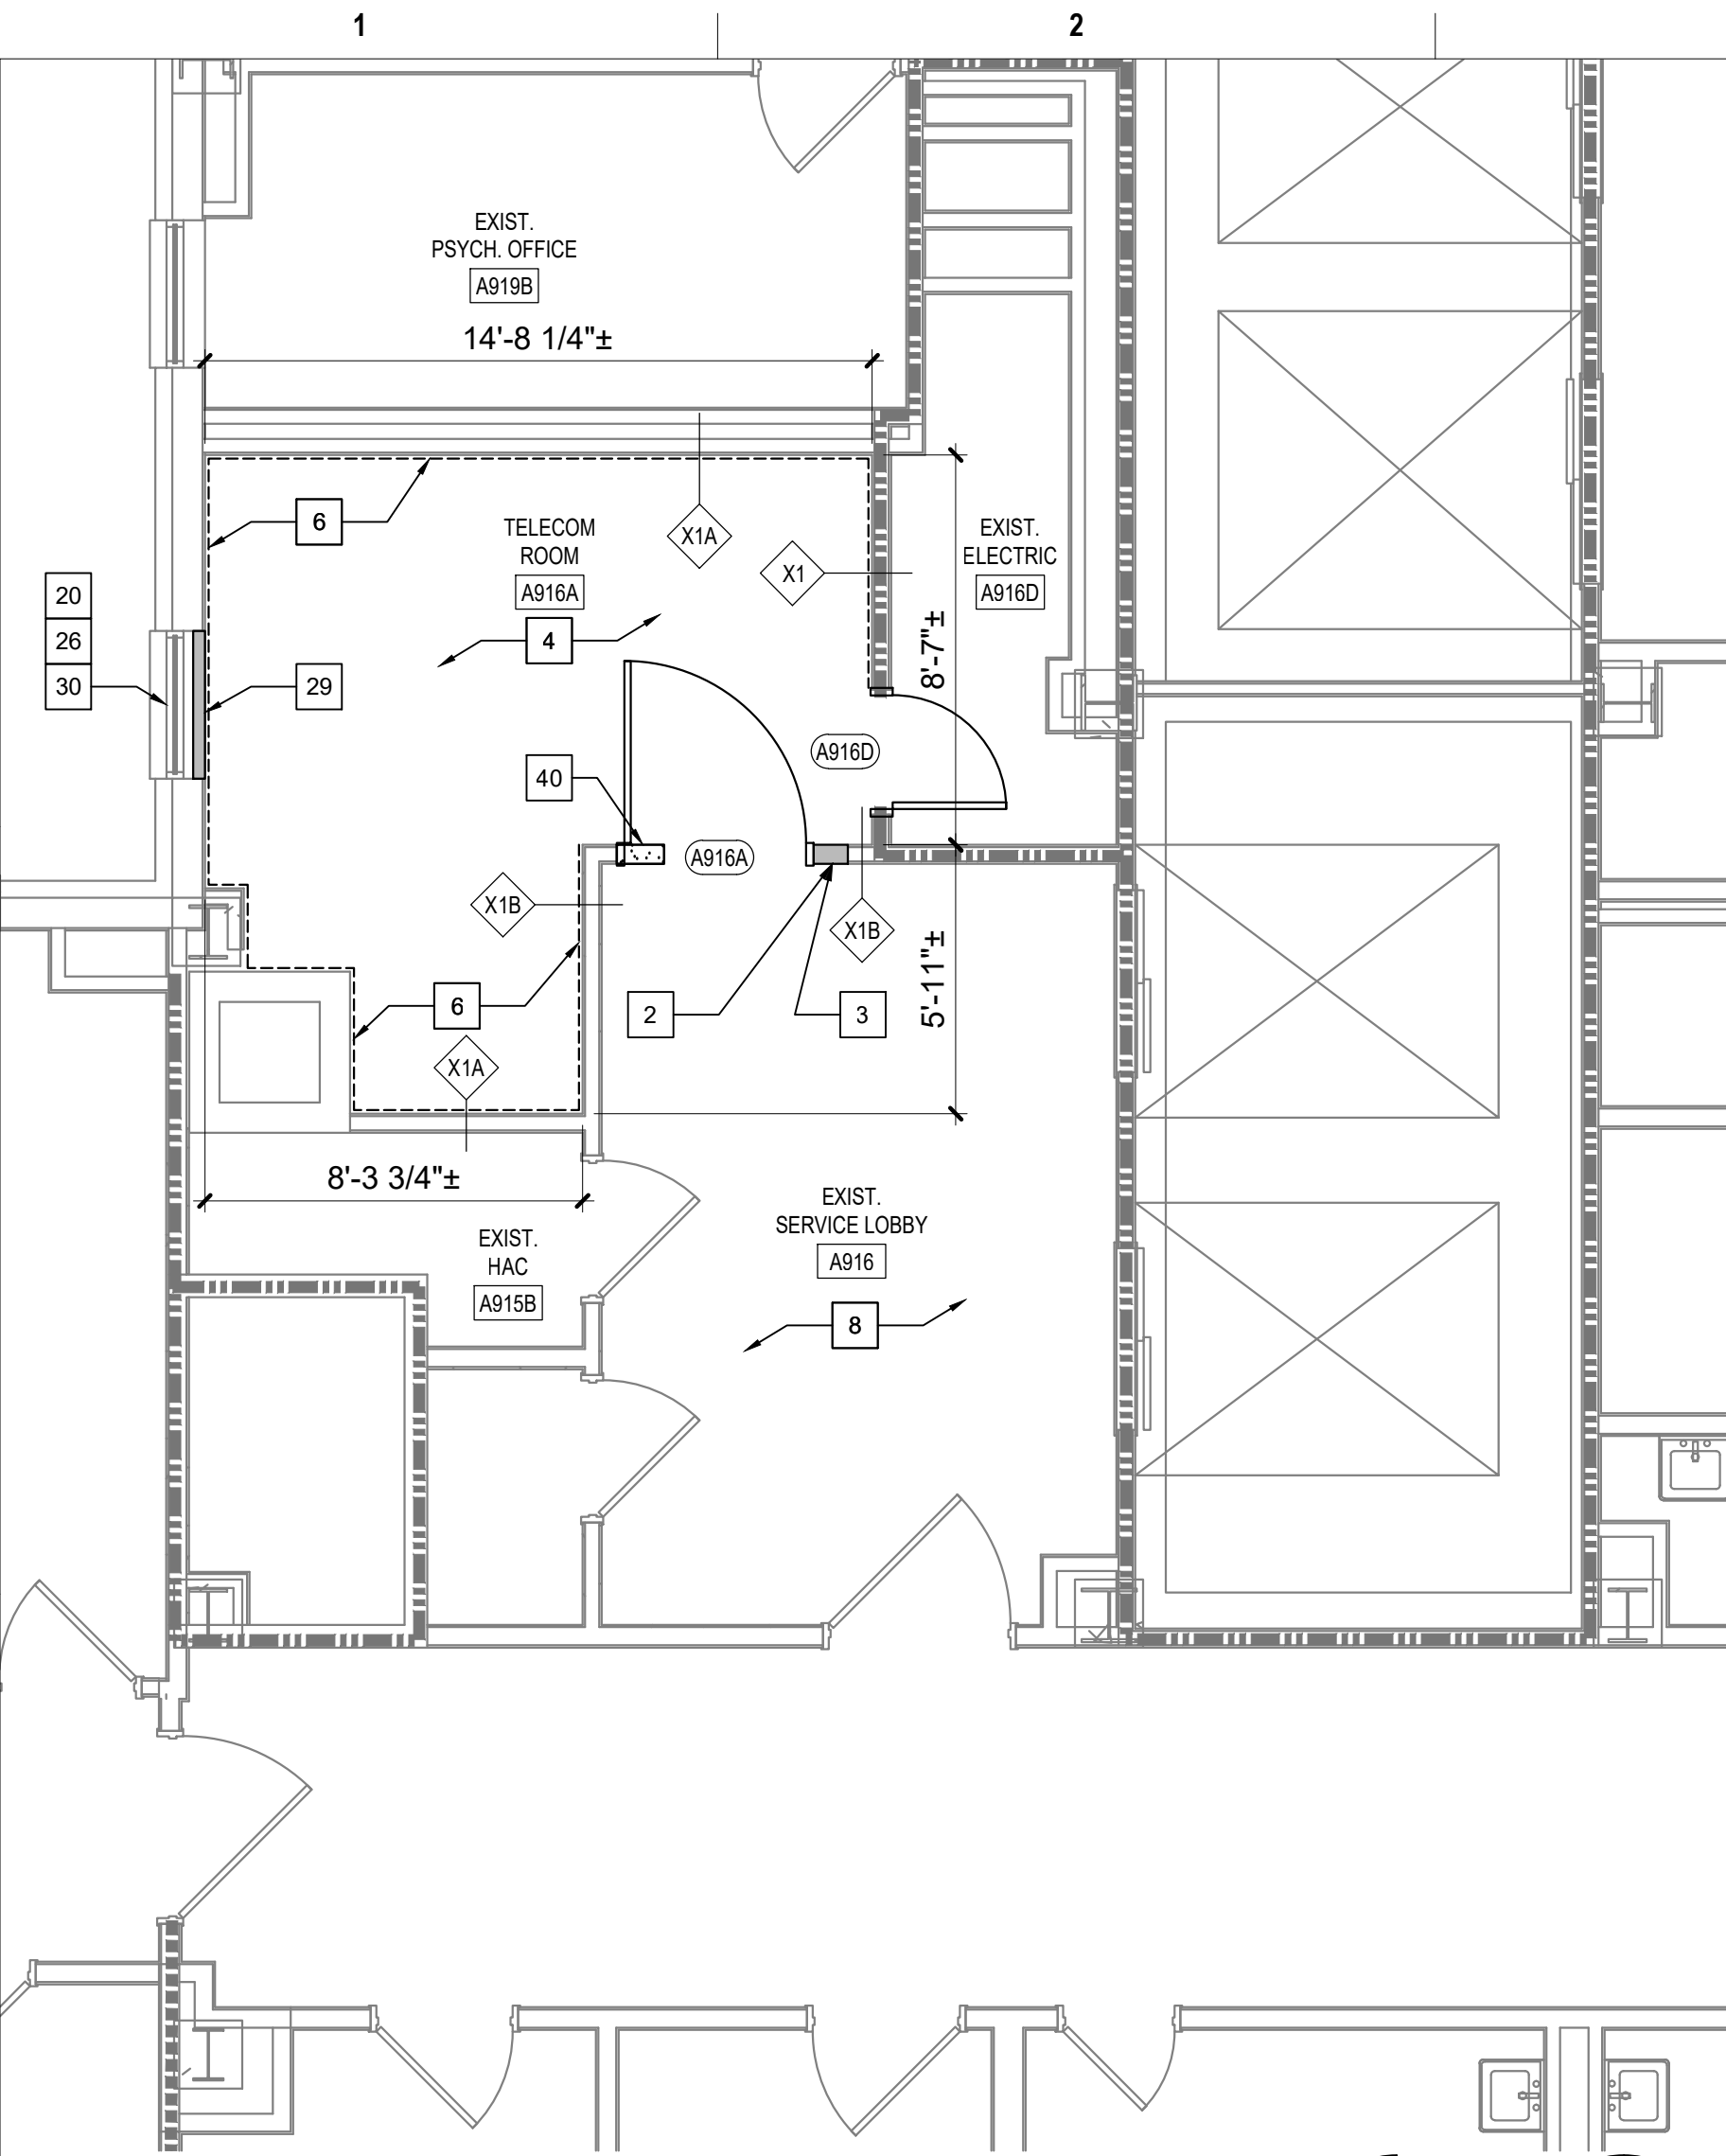

1 TELECOM ROOM A916A - ROOM RENOVATION  
SCALE: 1/4" = 1'-0"

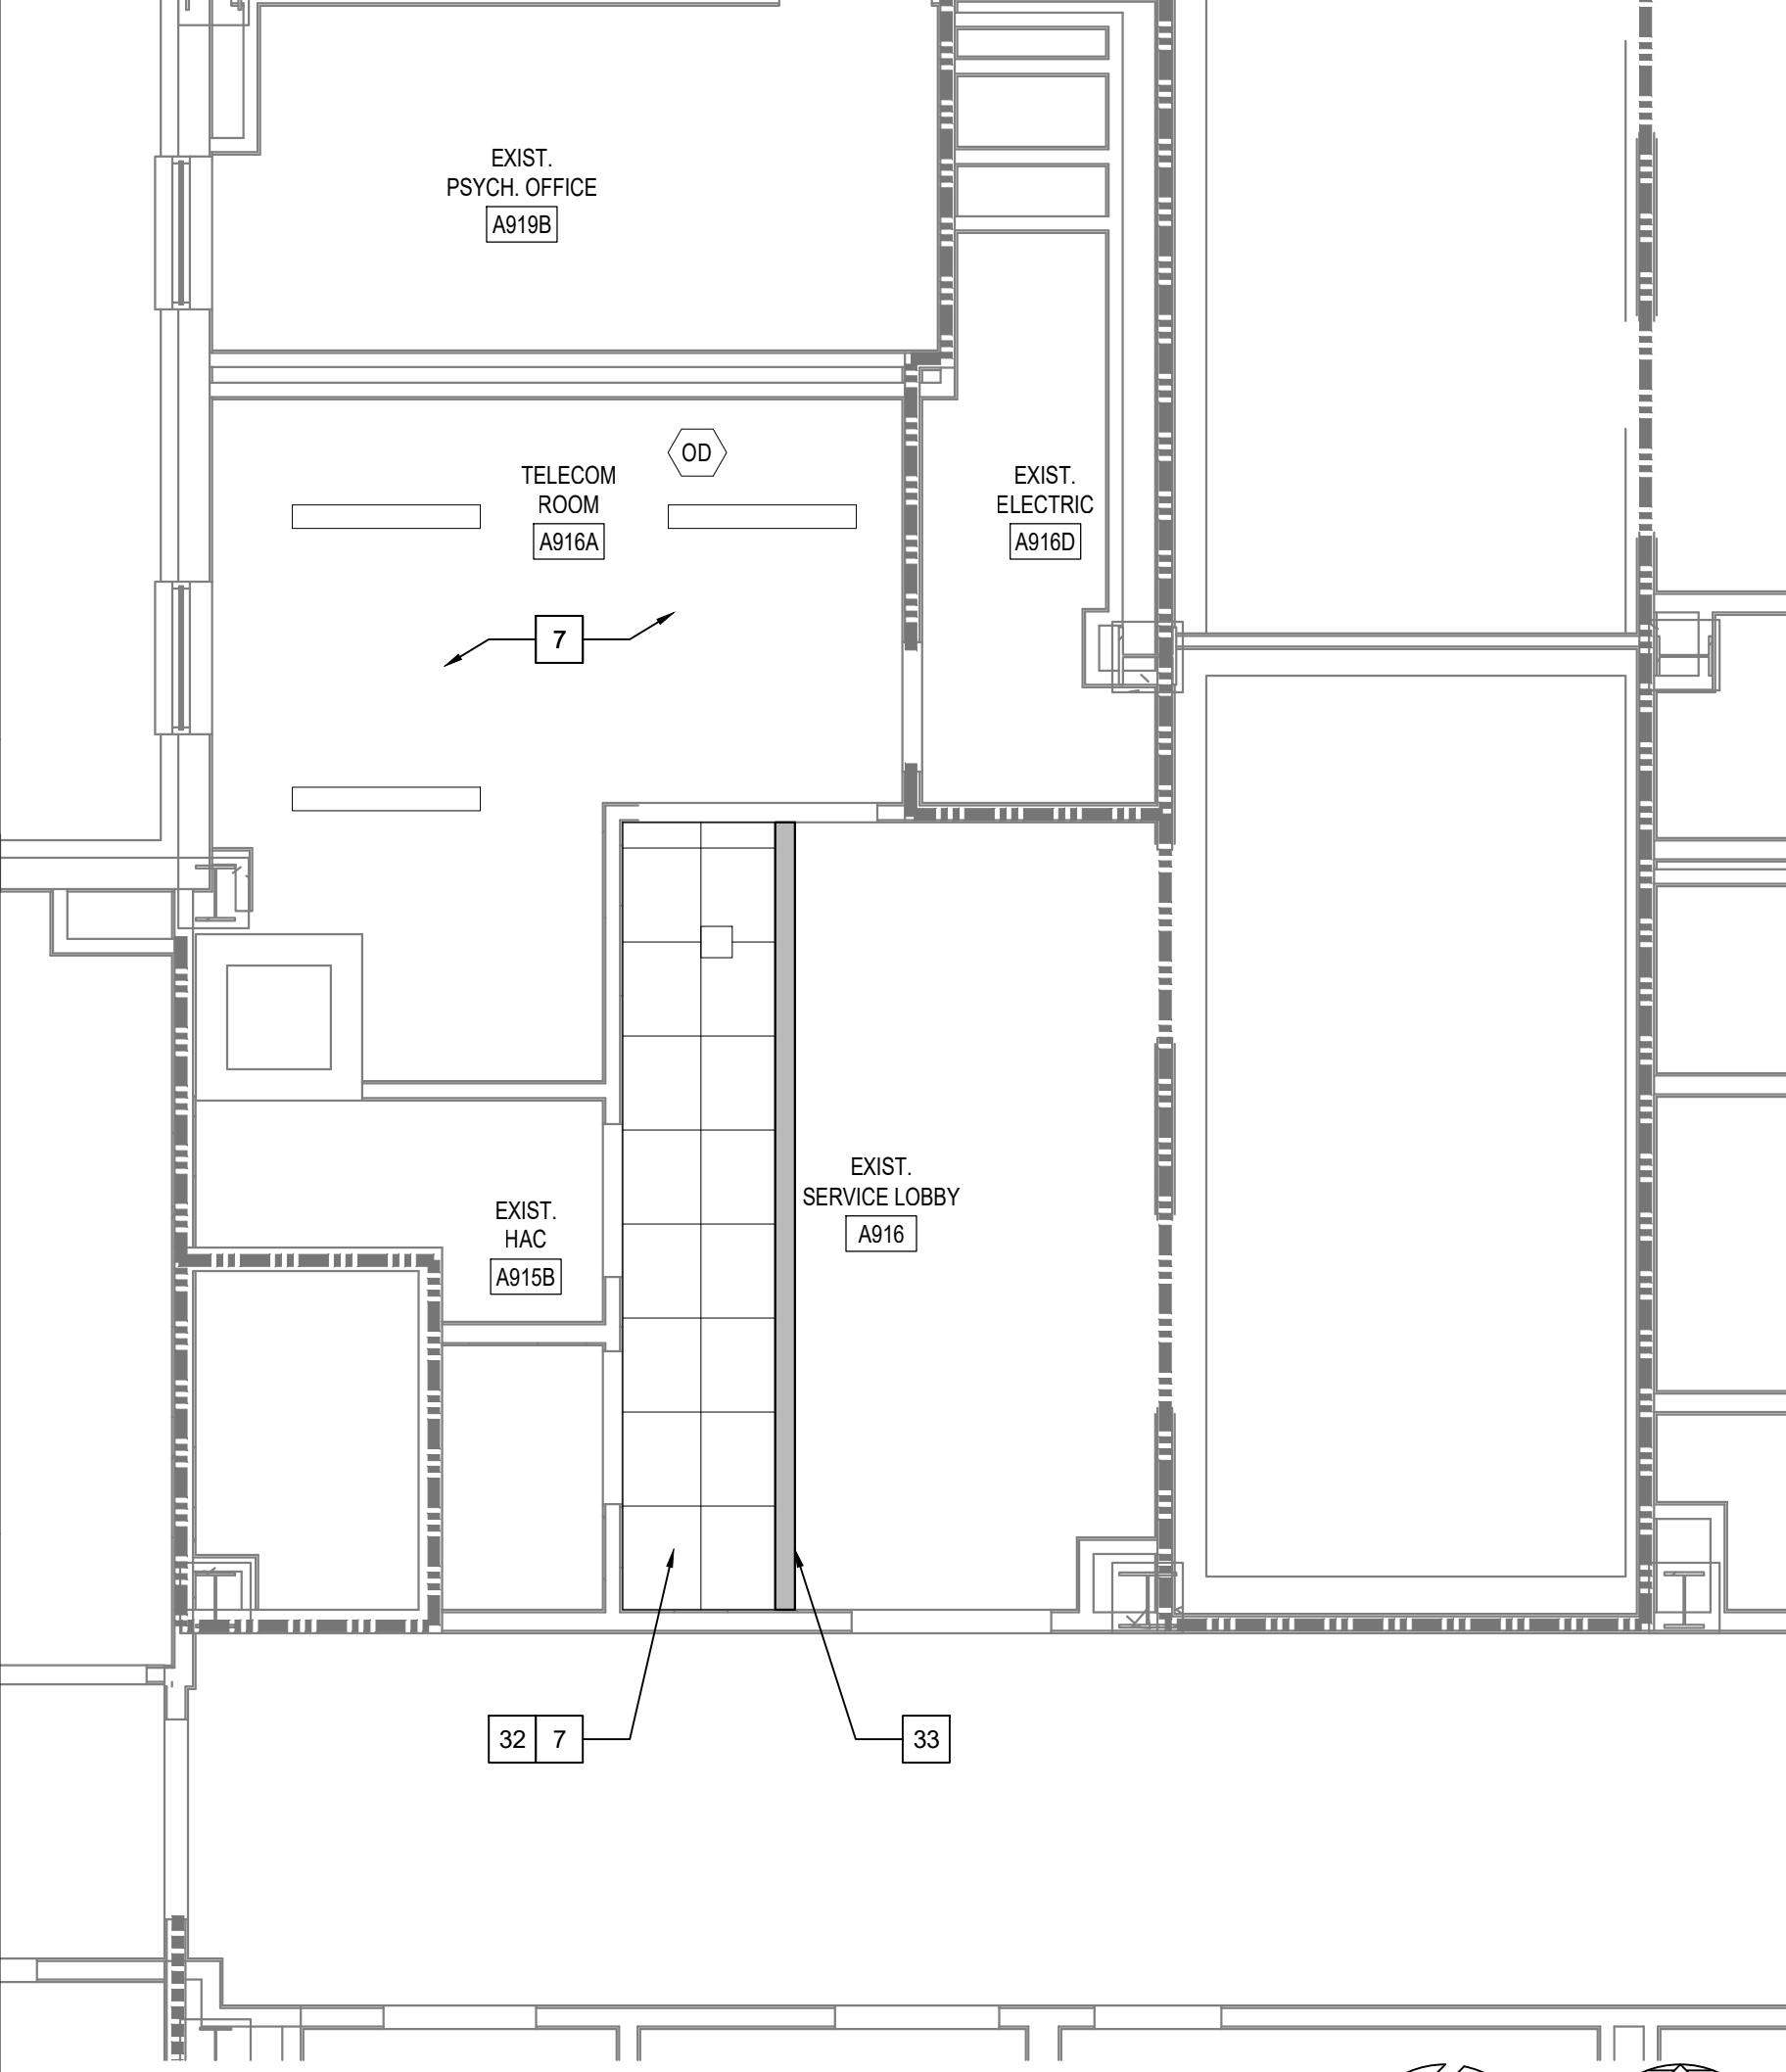

2 TELECOM ROOM A916A - CEILING RENOVATION  
SCALE: 1/4" = 1'-0"

Revisions:	Date:

CONSULTANT



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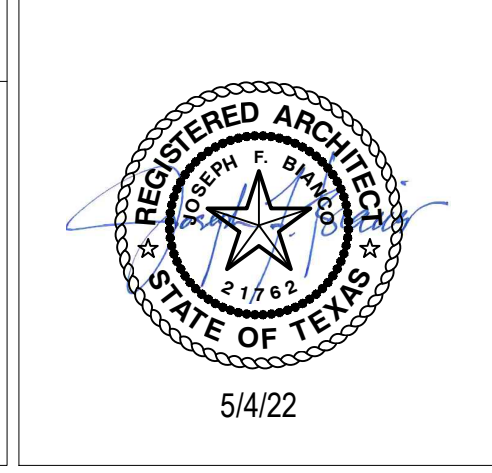
PROJECT MANAGEMENT




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Construction  
and Facilities  
Management

 U.S. Department  
of Veterans Affairs

Drawing Title

ENLARGED FLOOR PLANS -  
9TH FLOOR RENOVATION

Approved: Project Director

Phase

100% CONSTRUCTION  
DOCUMENTS

FULLY SPRINKLERED

Project Title

CINCINNATI VAMC EHRM  
INFRASTRUCTURE UPGRADES

Location  
3200 VINE ST., CINCINNATI, OH

Issue Date  
4-MAY-2022

Checked

Drawn  
JAR

Project Number  
539-21-701

Building Number  
C1

Drawing Number  
AS-409-C.1.9

- KEYED NOTES - RENOVATION
1. EXISTING DOOR/FRAME ASSEMBLY TO REMAIN.

2. PROVIDE CARD READER.

3. PROVIDE ROOM SIGNAGE.

4. PROVIDE NEW FLOORING AND BASE AS SCHEDULED.

5. REFERENCE MEP AND TECHNOLOGY DRAWINGS FOR WORK SCOPE IN THIS ROOM THAT MAY REQUIRE MINOR DEMOLITION, PATCHING AND REPAIR OF EXISTING FLOOR SUBSTRATE, WALL OR MISCELLANEOUS ASSEMBLIES.

6. PROVIDE 8"x4"x3/4" AC FACED FIRE-RATED PLYWOOD VERTICALLY ON ALL WALLS AS INDICATED. PAINT WITH 2 COATS MIN. FIRE-RATED PAINT. COORDINATE EXACT LOCATION A.F.F. WITH TECHNOLOGY AND ELECTRICAL DRAWINGS AND EXISTING CONDITIONS.

7. REFERENCE MEP AND TECHNOLOGY DRAWINGS FOR WORK SCOPE OF EXISTING AND NEW COMPONENTS AT CEILING LEVEL.

8. EXISTING FLOOR AND BASE TO REMAIN. REPAIR AS NECESSARY TO MATCH EXISTING CONDITIONS OR BETTER.

9. EXISTING VCT FLOORING AND RUBBER BASE TO REMAIN.

10. LIMITED RENOVATION TO EXISTING CEILING ASSEMBLY PER MEP AND TECHNOLOGY DRAWINGS WORK SCOPE.

11. RELOCATED EXISTING MARKER BOARD.

12. RELOCATED EXISTING MILLWORK.

13. CEILING FUR-DOWN ABOVE.

14. NEW GYPSUM BOARD/METAL STUD FRAMED FUR-DOWN TO MATCH EXISTING HEIGHT. NO JOINTS UNLESS NOTED OTHERWISE.

15. RELOCATED EXISTING LIGHT FIXTURE.

16. RELOCATED EXISTING TV MONITOR.

17. EXISTING ALUMINUM FLOOR AND WALL (EACH SIDE) EXPANSION JOINT COVERS TO REMAIN.

18. EXISTING GYPSUM BOARD/METAL STUD FRAMED FUR-DOWN TO REMAIN.

19. RELOCATED EXISTING FIRE EXTINGUISHER.

20. EXISTING EXTERIOR WINDOW TO REMAIN.

21. REINSTALL EXISTING SALVAGED WOOD BASE AND CHAIR RAIL. PROVIDE BALANCE OF MATERIAL AS NEEDED TO COMPLETE JOB. PAINT ALL BASE AND CHAIR RAIL IN ENTIRE ROOM.

22. EXISTING PLASTER ON CMU TO UNDERSIDE OF EXISTING STRUCTURE (4" OR 8" CMU PER WALL THICKNESS DEPICTED GRAPHICALLY). FIRE-RATED WALL. CONTRACTOR VERIFY.

23. EXISTING ROOM SIGNAGE.

24. EXISTING CARD READER.

25. REFERENCE DOOR SCHEDULE.

26. PAINT INTERIOR SIDE OF EXISTING WINDOW GLAZING ONLY "FLAT BLACK".

27. REINSTALLED EXISTING ROOM SIGNAGE.

28. REINSTALLED EXISTING CARD READER.

29. PLASTER ASSEMBLY INFILL AT EXISTING WALL AS DETAILED AT EXISTING WINDOW OPENING.

30. ENSURE EXISTING WALL VENT IS SECURELY CLOSED SHUT PRIOR TO COVER-UP.

31. PROVIDE WALL PROTECTION TO MATCH EXISTING.

32. PROVIDE NEW CEILING AS SCHEDULED.

33. PROVIDE GYPSUM BOARD/STEEL STUD FRAMED FUR-DOWN AS DETAILED.

34. PROVIDE 2' X 2' RAISED FLOOR SYSTEM AT 10" ABOVE THE 4TH FLOOR LEVEL.

35. ELECTRICAL CONDUITS AND MECHANICAL PIPING PER MEP DRAWINGS.

36. PROVIDE 5/8" GYPSUM BOARD WHERE EXISTING TILE WAINSCOT AND SUBSTRATE WAS REMOVED. TEXTURE AND FINISH TO MATCH EXISTING ADJACENT WALLS (4'-0"± HIGH, LOCATE AS INDICATED BY HEAVY LINE).

37. TEXTURE AND FINISH EXISTING GYPSUM BOARD SUBSTRATE TO MATCH EXISTING ADJACENT WALLS.

38. GYPSUM BOARD ASSEMBLY INFILL AS DETAILED AT EXISTING WINDOW OPENING.

39. PROVIDE INFILL PER KEYED NOTE 29 AT VOID LEFT BY HEATER REMOVED.

40. PROVIDE 1" THICK MINIMUM CONCRETE INFILL FLUSH WITH EXISTING CONCRETE TOPPING WHERE PORTIONS OF EXISTING CMU WALLS ARE REMOVED.

41. PROVIDE PAINTED WOOD CHAIR RAIL TO MATCH EXISTING.

42. REINSTALLED EXISTING SHELF.

43. PROVIDE GYPSUM BOARD/METAL STUD FRAMED CHASE FROM FLOORS ABOVE. MINIMIZE SIZE AND REFERENCE MEP DRAWINGS FOR COMPONENTS TO BE IN CHASE.

44. RAMP AND RAILS BY RAISED FLOOR SYSTEM MANUFACTURER.

45. ROOM PERIMETER WALLS TO BE FULLY SEALED TOP AND BOTTOM ON BOTH SIDES OF WALL. EXTERIOR WALL SEAL INTERIOR SIDE ONLY.

- GENERAL NOTES - RENOVATION
1. REFERENCE GENERAL NOTES ON SHEET GI-004.

2. UNLESS NOTED OTHERWISE, ALL EXISTING WALLS ARE 5/8" GYPSUM BOARD/3 5/8" METAL STUD FRAMED TO UNDERSIDE OF PRIMARY BUILDING FRAMING STRUCTURE (1 HR. FIRE RATED - CONSTRUCTION SIMILAR TO U.I. DESIGN NO. U465). CONTRACTOR TO VERIFY.

3. UNLESS NOTED OTHERWISE, ALL EXISTING DOOR ASSEMBLIES ARE SOLID CORE WOOD DOORS/HOLLOW METAL FRAME TYPICAL (3'-0" X 7'-0").

4. UNLESS NOTED OTHERWISE ALL EXISTING LAY-IN CEILING ASSEMBLIES ARE 2' X 2' STANDARD GRID WITH FISSURED TILES AT 8'-0" A.F.F. TYPICAL.

5. UNLESS NOTED OTHERWISE, ALL EXISTING STEEL COLUMN FUR-OUTS ARE GYPSUM BOARD/METAL STUD FRAMED TYPICAL.

6. PARTIAL OR ENTIRE RECONSTRUCTION OF SOME EXISTING CEILING ASSEMBLIES THROUGHOUT THE ENTIRE BUILDING(S), ESPECIALLY IN CORRIDORS, WILL BE NECESSARY. REFERENCE ALL DISCIPLINE DEMOLITION DRAWINGS. RECONSTRUCTION IS TO INCLUDE MISCELLANEOUS PATCHING /REPAIR TO MATCH EXISTING OR BETTER CONDITIONS.

7. EXISTING FIRE-RATED WALL IDENTIFICATION INDICATED ONLY FOR IMMEDIATE AFFECTED ROOM WALLS. CONTRACTOR SHALL VERIFY FULL EXTENT OF EXISTING FIRE-RATED WALLS AT ADJACENT AREAS.

8. ALL NEW WALLS SHALL BE PARTITION TYPE "1" UNLESS OTHERWISE NOTED.


9. UNLESS NOTED OTHERWISE AT ALL ROOMS WHERE EXISTING LAY-IN CEILING IS REMOVED AND IS TO BECOME A "NO CEILING" ROOM, THE EXISTING GYPSUM BOARD ABOVE. PREVIOUSLY REMOVED CEILING IS TO BE FULLY TAPED, FLOATED, TEXTURED AND PAINTED TO MATCH EXISTING WALLS.


KEYED NOTES - RENOVATION (CONT.)


46. TEMPORARY ALUMINUM RAMP BY CONTRACTOR TO BE RETURNED TO OWNER AT END OF JOB.


47. MODULAR BRICK INFILL ON EXTERIOR TO MATCH EXISTING. TOOTH-IN AND MATCH MORTAR.


LEGEND - RENOVATION


 EXISTING WALL TO REMAIN


 NEW WALL CONSTRUCTION


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
 NEW DOOR/FRAME ASSEMBLY

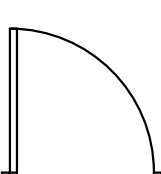 EXISTING WINDOW ASSEMBLY TO REMAIN

 NEW WINDOW ASSEMBLY

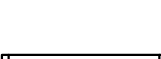 1 HR. FIRE-RATED WALL (EXISTING)

 2 HR. FIRE-RATED WALL (EXISTING)

 FIRE-RATED WALL (NEW OR EXISTING 1 HOUR UNLESS NOTED OTHERWISE)





1 TELECOM ROOM 0001 - ROOM RENOVATION  
SCALE: 1/4" = 1'-0"

2 TELECOM ROOM 0001 - CEILING RENOVATION  
SCALE: 1/4" = 1'-0"

#### KEYED NOTES - RENOVATION

- EXISTING DOOR/FRAME ASSEMBLY TO REMAIN.
- PROVIDE CARD READER.
- PROVIDE ROOM SIGNAGE.
- PROVIDE NEW FLOORING AND BASE AS SCHEDULED.
- REFERENCE MEP AND TECHNOLOGY DRAWINGS FOR WORK SCOPE IN THIS ROOM THAT MAY REQUIRE MINOR DEMOLITION, PATCHING AND REPAIR OF EXISTING FLOOR SUBSTRATE, WALL OR MISCELLANEOUS ASSEMBLIES.
- PROVIDE 8"x4"x3/4" AC FACED FIRE-RATED PLYWOOD VERTICALLY ON ALL WALLS AS INDICATED. PAINT WITH 2 COATS MIN. FIRE-RATED PAINT. COORDINATE EXACT LOCATION A.F.F. WITH TECHNOLOGY AND ELECTRICAL DRAWINGS AND EXISTING CONDITIONS.
- REFERENCE MEP AND TECHNOLOGY DRAWINGS FOR WORK SCOPE OF EXISTING AND NEW COMPONENTS AT CEILING LEVEL.
- EXISTING FLOOR AND BASE TO REMAIN. REPAIR AS NECESSARY TO MATCH EXISTING CONDITIONS OR BETTER.
- EXISTING VCT FLOORING AND RUBBER BASE TO REMAIN.
- LIMITED RENOVATION TO EXISTING CEILING ASSEMBLY PER MEP AND TECHNOLOGY DRAWINGS WORK SCOPE.
- RELOCATED EXISTING MARKER BOARD.
- RELOCATED EXISTING MILLWORK.
- CEILING FUR-DOWN ABOVE.
- NEW GYPSUM BOARD/METAL STUD FRAMED FUR-DOWN TO MATCH EXISTING HEIGHT. NO JOINTS UNLESS NOTED OTHERWISE.
- RELOCATED EXISTING LIGHT FIXTURE.
- RELOCATED EXISTING TV MONITOR.
- EXISTING ALUMINUM FLOOR AND WALL (EACH SIDE) EXPANSION JOINT COVERS TO REMAIN.
- EXISTING GYPSUM BOARD/METAL STUD FRAMED FUR-DOWN TO REMAIN.
- RELOCATED EXISTING FIRE EXTINGUISHER.
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- REINSTALL EXISTING SALVAGED WOOD BASE AND CHAIR RAIL. PROVIDE BALANCE OF MATERIAL AS NEEDED TO COMPLETE JOB. PAINT ALL BASE AND CHAIR RAIL IN ENTIRE ROOM.
- EXISTING PLASTER ON CMU TO UNDERSIDE OF EXISTING STRUCTURE (4" OR 8" CMU PER WALL THICKNESS DEPICTED GRAPHICALLY). FIRE-RATED WALL. CONTRACTOR VERIFY.
- EXISTING ROOM SIGNAGE.
- EXISTING CARD READER.
- REFERENCE DOOR SCHEDULE.
- PAINT INTERIOR SIDE OF EXISTING WINDOW GLAZING ONLY "FLAT BLACK".
- REINSTALLED EXISTING ROOM SIGNAGE.
- REINSTALLED EXISTING CARD READER.
- PLASTER ASSEMBLY INFILL AT EXISTING WALL AS DETAILED AT EXISTING WINDOW OPENING.
- ENSURE EXISTING WALL VENT IS SECURELY CLOSED SHUT PRIOR TO COVER-UP.
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- PROVIDE GYPSUM BOARD/STEEL STUD FRAMED FUR-DOWN AS DETAILED.
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- ELECTRICAL CONDUITS AND MECHANICAL PIPING PER MEP DRAWINGS.
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- TEXTURE AND FINISH EXISTING GYPSUM BOARD SUBSTRATE TO MATCH EXISTING ADJACENT WALLS.
- GYPSUM BOARD ASSEMBLY INFILL AS DETAILED AT EXISTING WINDOW OPENING.
- PROVIDE INFILL PER KEYED NOTE 29 AT VOID LEFT BY HEATER REMOVED.
- PROVIDE 1" THICK MINIMUM CONCRETE INFILL FLUSH WITH EXISTING CONCRETE TOPPING WHERE PORTIONS OF EXISTING CMU WALLS ARE REMOVED.
- PROVIDE PAINTED WOOD CHAIR RAIL TO MATCH EXISTING.
- REINSTALLED EXISTING SHELF.
- PROVIDE GYPSUM BOARD/METAL STUD FRAMED CHASE FROM FLOORS ABOVE. MINIMIZE SIZE AND REFERENCE MEP DRAWINGS FOR COMPONENTS TO BE IN CHASE.
- RAMP AND RAILS BY RAISED FLOOR SYSTEM MANUFACTURER.
- ROOM PERIMETER WALLS TO BE FULLY SEALED TOP AND BOTTOM ON BOTH SIDES OF WALL. EXTERIOR WALL SEAL INTERIOR SIDE ONLY.

#### GENERAL NOTES - RENOVATION

- REFERENCE GENERAL NOTES ON SHEET GI-004.
- UNLESS NOTED OTHERWISE, ALL EXISTING WALLS ARE 5/8" GYPSUM BOARD/3 5/8" METAL STUD FRAMED TO UNDERSIDE OF PRIMARY BUILDING FRAMING STRUCTURE (1 HR. FIRE RATED - CONSTRUCTION SIMILAR TO U.I. DESIGN NO. U465). CONTRACTOR TO VERIFY.
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#### KEYED NOTES - RENOVATION (CONT.)

- TEMPORARY ALUMINUM RAMP BY CONTRACTOR TO BE RETURNED TO OWNER AT END OF JOB.
- MODULAR BRICK INFILL ON EXTERIOR TO MATCH EXISTING. TOOTH-IN AND MATCH MORTAR.

#### LEGEND - RENOVATION

- EXISTING WALL TO REMAIN
- NEW WALL CONSTRUCTION
- EXISTING DOOR/FRAME ASSEMBLY TO REMAIN
- NEW DOOR/FRAME ASSEMBLY
- EXISTING WINDOW ASSEMBLY TO REMAIN
- NEW WINDOW ASSEMBLY
- 1 HR. FIRE-RATED WALL (EXISTING)
- 2 HR. FIRE-RATED WALL (EXISTING)
- FIRE-RATED WALL (NEW OR EXISTING 1 HOUR UNLESS NOTED OTHERWISE)

Revisions:	Date:

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#### PROJECT MANAGEMENT



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Construction  
and Facilities  
Management

VA U.S. Department  
of Veterans Affairs

Drawing Title  
**ENLARGED FLOOR PLANS -  
BASEMENT FLOOR RENOVATION**

Approved: Project Director

Phase  
**100% CONSTRUCTION  
DOCUMENTS**

**FULLY SPRINKLERED**

Project Title  
**CINCINNATI VAMC EHRM  
INFRASTRUCTURE UPGRADES**

Location  
3200 VINE ST., CINCINNATI, OH

Issue Date  
4-MAY-2022


Checked

Drawn  
JAR

Project Number  
539-21-701  
Building Number  
C2

Drawing Number  
**AS-440-C.2.B**



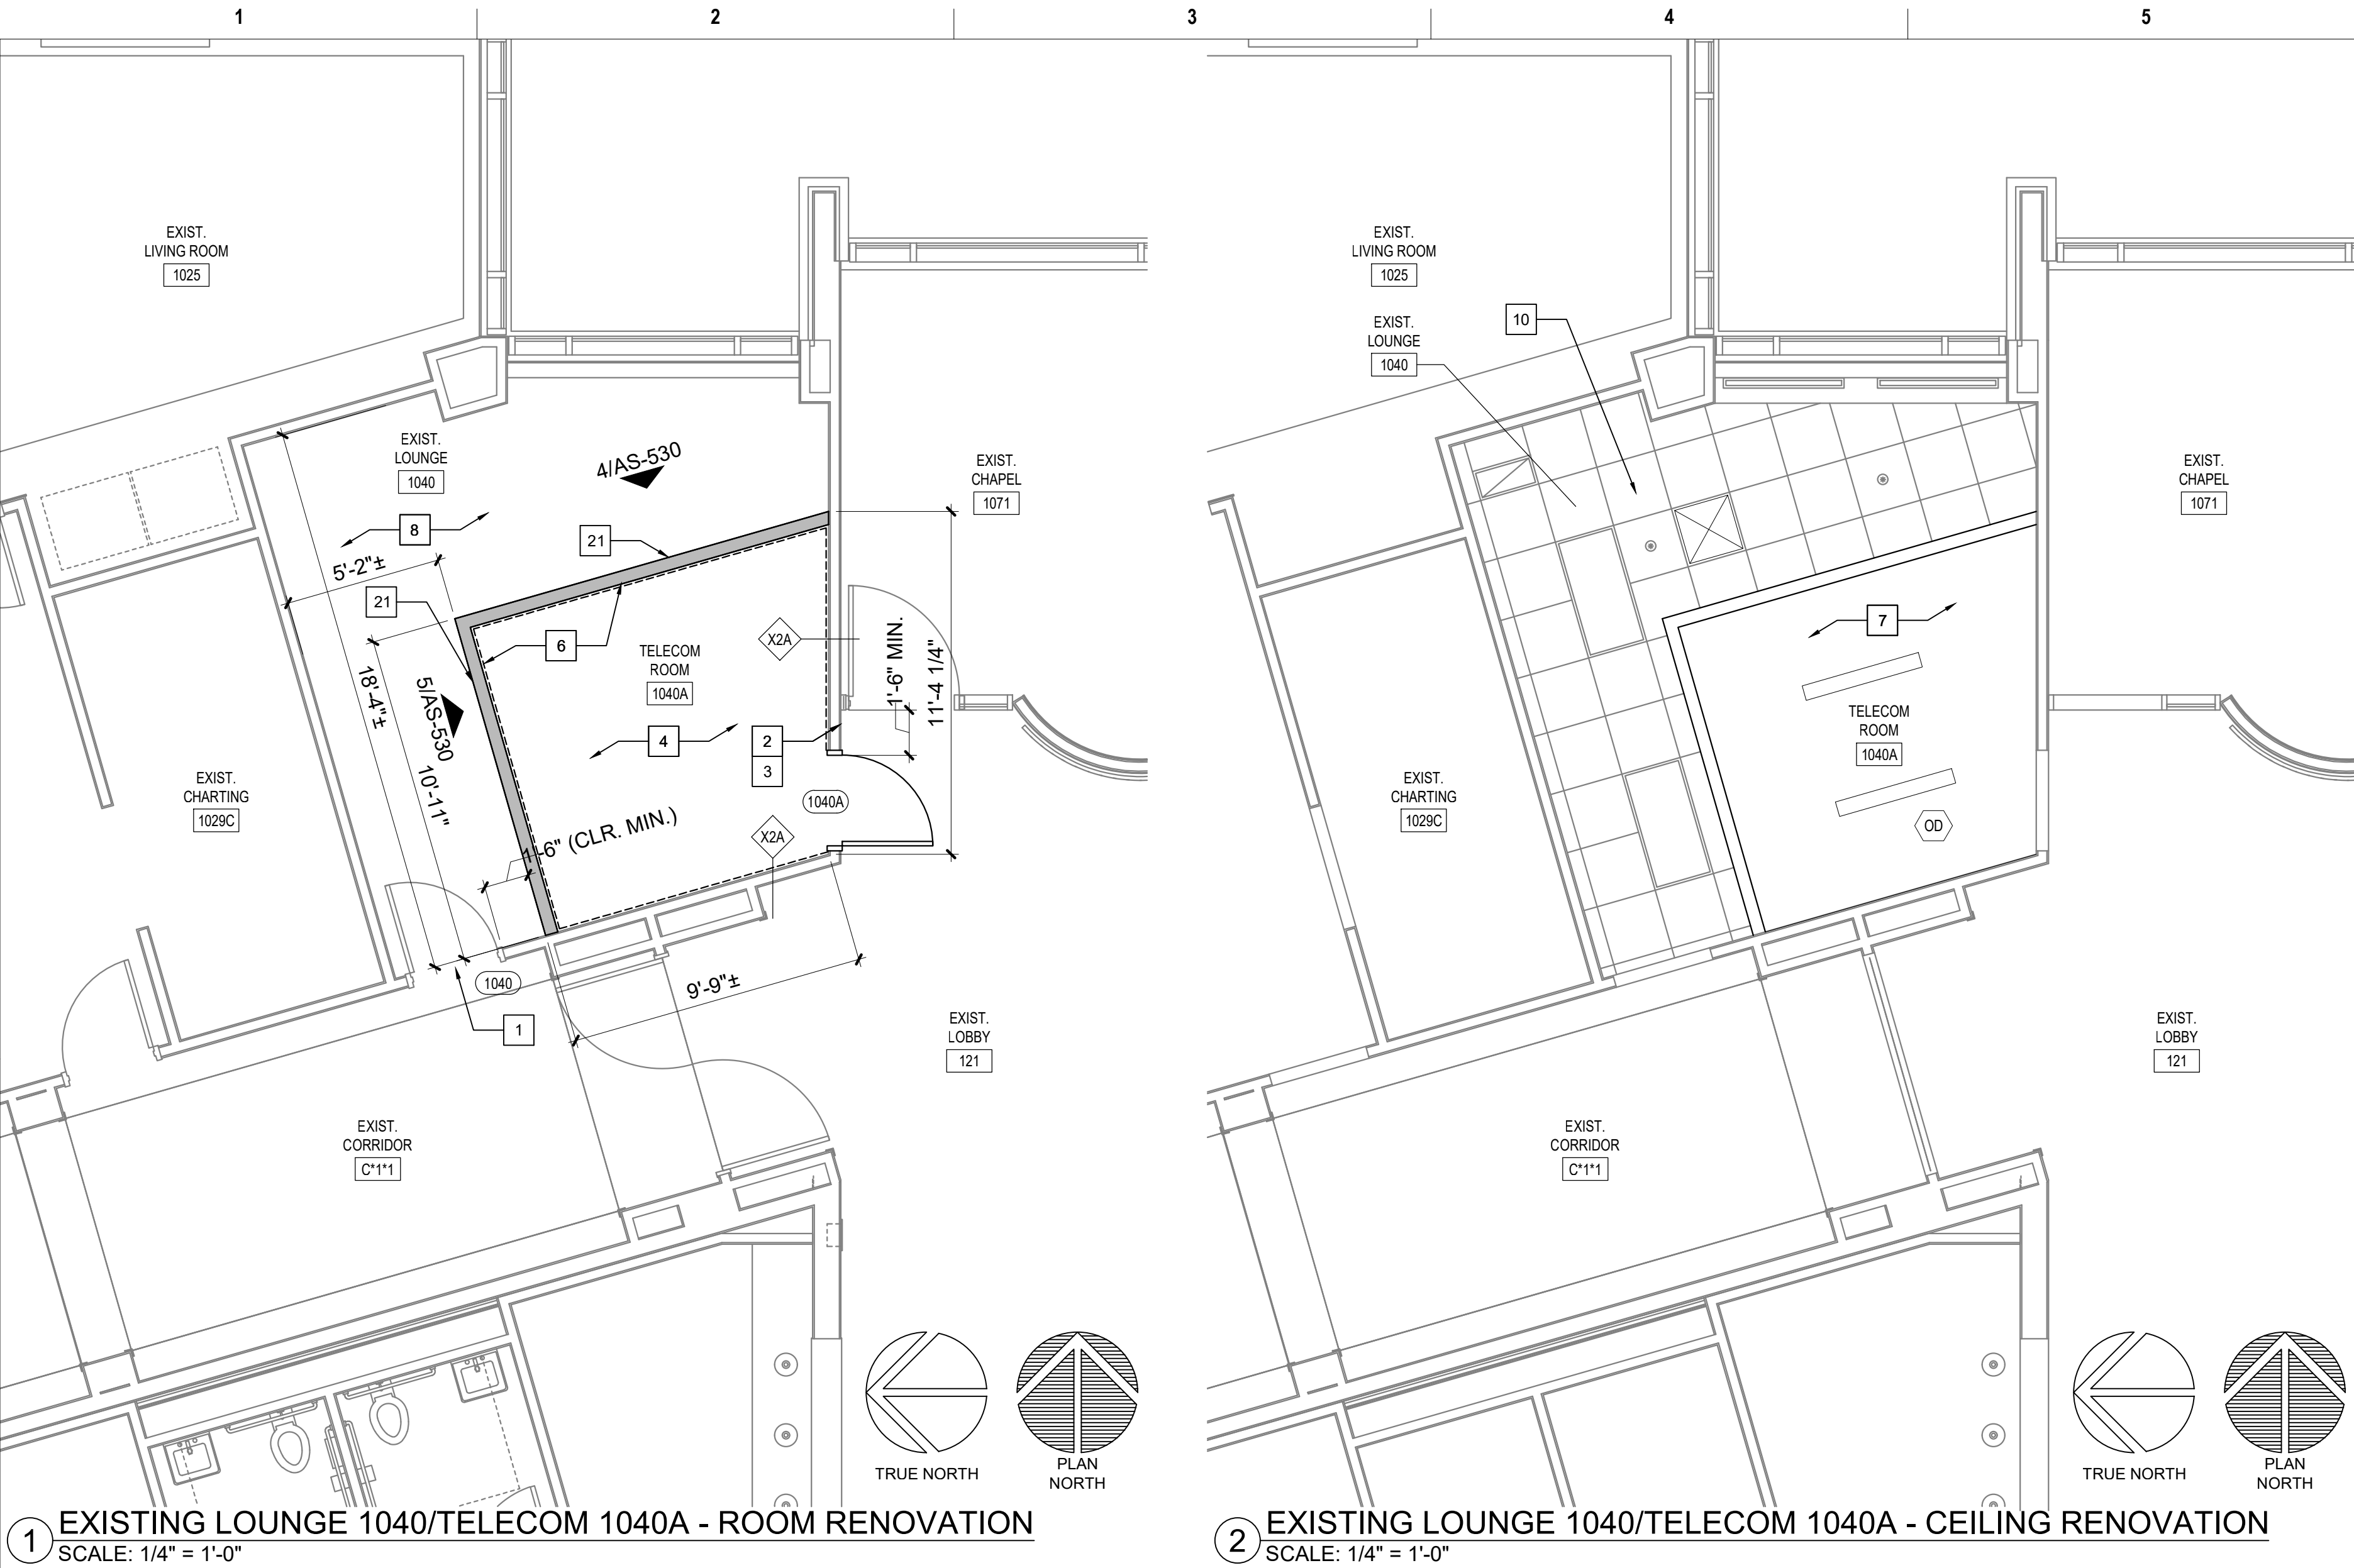

KEYED NOTES - RENOVATION

- EXISTING DOOR/FRAME ASSEMBLY TO REMAIN.
- PROVIDE CARD READER.
- PROVIDE ROOM SIGNAGE.
- PROVIDE NEW FLOORING AND BASE AS SCHEDULED.
- REFERENCE MEP AND TECHNOLOGY DRAWINGS FOR WORK SCOPE IN THIS ROOM THAT MAY REQUIRE MINOR DEMOLITION, PATCHING AND REPAIR OF EXISTING FLOOR SUBSTRATE, WALL OR MISCELLANEOUS ASSEMBLIES.
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- EXISTING VCT FLOORING AND RUBBER BASE TO REMAIN.
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- RELOCATED EXISTING MILLWORK.
- CEILING FUR-DOWN ABOVE.
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- PARTIAL OR ENTIRE RECONSTRUCTION OF SOME EXISTING CEILING ASSEMBLIES THOUGH OUT THE ENTIRE BUILDING(S), ESPECIALLY IN CORRIDORS, WILL BE NECESSARY. REFERENCE ALL DISCIPLINE DEMOLITION DRAWINGS. RECONSTRUCTION IS TO INCLUDE MISCELLANEOUS PATCHING /REPAIR TO MATCH EXISTING OR BETTER CONDITIONS.
- EXISTING FIRE-RATED WALL IDENTIFICATION INDICATED ONLY FOR IMMEDIATE AFFECTED ROOM WALLS. CONTRACTOR SHALL VERIFY FULL EXTENT OF EXISTING FIRE-RATED WALLS AT ADJACENT AREAS.
- ALL NEW WALLS SHALL BE PARTITION TYPE "1" UNLESS OTHERWISE NOTED.
- UNLESS NOTED OTHERWISE AT ALL ROOMS WHERE EXISTING LAY-IN CEILING IS REMOVED AND IS TO BECOME A "NO CEILING" ROOM, THE EXISTING GYPSUM BOARD ABOVE. PREVIOUSLY REMOVED CEILING IS TO BE FULLY TAPED, FLOATED, TEXTURED AND PAINTED TO MATCH EXISTING WALLS.

KEYED NOTES - RENOVATION (CONT.)

- TEMPORARY ALUMINUM RAMP BY CONTRACTOR TO BE RETURNED TO OWNER AT END OF JOB.
- MODULAR BRICK INFILL ON EXTERIOR TO MATCH EXISTING. TOOTH-IN AND MATCH MORTAR.

LEGEND - RENOVATION

- EXISTING WALL TO REMAIN
- NEW WALL CONSTRUCTION
- EXISTING DOOR/FRAME ASSEMBLY TO REMAIN
- NEW DOOR/FRAME ASSEMBLY
- EXISTING WINDOW ASSEMBLY TO REMAIN
- NEW WINDOW ASSEMBLY
- 1 HR. FIRE-RATED WALL (EXISTING)
- 2 HR. FIRE-RATED WALL (EXISTING)
- FIRE-RATED WALL (NEW OR EXISTING 1 HOUR UNLESS NOTED OTHERWISE)

Revisions:	Date:

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Construction  
and Facilities  
Management

 U.S. Department  
of Veterans Affairs

Drawing Title

ENLARGED FLOOR PLANS -  
1ST FLOOR RENOVATION

Approved: Project Director

Phase

100% CONSTRUCTION  
DOCUMENTS

FULLY SPRINKLERED

Project Title

CINCINNATI VAMC EHRM  
INFRASTRUCTURE UPGRADES

Location  
3200 VINE ST., CINCINNATI, OH

Issue Date  
4-MAY-2022

Checked

Drawn  
JAR

Project Number  
539-21-701

Building Number  
C2

Drawing Number  
AS-441-C.2.1





KEYED NOTES - RENOVATION

- EXISTING DOOR/FRAME ASSEMBLY TO REMAIN.
- PROVIDE CARD READER.
- PROVIDE ROOM SIGNAGE.
- PROVIDE NEW FLOORING AND BASE AS SCHEDULED.
- REFERENCE MEP AND TECHNOLOGY DRAWINGS FOR WORK SCOPE IN THIS ROOM THAT MAY REQUIRE MINOR DEMOLITION, PATCHING AND REPAIR OF EXISTING FLOOR SUBSTRATE, WALL OR MISCELLANEOUS ASSEMBLIES.
- PROVIDE 8"x4"x3/4" AC FACED FIRE-RATED PLYWOOD VERTICALLY ON ALL WALLS AS INDICATED. PAINT WITH 2 COATS MIN. FIRE-RATED PAINT. COORDINATE EXACT LOCATION A.F.F. WITH TECHNOLOGY AND ELECTRICAL DRAWINGS AND EXISTING CONDITIONS.
- REFERENCE MEP AND TECHNOLOGY DRAWINGS FOR WORK SCOPE OF EXISTING AND NEW COMPONENTS AT CEILING LEVEL.
- EXISTING FLOOR AND BASE TO REMAIN. REPAIR AS NECESSARY TO MATCH EXISTING CONDITIONS OR BETTER.
- EXISTING VCT FLOORING AND RUBBER BASE TO REMAIN.
- LIMITED RENOVATION TO EXISTING CEILING ASSEMBLY PER MEP AND TECHNOLOGY DRAWINGS WORK SCOPE.
- RELOCATED EXISTING MARKER BOARD.
- RELOCATED EXISTING MILLWORK.
- CEILING FUR-DOWN ABOVE.
- NEW GYPSUM BOARD/METAL STUD FRAMED FUR-DOWN TO MATCH EXISTING HEIGHT. NO JOINTS UNLESS NOTED OTHERWISE.
- RELOCATED EXISTING LIGHT FIXTURE.
- RELOCATED EXISTING TV MONITOR.
- EXISTING ALUMINUM FLOOR AND WALL (EACH SIDE) EXPANSION JOINT COVERS TO REMAIN.
- EXISTING GYPSUM BOARD/METAL STUD FRAMED FUR-DOWN TO REMAIN.
- RELOCATED EXISTING FIRE EXTINGUISHER.
- EXISTING EXTERIOR WINDOW TO REMAIN.
- REINSTALL EXISTING SALVAGED WOOD BASE AND CHAIR RAIL. PROVIDE BALANCE OF MATERIAL AS NEEDED TO COMPLETE JOB. PAINT ALL BASE AND CHAIR RAIL IN ENTIRE ROOM.
- EXISTING PLASTER ON CMU TO UNDERSIDE OF EXISTING STRUCTURE (4" OR 8" CMU PER WALL THICKNESS DEPICTED GRAPHICALLY). FIRE-RATED WALL. CONTRACTOR VERIFY.
- EXISTING ROOM SIGNAGE.
- EXISTING CARD READER.
- REFERENCE DOOR SCHEDULE.
- PAINT INTERIOR SIDE OF EXISTING WINDOW GLAZING ONLY "FLAT BLACK".
- REINSTALLED EXISTING ROOM SIGNAGE.
- REINSTALLED EXISTING CARD READER.
- PLASTER ASSEMBLY INFILL AT EXISTING WALL AS DETAILED AT EXISTING WINDOW OPENING.
- ENSURE EXISTING WALL VENT IS SECURELY CLOSED SHUT PRIOR TO COVER-UP.
- PROVIDE WALL PROTECTION TO MATCH EXISTING.
- PROVIDE NEW CEILING AS SCHEDULED.
- PROVIDE GYPSUM BOARD/STEEL STUD FRAMED FUR-DOWN AS DETAILED.
- PROVIDE 2' X 2' RAISED FLOOR SYSTEM AT 10" ABOVE THE 4TH FLOOR LEVEL.
- ELECTRICAL CONDUITS AND MECHANICAL PIPING PER MEP DRAWINGS.
- PROVIDE 5/8" GYPSUM BOARD WHERE EXISTING TILE WAINSCOT AND SUBSTRATE WAS REMOVED. TEXTURE AND FINISH TO MATCH EXISTING ADJACENT WALLS (4'-0"± HIGH, LOCATE AS INDICATED BY HEAVY LINE).
- TEXTURE AND FINISH EXISTING GYPSUM BOARD SUBSTRATE TO MATCH EXISTING ADJACENT WALLS.
- GYPSUM BOARD ASSEMBLY INFILL AS DETAILED AT EXISTING WINDOW OPENING.
- PROVIDE INFILL PER KEYED NOTE 29 AT VOID LEFT BY HEATER REMOVED.
- PROVIDE 1" THICK MINIMUM CONCRETE INFILL FLUSH WITH EXISTING CONCRETE TOPPING WHERE PORTIONS OF EXISTING CMU WALLS ARE REMOVED.
- PROVIDE PAINTED WOOD CHAIR RAIL TO MATCH EXISTING.
- REINSTALLED EXISTING SHELF.
- PROVIDE GYPSUM BOARD/METAL STUD FRAMED CHASE FROM FLOORS ABOVE. MINIMIZE SIZE AND REFERENCE MEP DRAWINGS FOR COMPONENTS TO BE IN CHASE.
- RAMP AND RAILS BY RAISED FLOOR SYSTEM MANUFACTURER.
- ROOM PERIMETER WALLS TO BE FULLY SEALED TOP AND BOTTOM ON BOTH SIDES OF WALL. EXTERIOR WALL SEAL INTERIOR SIDE ONLY.

GENERAL NOTES - RENOVATION

- REFERENCE GENERAL NOTES ON SHEET GI-004.
- UNLESS NOTED OTHERWISE, ALL EXISTING WALLS ARE 5/8" GYPSUM BOARD/3 5/8" METAL STUD FRAMED TO UNDERSIDE OF PRIMARY BUILDING FRAMING STRUCTURE (1 HR. FIRE RATED - CONSTRUCTION SIMILAR TO U.I. DESIGN NO. U465). CONTRACTOR TO VERIFY.
- UNLESS NOTED OTHERWISE, ALL EXISTING DOOR ASSEMBLIES ARE SOLID CORE WOOD DOORS/HOLLOW METAL FRAME TYPICAL (3'-0" X 7'-0").
- UNLESS NOTED OTHERWISE ALL EXISTING LAY-IN CEILING ASSEMBLIES ARE 2' X 2' STANDARD GRID WITH FISSURED TILES AT 8'-0" A.F.F. TYPICAL.
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- UNLESS NOTED OTHERWISE AT ALL ROOMS WHERE EXISTING LAY-IN CEILING IS REMOVED AND IS TO BECOME A "NO CEILING" ROOM, THE EXISTING GYPSUM BOARD ABOVE PREVIOUSLY REMOVED CEILING IS TO BE FULLY TAPED, FLOATED, TEXTURED AND PAINTED TO MATCH EXISTING WALLS.

KEYED NOTES - RENOVATION (CONT.)

- TEMPORARY ALUMINUM RAMP BY CONTRACTOR TO BE RETURNED TO OWNER AT END OF JOB.
- MODULAR BRICK INFILL ON EXTERIOR TO MATCH EXISTING. TOOTH-IN AND MATCH MORTAR.

LEGEND - RENOVATION

- EXISTING WALL TO REMAIN
- NEW WALL CONSTRUCTION
- EXISTING DOOR/FRAME ASSEMBLY TO REMAIN
- NEW DOOR/FRAME ASSEMBLY
- EXISTING WINDOW ASSEMBLY TO REMAIN
- NEW WINDOW ASSEMBLY
- 1 HR. FIRE-RATED WALL (EXISTING)
- 2 HR. FIRE-RATED WALL (EXISTING)
- FIRE-RATED WALL (NEW OR EXISTING 1 HOUR UNLESS NOTED OTHERWISE)

Revisions:	Date:

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Construction  
and Facilities  
Management

 U.S. Department  
of Veterans Affairs

Drawing Title

ENLARGED FLOOR PLANS -  
2ND FLOOR RENOVATION

Approved: Project Director

Phase

100% CONSTRUCTION  
DOCUMENTS

FULLY SPRINKLERED

Project Title

CINCINNATI VAMC EHRM  
INFRASTRUCTURE UPGRADES

Location  
3200 VINE ST., CINCINNATI, OH

Issue Date  
4-MAY-2022

Checked


Drawn  
JAR

Project Number  
539-21-701


Building Number  
C2

Drawing Number  
AS-442-C.2.2



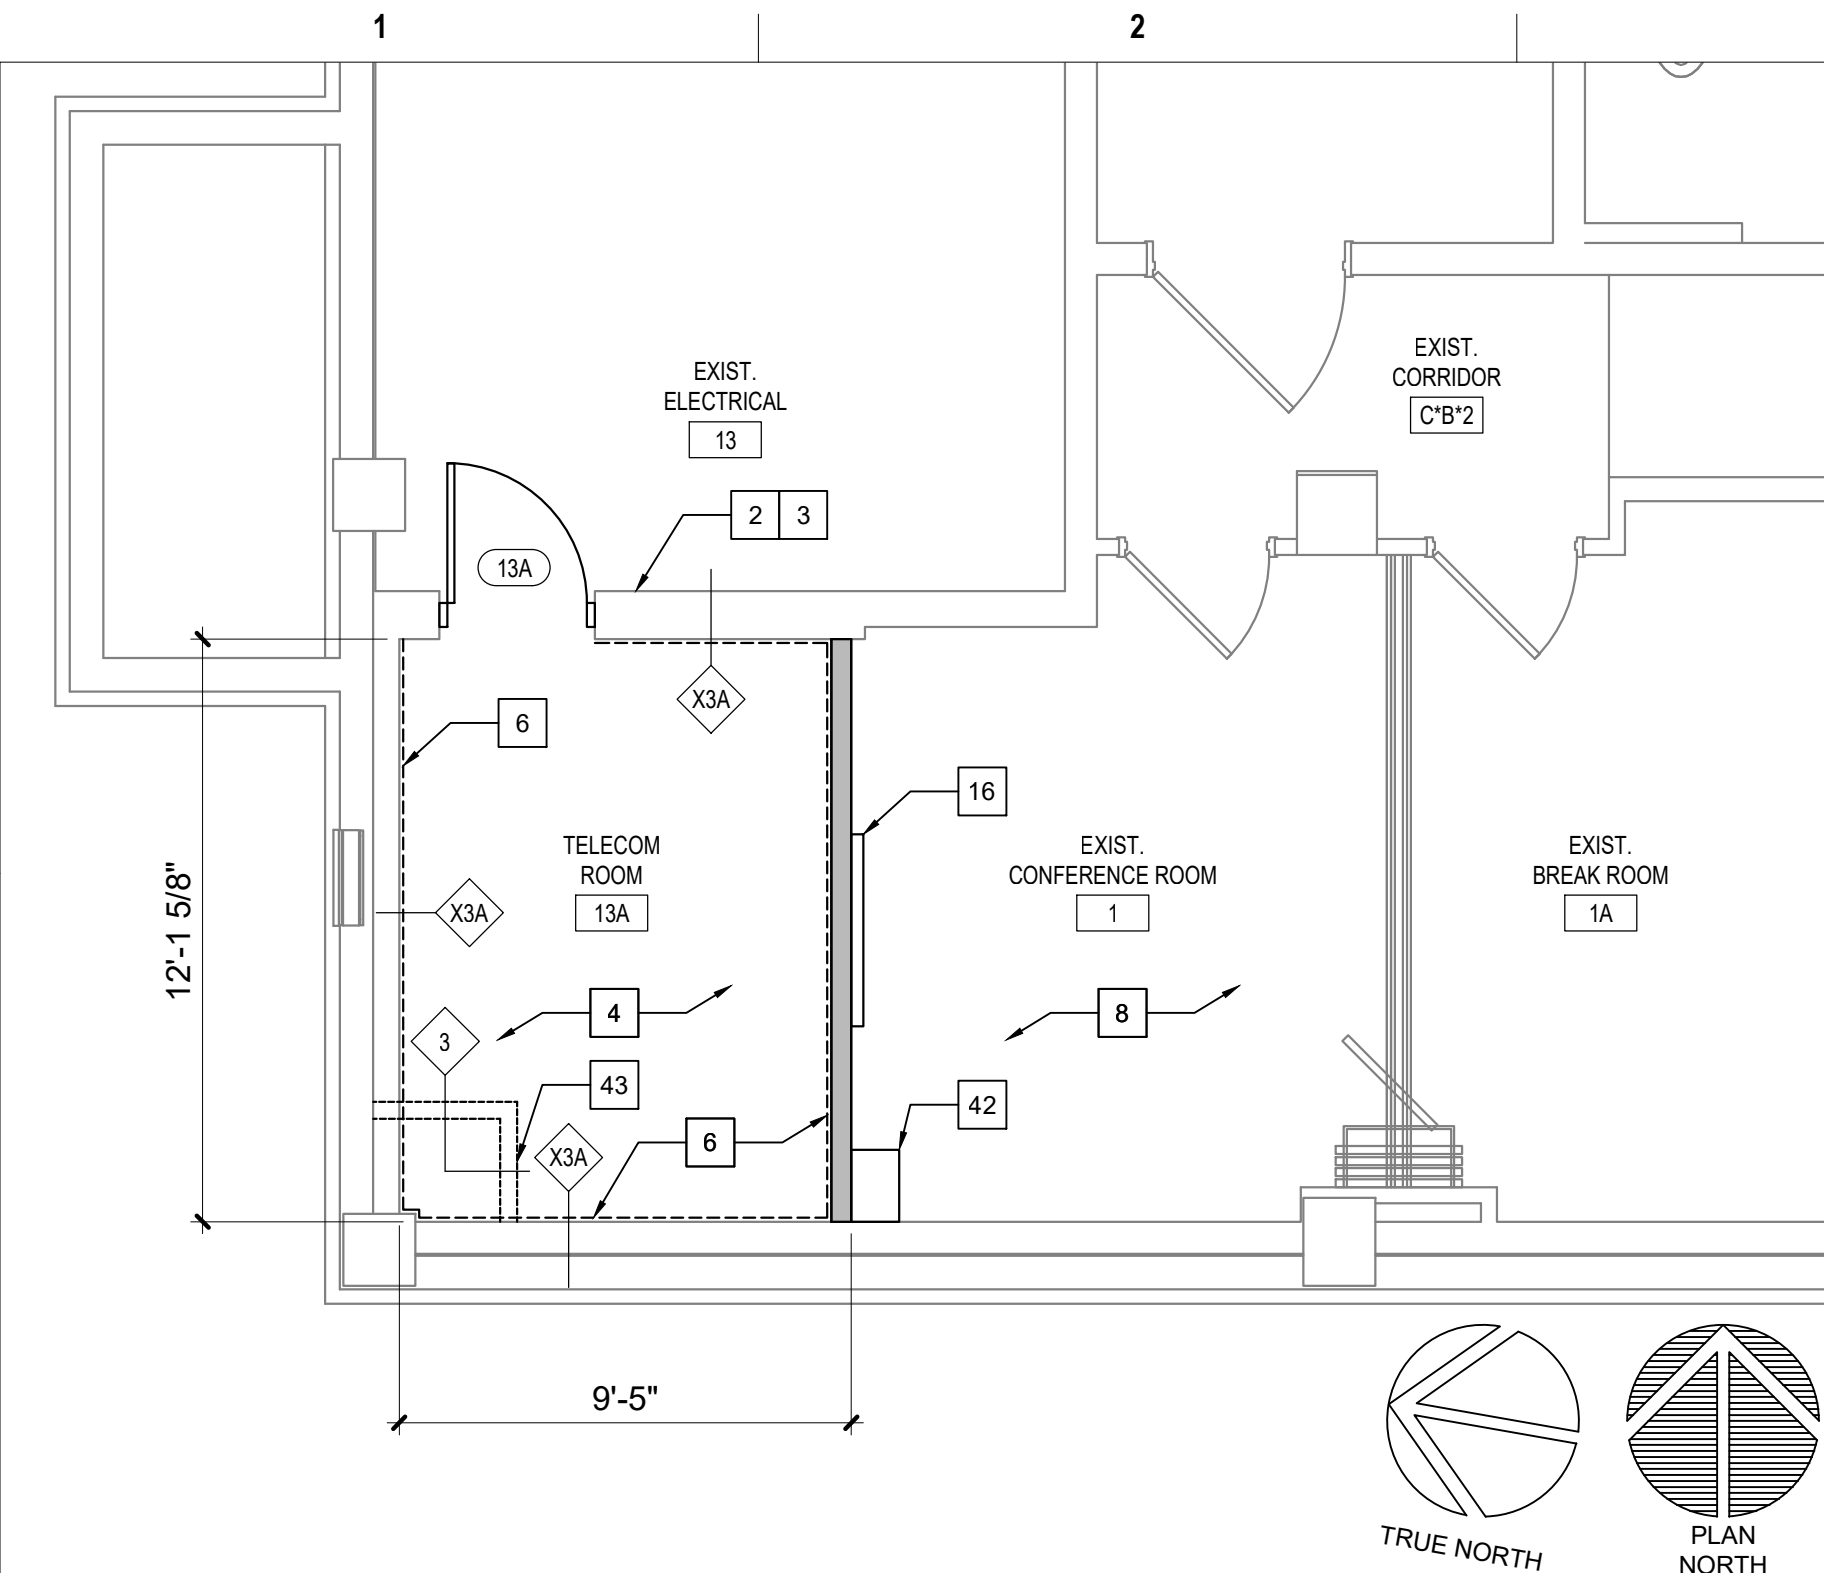

1 EXISTING CONFERENCE ROOM 1/TELECOM 13A - ROOM RENOVATION  
SCALE: 1/4" = 1'-0"

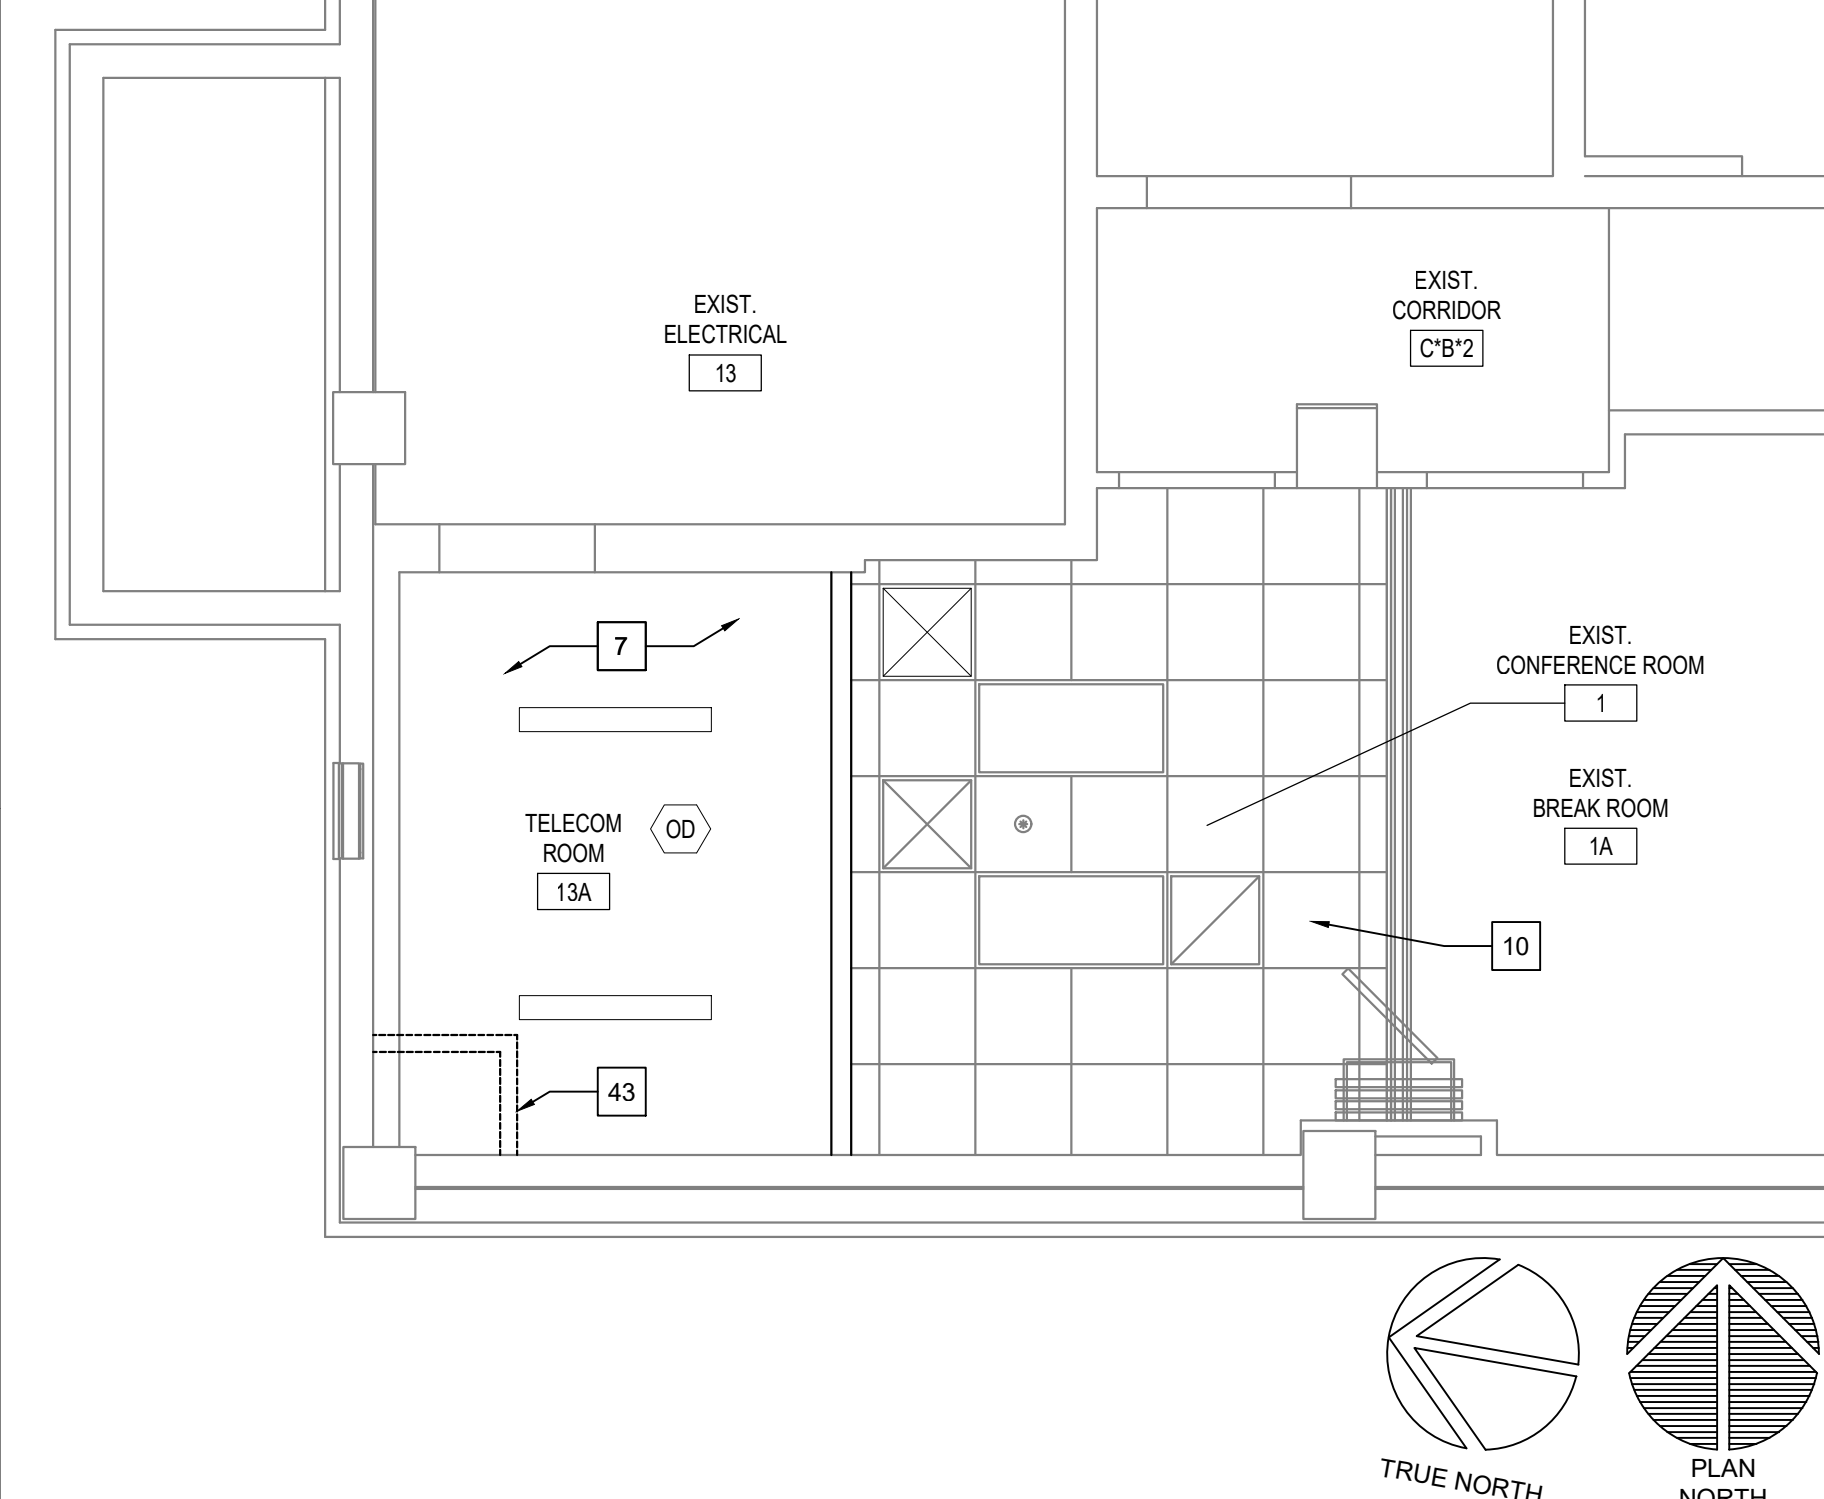

2 EXIST. CONFERENCE ROOM 1/TELECOM 13A - CEILING RENOVATION  
SCALE: 1/4" = 1'-0"

KEYED NOTES - RENOVATION

- EXISTING DOOR/FRAME ASSEMBLY TO REMAIN.
- PROVIDE CARD READER.
- PROVIDE ROOM SIGNAGE.
- PROVIDE NEW FLOORING AND BASE AS SCHEDULED.
- REFERENCE MEP AND TECHNOLOGY DRAWINGS FOR WORK SCOPE IN THIS ROOM THAT MAY REQUIRE MINOR DEMOLITION, PATCHING AND REPAIR OF EXISTING FLOOR SUBSTRATE, WALL OR MISCELLANEOUS ASSEMBLIES.
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- REFERENCE MEP AND TECHNOLOGY DRAWINGS FOR WORK SCOPE OF EXISTING AND NEW COMPONENTS AT CEILING LEVEL.
- EXISTING FLOOR AND BASE TO REMAIN. REPAIR AS NECESSARY TO MATCH EXISTING CONDITIONS OR BETTER.
- EXISTING VCT FLOORING AND RUBBER BASE TO REMAIN.
- LIMITED RENOVATION TO EXISTING CEILING ASSEMBLY PER MEP AND TECHNOLOGY DRAWINGS WORK SCOPE.
- RELOCATED EXISTING MARKER BOARD.
- RELOCATED EXISTING MILLWORK.
- CEILING FUR-DOWN ABOVE.
- NEW GYPSUM BOARD/METAL STUD FRAMED FUR-DOWN TO MATCH EXISTING HEIGHT. NO JOINTS UNLESS NOTED OTHERWISE.
- RELOCATED EXISTING LIGHT FIXTURE.
- RELOCATED EXISTING TV MONITOR.
- EXISTING ALUMINUM FLOOR AND WALL (EACH SIDE) EXPANSION JOINT COVERS TO REMAIN.
- EXISTING GYPSUM BOARD/METAL STUD FRAMED FUR-DOWN TO REMAIN.
- RELOCATED EXISTING FIRE EXTINGUISHER.
- EXISTING EXTERIOR WINDOW TO REMAIN.
- REINSTALL EXISTING SALVAGED WOOD BASE AND CHAIR RAIL. PROVIDE BALANCE OF MATERIAL AS NEEDED TO COMPLETE JOB. PAINT ALL BASE AND CHAIR RAIL IN ENTIRE ROOM.
- EXISTING PLASTER ON CMU TO UNDERSIDE OF EXISTING STRUCTURE (4" OR 8" CMU PER WALL THICKNESS DEPICTED GRAPHICALLY). FIRE-RATED WALL. CONTRACTOR VERIFY.
- EXISTING ROOM SIGNAGE.
- EXISTING CARD READER.
- REFERENCE DOOR SCHEDULE.
- PAINT INTERIOR SIDE OF EXISTING WINDOW GLAZING ONLY "FLAT BLACK".
- REINSTALLED EXISTING ROOM SIGNAGE.
- REINSTALLED EXISTING CARD READER.
- PLASTER ASSEMBLY INFILL AT EXISTING WALL AS DETAILED AT EXISTING WINDOW OPENING.
- ENSURE EXISTING WALL VENT IS SECURELY CLOSED SHUT PRIOR TO COVER-UP.
- PROVIDE WALL PROTECTION TO MATCH EXISTING.
- PROVIDE NEW CEILING AS SCHEDULED.
- PROVIDE GYPSUM BOARD/STEEL STUD FRAMED FUR-DOWN AS DETAILED.
- PROVIDE 2' X 2' RAISED FLOOR SYSTEM AT 10" ABOVE THE 4TH FLOOR LEVEL.
- ELECTRICAL CONDUITS AND MECHANICAL PIPING PER MEP DRAWINGS.
- PROVIDE 5/8" GYPSUM BOARD WHERE EXISTING TILE WAINSCOT AND SUBSTRATE WAS REMOVED. TEXTURE AND FINISH TO MATCH EXISTING ADJACENT WALLS (4'-0"± HIGH, LOCATE AS INDICATED BY HEAVY LINE).
- TEXTURE AND FINISH EXISTING GYPSUM BOARD SUBSTRATE TO MATCH EXISTING ADJACENT WALLS.
- GYPSUM BOARD ASSEMBLY INFILL AS DETAILED AT EXISTING WINDOW OPENING.
- PROVIDE INFILL PER KEYED NOTE 29 AT VOID LEFT BY HEATER REMOVED.
- PROVIDE 1" THICK MINIMUM CONCRETE INFILL FLUSH WITH EXISTING CONCRETE TOPPING WHERE PORTIONS OF EXISTING CMU WALLS ARE REMOVED.
- PROVIDE PAINTED WOOD CHAIR RAIL TO MATCH EXISTING.
- REINSTALLED EXISTING SHELF.
- PROVIDE GYPSUM BOARD/METAL STUD FRAMED CHASE FROM FLOORS ABOVE. MINIMIZE SIZE AND REFERENCE MEP DRAWINGS FOR COMPONENTS TO BE IN CHASE.
- RAMP AND RAILS BY RAISED FLOOR SYSTEM MANUFACTURER.
- ROOM PERIMETER WALLS TO BE FULLY SEALED TOP AND BOTTOM ON BOTH SIDES OF WALL. EXTERIOR WALL SEAL INTERIOR SIDE ONLY.

GENERAL NOTES - RENOVATION

- REFERENCE GENERAL NOTES ON SHEET GI-004.
- UNLESS NOTED OTHERWISE, ALL EXISTING WALLS ARE 5/8" GYPSUM BOARD/3 5/8" METAL STUD FRAMED TO UNDERSIDE OF PRIMARY BUILDING FRAMING STRUCTURE (1 HR. FIRE RATED - CONSTRUCTION SIMILAR TO U.I. DESIGN NO. U465). CONTRACTOR TO VERIFY.
- UNLESS NOTED OTHERWISE, ALL EXISTING DOOR ASSEMBLIES ARE SOLID CORE WOOD DOORS/HOLLOW METAL FRAME TYPICAL (3'-0" X 7'-0").
- UNLESS NOTED OTHERWISE ALL EXISTING LAY-IN CEILING ASSEMBLIES ARE 2' X 2' STANDARD GRID WITH FISSURED TILES AT 8'-0" A.F.F. TYPICAL.
- UNLESS NOTED OTHERWISE, ALL EXISTING STEEL COLUMN FUR-OUTS ARE GYPSUM BOARD/METAL STUD FRAMED TYPICAL.
- PARTIAL OR ENTIRE RECONSTRUCTION OF SOME EXISTING CEILING ASSEMBLIES THROUGH OUT THE ENTIRE BUILDING(S), ESPECIALLY IN CORRIDORS, WILL BE NECESSARY. REFERENCE ALL DISCIPLINE DEMOLITION DRAWINGS. RECONSTRUCTION IS TO INCLUDE MISCELLANEOUS PATCHING /REPAIR TO MATCH EXISTING OR BETTER CONDITIONS.
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- ALL NEW WALLS SHALL BE PARTITION TYPE "1" UNLESS OTHERWISE NOTED.
- UNLESS NOTED OTHERWISE AT ALL ROOMS WHERE EXISTING LAY-IN CEILING IS REMOVED AND IS TO BECOME A "NO CEILING" ROOM, THE EXISTING GYPSUM BOARD ABOVE. PREVIOUSLY REMOVED CEILING IS TO BE FULLY TAPED, FLOATED, TEXTURED AND PAINTED TO MATCH EXISTING WALLS.

KEYED NOTES - RENOVATION (CONT.)

- TEMPORARY ALUMINUM RAMP BY CONTRACTOR TO BE RETURNED TO OWNER AT END OF JOB.
- MODULAR BRICK INFILL ON EXTERIOR TO MATCH EXISTING. TOOTH-IN AND MATCH MORTAR.

LEGEND - RENOVATION

- |  |   |
|--|---|
|  | EXISTING WALL TO REMAIN   |
|  | NEW WALL CONSTRUCTION   |
|  | EXISTING DOOR/FRAME ASSEMBLY TO REMAIN                          |
|  | NEW DOOR/FRAME ASSEMBLY   |
|  | EXISTING WINDOW ASSEMBLY TO REMAIN                              |
|  | NEW WINDOW ASSEMBLY   |
|  | 1 HR. FIRE-RATED WALL (EXISTING)                                |
|  | 2 HR. FIRE-RATED WALL (EXISTING)                                |
|  | FIRE-RATED WALL (NEW OR EXISTING 1 HOUR UNLESS NOTED OTHERWISE) |

Revisions:	Date:

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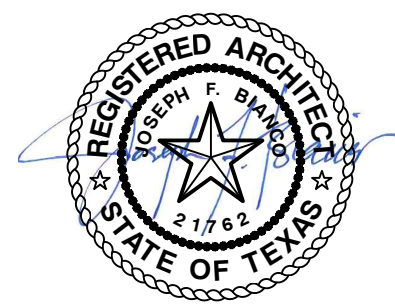
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Construction  
and Facilities  
Management

VA U.S. Department  
of Veterans Affairs

Drawing Title  
**ENLARGED FLOOR PLANS -  
BASEMENT FLOOR RENOVATION**

Approved: Project Director

Phase  
**100% CONSTRUCTION  
DOCUMENTS**

**FULLY SPRINKLERED**

Project Title  
**CINCINNATI VAMC EHRM  
INFRASTRUCTURE UPGRADES**

Location  
3200 VINE ST., CINCINNATI, OH

Issue Date  
4-MAY-2022

Checked

Drawn  
JAR


Project Number  
539-21-701

Building Number  
C3


Drawing Number

**AS-450-C.3.B**



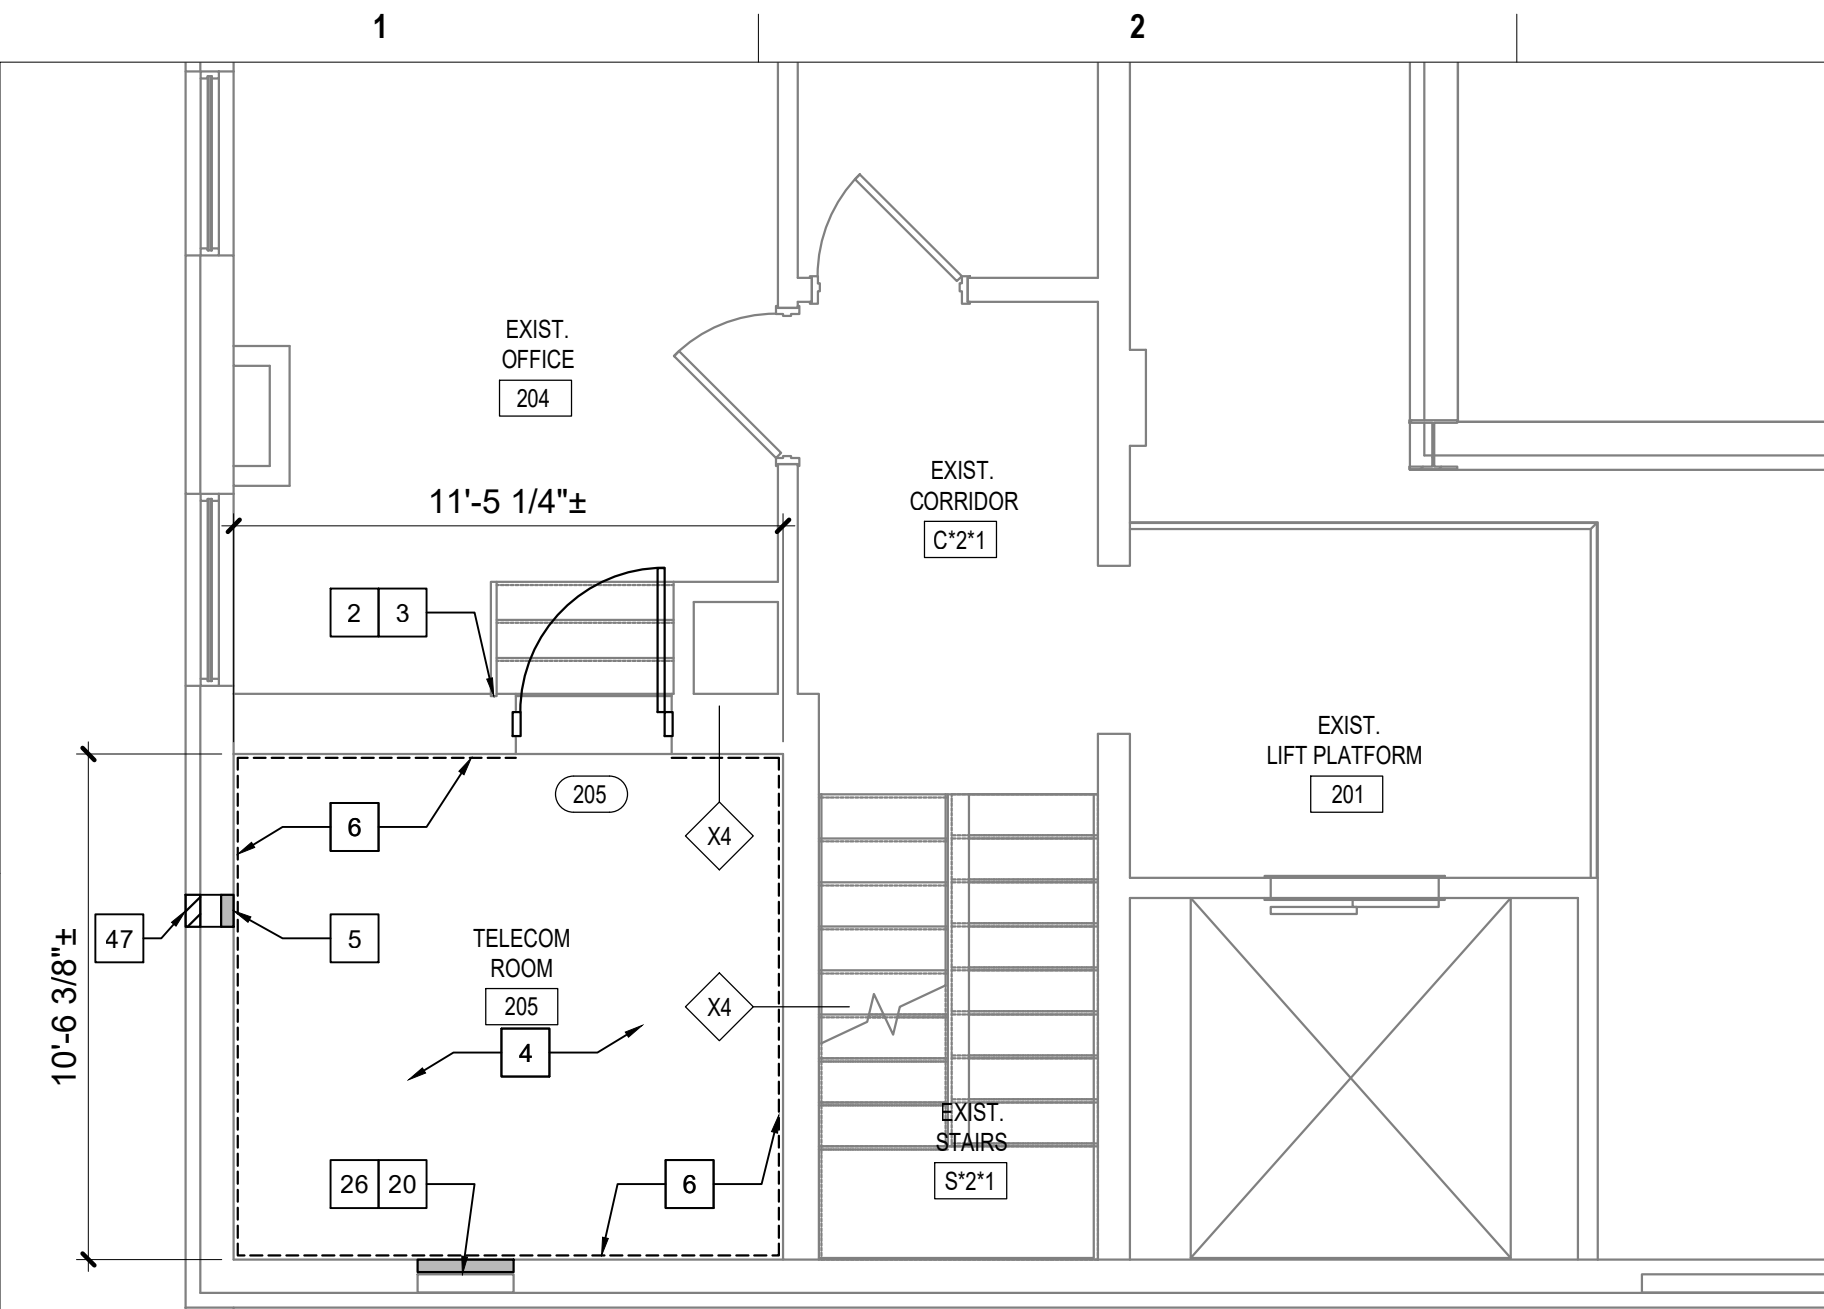

1 TELECOM ROOM 205 - ROOM RENOVATION  
SCALE: 1/4" = 1'-0"

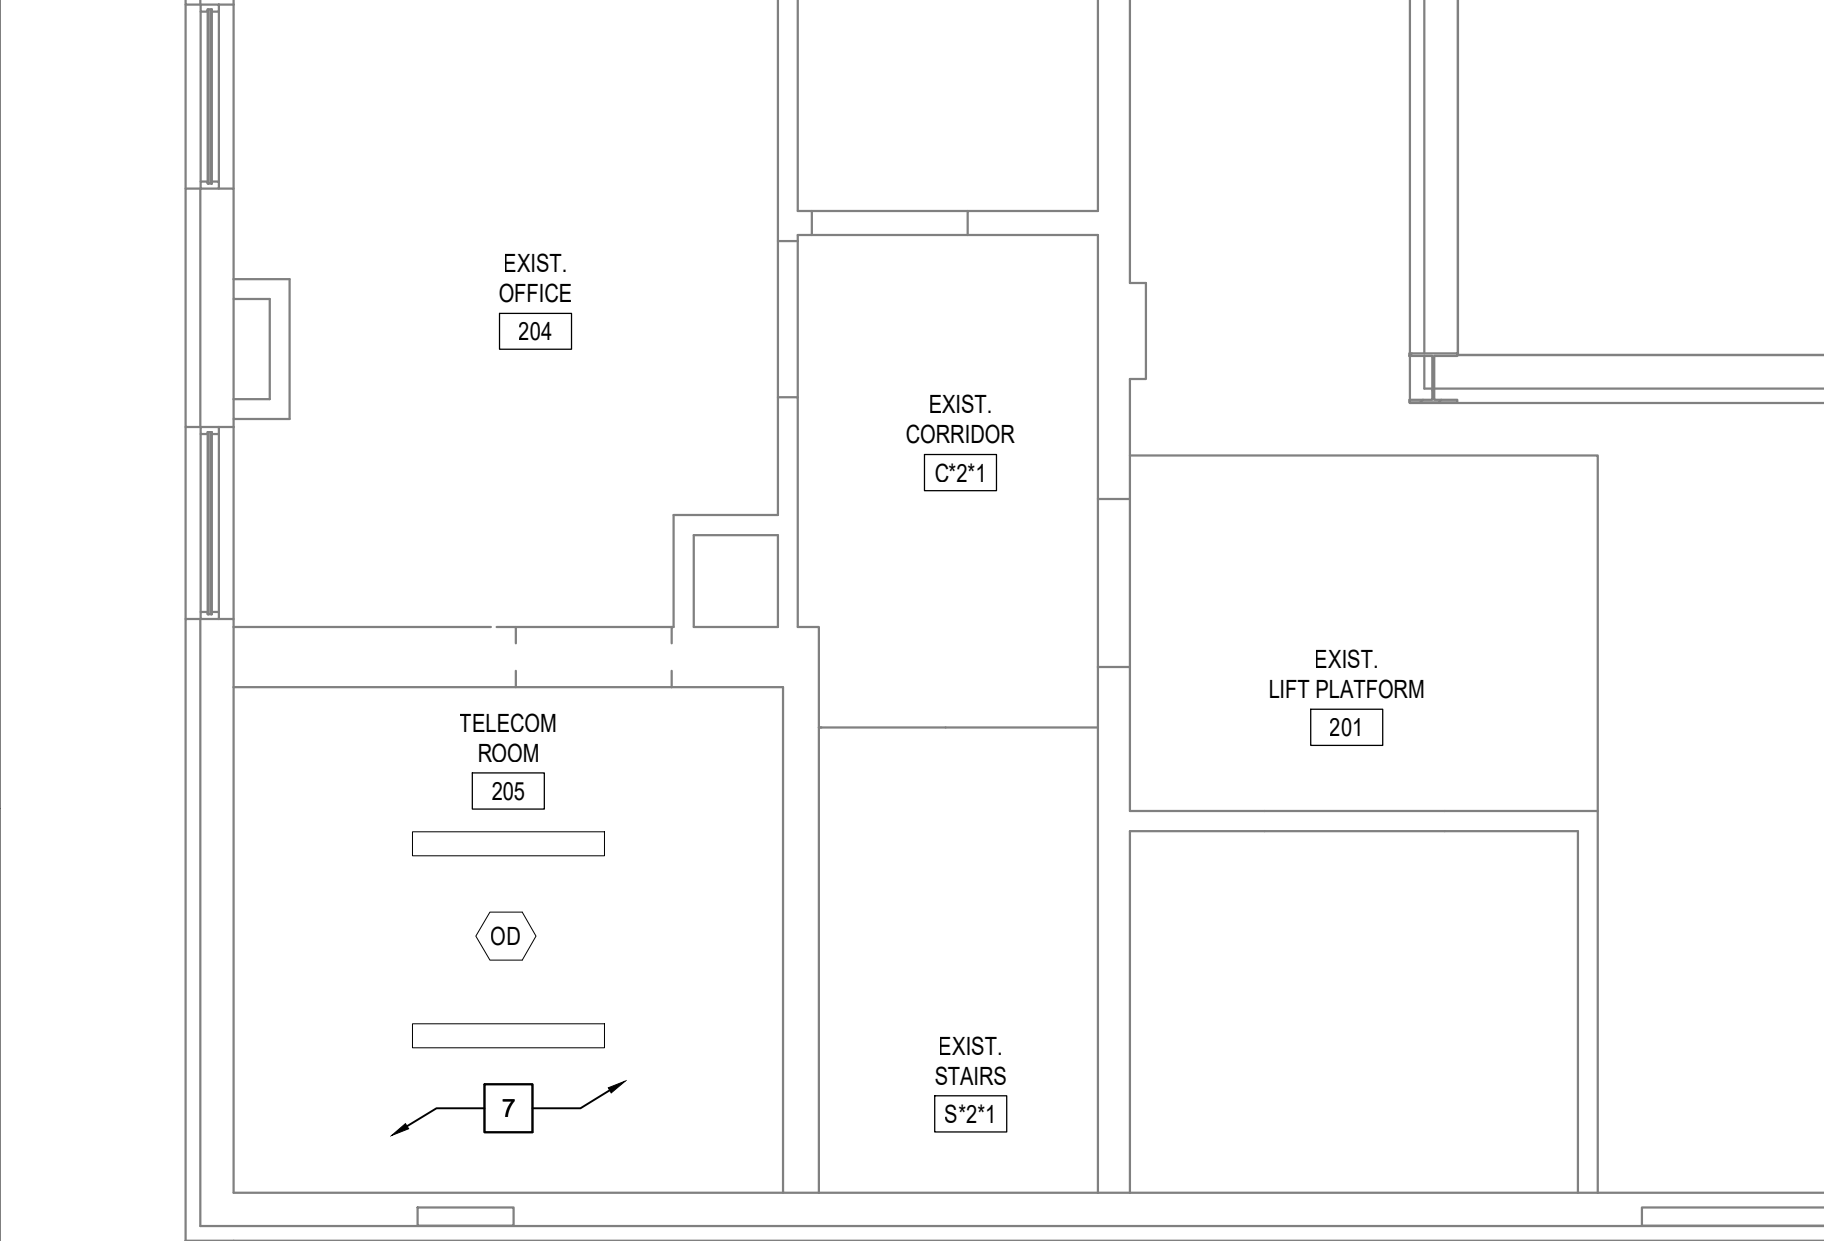

2 TELECOM ROOM 205 - CEILING RENOVATION  
SCALE: 1/4" = 1'-0"

KEYED NOTES - RENOVATION

- EXISTING DOOR/FRAME ASSEMBLY TO REMAIN.
- PROVIDE CARD READER.
- PROVIDE ROOM SIGNAGE.
- PROVIDE NEW FLOORING AND BASE AS SCHEDULED.
- REFERENCE MEP AND TECHNOLOGY DRAWINGS FOR WORK SCOPE IN THIS ROOM THAT MAY REQUIRE MINOR DEMOLITION, PATCHING AND REPAIR OF EXISTING FLOOR SUBSTRATE, WALL OR MISCELLANEOUS ASSEMBLIES.
- PROVIDE 8"x4"x3/4" AC FACED FIRE-RATED PLYWOOD VERTICALLY ON ALL WALLS AS INDICATED. PAINT WITH 2 COATS MIN. FIRE-RATED PAINT. COORDINATE EXACT LOCATION A.F.F. WITH TECHNOLOGY AND ELECTRICAL DRAWINGS AND EXISTING CONDITIONS.
- REFERENCE MEP AND TECHNOLOGY DRAWINGS FOR WORK SCOPE OF EXISTING AND NEW COMPONENTS AT CEILING LEVEL.
- EXISTING FLOOR AND BASE TO REMAIN. REPAIR AS NECESSARY TO MATCH EXISTING CONDITIONS OR BETTER.
- EXISTING VCT FLOORING AND RUBBER BASE TO REMAIN.
- LIMITED RENOVATION TO EXISTING CEILING ASSEMBLY PER MEP AND TECHNOLOGY DRAWINGS WORK SCOPE.
- RELOCATED EXISTING MARKER BOARD.
- RELOCATED EXISTING MILLWORK.
- CEILING FUR-DOWN ABOVE.
- NEW GYPSUM BOARD/METAL STUD FRAMED FUR-DOWN TO MATCH EXISTING HEIGHT. NO JOINTS UNLESS NOTED OTHERWISE.
- RELOCATED EXISTING LIGHT FIXTURE.
- RELOCATED EXISTING TV MONITOR.
- EXISTING ALUMINUM FLOOR AND WALL (EACH SIDE) EXPANSION JOINT COVERS TO REMAIN.
- EXISTING GYPSUM BOARD/METAL STUD FRAMED FUR-DOWN TO REMAIN.
- RELOCATED EXISTING FIRE EXTINGUISHER.
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- REINSTALL EXISTING SALVAGED WOOD BASE AND CHAIR RAIL. PROVIDE BALANCE OF MATERIAL AS NEEDED TO COMPLETE JOB. PAINT ALL BASE AND CHAIR RAIL IN ENTIRE ROOM.
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- EXISTING ROOM SIGNAGE.
- EXISTING CARD READER.
- REFERENCE DOOR SCHEDULE.
- PAINT INTERIOR SIDE OF EXISTING WINDOW GLAZING ONLY "FLAT BLACK".
- REINSTALLED EXISTING ROOM SIGNAGE.
- REINSTALLED EXISTING CARD READER.
- PLASTER ASSEMBLY INFILL AT EXISTING WALL AS DETAILED AT EXISTING WINDOW OPENING.
- ENSURE EXISTING WALL VENT IS SECURELY CLOSED SHUT PRIOR TO COVER-UP.
- PROVIDE WALL PROTECTION TO MATCH EXISTING.
- PROVIDE NEW CEILING AS SCHEDULED.
- PROVIDE GYPSUM BOARD/STEEL STUD FRAMED FUR-DOWN AS DETAILED.
- PROVIDE 2' X 2' RAISED FLOOR SYSTEM AT 10" ABOVE THE 4TH FLOOR LEVEL.
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- TEXTURE AND FINISH EXISTING GYPSUM BOARD SUBSTRATE TO MATCH EXISTING ADJACENT WALLS.
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- PROVIDE GYPSUM BOARD/METAL STUD FRAMED CHASE FROM FLOORS ABOVE. MINIMIZE SIZE AND REFERENCE MEP DRAWINGS FOR COMPONENTS TO BE IN CHASE.
- RAMP AND RAILS BY RAISED FLOOR SYSTEM MANUFACTURER.
- ROOM PERIMETER WALLS TO BE FULLY SEALED TOP AND BOTTOM ON BOTH SIDES OF WALL. EXTERIOR WALL SEAL INTERIOR SIDE ONLY.

GENERAL NOTES - RENOVATION

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- EXISTING FIRE-RATED WALL IDENTIFICATION INDICATED ONLY FOR IMMEDIATE AFFECTED ROOM WALLS. CONTRACTOR SHALL VERIFY FULL EXTENT OF EXISTING FIRE-RATED WALLS AT ADJACENT AREAS.
- ALL NEW WALLS SHALL BE PARTITION TYPE "1" UNLESS OTHERWISE NOTED.
- UNLESS NOTED OTHERWISE AT ALL ROOMS WHERE EXISTING LAY-IN CEILING IS REMOVED AND IS TO BECOME A "NO CEILING" ROOM, THE EXISTING GYPSUM BOARD ABOVE PREVIOUSLY REMOVED CEILING IS TO BE FULLY TAPED, FLOATED, TEXTURED AND PAINTED TO MATCH EXISTING WALLS.

KEYED NOTES - RENOVATION (CONT.)


- TEMPORARY ALUMINUM RAMP BY CONTRACTOR TO BE RETURNED TO OWNER AT END OF JOB.
- MODULAR BRICK INFILL ON EXTERIOR TO MATCH EXISTING. TOOTH-IN AND MATCH MORTAR.

LEGEND - RENOVATION

- EXISTING WALL TO REMAIN
- NEW WALL CONSTRUCTION
- EXISTING DOOR/FRAME ASSEMBLY TO REMAIN
- NEW DOOR/FRAME ASSEMBLY
- EXISTING WINDOW ASSEMBLY TO REMAIN
- NEW WINDOW ASSEMBLY
- 1 HR. FIRE-RATED WALL (EXISTING)
- 2 HR. FIRE-RATED WALL (EXISTING)
- FIRE-RATED WALL (NEW OR EXISTING 1 HOUR UNLESS NOTED OTHERWISE)

Revisions:	Date:

CONSULTANT




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Construction  
and Facilities  
Management

 U.S. Department  
of Veterans Affairs

Drawing Title

ENLARGED FLOOR PLANS -  
2ND FLOOR RENOVATION

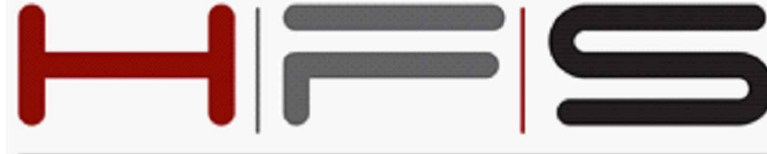Approved: Project Director

Phase

100% CONSTRUCTION  
DOCUMENTS

FULLY SPRINKLERED

Project Title

CINCINNATI VAMC EHRM  
INFRASTRUCTURE UPGRADES

Location  
3200 VINE ST., CINCINNATI, OH

Issue Date  
4-MAY-2022

Checked


Drawn  
JAR

Project Number  
539-21-701

Building Number  
C8

Drawing Number  
AS-460-C.8.2



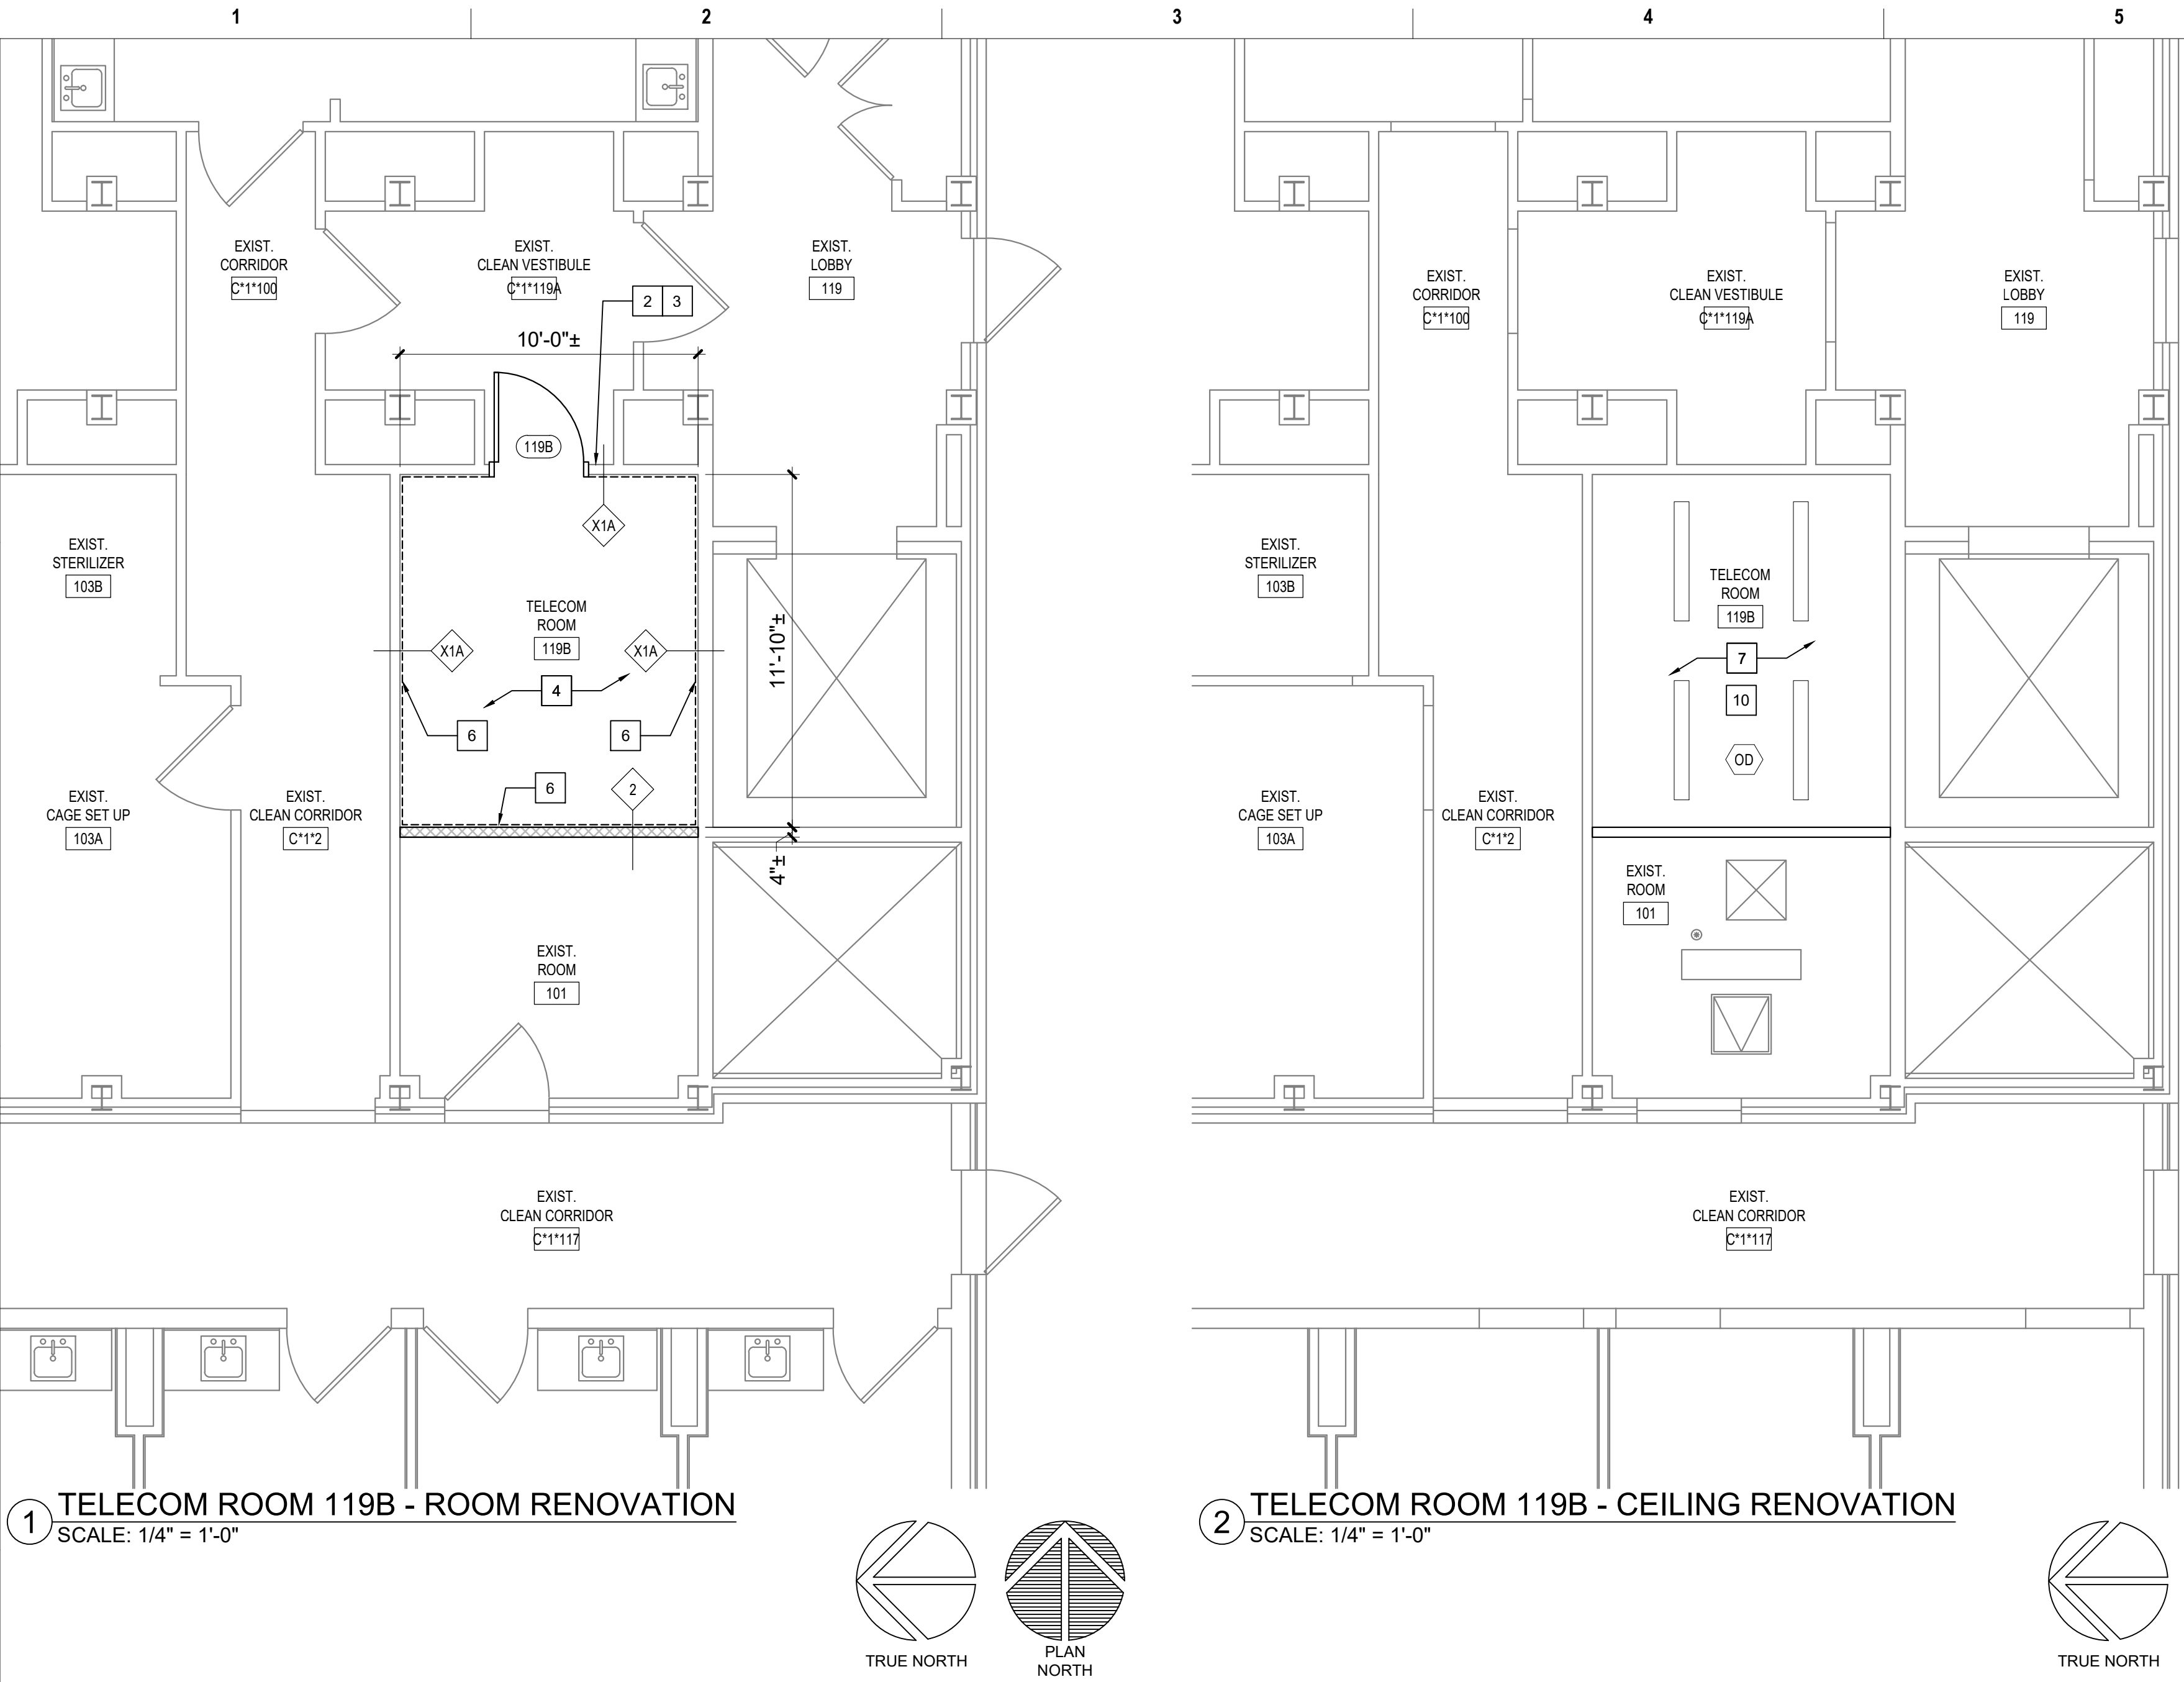

KEYED NOTES - RENOVATION

- EXISTING DOOR/FRAME ASSEMBLY TO REMAIN.
- PROVIDE CARD READER.
- PROVIDE ROOM SIGNAGE.
- PROVIDE NEW FLOORING AND BASE AS SCHEDULED.
- REFERENCE MEP AND TECHNOLOGY DRAWINGS FOR WORK SCOPE IN THIS ROOM THAT MAY REQUIRE MINOR DEMOLITION, PATCHING AND REPAIR OF EXISTING FLOOR SUBSTRATE, WALL OR MISCELLANEOUS ASSEMBLIES.
- PROVIDE 8'x4'x3/4" AC FACED FIRE-RATED PLYWOOD VERTICALLY ON ALL WALLS AS INDICATED. PAINT WITH 2 COATS MIN. FIRE-RATED PAINT. COORDINATE EXACT LOCATION A.F.F. WITH TECHNOLOGY AND ELECTRICAL DRAWINGS AND EXISTING CONDITIONS.
- REFERENCE MEP AND TECHNOLOGY DRAWINGS FOR WORK SCOPE OF EXISTING AND NEW COMPONENTS AT CEILING LEVEL.
- EXISTING FLOOR AND BASE TO REMAIN. REPAIR AS NECESSARY TO MATCH EXISTING CONDITIONS OR BETTER.
- EXISTING VCT FLOORING AND RUBBER BASE TO REMAIN.
- LIMITED RENOVATION TO EXISTING CEILING ASSEMBLY PER MEP AND TECHNOLOGY DRAWINGS WORK SCOPE.
- RELOCATED EXISTING MARKER BOARD.
- RELOCATED EXISTING MILLWORK.
- CEILING FUR-DOWN ABOVE.
- NEW GYPSUM BOARD/METAL STUD FRAMED FUR-DOWN TO MATCH EXISTING HEIGHT. NO JOINTS UNLESS NOTED OTHERWISE.
- RELOCATED EXISTING LIGHT FIXTURE.
- RELOCATED EXISTING TV MONITOR.
- EXISTING ALUMINUM FLOOR AND WALL (EACH SIDE) EXPANSION JOINT COVERS TO REMAIN.
- EXISTING GYPSUM BOARD/METAL STUD FRAMED FUR-DOWN TO REMAIN.
- RELOCATED EXISTING FIRE EXTINGUISHER.
- EXISTING EXTERIOR WINDOW TO REMAIN.
- REINSTALL EXISTING SALVAGED WOOD BASE AND CHAIR RAIL. PROVIDE BALANCE OF MATERIAL AS NEEDED TO COMPLETE JOB. PAINT ALL BASE AND CHAIR RAIL IN ENTIRE ROOM.
- EXISTING PLASTER ON CMU TO UNDERSIDE OF EXISTING STRUCTURE (4" OR 8" CMU PER WALL THICKNESS DEPICTED GRAPHICALLY). FIRE-RATED WALL. CONTRACTOR VERIFY.
- EXISTING ROOM SIGNAGE.
- EXISTING CARD READER.
- REFERENCE DOOR SCHEDULE.
- PAINT INTERIOR SIDE OF EXISTING WINDOW GLAZING ONLY "FLAT BLACK".
- REINSTALLED EXISTING ROOM SIGNAGE.
- REINSTALLED EXISTING CARD READER.
- PLASTER ASSEMBLY INFILL AT EXISTING WALL AS DETAILED AT EXISTING WINDOW OPENING.
- ENSURE EXISTING WALL VENT IS SECURELY CLOSED SHUT PRIOR TO COVER-UP.
- PROVIDE WALL PROTECTION TO MATCH EXISTING.
- PROVIDE NEW CEILING AS SCHEDULED.
- PROVIDE GYPSUM BOARD/STEEL STUD FRAMED FUR-DOWN AS DETAILED.
- PROVIDE 2' X 2' RAISED FLOOR SYSTEM AT 10" ABOVE THE 4TH FLOOR LEVEL.
- ELECTRICAL CONDUITS AND MECHANICAL PIPING PER MEP DRAWINGS.
- PROVIDE 5/8" GYPSUM BOARD WHERE EXISTING TILE WAINSCOT AND SUBSTRATE WAS REMOVED. TEXTURE AND FINISH TO MATCH EXISTING ADJACENT WALLS (4'-0"± HIGH, LOCATE AS INDICATED BY HEAVY LINE).
- TEXTURE AND FINISH EXISTING GYPSUM BOARD SUBSTRATE TO MATCH EXISTING ADJACENT WALLS.
- GYPSUM BOARD ASSEMBLY INFILL AS DETAILED AT EXISTING WINDOW OPENING.
- PROVIDE INFILL PER KEYED NOTE 29 AT VOID LEFT BY HEATER REMOVED.
- PROVIDE 1" THICK MINIMUM CONCRETE INFILL FLUSH WITH EXISTING CONCRETE TOPPING WHERE PORTIONS OF EXISTING CMU WALLS ARE REMOVED.
- PROVIDE PAINTED WOOD CHAIR RAIL TO MATCH EXISTING.
- REINSTALLED EXISTING SHELF.
- PROVIDE GYPSUM BOARD/METAL STUD FRAMED CHASE FROM FLOORS ABOVE. MINIMIZE SIZE AND REFERENCE MEP DRAWINGS FOR COMPONENTS TO BE IN CHASE.
- RAMP AND RAILS BY RAISED FLOOR SYSTEM MANUFACTURER.
- ROOM PERIMETER WALLS TO BE FULLY SEALED TOP AND BOTTOM ON BOTH SIDES OF WALL. EXTERIOR WALL SEAL INTERIOR SIDE ONLY.

GENERAL NOTES - RENOVATION

- REFERENCE GENERAL NOTES ON SHEET GI-004.
- UNLESS NOTED OTHERWISE, ALL EXISTING WALLS ARE 5/8" GYPSUM BOARD/3 5/8" METAL STUD FRAMED TO UNDERSIDE OF PRIMARY BUILDING FRAMING STRUCTURE (1 HR. FIRE RATED - CONSTRUCTION SIMILAR TO U.I. DESIGN NO. U465). CONTRACTOR TO VERIFY.
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KEYED NOTES - RENOVATION (CONT.)


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LEGEND - RENOVATION

- EXISTING WALL TO REMAIN
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Revisions:	Date:

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Construction and Facilities Management

 U.S. Department of Veterans Affairs

Drawing Title

ENLARGED FLOOR PLANS - 1ST FLOOR RENOVATION

Approved: Project Director

Phase

100% CONSTRUCTION DOCUMENTS

FULLY SPRINKLERED

Project Title

CINCINNATI VAMC EHRM INFRASTRUCTURE UPGRADES

Location  
3200 VINE ST., CINCINNATI, OH

Issue Date  
4-MAY-2022

Checked


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Project Number  
539-21-701



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Drawing Number  
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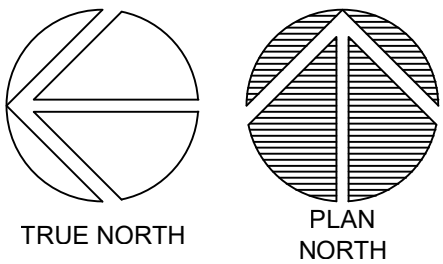




1 EXISTING XXX - ROOM RENOVATION  
SCALE: 1/4" = 1'-0"

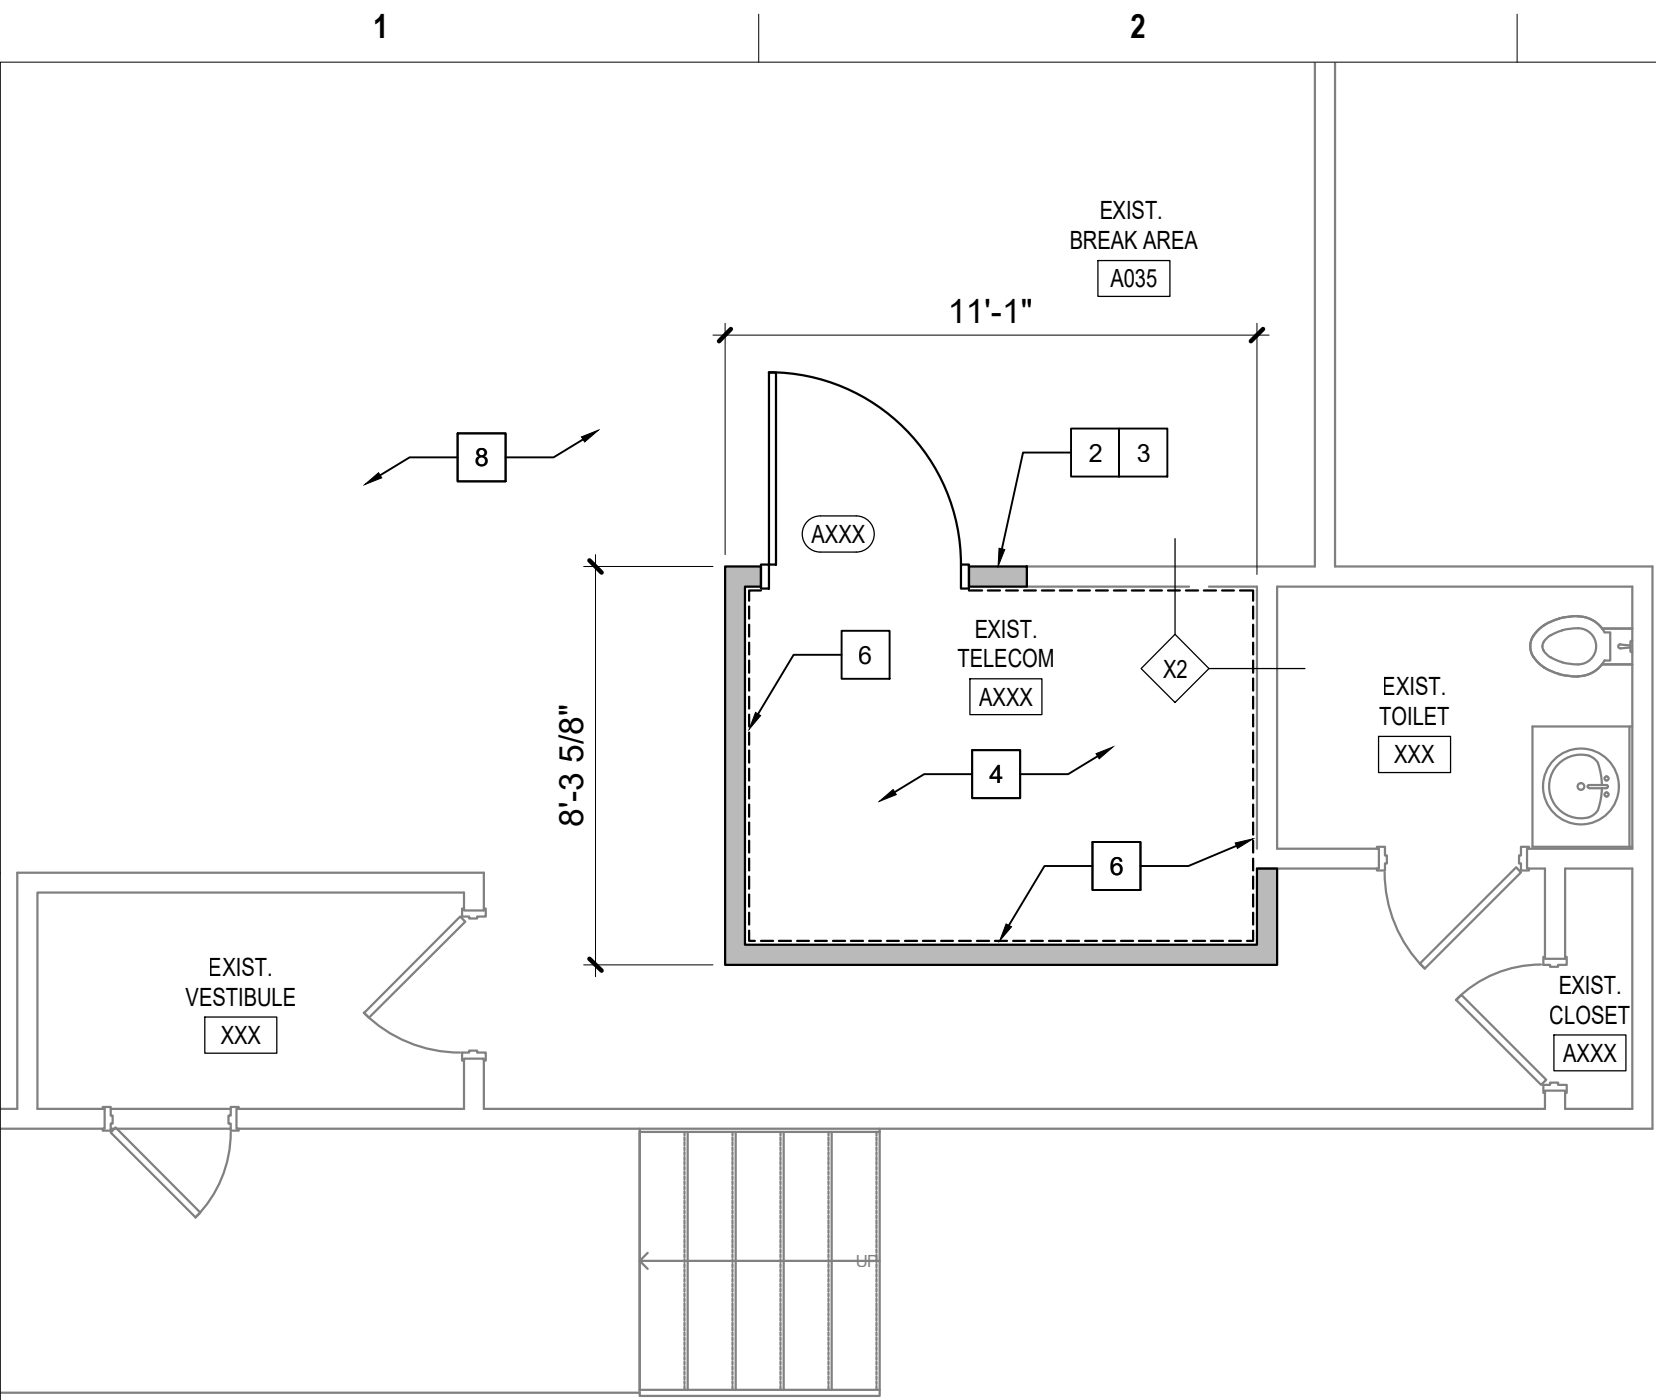

2 EXISTING XXX - CEILING RENOVATION  
SCALE: 1/4" = 1'-0"

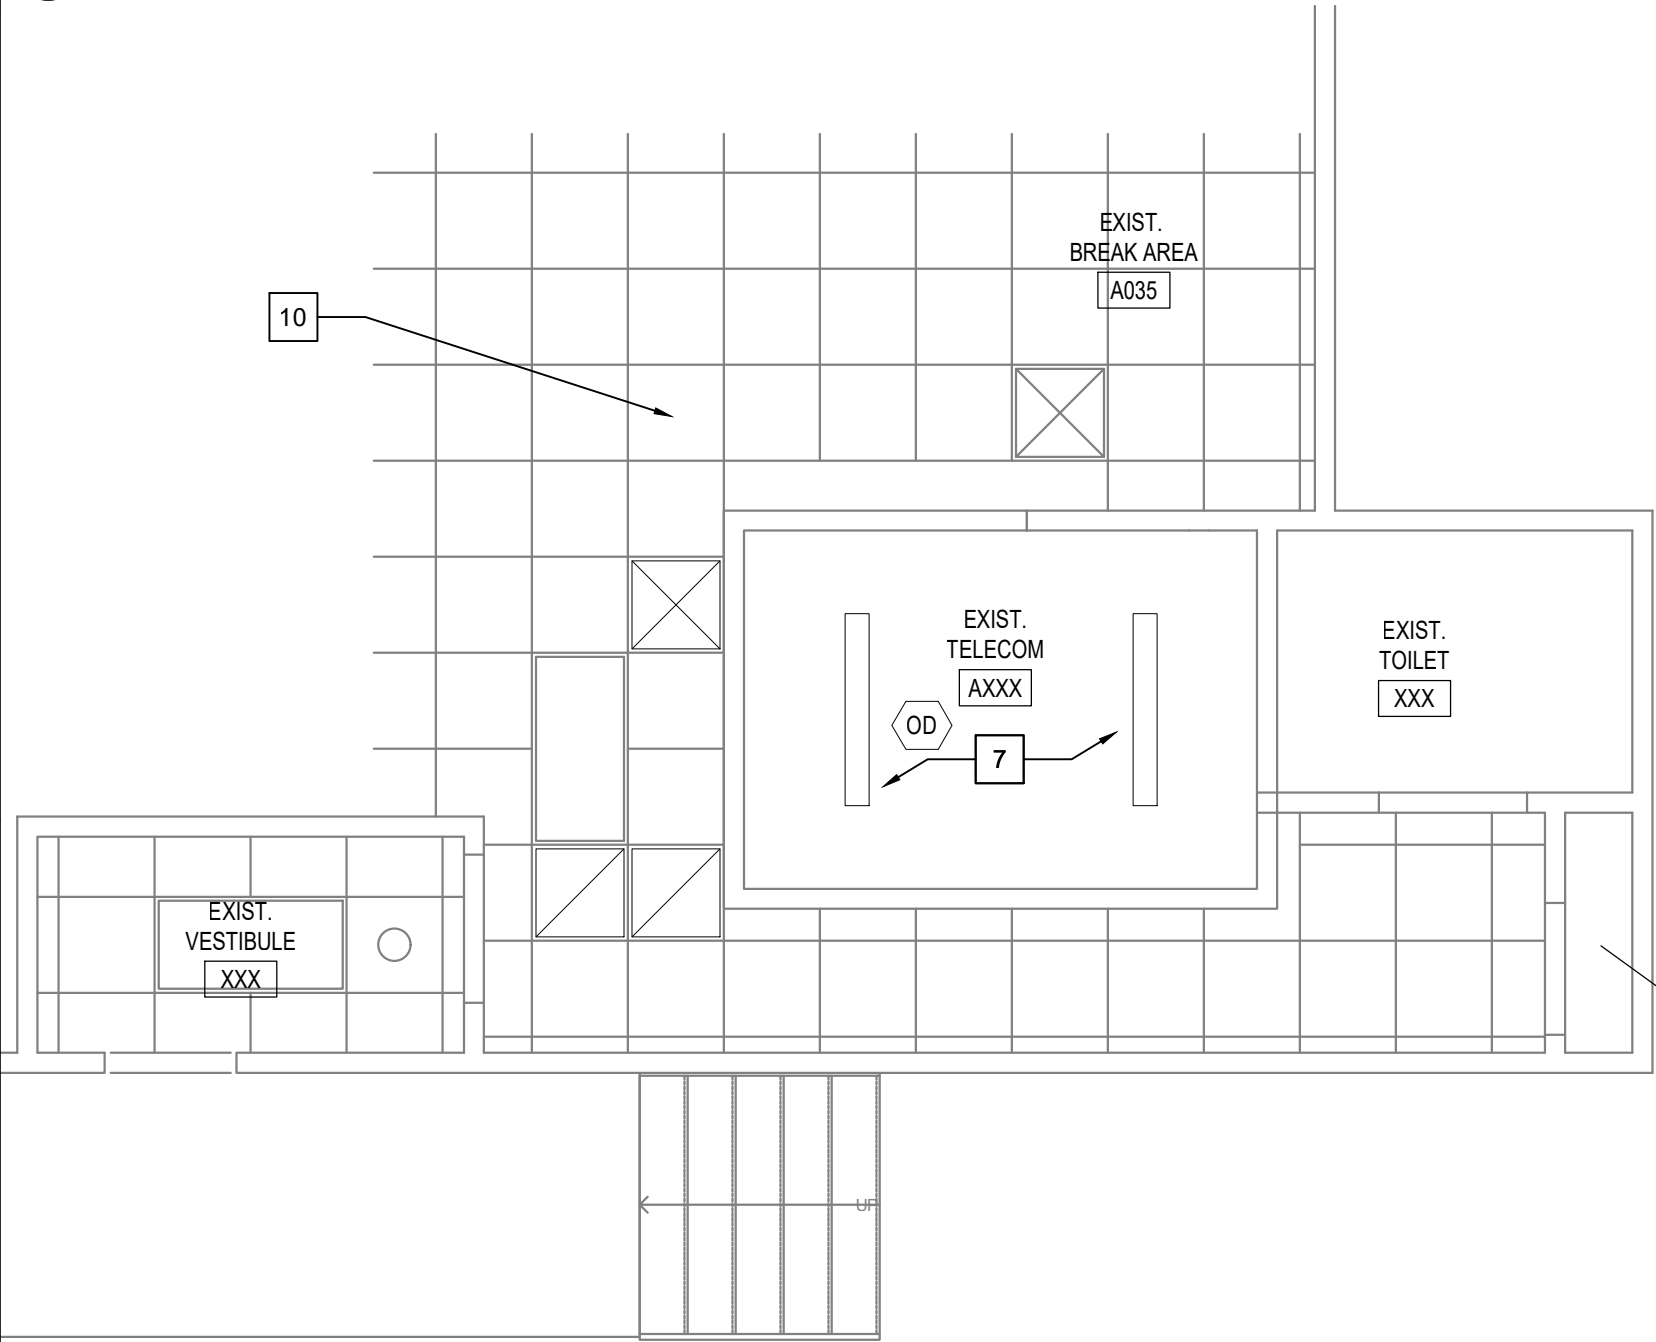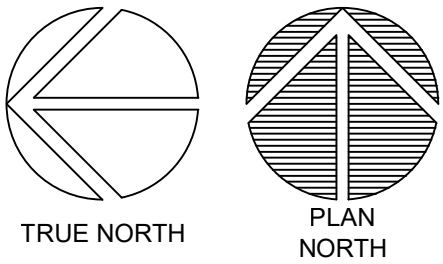

#### KEYED NOTES - RENOVATION

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- PROVIDE CARD READER.
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- REFERENCE MEP AND TECHNOLOGY DRAWINGS FOR WORK SCOPE IN THIS ROOM THAT MAY REQUIRE MINOR DEMOLITION, PATCHING AND REPAIR OF EXISTING FLOOR SUBSTRATE, WALL OR MISCELLANEOUS ASSEMBLIES.
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#### KEYED NOTES - RENOVATION (CONT.)

- TEMPORARY ALUMINUM RAMP BY CONTRACTOR TO BE RETURNED TO OWNER AT END OF JOB.
- MODULAR BRICK INFILL ON EXTERIOR TO MATCH EXISTING. TOOTH-IN AND MATCH MORTAR.

#### LEGEND - RENOVATION

- |  |   |
|--|---|
|  | EXISTING WALL TO REMAIN   |
|  | NEW WALL CONSTRUCTION   |
|  | EXISTING DOOR/FRAME ASSEMBLY TO REMAIN                          |
|  | NEW DOOR/FRAME ASSEMBLY   |
|  | EXISTING WINDOW ASSEMBLY TO REMAIN                              |
|  | NEW WINDOW ASSEMBLY   |
|  | 1 HR. FIRE-RATED WALL (EXISTING)                                |
|  | 2 HR. FIRE-RATED WALL (EXISTING)                                |
|  | FIRE-RATED WALL (NEW OR EXISTING 1 HOUR UNLESS NOTED OTHERWISE) |

Revisions:	Date:

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Construction  
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Management



U.S. Department  
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Drawing Title

ENLARGED FLOOR PLANS -  
1ST FLOOR RENOVATION

Approved: Project Director

Phase

100% CONSTRUCTION  
DOCUMENTS

FULLY SPRINKLERED

Project Title

CINCINNATI VAMC EHRM  
INFRASTRUCTURE UPGRADES

Location

3200 VINE ST., CINCINNATI, OH

Issue Date

4-MAY-2022

Checked

Drawn

JAR

Project Number

539-21-701



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


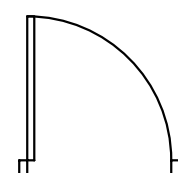








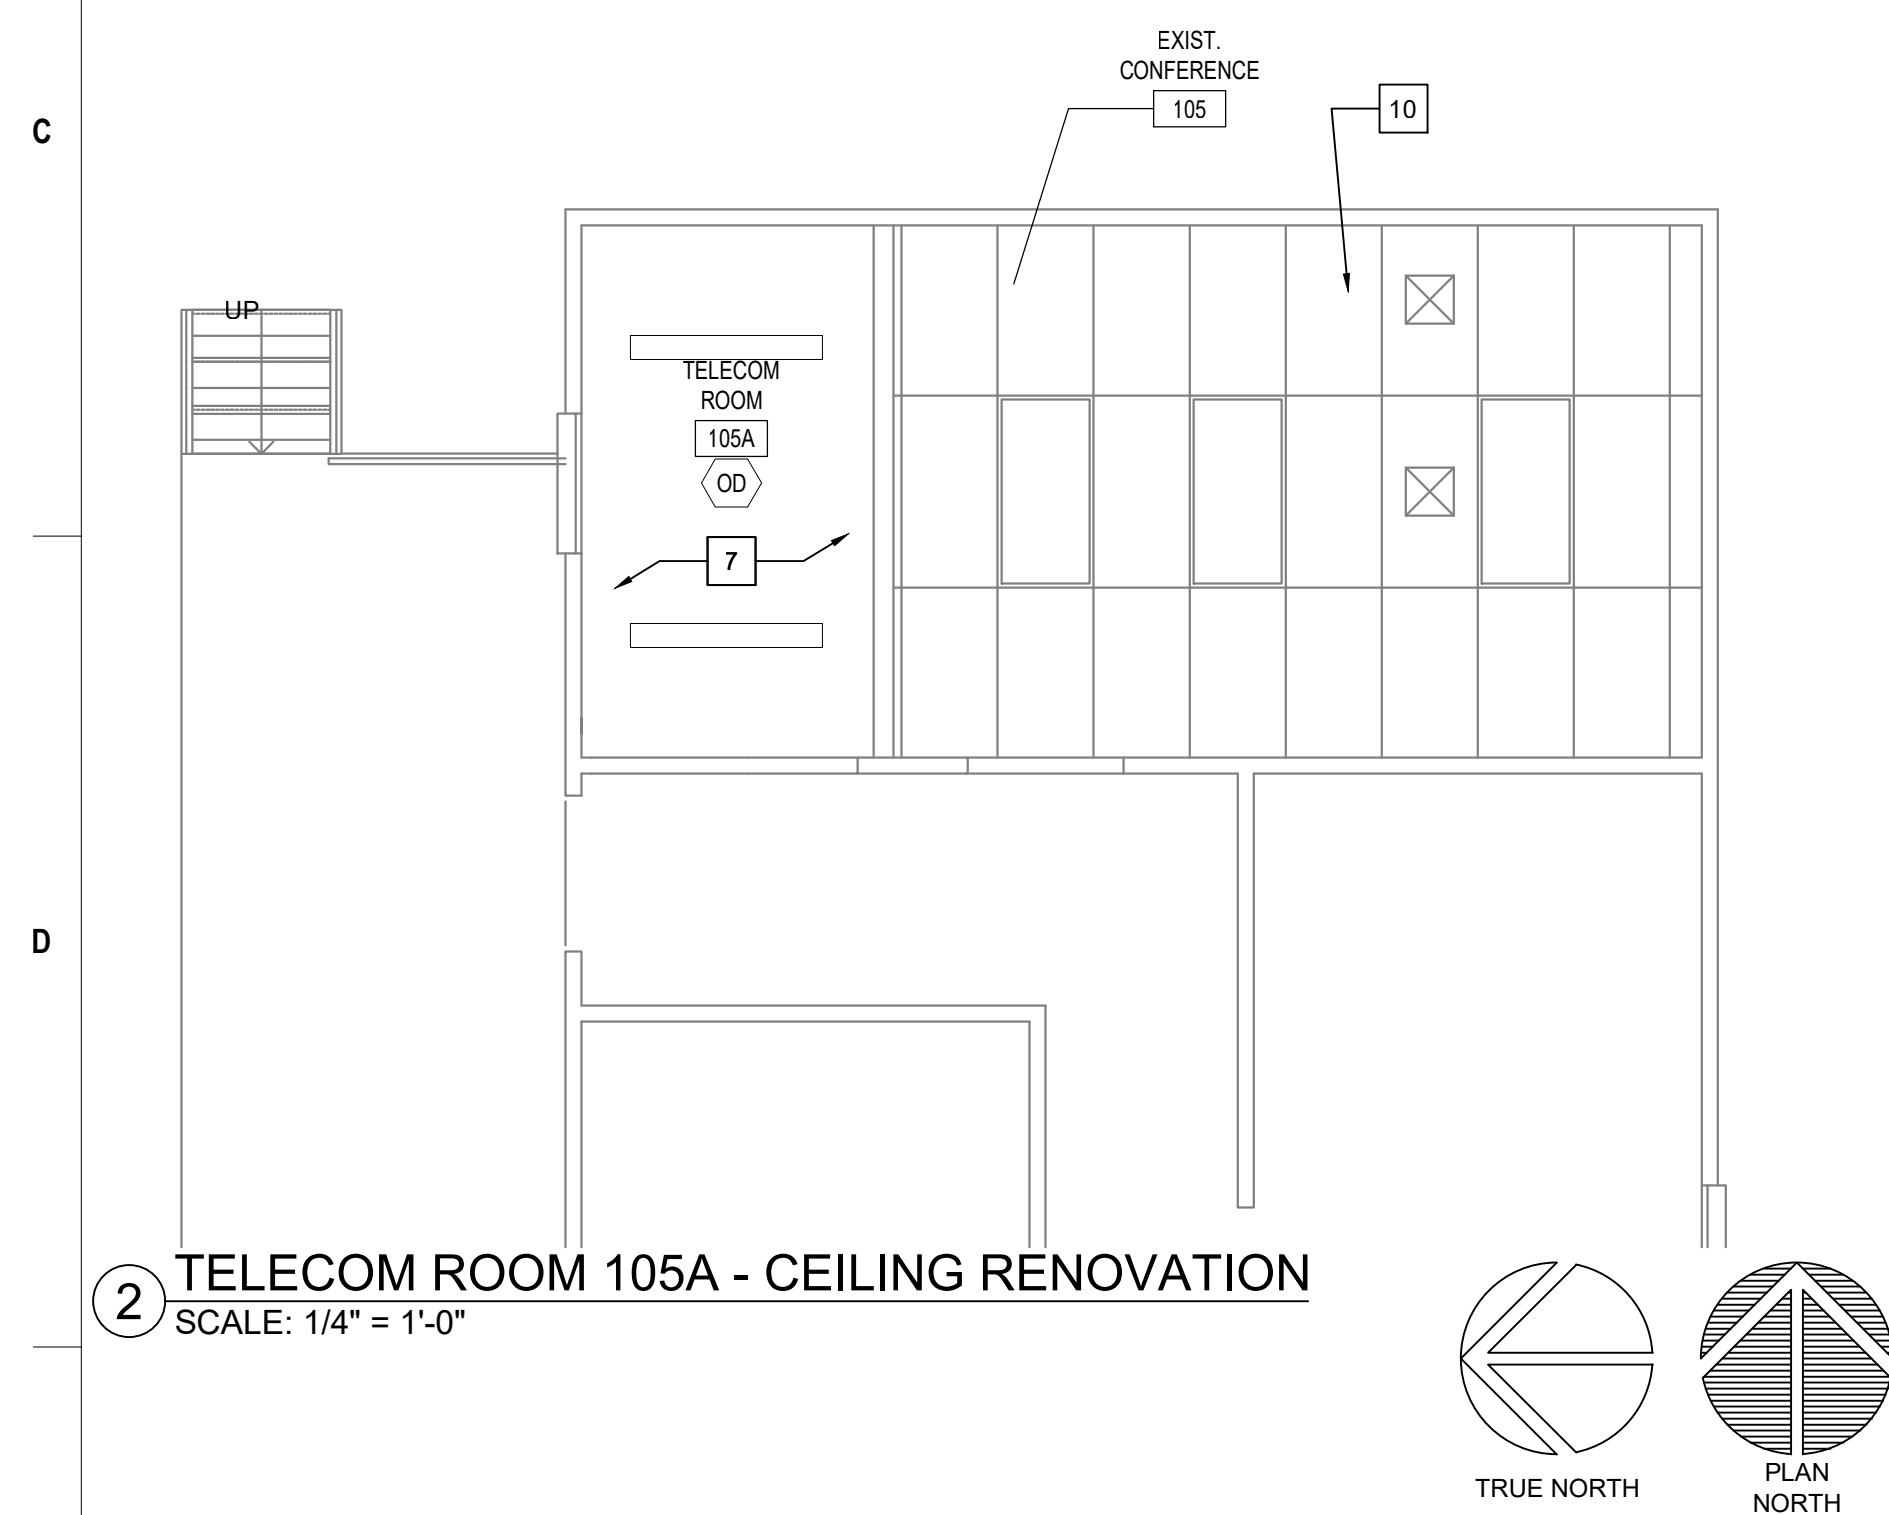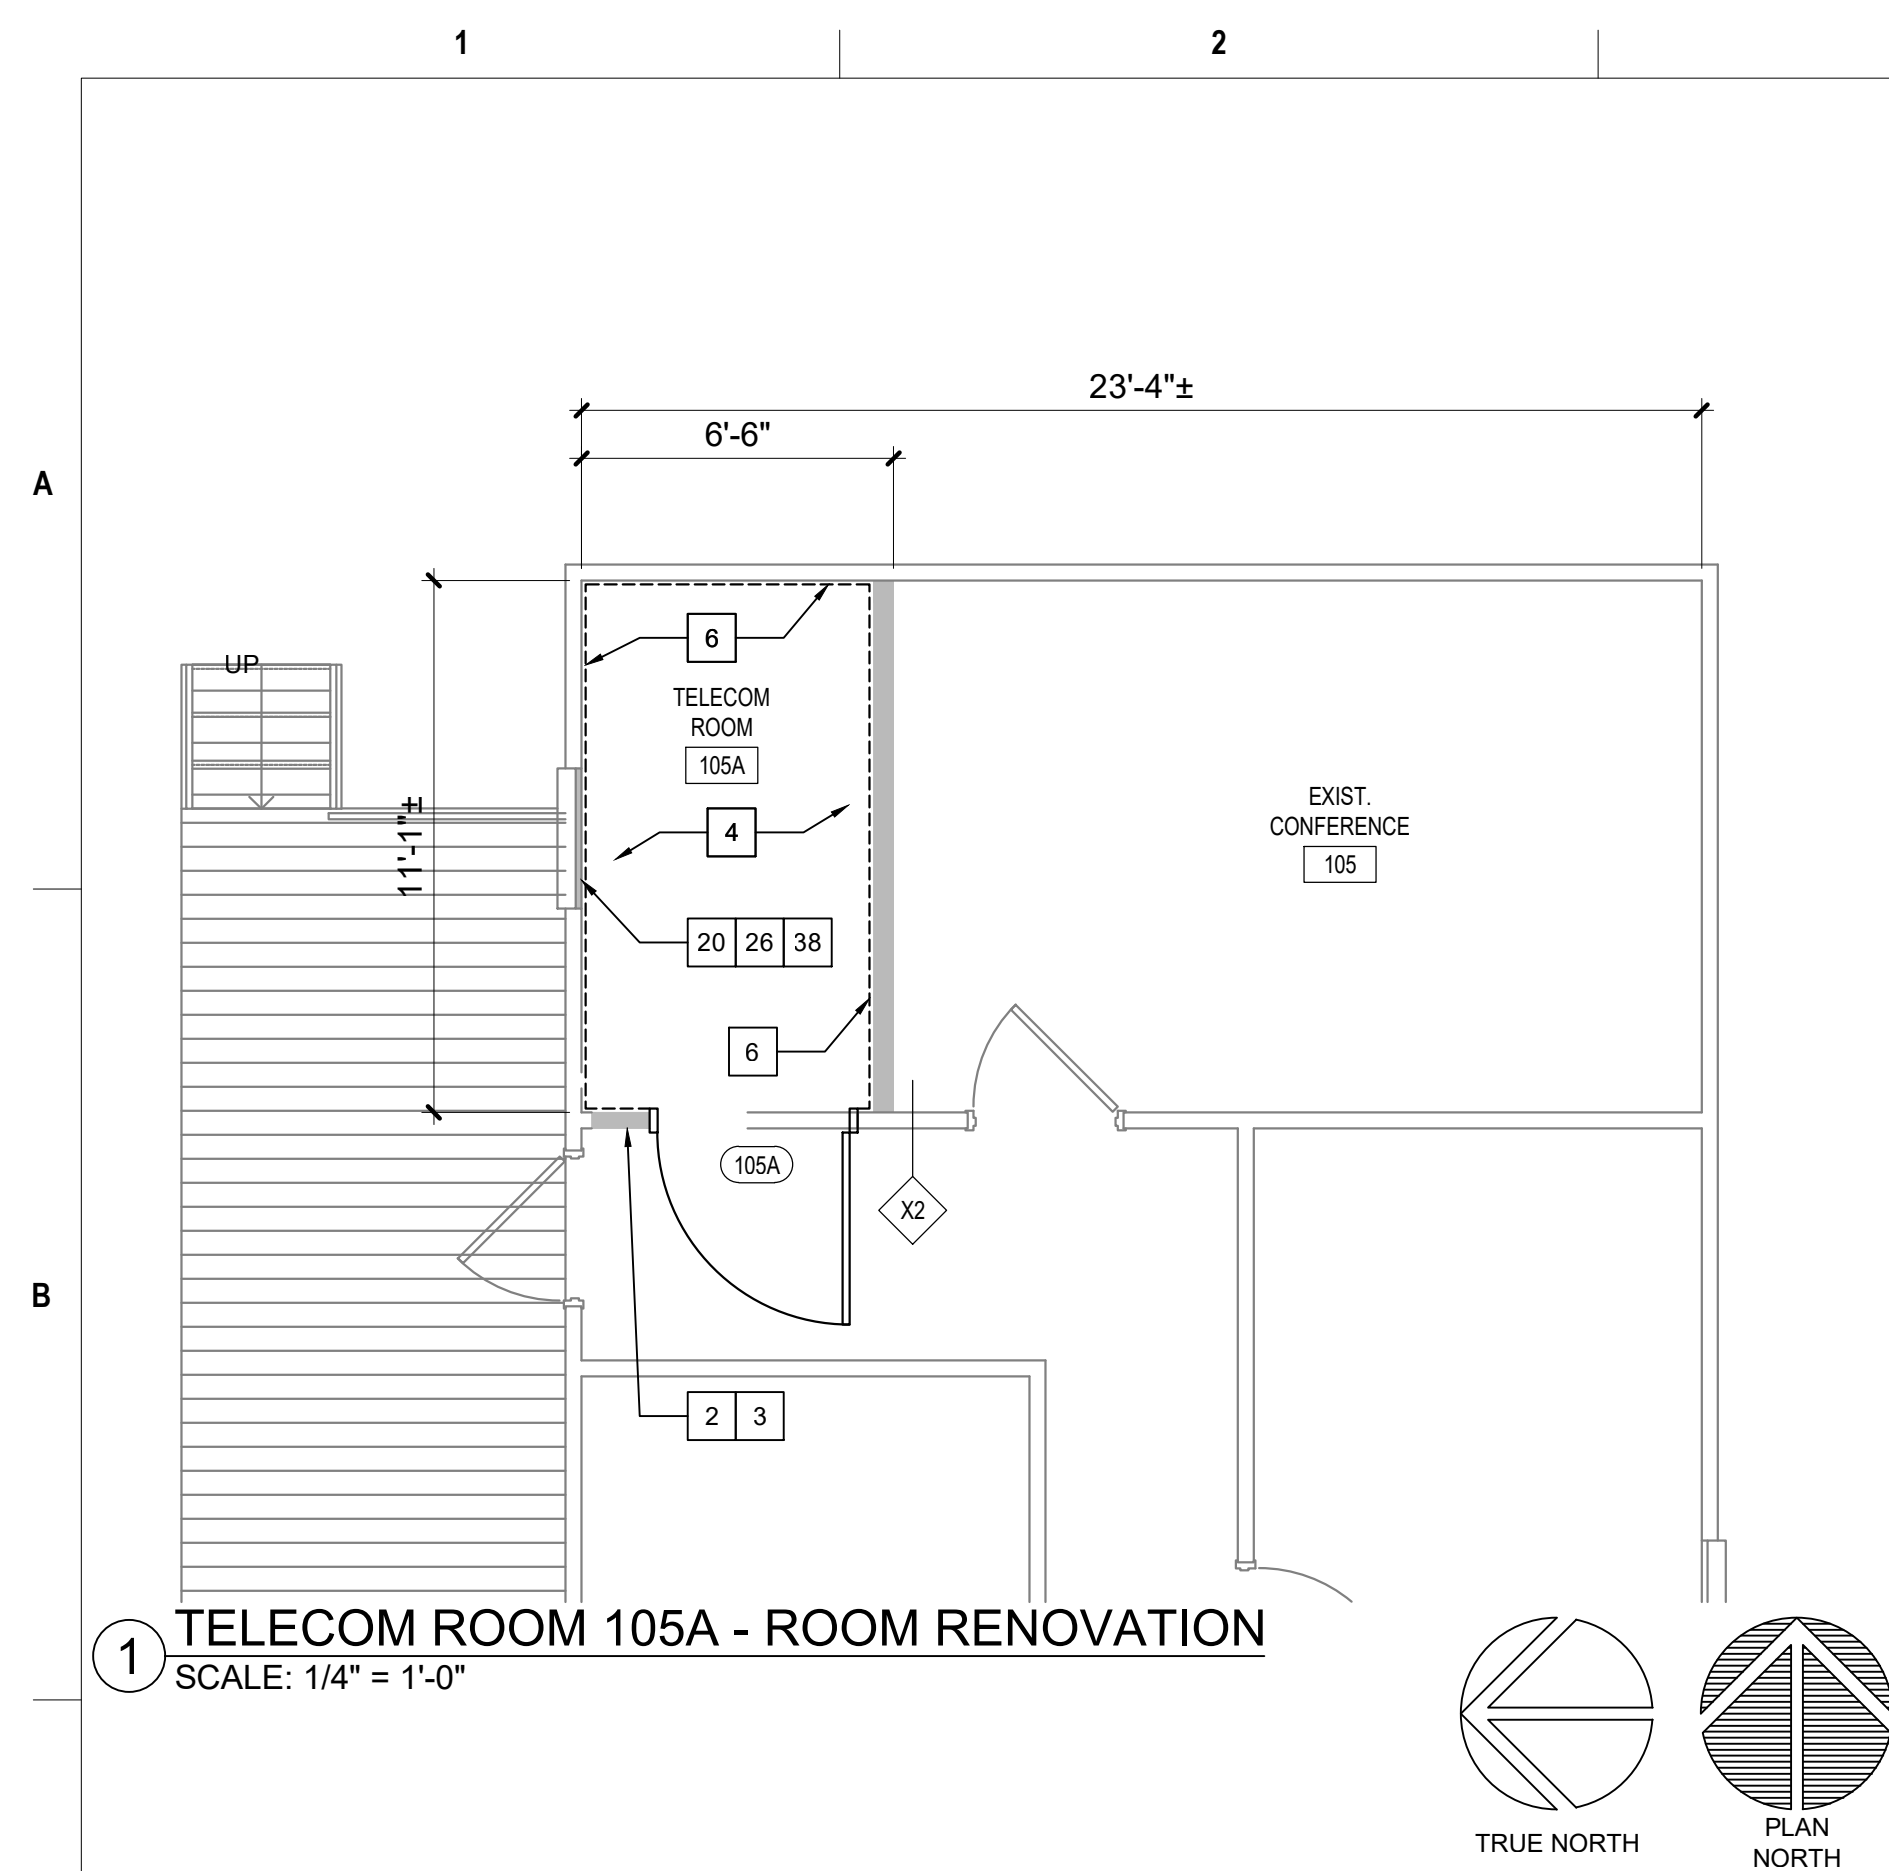





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


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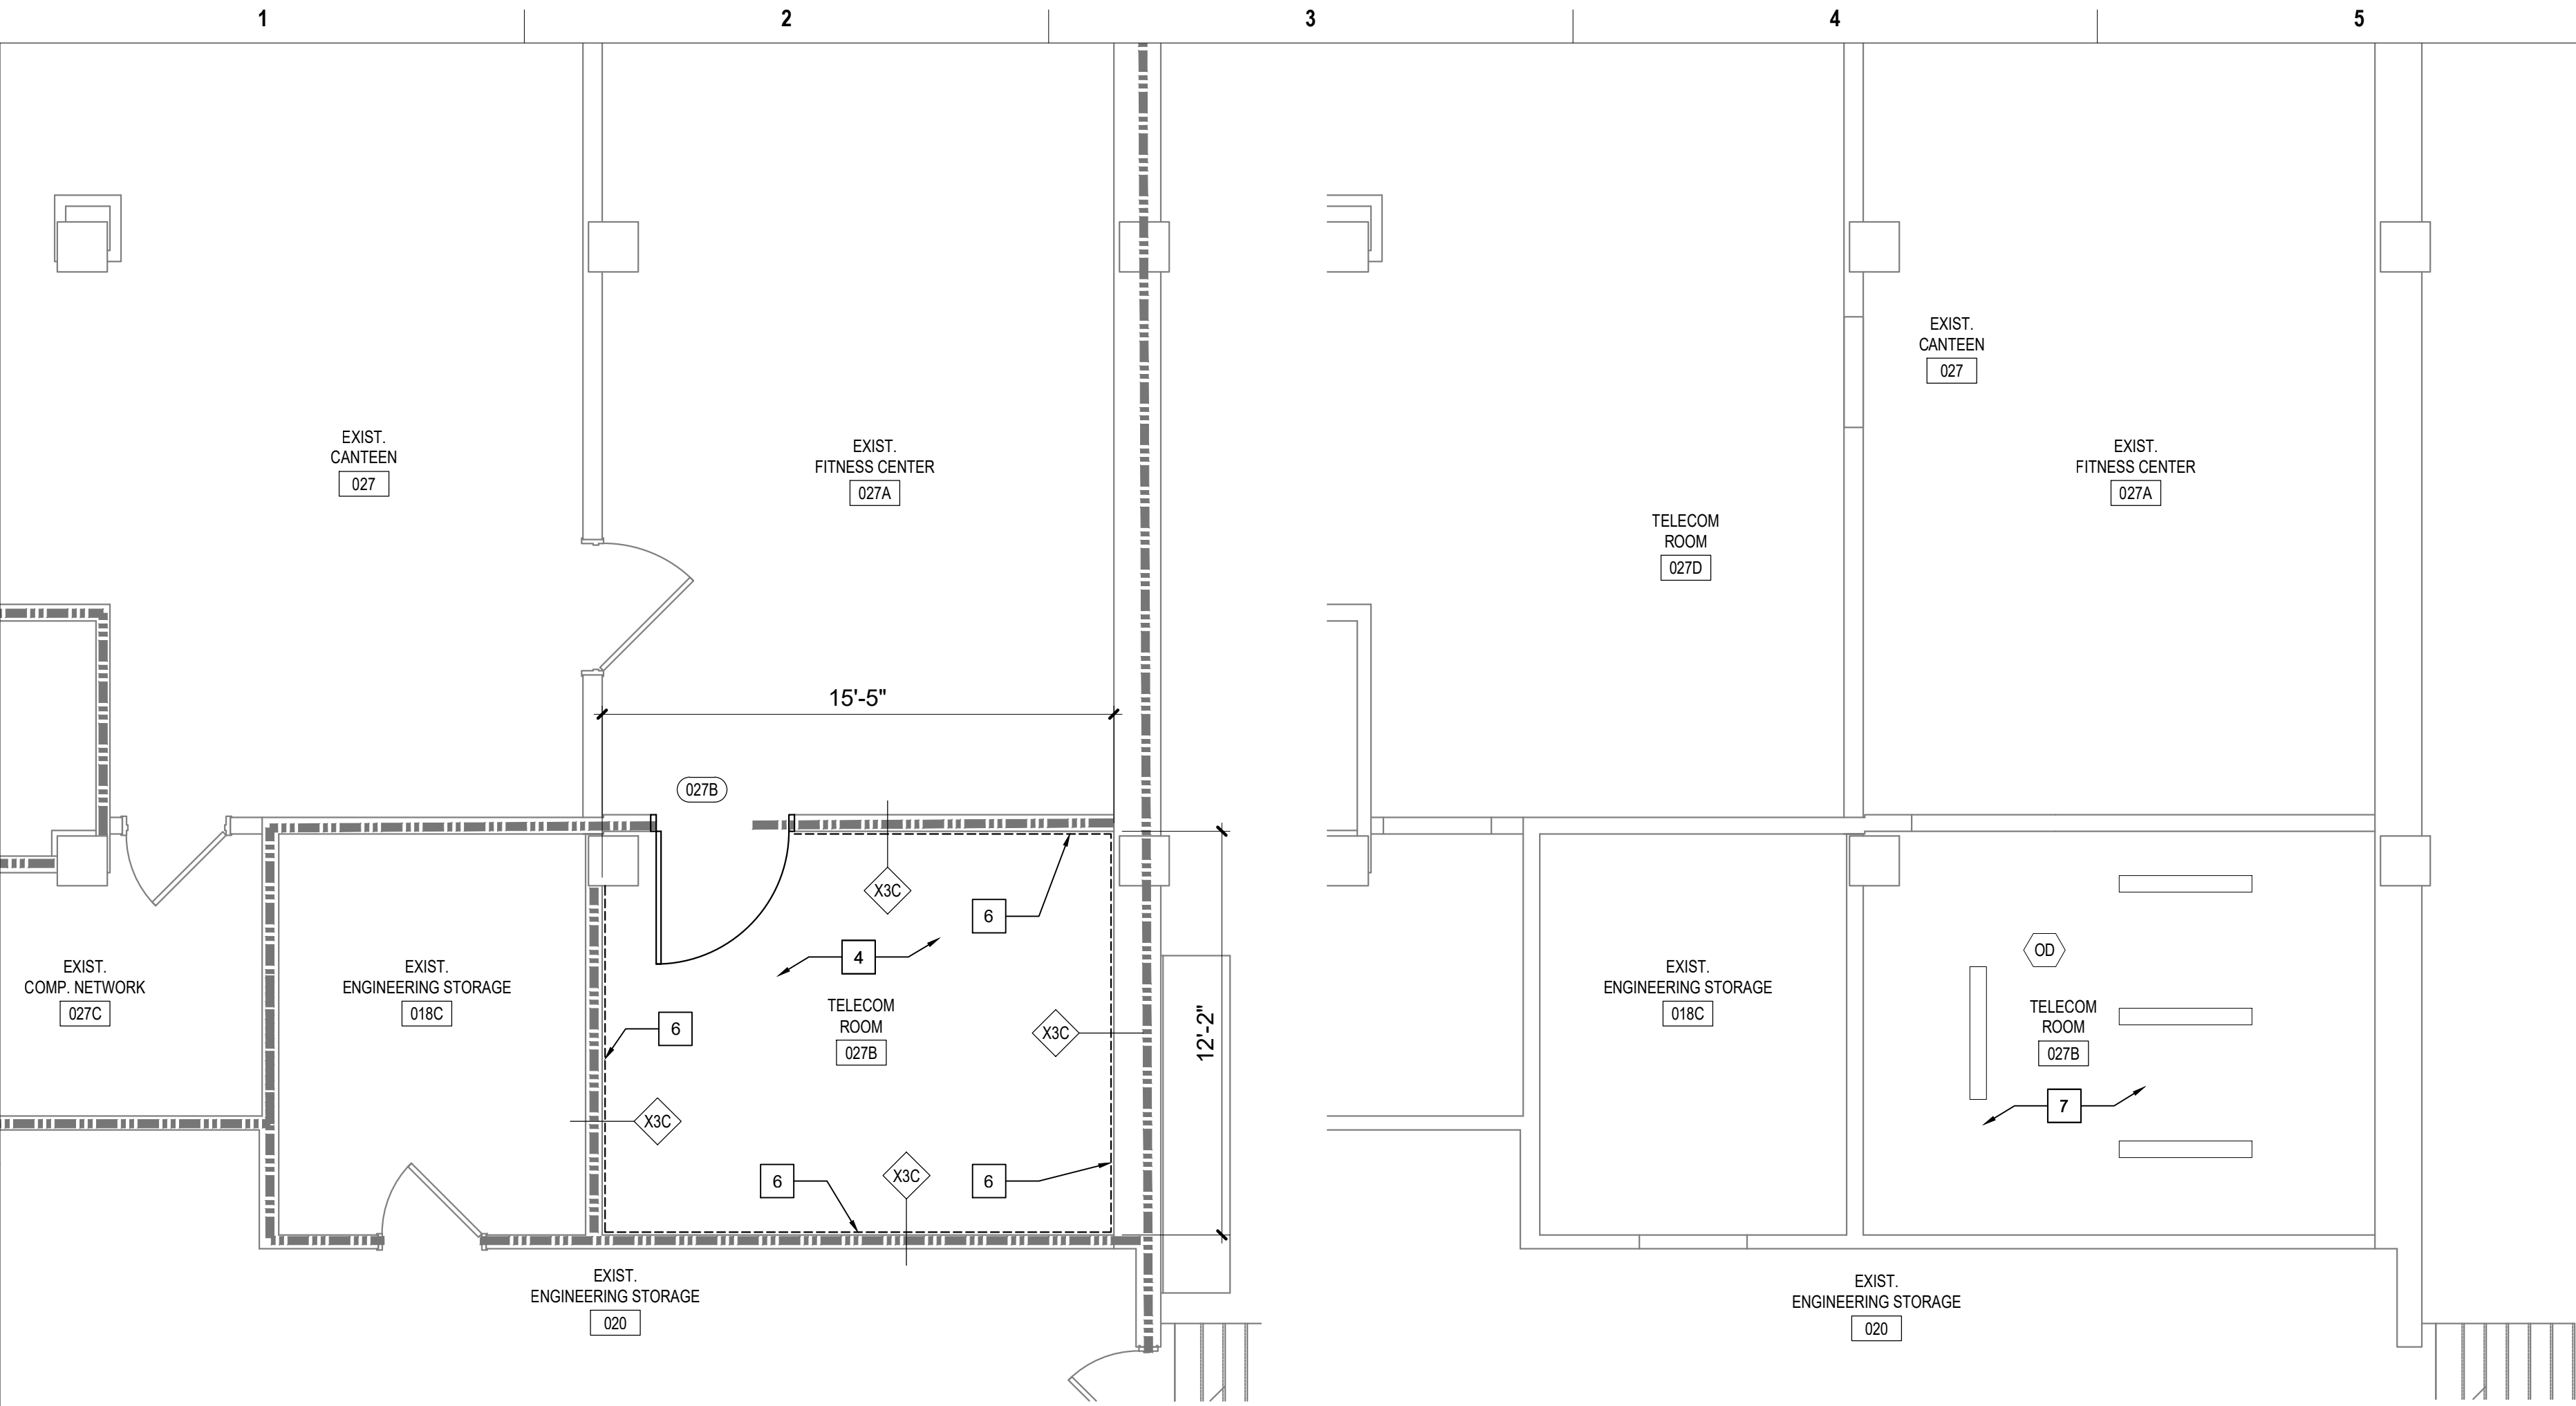


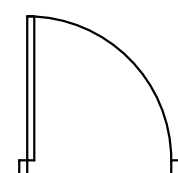


KEYED NOTES - RENOVATION		GENERAL NOTES - RENOVATION	
<div><div>1.</div><div>EXISTING DOOR/FRAME ASSEMBLY TO REMAIN.</div></div> <div><div>2.</div><div>PROVIDE CARD READER.</div></div> <div><div>3.</div><div>PROVIDE ROOM SIGNAGE.</div></div> <div><div>4.</div><div>PROVIDE NEW FLOORING AND BASE AS SCHEDULED.</div></div> <div><div>5.</div><div>REFERENCE MEP AND TECHNOLOGY DRAWINGS FOR WORK SCOPE IN THIS ROOM THAT MAY REQUIRE MINOR DEMOLITION, PATCHING AND REPAIR OF EXISTING FLOOR SUBSTRATE, WALL OR MISCELLANEOUS ASSEMBLIES.</div></div> <div><div>6.</div><div>PROVIDE 8"x4"x3/4" "AC" FACED FIRE-RATED PLYWOOD VERTICALLY ON ALL WALLS AS INDICATED. PAINT WITH 2 COATS MIN. FIRE-RATED PAINT, COORDINATE EXACT LOCATION A.F.F. WITH TECHNOLOGY AND ELECTRICAL DRAWINGS AND EXISTING CONDITIONS.</div></div> <div><div>7.</div><div>REFERENCE MEP AND TECHNOLOGY DRAWINGS FOR WORK SCOPE OF EXISTING AND NEW COMPONENTS AT CEILING LEVEL.</div></div> <div><div>8.</div><div>EXISTING FLOOR AND BASE TO REMAIN. REPAIR AS NECESSARY TO MATCH EXISTING CONDITIONS OR BETTER.</div></div> <div><div>9.</div><div>EXISTING VCT FLOORING AND RUBBER BASE TO REMAIN.</div></div> <div><div>10.</div><div>LIMITED RENOVATION TO EXISTING CEILING ASSEMBLY PER MEP AND TECHNOLOGY DRAWINGS WORK SCOPE.</div></div> <div><div>11.</div><div>RELOCATED EXISTING MARKER BOARD.</div></div> <div><div>12.</div><div>RELOCATED EXISTING MILLWORK.</div></div> <div><div>13.</div><div>CEILING FUR-DOWN ABOVE.</div></div> <div><div>14.</div><div>NEW GYPSUM BOARD/METAL STUD FRAMED FUR-DOWN TO MATCH EXISTING HEIGHT. NO JOINTS UNLESS NOTED OTHERWISE.</div></div> <div><div>15.</div><div>RELOCATED EXISTING LIGHT FIXTURE.</div></div> <div><div>16.</div><div>RELOCATED EXISTING TV MONITOR.</div></div> <div><div>17.</div><div>EXISTING ALUMINUM FLOOR AND WALL (EACH SIDE) EXPANSION JOINT COVERS TO REMAIN.</div></div> <div><div>18.</div><div>EXISTING GYPSUM BOARD/METAL STUD FRAMED FUR-DOWN TO REMAIN.</div></div> <div><div>19.</div><div>RELOCATED EXISTING FIRE EXTINGUISHER.</div></div> <div><div>20.</div><div>EXISTING EXTERIOR WINDOW TO REMAIN.</div></div> <div><div>21.</div><div>REINSTALL EXISTING SALVAGED WOOD BASE AND CHAIR RAIL. PROVIDE BALANCE OF MATERIAL AS NEEDED TO COMPLETE JOB. PAINT ALL BASE AND CHAIR RAIL IN ENTIRE ROOM.</div></div> <div><div>22.</div><div>EXISTING PLASTER ON CMU TO UNDERSIDE OF EXISTING STRUCTURE (4" OR 8" CMU PER WALL THICKNESS DEPICTED GRAPHICALLY). FIRE-RATED WALL. CONTRACTOR VERIFY.</div></div> <div><div>23.</div><div>EXISTING ROOM SIGNAGE.</div></div> <div><div>24.</div><div>EXISTING CARD READER.</div></div> <div><div>25.</div><div>REFERENCE DOOR SCHEDULE.</div></div> <div><div>26.</div><div>PAINT INTERIOR SIDE OF EXISTING WINDOW GLAZING ONLY "FLAT BLACK".</div></div> <div><div>27.</div><div>REINSTALLED EXISTING ROOM SIGNAGE.</div></div> <div><div>28.</div><div>REINSTALLED EXISTING CARD READER.</div></div> <div><div>29.</div><div>PLASTER ASSEMBLY INFILL AT EXISTING WALL AS DETAILED AT EXISTING WINDOW OPENING.</div></div> <div><div>30.</div><div>ENSURE EXISTING WALL VENT IS SECURELY CLOSED SHUT PRIOR TO COVER-UP.</div></div> <div><div>31.</div><div>PROVIDE WALL PROTECTION TO MATCH EXISTING.</div></div> <div><div>32.</div><div>PROVIDE NEW CEILING AS SCHEDULED.</div></div> <div><div>33.</div><div>PROVIDE GYPSUM BOARD/STEEL STUD FRAMED FUR-DOWN AS DETAILED.</div></div> <div><div>34.</div><div>PROVIDE 2" X 2" RAISED FLOOR SYSTEM AT 10" ABOVE THE 4TH FLOOR LEVEL.</div></div> <div><div>35.</div><div>ELECTRICAL CONDUITS AND MECHANICAL PIPING PER MEP DRAWINGS.</div></div> <div><div>36.</div><div>PROVIDE 5/8" GYPSUM BOARD WHERE EXISTING TILE WAINSCOT AND SUBSTRATE WAS REMOVED. TEXTURE AND FINISH TO MATCH EXISTING ADJACENT WALLS (4'-0"± HIGH, LOCATE AS INDICATED BY HEAVY LINE).</div></div> <div><div>37.</div><div>TEXTURE AND FINISH EXISTING GYPSUM BOARD SUBSTRATE TO MATCH EXISTING ADJACENT WALLS.</div></div> <div><div>38.</div><div>GYPSUM BOARD ASSEMBLY INFILL AS DETAILED AT EXISTING WINDOW OPENING.</div></div> <div><div>39.</div><div>PROVIDE INFILL PER KEYED NOTE 29 AT VOID LEFT BY HEATER REMOVED.</div></div> <div><div>40.</div><div>PROVIDE 1" THICK MINIMUM CONCRETE INFILL FLUSH WITH EXISTING CONCRETE TOPPING WHERE PORTIONS OF EXISTING CMU WALLS ARE REMOVED.</div></div> <div><div>41.</div><div>PROVIDE PAINTED WOOD CHAIR RAIL TO MATCH EXISTING.</div></div> <div><div>42.</div><div>REINSTALLED EXISTING SHELF.</div></div> <div><div>43.</div><div>PROVIDE GYPSUM BOARD/METAL STUD FRAMED CHASE FROM FLOORS ABOVE. MINIMIZE SIZE AND REFERENCE MEP DRAWINGS FOR COMPONENTS TO BE IN CHASE.</div></div> <div><div>44.</div><div>RAMP AND RAILS BY RAISED FLOOR SYSTEM MANUFACTURER.</div></div> <div><div>45.</div><div>ROOM PERIMETER WALLS TO BE FULLY SEALED TOP AND BOTTOM ON BOTH SIDES OF WALL. EXTERIOR WALL SEAL INTERIOR SIDE ONLY.</div></div>	<div><div>1.</div><div>REFERENCE GENERAL NOTES ON SHEET GI-004.</div></div> <div><div>2.</div><div>UNLESS NOTED OTHERWISE, ALL EXISTING WALLS ARE 5/8" GYPSUM BOARD/3 5/8" METAL STUD FRAMED TO UNDERSIDE OF PRIMARY BUILDING FRAMING STRUCTURE (1 HR. FIRE RATED - CONSTRUCTION SIMILAR TO U.I. DESIGN NO. U465). CONTRACTOR TO VERIFY.</div></div> <div><div>3.</div><div>UNLESS NOTED OTHERWISE, ALL EXISTING DOOR ASSEMBLIES ARE SOLID CORE WOOD DOORS/HOLLOW METAL FRAME TYPICAL (3'-0" X 7'-0").</div></div> <div><div>4.</div><div>UNLESS NOTED OTHERWISE ALL EXISTING LAY-IN CEILING ASSEMBLIES ARE 2" X 2" STANDARD GRID WITH FISSED TILES AT 8'-0" A.F.F. 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KEYED NOTES - RENOVATION (CONT.)		KEYED NOTES - RENOVATION (CONT.)	
<div><div>46.</div><div>TEMPORARY ALUMINUM RAMP BY CONTRACTOR TO BE RETURNED TO OWNER AT END OF JOB.</div></div> <div><div>47.</div><div>MODULAR BRICK INFILL ON EXTERIOR TO MATCH EXISTING. TOOTH-IN AND MATCH MORTAR.</div></div>	<div><div>46.</div><div>TEMPORARY ALUMINUM RAMP BY CONTRACTOR TO BE RETURNED TO OWNER AT END OF JOB.</div></div> <div><div>47.</div><div>MODULAR BRICK INFILL ON EXTERIOR TO MATCH EXISTING. TOOTH-IN AND MATCH MORTAR.</div></div>		
LEGEND - RENOVATION		LEGEND - RENOVATION	
<div><div></div><div>EXISTING WALL TO REMAIN</div></div> <div><div></div><div>NEW WALL CONSTRUCTION</div></div> <div><div></div><div>EXISTING DOOR/FRAME ASSEMBLY TO REMAIN</div></div> <div><div></div><div>NEW DOOR/FRAME ASSEMBLY</div></div> <div><div></div><div>EXISTING WINDOW ASSEMBLY TO REMAIN</div></div> <div><div></div><div>NEW WINDOW ASSEMBLY</div></div> <div><div></div><div>1 HR. FIRE-RATED WALL (EXISTING)</div></div> <div><div></div><div>2 HR. FIRE-RATED WALL (EXISTING)</div></div> <div><div></div><div>FIRE-RATED WALL (NEW OR EXISTING 1 HOUR UNLESS NOTED OTHERWISE)</div></div>	<div><div></div><div>EXISTING WALL TO REMAIN</div></div> <div><div></div><div>NEW WALL CONSTRUCTION</div></div> <div><div></div><div>EXISTING DOOR/FRAME ASSEMBLY TO REMAIN</div></div> <div><div></div><div>NEW DOOR/FRAME ASSEMBLY</div></div> <div><div></div><div>EXISTING WINDOW ASSEMBLY TO REMAIN</div></div> <div><div></div><div>NEW WINDOW ASSEMBLY</div></div> <div><div></div><div>1 HR. FIRE-RATED WALL (EXISTING)</div></div> <div><div></div><div>2 HR. FIRE-RATED WALL (EXISTING)</div></div> <div><div></div><div>FIRE-RATED WALL (NEW OR EXISTING 1 HOUR UNLESS NOTED OTHERWISE)</div></div>		

Revisions:		Date:	CONSULTANT		PROJECT MANAGEMENT			Construction and Facilities Management		Drawing Title ENLARGED FLOOR PLANS - 1ST FLOOR RENOVATION		Phase 100% CONSTRUCTION DOCUMENTS		Project Title CINCINNATI VAMC EHRM INFRASTRUCTURE UPGRADES		Project Number 539-21-701	
			 C O M P A N Y 8718 Botts Lane Phone: (210) 816-4784 San Antonio, Texas 78217 Fax: (210) 881-6808 www.hfscompany.com jbianco@hfscompany.com		 C O M P A N Y 8718 Botts Lane Phone: (210) 816-4784 San Antonio, Texas 78217 Fax: (210) 881-6808 www.hfscompany.com jbianco@hfscompany.com			VA U.S. Department of Veterans Affairs		Approved: Project Director		FULLY SPRINKLERED		Location 3200 VINE ST., CINCINNATI, OH		Building Number C TE	
							5/4/22							Issue Date 4-MAY-2022		Drawing Number AS-500-C.TE.1	
														Checked		Drawn IAR	






1 TELECOM ROOM 027B - ROOM RENOVATION  
SCALE: 1/4" = 1'-0"

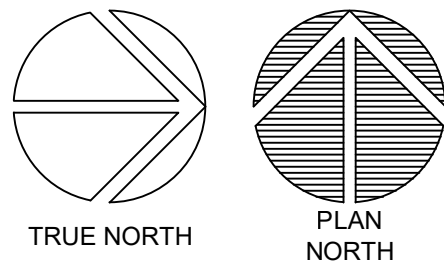

2 TELECOM ROOM 027B - CEILING RENOVATION  
SCALE: 1/4" = 1'-0"

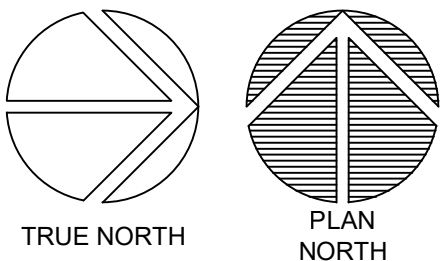

KEYED NOTES - RENOVATION

- EXISTING DOOR/FRAME ASSEMBLY TO REMAIN.
- PROVIDE CARD READER.
- PROVIDE ROOM SIGNAGE.
- PROVIDE NEW FLOORING AND BASE AS SCHEDULED.
- REFERENCE MEP AND TECHNOLOGY DRAWINGS FOR WORK SCOPE IN THIS ROOM THAT MAY REQUIRE MINOR DEMOLITION, PATCHING AND REPAIR OF EXISTING FLOOR SUBSTRATE, WALL OR MISCELLANEOUS ASSEMBLIES.
- PROVIDE 8"x4"x3/4" AC FACED FIRE-RATED PLYWOOD VERTICALLY ON ALL WALLS AS INDICATED. PAINT WITH 2 COATS MIN. FIRE-RATED PAINT. COORDINATE EXACT LOCATION A.F.F. WITH TECHNOLOGY AND ELECTRICAL DRAWINGS AND EXISTING CONDITIONS.
- REFERENCE MEP AND TECHNOLOGY DRAWINGS FOR WORK SCOPE OF EXISTING AND NEW COMPONENTS AT CEILING LEVEL.
- EXISTING FLOOR AND BASE TO REMAIN. REPAIR AS NECESSARY TO MATCH EXISTING CONDITIONS OR BETTER.
- EXISTING VCT FLOORING AND RUBBER BASE TO REMAIN.
- LIMITED RENOVATION TO EXISTING CEILING ASSEMBLY PER MEP AND TECHNOLOGY DRAWINGS WORK SCOPE.
- RELOCATED EXISTING MARKER BOARD.
- RELOCATED EXISTING MILLWORK.
- CEILING FUR-DOWN ABOVE.
- NEW GYPSUM BOARD/METAL STUD FRAMED FUR-DOWN TO MATCH EXISTING HEIGHT. NO JOINTS UNLESS NOTED OTHERWISE.
- RELOCATED EXISTING LIGHT FIXTURE.
- RELOCATED EXISTING TV MONITOR.
- EXISTING ALUMINUM FLOOR AND WALL (EACH SIDE) EXPANSION JOINT COVERS TO REMAIN.
- EXISTING GYPSUM BOARD/METAL STUD FRAMED FUR-DOWN TO REMAIN.
- RELOCATED EXISTING FIRE EXTINGUISHER.
- EXISTING EXTERIOR WINDOW TO REMAIN.
- REINSTALL EXISTING SALVAGED WOOD BASE AND CHAIR RAIL. PROVIDE BALANCE OF MATERIAL AS NEEDED TO COMPLETE JOB. PAINT ALL BASE AND CHAIR RAIL IN ENTIRE ROOM.
- EXISTING PLASTER ON CMU TO UNDERSIDE OF EXISTING STRUCTURE (4" OR 8" CMU PER WALL THICKNESS DEPICTED GRAPHICALLY). FIRE-RATED WALL. CONTRACTOR VERIFY.
- EXISTING ROOM SIGNAGE.
- EXISTING CARD READER.
- REFERENCE DOOR SCHEDULE.
- PAINT INTERIOR SIDE OF EXISTING WINDOW GLAZING ONLY "FLAT BLACK".
- REINSTALLED EXISTING ROOM SIGNAGE.
- REINSTALLED EXISTING CARD READER.
- PLASTER ASSEMBLY INFILL AT EXISTING WALL AS DETAILED AT EXISTING WINDOW OPENING.
- ENSURE EXISTING WALL VENT IS SECURELY CLOSED SHUT PRIOR TO COVER-UP.
- PROVIDE WALL PROTECTION TO MATCH EXISTING.
- PROVIDE NEW CEILING AS SCHEDULED.
- PROVIDE GYPSUM BOARD/STEEL STUD FRAMED FUR-DOWN AS DETAILED.
- PROVIDE 2' X 2' RAISED FLOOR SYSTEM AT 10" ABOVE THE 4TH FLOOR LEVEL.
- ELECTRICAL CONDUITS AND MECHANICAL PIPING PER MEP DRAWINGS.
- PROVIDE 5/8" GYPSUM BOARD WHERE EXISTING TILE WAINSCOT AND SUBSTRATE WAS REMOVED. TEXTURE AND FINISH TO MATCH EXISTING ADJACENT WALLS (4'-0"± HIGH, LOCATE AS INDICATED BY HEAVY LINE).
- TEXTURE AND FINISH EXISTING GYPSUM BOARD SUBSTRATE TO MATCH EXISTING ADJACENT WALLS.
- GYPSUM BOARD ASSEMBLY INFILL AS DETAILED AT EXISTING WINDOW OPENING.
- PROVIDE INFILL PER KEYED NOTE 29 AT VOID LEFT BY HEATER REMOVED.
- PROVIDE 1" THICK MINIMUM CONCRETE INFILL FLUSH WITH EXISTING CONCRETE TOPPING WHERE PORTIONS OF EXISTING CMU WALLS ARE REMOVED.
- PROVIDE PAINTED WOOD CHAIR RAIL TO MATCH EXISTING.
- REINSTALLED EXISTING SHELF.
- PROVIDE GYPSUM BOARD/METAL STUD FRAMED CHASE FROM FLOORS ABOVE. MINIMIZE SIZE AND REFERENCE MEP DRAWINGS FOR COMPONENTS TO BE IN CHASE.
- RAMP AND RAILS BY RAISED FLOOR SYSTEM MANUFACTURER.
- ROOM PERIMETER WALLS TO BE FULLY SEALED TOP AND BOTTOM ON BOTH SIDES OF WALL. EXTERIOR WALL SEAL INTERIOR SIDE ONLY.

GENERAL NOTES - RENOVATION

- REFERENCE GENERAL NOTES ON SHEET GI-004.
- UNLESS NOTED OTHERWISE, ALL EXISTING WALLS ARE 5/8" GYPSUM BOARD/3 5/8" METAL STUD FRAMED TO UNDERSIDE OF PRIMARY BUILDING FRAMING STRUCTURE (1 HR. FIRE RATED - CONSTRUCTION SIMILAR TO U.I. DESIGN NO. U465). CONTRACTOR TO VERIFY.
- UNLESS NOTED OTHERWISE, ALL EXISTING DOOR ASSEMBLIES ARE SOLID CORE WOOD DOORS/HOLLOW METAL FRAME TYPICAL (3'-0" X 7'-0").
- UNLESS NOTED OTHERWISE ALL EXISTING LAY-IN CEILING ASSEMBLIES ARE 2' X 2' STANDARD GRID WITH FISSURED TILES AT 8'-0" A.F.F. TYPICAL.
- UNLESS NOTED OTHERWISE, ALL EXISTING STEEL COLUMN FUR-OUTS ARE GYPSUM BOARD/METAL STUD FRAMED TYPICAL.
- PARTIAL OR ENTIRE RECONSTRUCTION OF SOME EXISTING CEILING ASSEMBLIES THROUGHOUT THE ENTIRE BUILDING(S), ESPECIALLY IN CORRIDORS, WILL BE NECESSARY. REFERENCE ALL DISCIPLINE DEMOLITION DRAWINGS. RECONSTRUCTION IS TO INCLUDE MISCELLANEOUS PATCHING /REPAIR TO MATCH EXISTING OR BETTER CONDITIONS.
- EXISTING FIRE-RATED WALL IDENTIFICATION INDICATED ONLY FOR IMMEDIATE AFFECTED ROOM WALLS. CONTRACTOR SHALL VERIFY FULL EXTENT OF EXISTING FIRE-RATED WALLS AT ADJACENT AREAS.
- ALL NEW WALLS SHALL BE PARTITION TYPE "1" UNLESS OTHERWISE NOTED.
- UNLESS NOTED OTHERWISE AT ALL ROOMS WHERE EXISTING LAY-IN CEILING IS REMOVED AND IS TO BECOME A "NO CEILING" ROOM, THE EXISTING GYPSUM BOARD ABOVE PREVIOUSLY REMOVED CEILING IS TO BE FULLY TAPED, FLOATED, TEXTURED AND PAINTED TO MATCH EXISTING WALLS.

KEYED NOTES - RENOVATION (CONT.)

- TEMPORARY ALUMINUM RAMP BY CONTRACTOR TO BE RETURNED TO OWNER AT END OF JOB.
- MODULAR BRICK INFILL ON EXTERIOR TO MATCH EXISTING. TOOTH-IN AND MATCH MORTAR.

LEGEND - RENOVATION

- EXISTING WALL TO REMAIN
- NEW WALL CONSTRUCTION
- EXISTING DOOR/FRAME ASSEMBLY TO REMAIN
- NEW DOOR/FRAME ASSEMBLY
- EXISTING WINDOW ASSEMBLY TO REMAIN
- NEW WINDOW ASSEMBLY
- 1 HR. FIRE-RATED WALL (EXISTING)
- 2 HR. FIRE-RATED WALL (EXISTING)
- FIRE-RATED WALL (NEW OR EXISTING 1 HOUR UNLESS NOTED OTHERWISE)

Revisions:	Date:

CONSULTANT

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PROJECT MANAGEMENT

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Construction  
and Facilities  
Management

**VA** U.S. Department  
of Veterans Affairs

Drawing Title  
**ENLARGED FLOOR PLANS -  
BASEMENT FLOOR RENOVATION**  
Approved: Project Director

Phase  
**100% CONSTRUCTION  
DOCUMENTS**

**FULLY SPRINKLERED**


Project Title  
**CINCINNATI VAMC EHRM  
INFRASTRUCTURE UPGRADES**

Location  
3200 VINE ST., CINCINNATI, OH  
Issue Date  
4-MAY-2022  
Checked  
Drawn  
JAR

Project Number  
539-21-701  
Building Number  
FT64

Drawing Number  
**AS-510-FT.64.B**



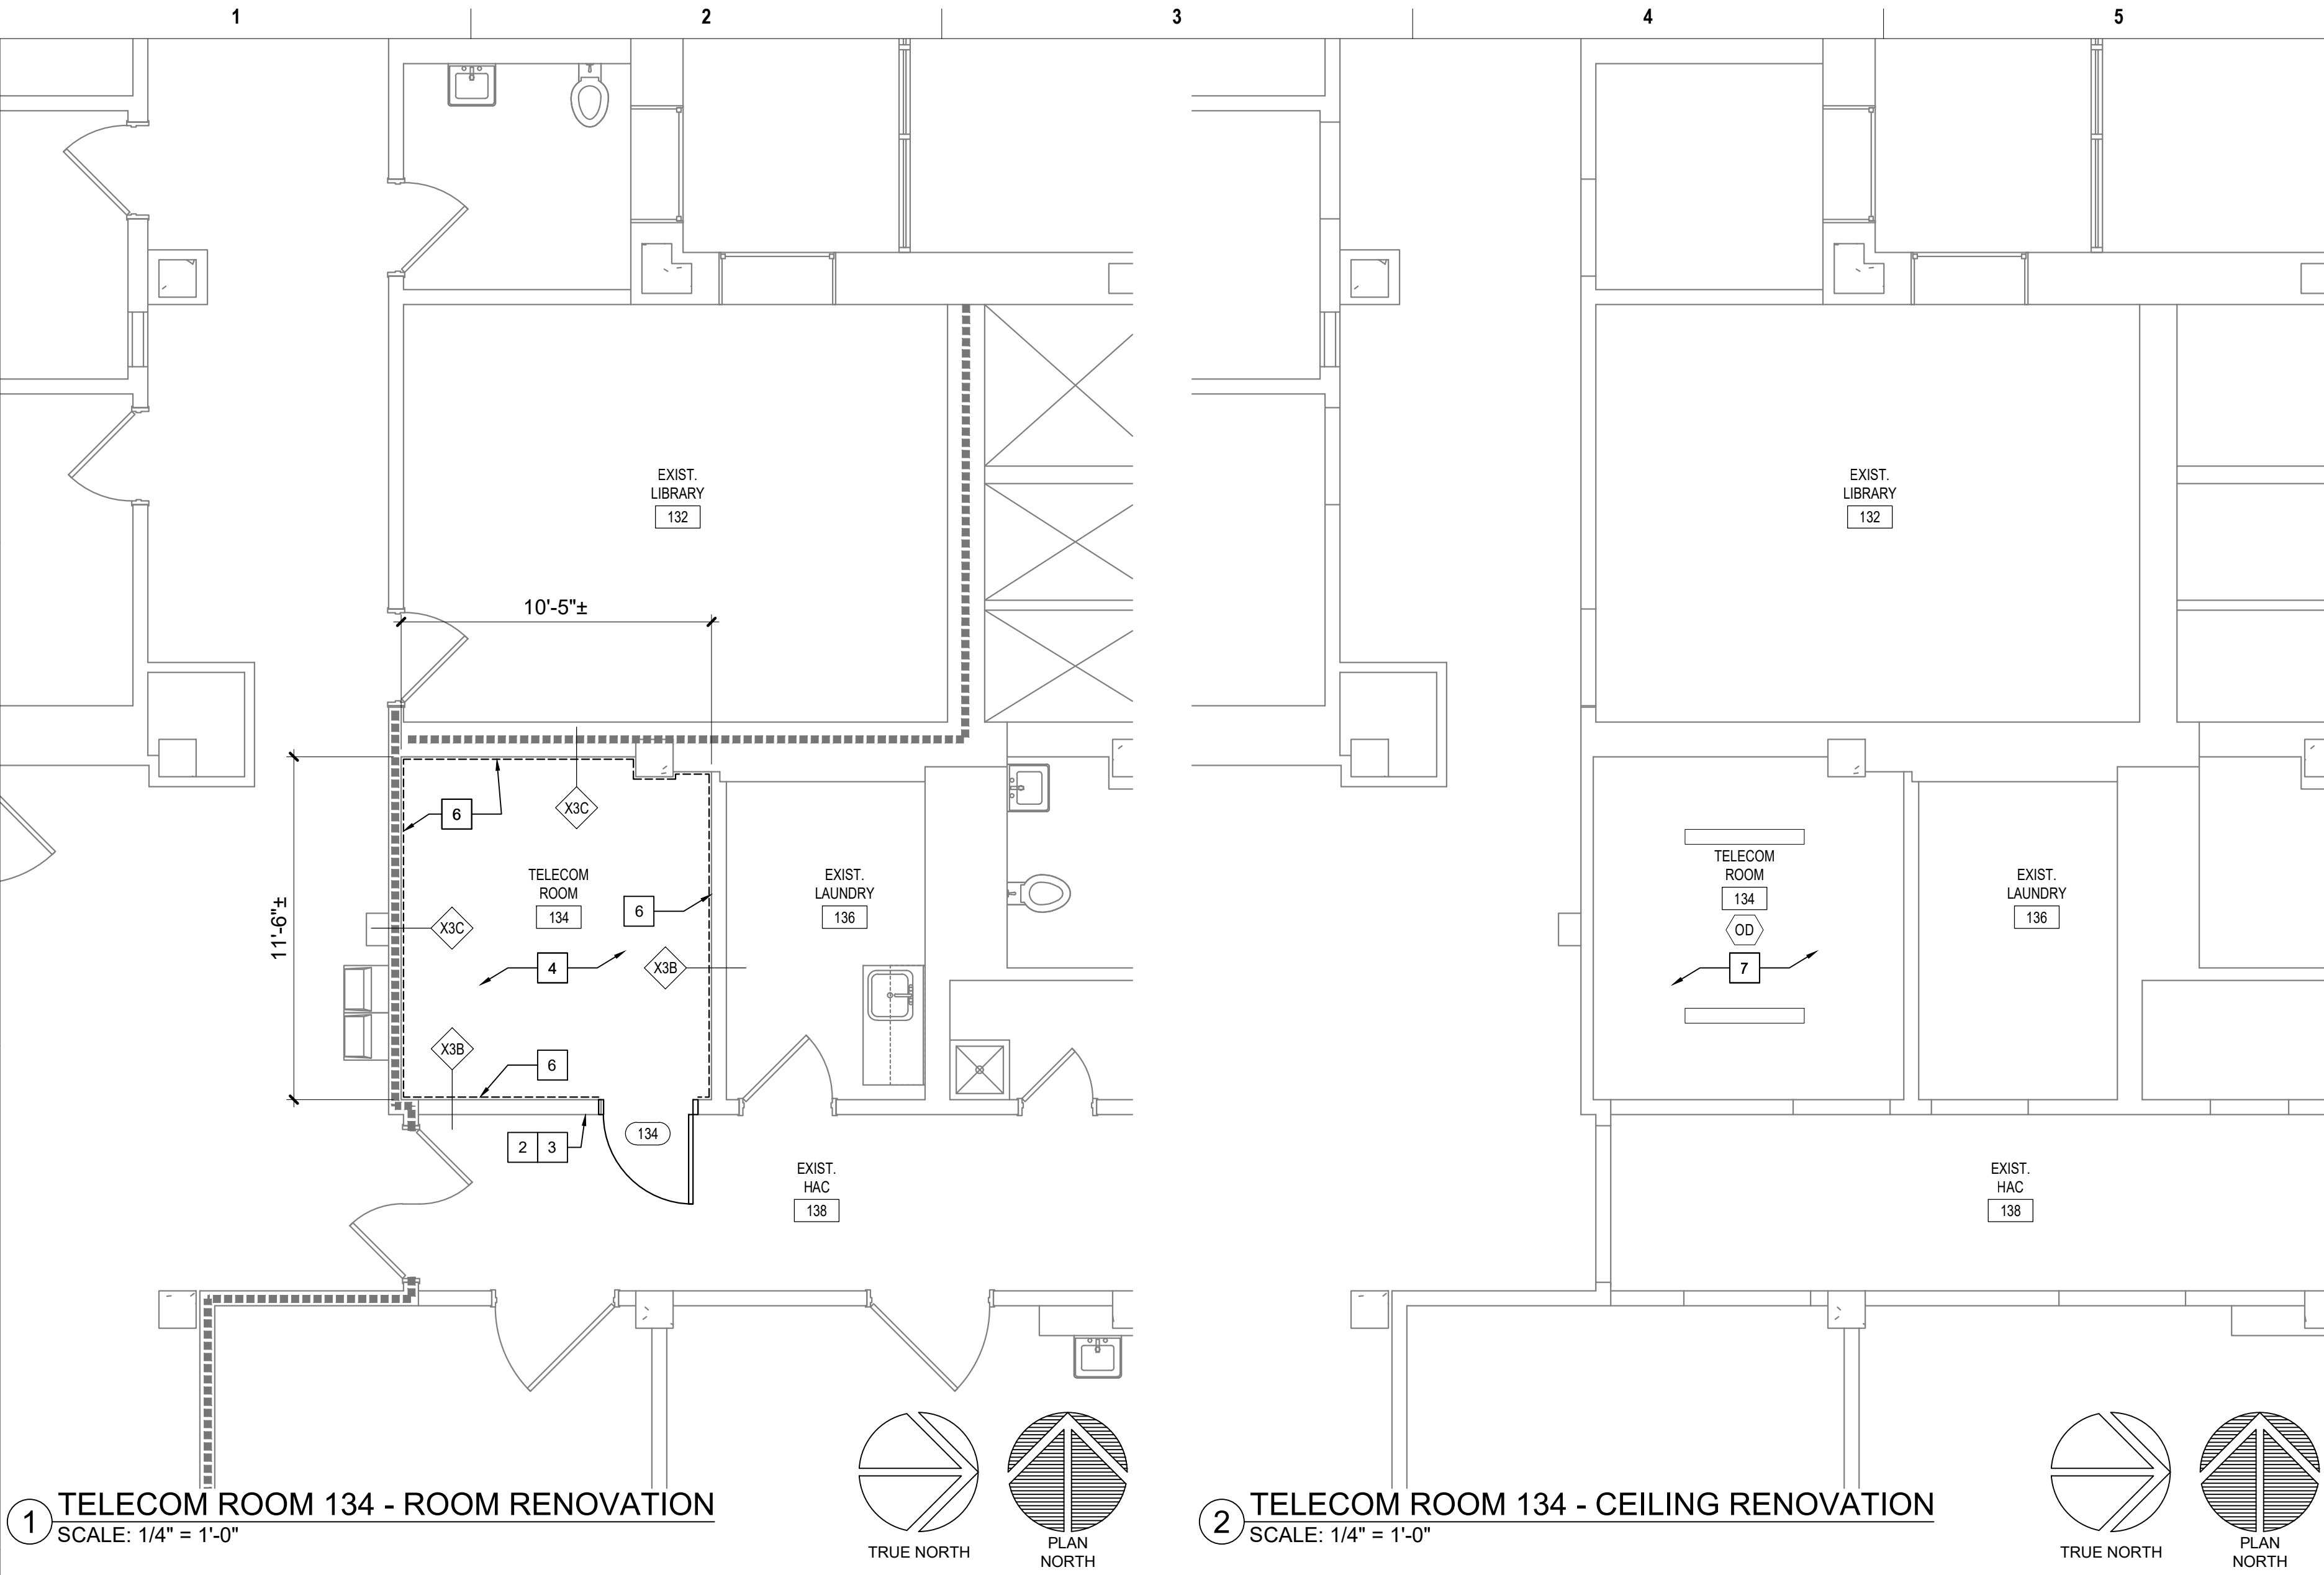

KEYED NOTES - RENOVATION

- EXISTING DOOR/FRAME ASSEMBLY TO REMAIN.
- PROVIDE CARD READER.
- PROVIDE ROOM SIGNAGE.
- PROVIDE NEW FLOORING AND BASE AS SCHEDULED.
- REFERENCE MEP AND TECHNOLOGY DRAWINGS FOR WORK SCOPE IN THIS ROOM THAT MAY REQUIRE MINOR DEMOLITION, PATCHING AND REPAIR OF EXISTING FLOOR SUBSTRATE, WALL OR MISCELLANEOUS ASSEMBLIES.
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- PROVIDE PAINTED WOOD CHAIR RAIL TO MATCH EXISTING.
- REINSTALLED EXISTING SHELF.
- PROVIDE GYPSUM BOARD/METAL STUD FRAMED CHASE FROM FLOORS ABOVE. MINIMIZE SIZE AND REFERENCE MEP DRAWINGS FOR COMPONENTS TO BE IN CHASE.
- RAMP AND RAILS BY RAISED FLOOR SYSTEM MANUFACTURER.
- ROOM PERIMETER WALLS TO BE FULLY SEALED TOP AND BOTTOM ON BOTH SIDES OF WALL. EXTERIOR WALL SEAL INTERIOR SIDE ONLY.

GENERAL NOTES - RENOVATION

- REFERENCE GENERAL NOTES ON SHEET GI-004.
- UNLESS NOTED OTHERWISE, ALL EXISTING WALLS ARE 5/8" GYPSUM BOARD/3 5/8" METAL STUD FRAMED TO UNDERSIDE OF PRIMARY BUILDING FRAMING STRUCTURE (1 HR. FIRE RATED - CONSTRUCTION SIMILAR TO U.I. DESIGN NO. U465). CONTRACTOR TO VERIFY.
- UNLESS NOTED OTHERWISE, ALL EXISTING DOOR ASSEMBLIES ARE SOLID CORE WOOD DOORS/HOLLOW METAL FRAME TYPICAL (3'-0" X 7'-0").
- UNLESS NOTED OTHERWISE ALL EXISTING LAY-IN CEILING ASSEMBLIES ARE 2' X 2' STANDARD GRID WITH FISSURED TILES AT 8'-0" A.F.F. TYPICAL.
- UNLESS NOTED OTHERWISE, ALL EXISTING STEEL COLUMN FUR-OUTS ARE GYPSUM BOARD/METAL STUD FRAMED TYPICAL.
- PARTIAL OR ENTIRE RECONSTRUCTION OF SOME EXISTING CEILING ASSEMBLIES THROUGHOUT THE ENTIRE BUILDING(S), ESPECIALLY IN CORRIDORS, WILL BE NECESSARY. REFERENCE ALL DISCIPLINE DEMOLITION DRAWINGS. RECONSTRUCTION IS TO INCLUDE MISCELLANEOUS PATCHING /REPAIR TO MATCH EXISTING OR BETTER CONDITIONS.
- EXISTING FIRE-RATED WALL IDENTIFICATION INDICATED ONLY FOR IMMEDIATE AFFECTED ROOM WALLS. CONTRACTOR SHALL VERIFY FULL EXTENT OF EXISTING FIRE-RATED WALLS AT ADJACENT AREAS.
- ALL NEW WALLS SHALL BE PARTITION TYPE "1" UNLESS OTHERWISE NOTED.
- UNLESS NOTED OTHERWISE AT ALL ROOMS WHERE EXISTING LAY-IN CEILING IS REMOVED AND IS TO BECOME A "NO CEILING" ROOM, THE EXISTING GYPSUM BOARD ABOVE PREVIOUSLY REMOVED CEILING IS TO BE FULLY TAPED, FLOATED, TEXTURED AND PAINTED TO MATCH EXISTING WALLS.

KEYED NOTES - RENOVATION (CONT.)

- TEMPORARY ALUMINUM RAMP BY CONTRACTOR TO BE RETURNED TO OWNER AT END OF JOB.
- MODULAR BRICK INFILL ON EXTERIOR TO MATCH EXISTING. TOOTH-IN AND MATCH MORTAR.

LEGEND - RENOVATION

- EXISTING WALL TO REMAIN
- NEW WALL CONSTRUCTION
- EXISTING DOOR/FRAME ASSEMBLY TO REMAIN
- NEW DOOR/FRAME ASSEMBLY
- EXISTING WINDOW ASSEMBLY TO REMAIN
- NEW WINDOW ASSEMBLY
- 1 HR. FIRE-RATED WALL (EXISTING)
- 2 HR. FIRE-RATED WALL (EXISTING)
- FIRE-RATED WALL (NEW OR EXISTING 1 HOUR UNLESS NOTED OTHERWISE)

Revisions:	Date:

CONSULTANT

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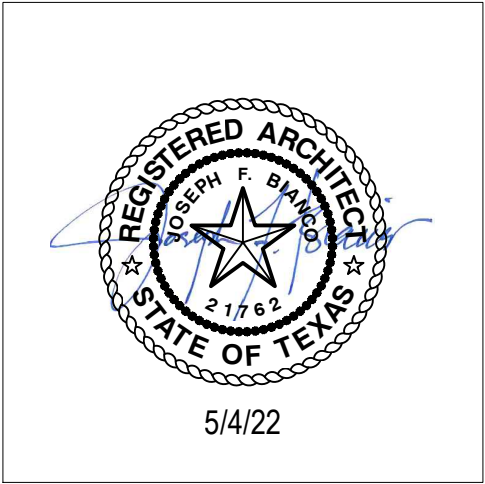
PROJECT MANAGEMENT

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Construction and Facilities Management

**VA** U.S. Department of Veterans Affairs

Drawing Title

ENLARGED FLOOR PLANS - 1ST FLOOR RENOVATION

Approved: Project Director

Phase

100% CONSTRUCTION DOCUMENTS

FULLY SPRINKLERED

Project Title

CINCINNATI VAMC EHRM INFRASTRUCTURE UPGRADES

Location  
3200 VINE ST., CINCINNATI, OH

Issue Date  
4-MAY-2022

Checked


Drawn  
JAR

Project Number  
539-21-701

Building Number  
FT64

Drawing Number  
AS-511-FT.64.1



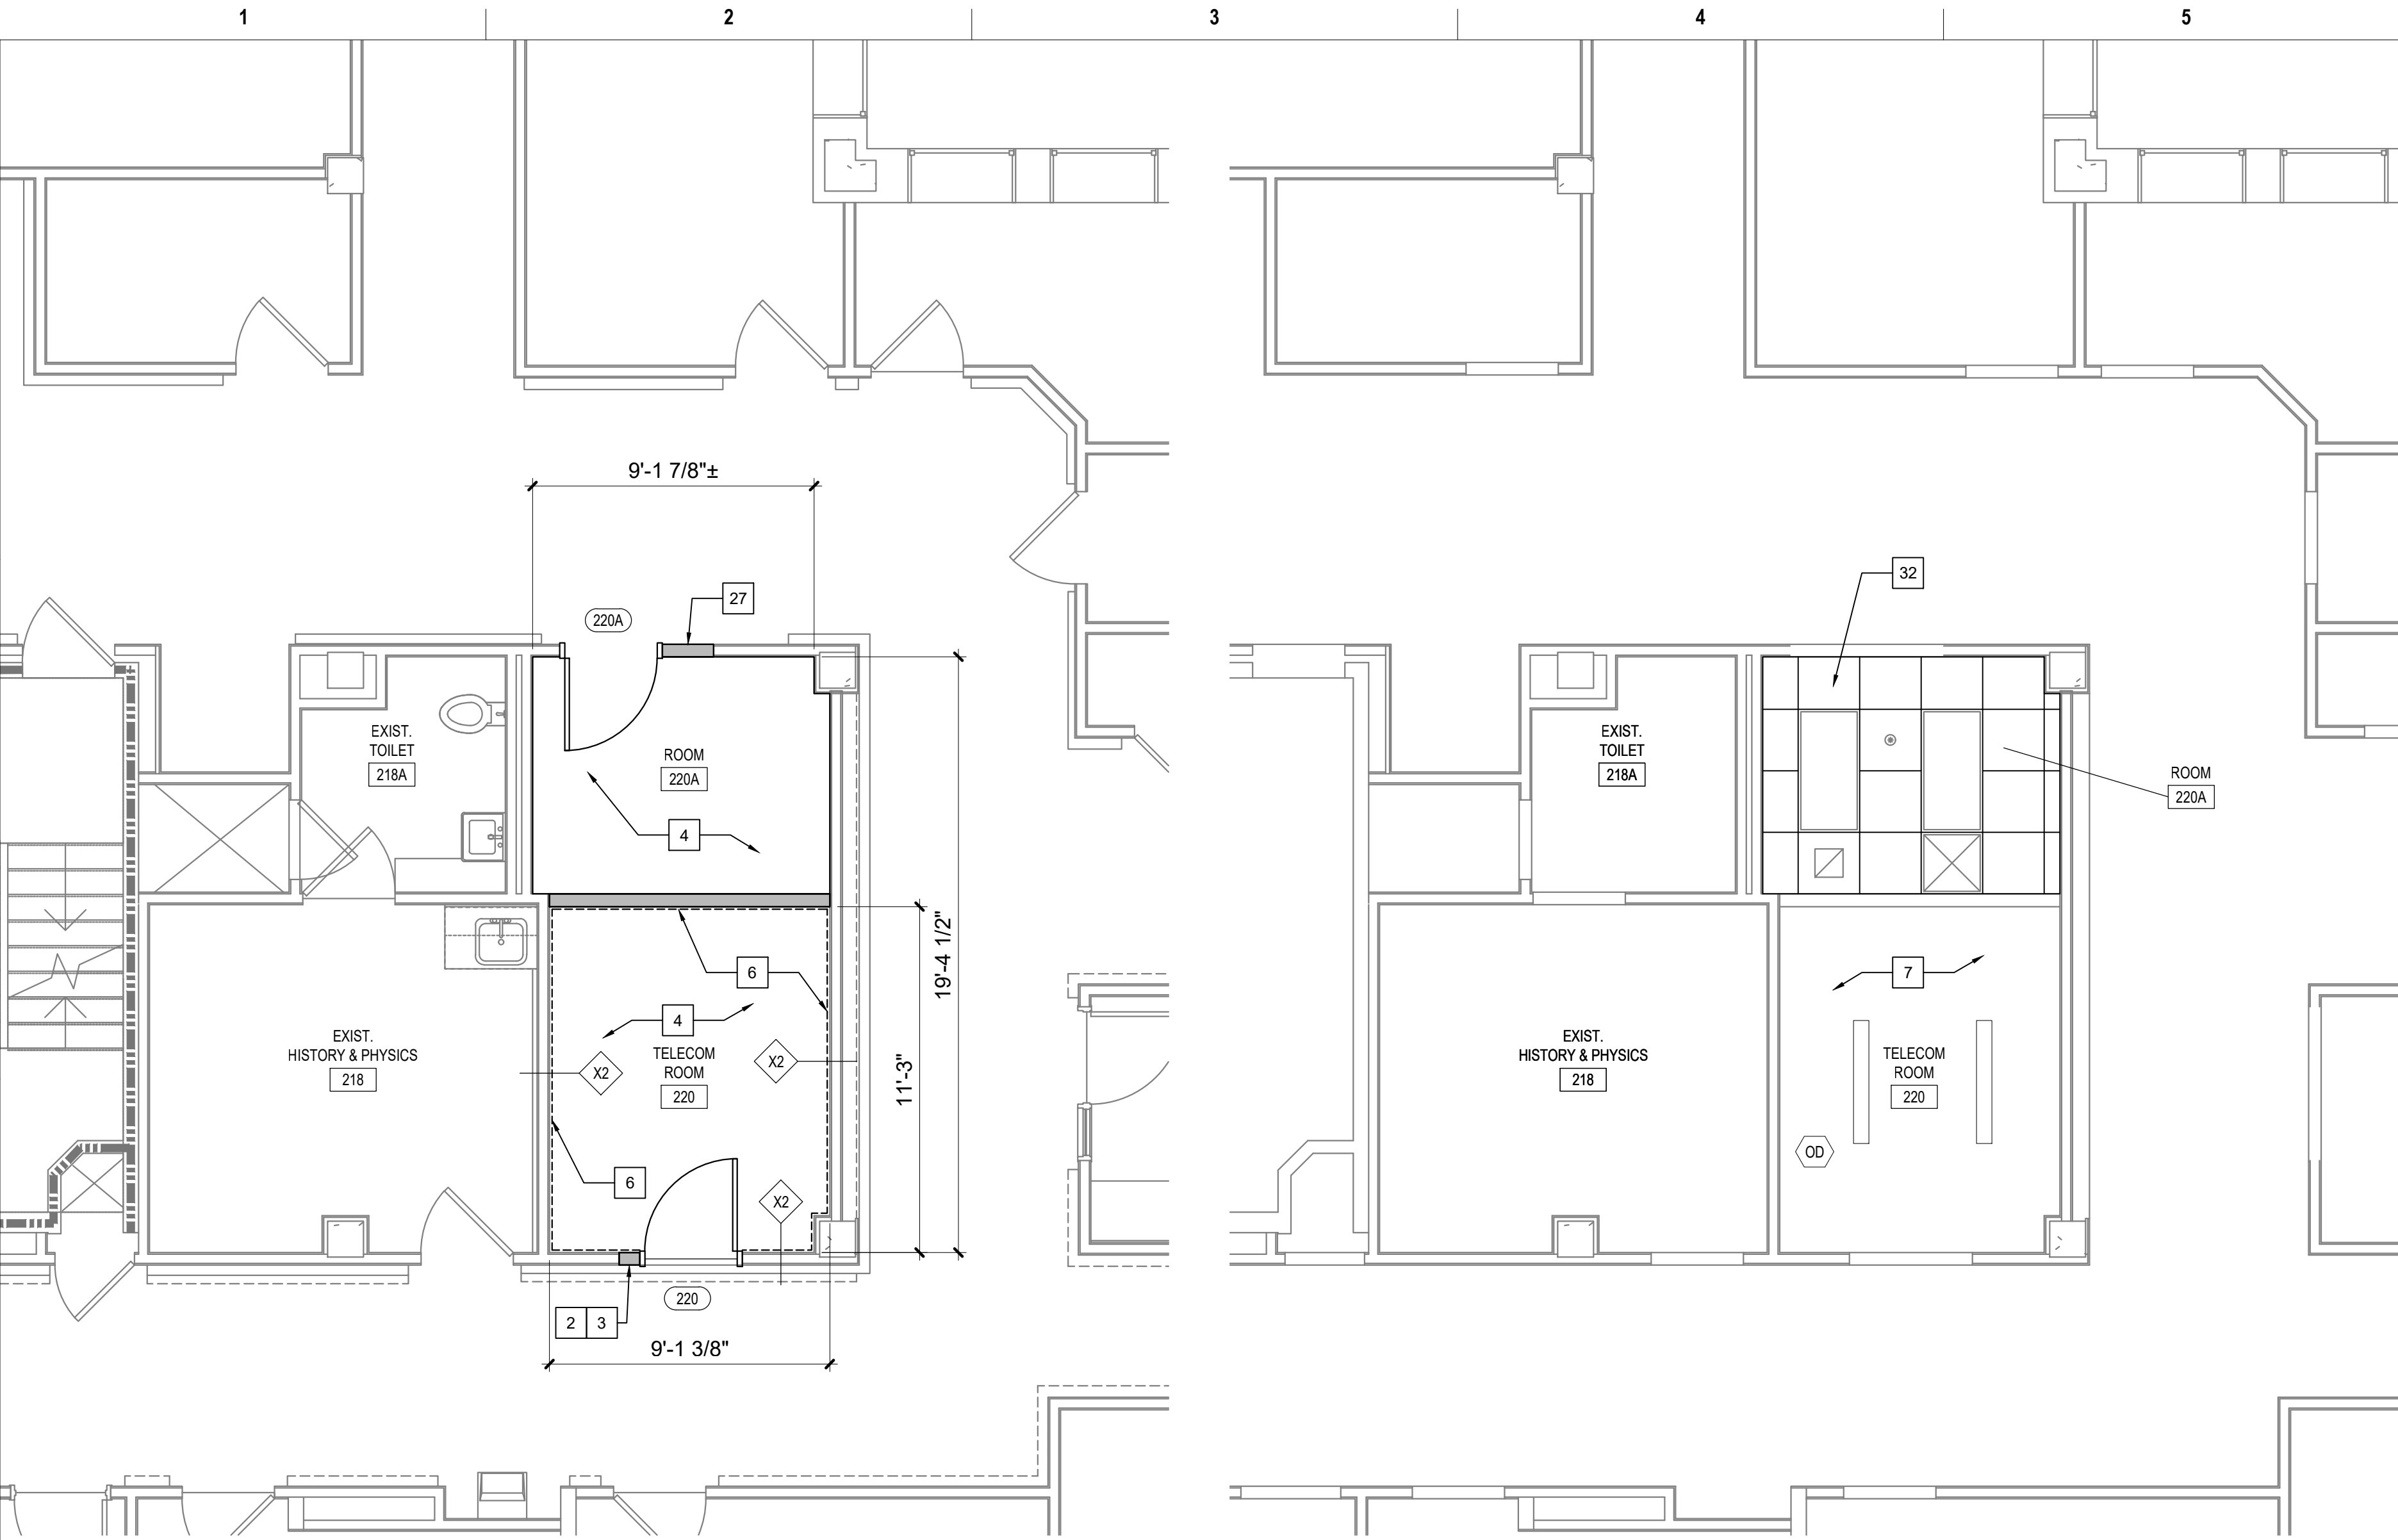

1 TELECOM ROOM 220 - ROOM RENOVATION  
SCALE: 1/4" = 1'-0"

2 TELECOM ROOM 220 - CEILING RENOVATION  
SCALE: 1/4" = 1'-0"

#### KEYED NOTES - RENOVATION

- EXISTING DOOR/FRAME ASSEMBLY TO REMAIN.
- PROVIDE CARD READER.
- PROVIDE ROOM SIGNAGE.
- PROVIDE NEW FLOORING AND BASE AS SCHEDULED.
- REFERENCE MEP AND TECHNOLOGY DRAWINGS FOR WORK SCOPE IN THIS ROOM THAT MAY REQUIRE MINOR DEMOLITION, PATCHING AND REPAIR OF EXISTING FLOOR SUBSTRATE, WALL OR MISCELLANEOUS ASSEMBLIES.
- PROVIDE 8"x4"x3/4" AC FACED FIRE-RATED PLYWOOD VERTICALLY ON ALL WALLS AS INDICATED. PAINT WITH 2 COATS MIN. FIRE-RATED PAINT. COORDINATE EXACT LOCATION A.F.F. WITH TECHNOLOGY AND ELECTRICAL DRAWINGS AND EXISTING CONDITIONS.
- REFERENCE MEP AND TECHNOLOGY DRAWINGS FOR WORK SCOPE OF EXISTING AND NEW COMPONENTS AT CEILING LEVEL.
- EXISTING FLOOR AND BASE TO REMAIN. REPAIR AS NECESSARY TO MATCH EXISTING CONDITIONS OR BETTER.
- EXISTING VCT FLOORING AND RUBBER BASE TO REMAIN.
- LIMITED RENOVATION TO EXISTING CEILING ASSEMBLY PER MEP AND TECHNOLOGY DRAWINGS WORK SCOPE.
- RELOCATED EXISTING MARKER BOARD.
- RELOCATED EXISTING MILLWORK.
- CEILING FUR-DOWN ABOVE.
- NEW GYPSUM BOARD/METAL STUD FRAMED FUR-DOWN TO MATCH EXISTING HEIGHT. NO JOINTS UNLESS NOTED OTHERWISE.
- RELOCATED EXISTING LIGHT FIXTURE.
- RELOCATED EXISTING TV MONITOR.
- EXISTING ALUMINUM FLOOR AND WALL (EACH SIDE) EXPANSION JOINT COVERS TO REMAIN.
- EXISTING GYPSUM BOARD/METAL STUD FRAMED FUR-DOWN TO REMAIN.
- RELOCATED EXISTING FIRE EXTINGUISHER.
- EXISTING EXTERIOR WINDOW TO REMAIN.
- REINSTALL EXISTING SALVAGED WOOD BASE AND CHAIR RAIL. PROVIDE BALANCE OF MATERIAL AS NEEDED TO COMPLETE JOB. PAINT ALL BASE AND CHAIR RAIL IN ENTIRE ROOM.
- EXISTING PLASTER ON CMU TO UNDERSIDE OF EXISTING STRUCTURE (4" OR 8" CMU PER WALL THICKNESS DEPICTED GRAPHICALLY). FIRE-RATED WALL. CONTRACTOR VERIFY.
- EXISTING ROOM SIGNAGE.
- EXISTING CARD READER.
- REFERENCE DOOR SCHEDULE.
- PAINT INTERIOR SIDE OF EXISTING WINDOW GLAZING ONLY "FLAT BLACK".
- REINSTALLED EXISTING ROOM SIGNAGE.
- REINSTALLED EXISTING CARD READER.
- PLASTER ASSEMBLY INFILL AT EXISTING WALL AS DETAILED AT EXISTING WINDOW OPENING.
- ENSURE EXISTING WALL VENT IS SECURELY CLOSED SHUT PRIOR TO COVER-UP.
- PROVIDE WALL PROTECTION TO MATCH EXISTING.
- PROVIDE NEW CEILING AS SCHEDULED.
- PROVIDE GYPSUM BOARD/STEEL STUD FRAMED FUR-DOWN AS DETAILED.
- PROVIDE 2' X 2' RAISED FLOOR SYSTEM AT 10" ABOVE THE 4TH FLOOR LEVEL.
- ELECTRICAL CONDUITS AND MECHANICAL PIPING PER MEP DRAWINGS.
- PROVIDE 5/8" GYPSUM BOARD WHERE EXISTING TILE WAINSCOT AND SUBSTRATE WAS REMOVED. TEXTURE AND FINISH TO MATCH EXISTING ADJACENT WALLS (4'-0"± HIGH, LOCATE AS INDICATED BY HEAVY LINE).
- TEXTURE AND FINISH EXISTING GYPSUM BOARD SUBSTRATE TO MATCH EXISTING ADJACENT WALLS.
- GYPSUM BOARD ASSEMBLY INFILL AS DETAILED AT EXISTING WINDOW OPENING.
- PROVIDE INFILL PER KEYED NOTE 29 AT VOID LEFT BY HEATER REMOVED.
- PROVIDE 1" THICK MINIMUM CONCRETE INFILL FLUSH WITH EXISTING CONCRETE TOPPING WHERE PORTIONS OF EXISTING CMU WALLS ARE REMOVED.
- PROVIDE PAINTED WOOD CHAIR RAIL TO MATCH EXISTING.
- REINSTALLED EXISTING SHELF.
- PROVIDE GYPSUM BOARD/METAL STUD FRAMED CHASE FROM FLOORS ABOVE. MINIMIZE SIZE AND REFERENCE MEP DRAWINGS FOR COMPONENTS TO BE IN CHASE.
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#### GENERAL NOTES - RENOVATION

- REFERENCE GENERAL NOTES ON SHEET GI-004.
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#### KEYED NOTES - RENOVATION (CONT.)

- TEMPORARY ALUMINUM RAMP BY CONTRACTOR TO BE RETURNED TO OWNER AT END OF JOB.
- MODULAR BRICK INFILL ON EXTERIOR TO MATCH EXISTING. TOOTH-IN AND MATCH MORTAR.

#### LEGEND - RENOVATION


- EXISTING WALL TO REMAIN
- NEW WALL CONSTRUCTION
- EXISTING DOOR/FRAME ASSEMBLY TO REMAIN
- NEW DOOR/FRAME ASSEMBLY
- EXISTING WINDOW ASSEMBLY TO REMAIN
- NEW WINDOW ASSEMBLY
- 1 HR. FIRE-RATED WALL (EXISTING)
- 2 HR. FIRE-RATED WALL (EXISTING)
- FIRE-RATED WALL (NEW OR EXISTING 1 HOUR UNLESS NOTED OTHERWISE)

Revisions:	Date:

#### CONSULTANT



#### PROJECT MANAGEMENT

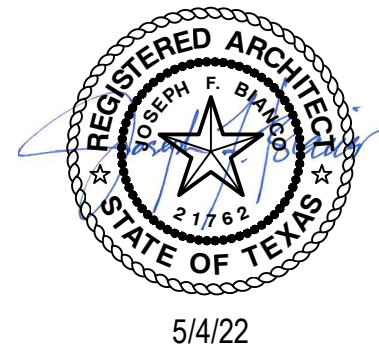

Construction  
and Facilities  
Management

VA U.S. Department  
of Veterans Affairs

Drawing Title  
**ENLARGED FLOOR PLANS -  
2ND FLOOR RENOVATION**

Approved: Project Director

Phase  
**100% CONSTRUCTION  
DOCUMENTS**

**FULLY SPRINKLERED**

Project Title  
**CINCINNATI VAMC EHRM  
INFRASTRUCTURE UPGRADES**

Location  
3200 VINE ST., CINCINNATI, OH

Issue Date  
4-MAY-2022


Checked

Drawn  
JAR

Project Number  
539-21-701  
Building Number  
FT64

Drawing Number  
**AS-512-FT.64.2**



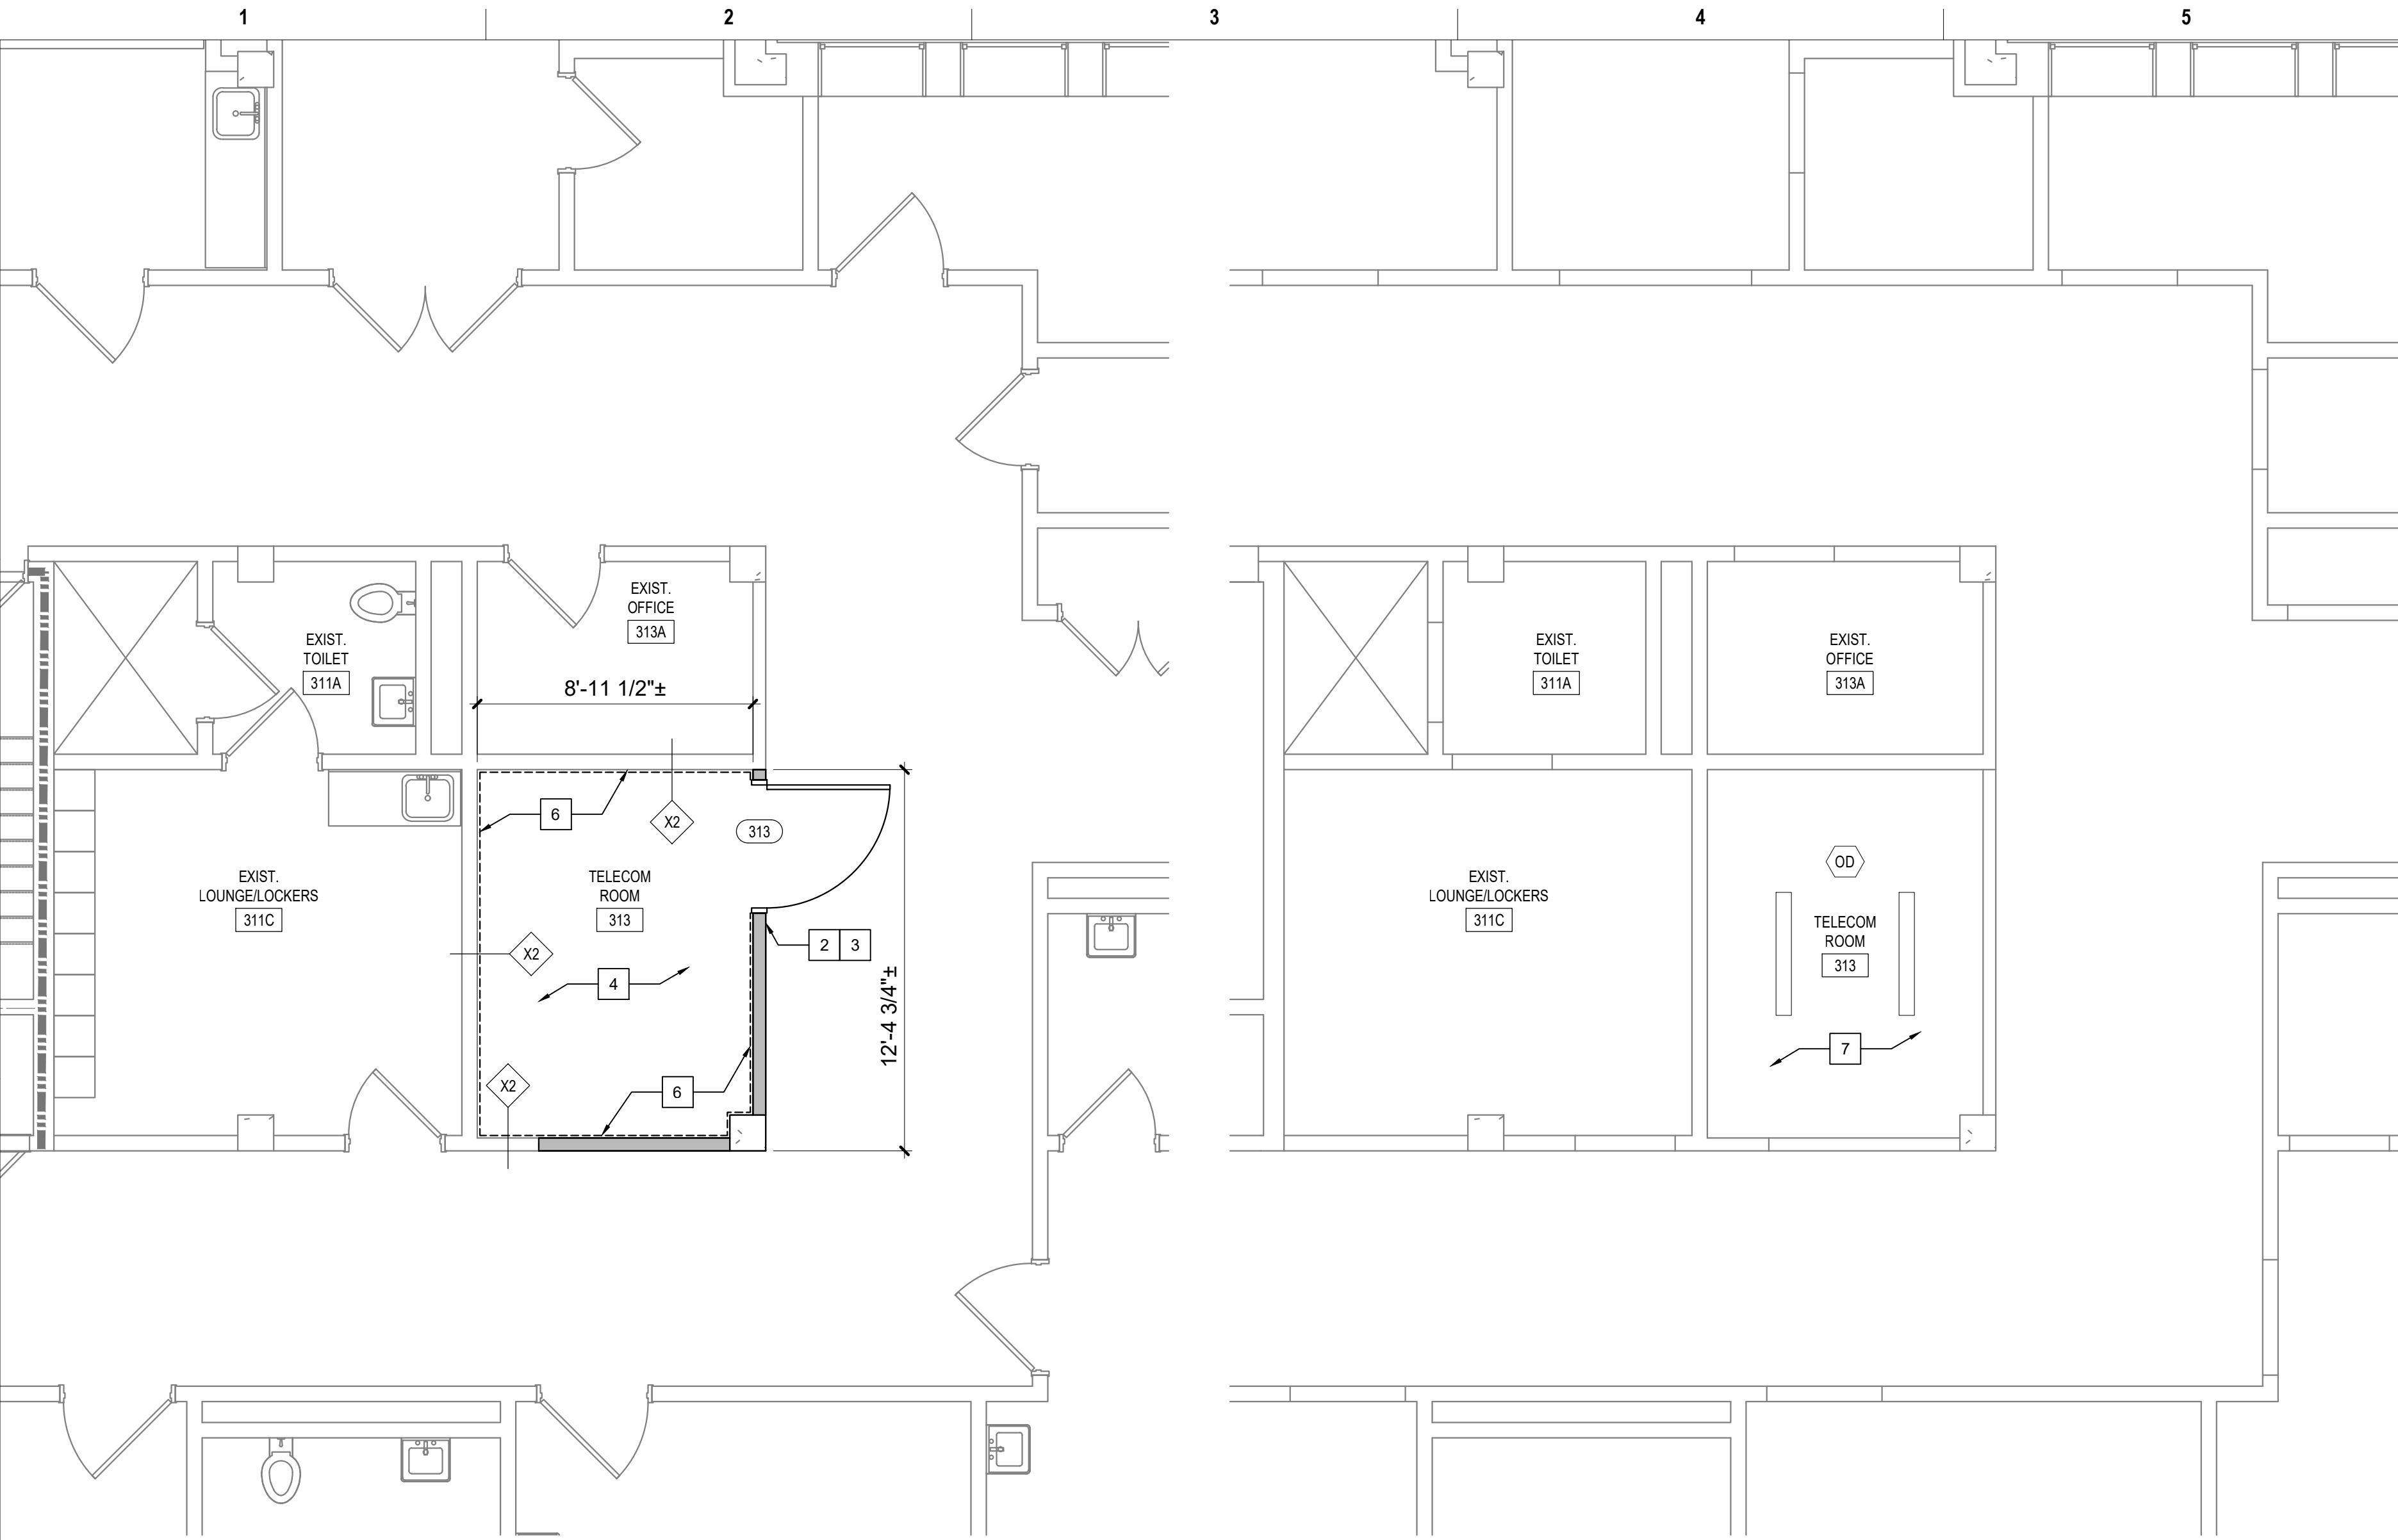

1 TELECOM ROOM 313 - ROOM RENOVATION  
SCALE: 1/4" = 1'-0"

2 TELECOM ROOM 313 - CEILING RENOVATION  
SCALE: 1/4" = 1'-0"

### KEYED NOTES - RENOVATION

- EXISTING DOOR/FRAME ASSEMBLY TO REMAIN.
- PROVIDE CARD READER.
- PROVIDE ROOM SIGNAGE.
- PROVIDE NEW FLOORING AND BASE AS SCHEDULED.
- REFERENCE MEP AND TECHNOLOGY DRAWINGS FOR WORK SCOPE IN THIS ROOM THAT MAY REQUIRE MINOR DEMOLITION, PATCHING AND REPAIR OF EXISTING FLOOR SUBSTRATE, WALL OR MISCELLANEOUS ASSEMBLIES.
- PROVIDE 8"x4"x3/4" AC FACED FIRE-RATED PLYWOOD VERTICALLY ON ALL WALLS AS INDICATED. PAINT WITH 2 COATS MIN. FIRE-RATED PAINT. COORDINATE EXACT LOCATION A.F.F. WITH TECHNOLOGY AND ELECTRICAL DRAWINGS AND EXISTING CONDITIONS.
- REFERENCE MEP AND TECHNOLOGY DRAWINGS FOR WORK SCOPE OF EXISTING AND NEW COMPONENTS AT CEILING LEVEL.
- EXISTING FLOOR AND BASE TO REMAIN. REPAIR AS NECESSARY TO MATCH EXISTING CONDITIONS OR BETTER.
- EXISTING VCT FLOORING AND RUBBER BASE TO REMAIN.
- LIMITED RENOVATION TO EXISTING CEILING ASSEMBLY PER MEP AND TECHNOLOGY DRAWINGS WORK SCOPE.
- RELOCATED EXISTING MARKER BOARD.
- RELOCATED EXISTING MILLWORK.
- CEILING FUR-DOWN ABOVE.
- NEW GYPSUM BOARD/METAL STUD FRAMED FUR-DOWN TO MATCH EXISTING HEIGHT. NO JOINTS UNLESS NOTED OTHERWISE.
- RELOCATED EXISTING LIGHT FIXTURE.
- RELOCATED EXISTING TV MONITOR.
- EXISTING ALUMINUM FLOOR AND WALL (EACH SIDE) EXPANSION JOINT COVERS TO REMAIN.
- EXISTING GYPSUM BOARD/METAL STUD FRAMED FUR-DOWN TO REMAIN.
- RELOCATED EXISTING FIRE EXTINGUISHER.
- EXISTING EXTERIOR WINDOW TO REMAIN.
- REINSTALL EXISTING SALVAGED WOOD BASE AND CHAIR RAIL. PROVIDE BALANCE OF MATERIAL AS NEEDED TO COMPLETE JOB. PAINT ALL BASE AND CHAIR RAIL IN ENTIRE ROOM.
- EXISTING PLASTER ON CMU TO UNDERSIDE OF EXISTING STRUCTURE (4" OR 8" CMU PER WALL THICKNESS DEPICTED GRAPHICALLY). FIRE-RATED WALL. CONTRACTOR VERIFY.
- EXISTING ROOM SIGNAGE.
- EXISTING CARD READER.
- REFERENCE DOOR SCHEDULE.
- PAINT INTERIOR SIDE OF EXISTING WINDOW GLAZING ONLY "FLAT BLACK".
- REINSTALLED EXISTING ROOM SIGNAGE.
- REINSTALLED EXISTING CARD READER.
- PLASTER ASSEMBLY INFILL AT EXISTING WALL AS DETAILED AT EXISTING WINDOW OPENING.
- ENSURE EXISTING WALL VENT IS SECURELY CLOSED SHUT PRIOR TO COVER-UP.
- PROVIDE WALL PROTECTION TO MATCH EXISTING.
- PROVIDE NEW CEILING AS SCHEDULED.
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- PROVIDE 2' X 2' RAISED FLOOR SYSTEM AT 10" ABOVE THE 4TH FLOOR LEVEL.
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- PROVIDE 5/8" GYPSUM BOARD WHERE EXISTING TILE WAINSCOT AND SUBSTRATE WAS REMOVED. TEXTURE AND FINISH TO MATCH EXISTING ADJACENT WALLS (4'-0"± HIGH. LOCATE AS INDICATED BY HEAVY LINE).
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- GYPSUM BOARD ASSEMBLY INFILL AS DETAILED AT EXISTING WINDOW OPENING.
- PROVIDE INFILL PER KEYED NOTE 29 AT VOID LEFT BY HEATER REMOVED.
- PROVIDE 1" THICK MINIMUM CONCRETE INFILL FLUSH WITH EXISTING CONCRETE TOPPING WHERE PORTIONS OF EXISTING CMU WALLS ARE REMOVED.
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- REINSTALLED EXISTING SHELF.
- PROVIDE GYPSUM BOARD/METAL STUD FRAMED CHASE FROM FLOORS ABOVE. MINIMIZE SIZE AND REFERENCE MEP DRAWINGS FOR COMPONENTS TO BE IN CHASE.
- RAMP AND RAILS BY RAISED FLOOR SYSTEM MANUFACTURER.
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### GENERAL NOTES - RENOVATION

- REFERENCE GENERAL NOTES ON SHEET GI-004.
- UNLESS NOTED OTHERWISE, ALL EXISTING WALLS ARE 5/8" GYPSUM BOARD/3 5/8" METAL STUD FRAMED TO UNDERSIDE OF PRIMARY BUILDING FRAMING STRUCTURE (1 HR. FIRE RATED - CONSTRUCTION SIMILAR TO U.I. DESIGN NO. U465). CONTRACTOR TO VERIFY.
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### KEYED NOTES - RENOVATION (CONT.)

- TEMPORARY ALUMINUM RAMP BY CONTRACTOR TO BE RETURNED TO OWNER AT END OF JOB.
- MODULAR BRICK INFILL ON EXTERIOR TO MATCH EXISTING. TOOTH-IN AND MATCH MORTAR.

### LEGEND - RENOVATION

- EXISTING WALL TO REMAIN
- NEW WALL CONSTRUCTION
- EXISTING DOOR/FRAME ASSEMBLY TO REMAIN
- NEW DOOR/FRAME ASSEMBLY
- EXISTING WINDOW ASSEMBLY TO REMAIN
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- 1 HR. FIRE-RATED WALL (EXISTING)
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Revisions:	Date:

CONSULTANT



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Construction  
and Facilities  
Management

VA U.S. Department  
of Veterans Affairs

Drawing Title  
ENLARGED FLOOR PLANS -  
3RD FLOOR RENOVATION

Approved: Project Director

Phase  
100% CONSTRUCTION  
DOCUMENTS

FULLY SPRINKLERED

Project Title  
CINCINNATI VAMC EHRM  
INFRASTRUCTURE UPGRADES

Location  
3200 VINE ST., CINCINNATI, OH

Issue Date

4-MAY-2022

Checked

Drawn


JAR

Project Number  
539-21-701  
Building Number  
FT64

Drawing Number

AS-513-FT.64.3



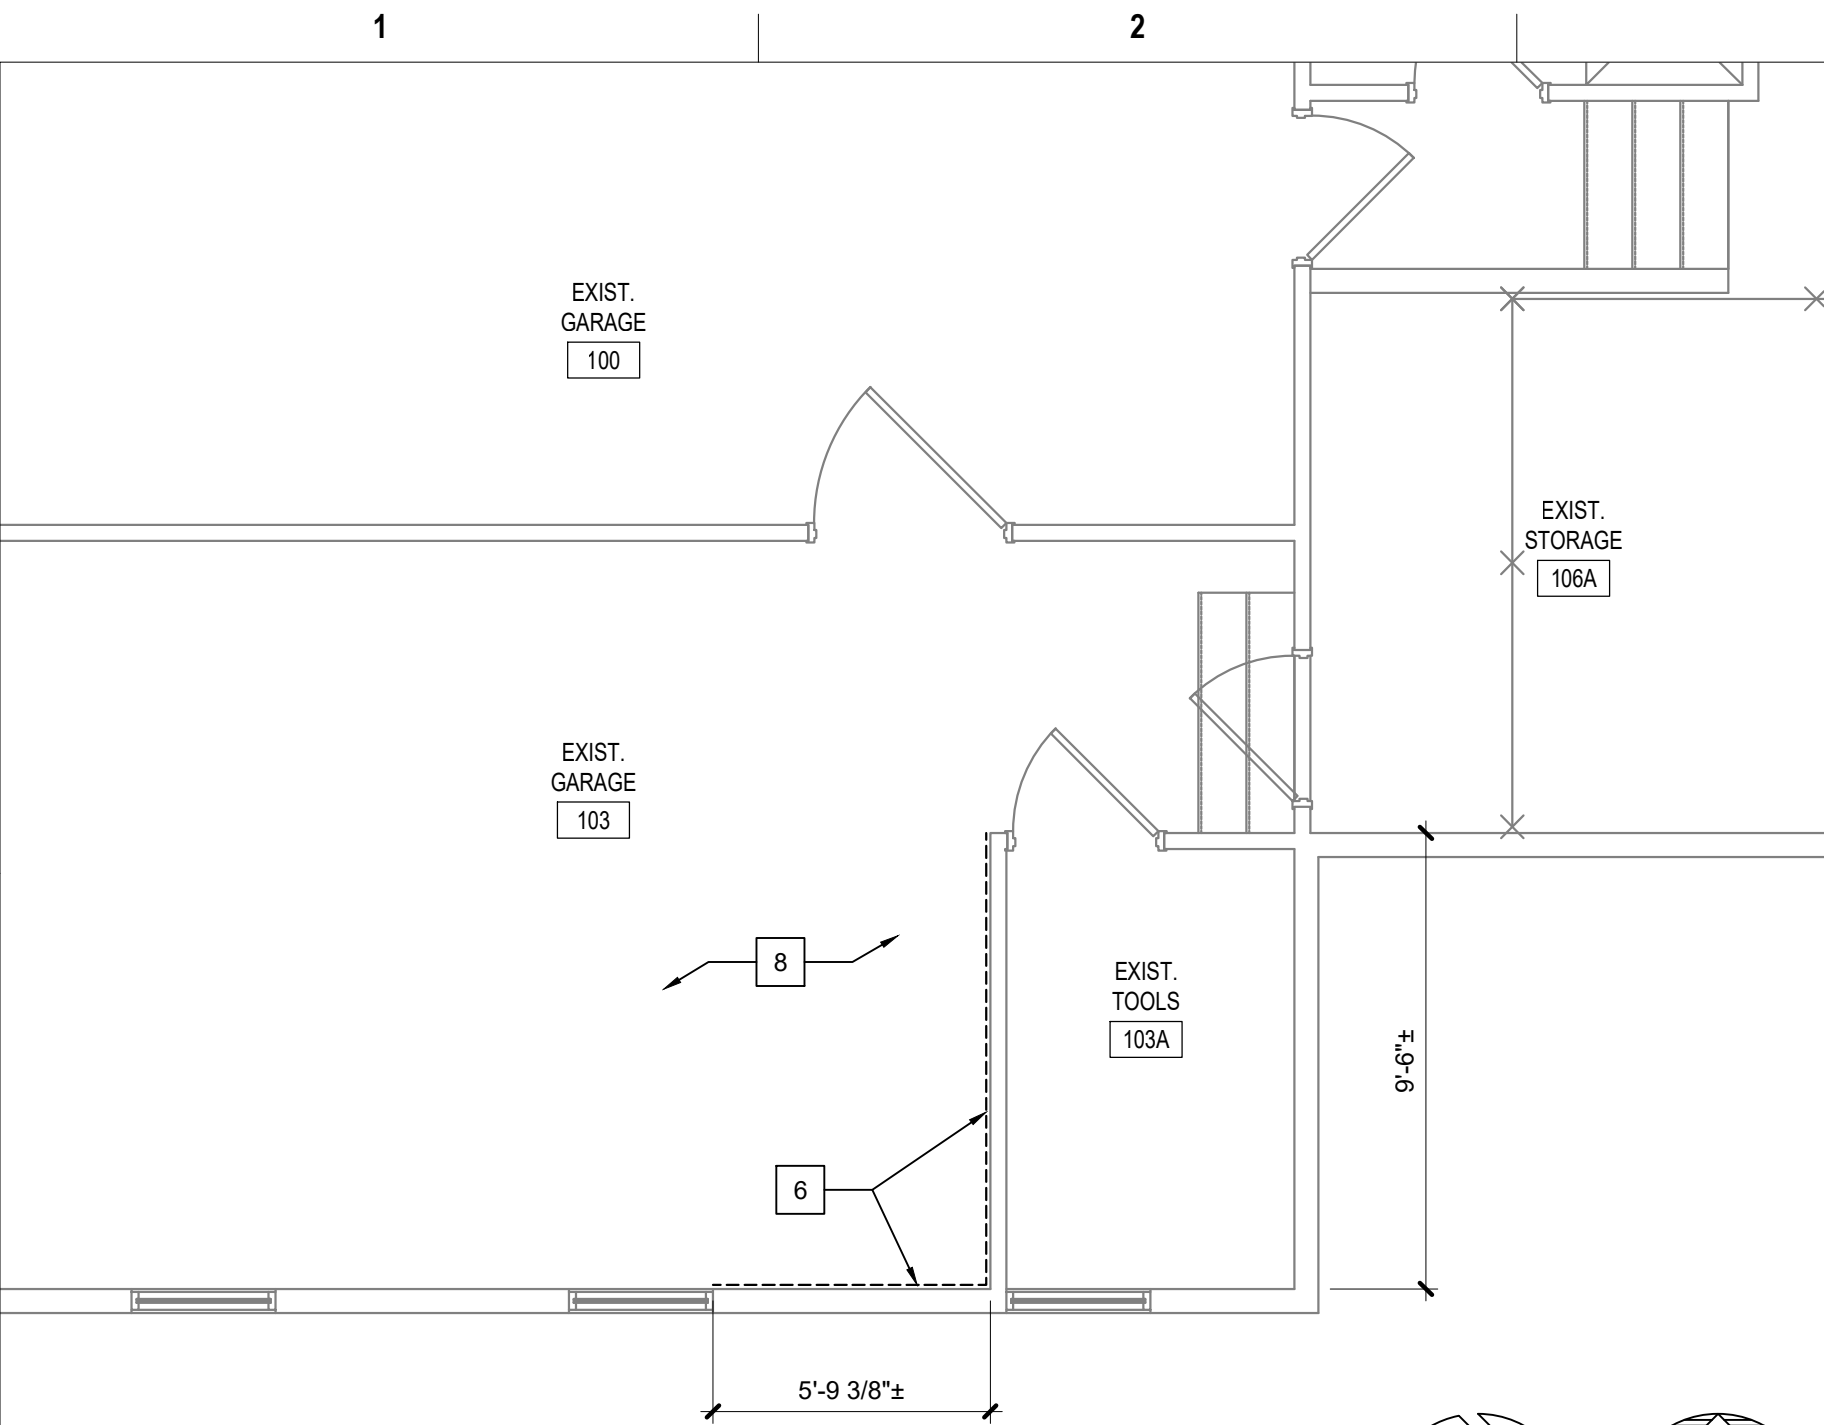

1 EXISTING GARAGE 103 - ROOM RENOVATION  
SCALE: 1/4" = 1'-0"



2 EXISTING GARAGE 103 - CEILING RENOVATION  
SCALE: 1/4" = 1'-0"



KEYED NOTES - RENOVATION

- EXISTING DOOR/FRAME ASSEMBLY TO REMAIN.
- PROVIDE CARD READER.
- PROVIDE ROOM SIGNAGE.
- PROVIDE NEW FLOORING AND BASE AS SCHEDULED.
- REFERENCE MEP AND TECHNOLOGY DRAWINGS FOR WORK SCOPE IN THIS ROOM THAT MAY REQUIRE MINOR DEMOLITION, PATCHING AND REPAIR OF EXISTING FLOOR SUBSTRATE, WALL OR MISCELLANEOUS ASSEMBLIES.
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- CEILING FUR-DOWN ABOVE.
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- REFERENCE GENERAL NOTES ON SHEET GI-004.
- UNLESS NOTED OTHERWISE, ALL EXISTING WALLS ARE 5/8" GYPSUM BOARD/3 5/8" METAL STUD FRAMED TO UNDERSIDE OF PRIMARY BUILDING FRAMING STRUCTURE (1 HR. FIRE RATED - CONSTRUCTION SIMILAR TO U.I. DESIGN NO. U465). CONTRACTOR TO VERIFY.
- UNLESS NOTED OTHERWISE, ALL EXISTING DOOR ASSEMBLIES ARE SOLID CORE WOOD DOORS/HOLLOW METAL FRAME TYPICAL (3'-0" X 7'-0").
- UNLESS NOTED OTHERWISE ALL EXISTING LAY-IN CEILING ASSEMBLIES ARE 2' X 2' STANDARD GRID WITH FISSURED TILES AT 8'-0" A.F.F. TYPICAL.
- UNLESS NOTED OTHERWISE, ALL EXISTING STEEL COLUMN FUR-OUTS ARE GYPSUM BOARD/METAL STUD FRAMED TYPICAL.
- PARTIAL OR ENTIRE RECONSTRUCTION OF SOME EXISTING CEILING ASSEMBLIES THROUGH OUT THE ENTIRE BUILDING(S), ESPECIALLY IN CORRIDORS, WILL BE NECESSARY. REFERENCE ALL DISCIPLINE DEMOLITION DRAWINGS. RECONSTRUCTION IS TO INCLUDE MISCELLANEOUS PATCHING /REPAIR TO MATCH EXISTING OR BETTER CONDITIONS.
- EXISTING FIRE-RATED WALL IDENTIFICATION INDICATED ONLY FOR IMMEDIATE AFFECTED ROOM WALLS. CONTRACTOR SHALL VERIFY FULL EXTENT OF EXISTING FIRE-RATED WALLS AT ADJACENT AREAS.
- ALL NEW WALLS SHALL BE PARTITION TYPE "1" UNLESS OTHERWISE NOTED.
- UNLESS NOTED OTHERWISE AT ALL ROOMS WHERE EXISTING LAY-IN CEILING IS REMOVED AND IS TO BECOME A "NO CEILING" ROOM, THE EXISTING GYPSUM BOARD ABOVE. PREVIOUSLY REMOVED CEILING IS TO BE FULLY TAPED, FLOATED, TEXTURED AND PAINTED TO MATCH EXISTING WALLS.

KEYED NOTES - RENOVATION (CONT.)

- TEMPORARY ALUMINUM RAMP BY CONTRACTOR TO BE RETURNED TO OWNER AT END OF JOB.
- MODULAR BRICK INFILL ON EXTERIOR TO MATCH EXISTING. TOOTH-IN AND MATCH MORTAR.

LEGEND - RENOVATION

- EXISTING WALL TO REMAIN
- NEW WALL CONSTRUCTION
- EXISTING DOOR/FRAME ASSEMBLY TO REMAIN
- NEW DOOR/FRAME ASSEMBLY
- EXISTING WINDOW ASSEMBLY TO REMAIN
- NEW WINDOW ASSEMBLY
- 1 HR. FIRE-RATED WALL (EXISTING)
- 2 HR. FIRE-RATED WALL (EXISTING)
- FIRE-RATED WALL (NEW OR EXISTING 1 HOUR UNLESS NOTED OTHERWISE)

Revisions:	Date:

CONSULTANT



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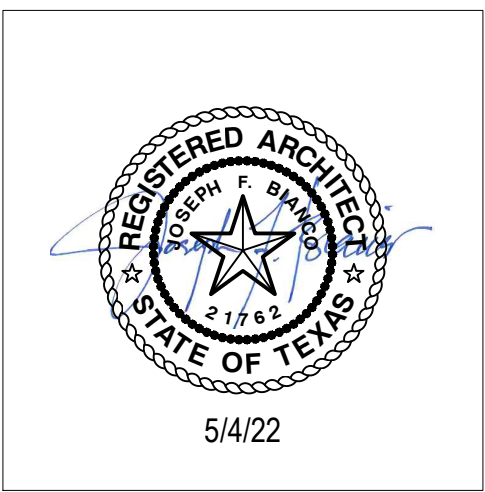
PROJECT MANAGEMENT



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Construction  
and Facilities  
Management

 U.S. Department  
of Veterans Affairs

Drawing Title

ENLARGED FLOOR PLANS -  
1ST FLOOR RENOVATION

Approved: Project Director

Phase

100% CONSTRUCTION  
DOCUMENTS

FULLY SPRINKLERED

Project Title

CINCINNATI VAMC EHRM  
INFRASTRUCTURE UPGRADES

Location  
3200 VINE ST., CINCINNATI, OH

Issue Date  
4-MAY-2022

Checked

Drawn  
JAR

Project Number  
539-21-701


Building Number  
FT117

Drawing Number  
AS-520-FT.117.1







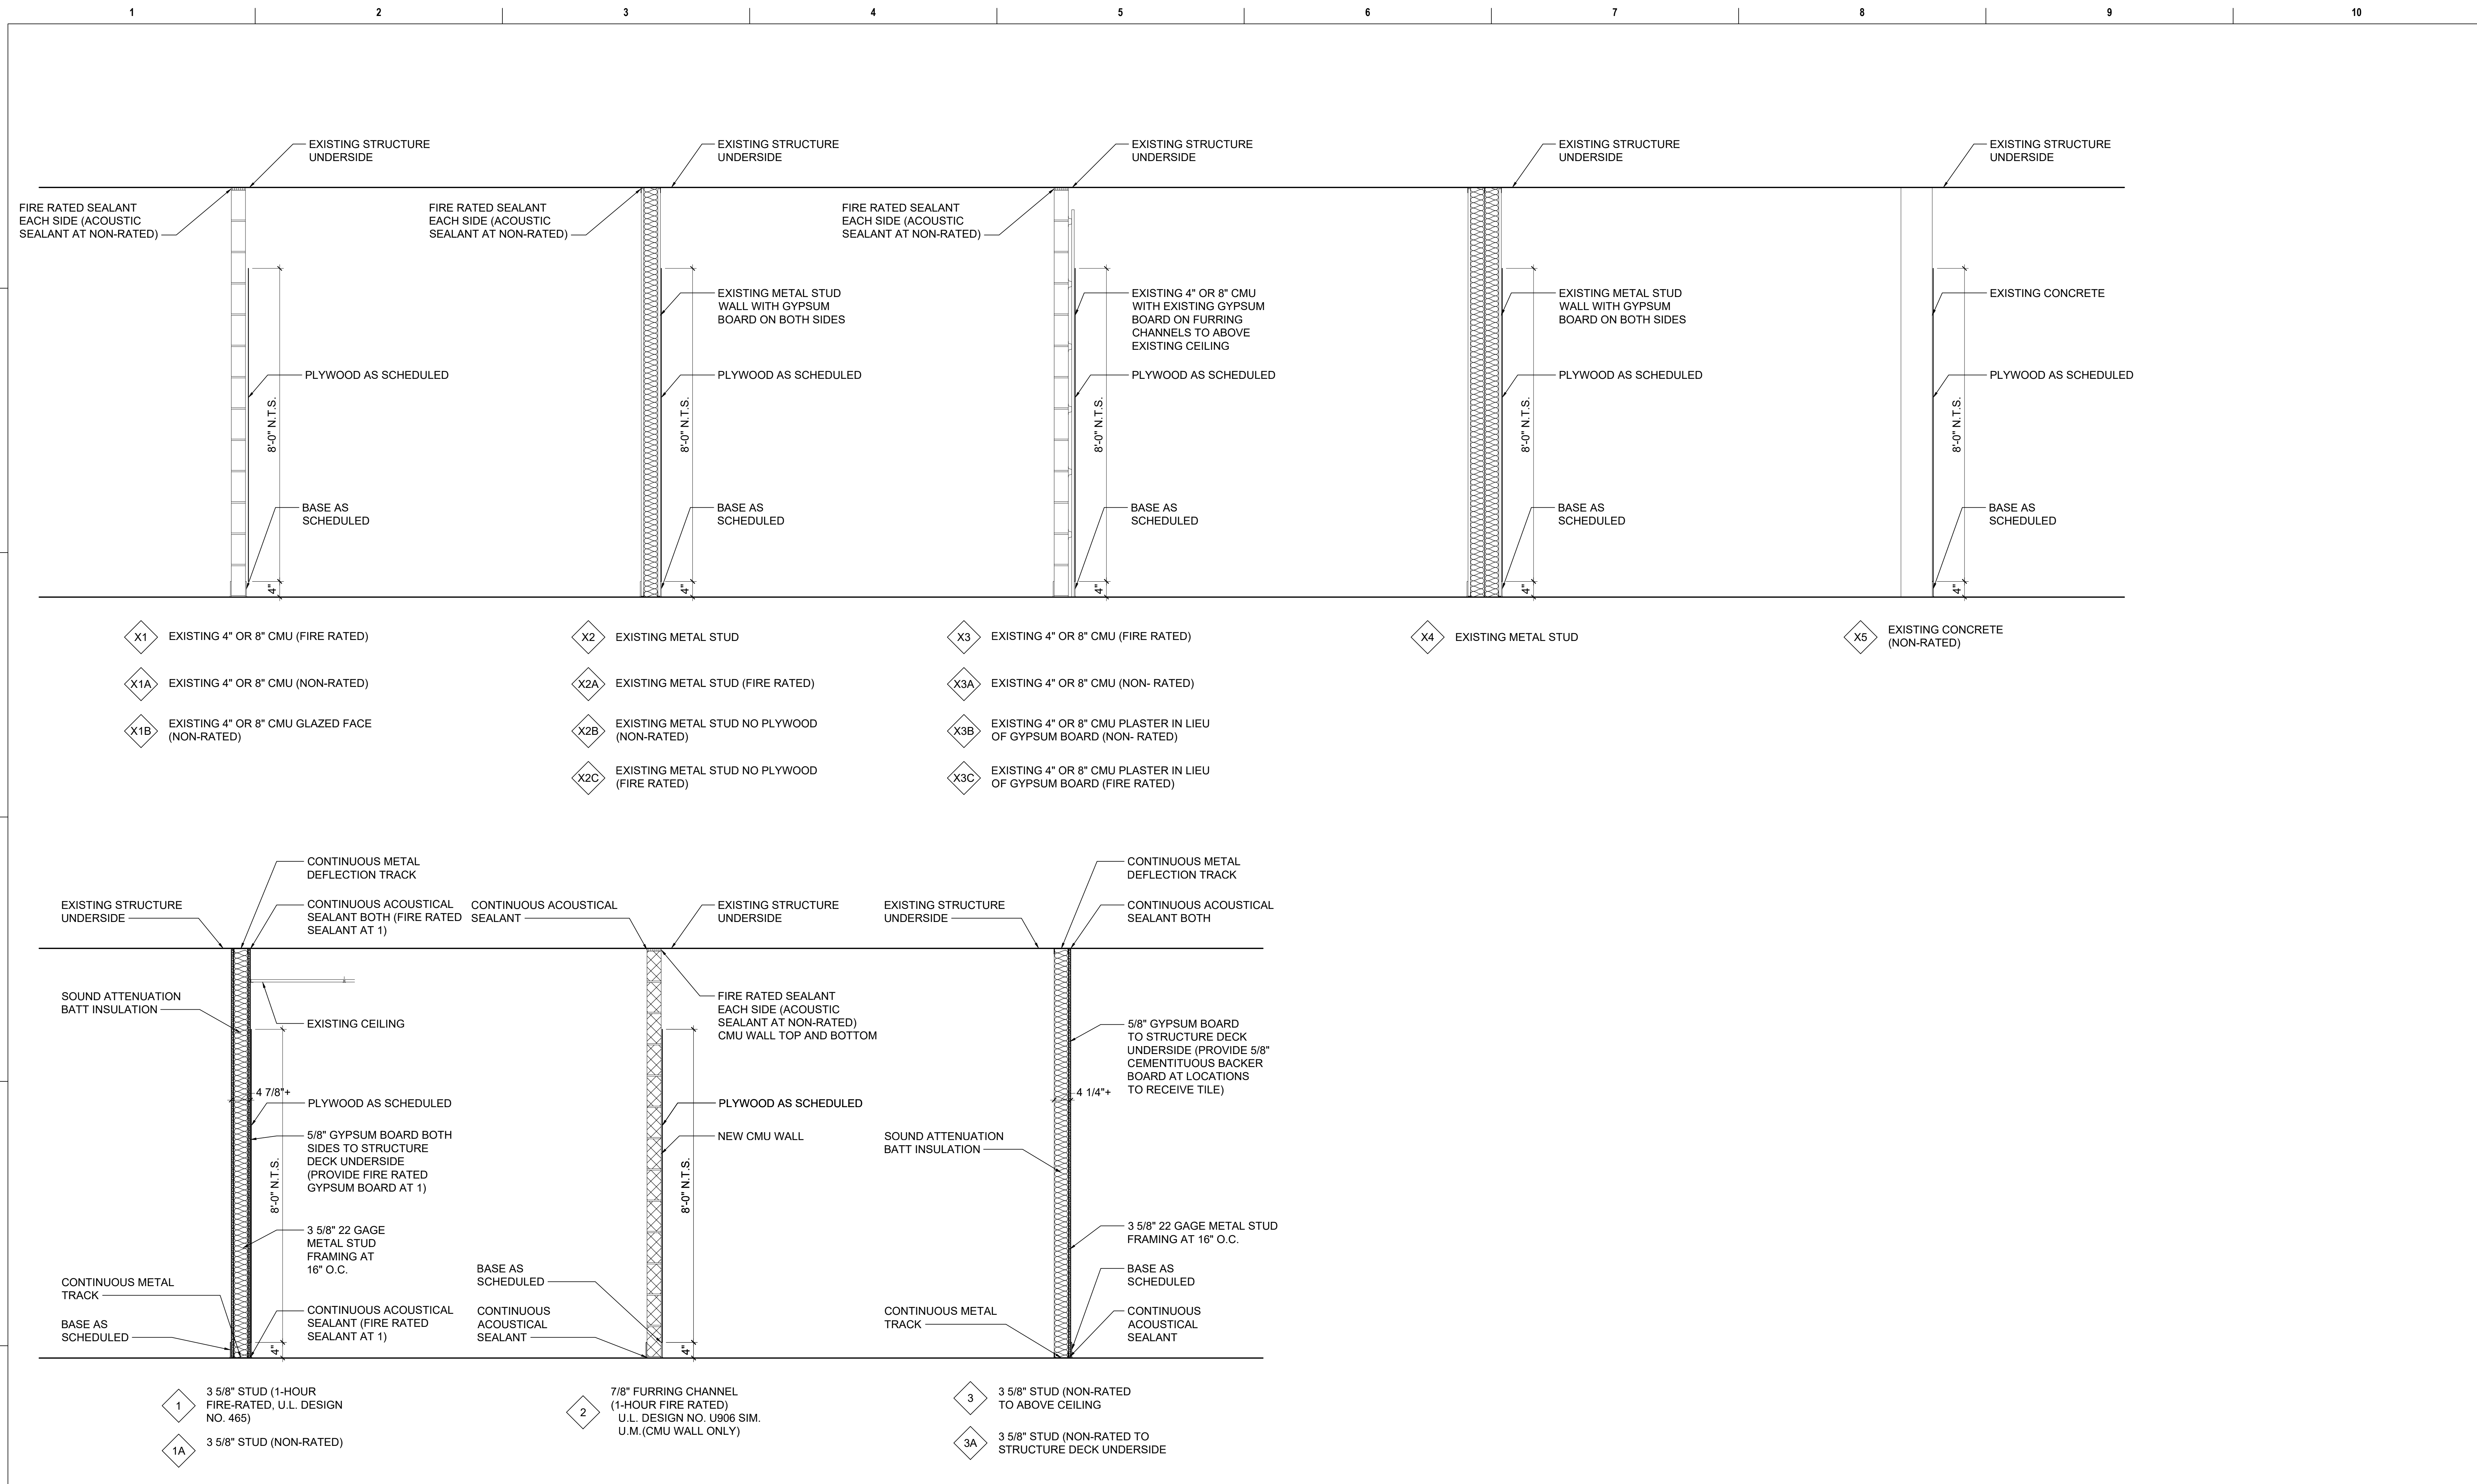

1 PARTITION TYPES - EXISTING & NEW CONSTRUCTION

Revisions:	Date:

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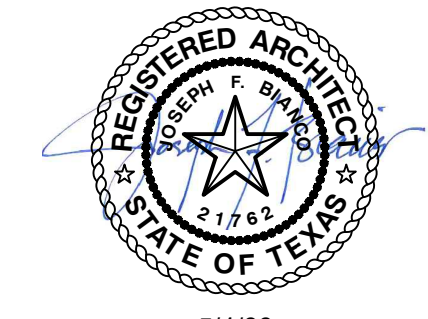
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Construction  
and Facilities  
Management

VA U.S. Department  
of Veterans Affairs

Drawing Title

PARTITION TYPES

Approved: Project Director

Phase

100% CONSTRUCTION  
DOCUMENTS

FULLY SPRINKLERED

Project Title

CINCINNATI VAMC EHRM  
INFRASTRUCTURE UPGRADES

Location

3200 VINE ST., CINCINNATI, OH

Issue Date

4-MAY-2022

Checked

IAR, JFB

Drawn

IAR

Project Number

539-21-701

Building Number

-

Drawing Number

AS-600




1		2		3			4			5						
DOOR SCHEDULE																
ROOM NAME		DOOR NUMBER	DOOR				FRAME			DETAILS			HARDWARE GROUP	LABEL RATING	REMARKS	
			WIDTH	HEIGHT	MATERIAL	FINISH	TYPE	MATERIAL	FINISH	TYPE	HEAD	JAMB				SILL
CINCINNATI - BUILDING 1																
TELECOM ROOM B021	B201	4'-0"	7'-0"	SC WD	STAIN	A	HM	PAINT	1	1/AS-710	2/AS-710	-	HW-4A	1 HR	1,2,3,4	
EXISTING VENDING A134	A134	4'-0"	7'-0"	SC WD	STAIN	A	HM	PAINT	1	3/AS-710 SIM.	4/AS-710 SIM	-	HW-5B	1 HR	1,3	
TELECOM ROOM A134A	A134A	4'-0"	7'-0"	HM	STAIN	A	HM	PAINT	1	3/AS-710	4/AS-710	-	HW-4A	1 HR	2,3,4	
TELECOM ROOM A144A	A144A	4'-0"	7'-0"	SC WD	STAIN	A	HM	PAINT	1	3/AS-710 SIM.	4/AS-710 SIM.	-	HW-4A	1 HR	1,2,3,4	
TELECOM ROOM B232	B232	4'-0"	7'-0"	SC WD	STAIN	A	HM	PAINT	1	3/AS-710 SIM.	4/AS-710 SIM.	-	HW-4A	1 HR	1,2,3,4	
TELECOM ROOM C236A	C236A	4'-0"	7'-0"	SC WD	STAIN	A	HM	PAINT	1	3/AS-710 SIM.	4/AS-710 SIM.	-	HW-4A	1 HR	1,2,3,4	
TELECOM ROOM A2006A	A2006A	4'-0"	7'-0"	SC WD	STAIN	A	HM	PAINT	1	3/AS-710 SIM.	4/AS-710 SIM.	-	HW-4A	1 HR	1,2,3,4	
EXISTING RESEARCH OFFICE B312	B312	3'-0"	7'-0"	SC WD	STAIN	A	HM	PAINT	1	3/AS-710 SIM.	4/AS-710 SIM.	-	HW-4	-	1,3,4	
EXISTING TELECOM ROOM B312D	B312D	4'-0"	7'-0"	SC WD	STAIN	A	HM	PAINT	1	3/AS-710 SIM.	4/AS-710 SIM.	-	HW-4A	1 HR	1,2,3,4	
TELECOM ROMM C3006	C3006	4'-0"	7'-0"	SC WD	STAIN	A	HM	PAINT	1	3/AS-710 SIM.	4/AS-710 SIM.	-	HW-4A	1 HR	1,2,3,4	
RESIDENT OFFICE/OVERNIGHT A383A	A383A	EXIST.	EXIST.	EXIST.	EXIST.	EXIST.	EXIST.	EXIST.	EXIST.	-	-	-	-	EXIST.	5	
TELECOM ROOM C305	C305	4'-0"	7'-0"	SC WD	STAIN	A	HM	PAINT	1	3/AS-710	4/AS-710	-	HW-4A	1 HR	1,2,3,4	
EXIST. IRM NETWORK OPERATION CENTER	A437	PR(3'-0")	7'-0"	SC WD	STAIN	A	HM	PAINT	1	3/AS-710	4/AS-710	5A/AS-710	HW-12H	1 HR	3	
EXIST. COMPUTER ROOM A437C	A437A	PR(3'-0")	7'-0"	SC WD	STAIN	A	HM	PAINT	2	3/AS-710	4/AS-710	5A/AS-710	HW-12H	1 HR	2,3,6	
EXIST. COMPUTER ROOM A437C	A437C	4'-0"	7'-0"	SC WD	STAIN	A	HM	PAINT	2	3/AS-710	4/AS-710	6/AS-710	HW-4L	1 HR	3,6	
TELECOM ROOM A441	A441	4'-0"	7'-0"	SC WD	STAIN	A	HM	PAINT	1	1/AS-710	2/AS-710	-	HW-4A	1 HR	1,2,3,4	
TELECOM ROOM A540	A540	4'-0"	7'-0"	SC WD	STAIN	A	HM	PAINT	1	1/AS-710	2/AS-710	-	HW-4A	1 HR	1,2,3,4	
TELECOM ROOM A643	A643	4'-0"	7'-0"	SC WD	STAIN	A	HM	PAINT	1	1/AS-710	2/AS-710	-	HW-4A	1 HR	1,2,3,4	
STORAGE A702A	A702A	3'-0"	7'-0"	SC WD	STAIN	A	HM	PAINT	1	3/AS-710	4/AS-710	-	HW-5	1 HR	1,3,4	
STORAGE A704A	A704A	3'-0"	7'-0"	SC WD	STAIN	A	HM	PAINT	1	3/AS-710	4/AS-710	-	HW-5	1 HR	1,3,4	
EXISTING OCCUPATIONAL THERAPY A732	A732	3'-0"	7'-0"	SC WD	STAIN	A	HM	PAINT	1	1/AS-710	2/AS-710	-	HW-4A	1 HR	1,3,4	
TELECOM ROOM A732A	A732A	4'-0"	7'-0"	SC WD	STAIN	A	HM	PAINT	1	1/AS-710	2/AS-710	-	HW-4A	1 HR	1,2,3,4	
TELECOM ROOM A838	A838	4'-0"	7'-0"	SC WD	STAIN	A	HM	PAINT	1	1/AS-710	2/AS-710	-	HW-4A	1 HR	1,2,3,4	
TELECOM ROOM A916A	A916A	4'-0"	7'-0"	HM	PAINT	A	HM	PAINT	1	1/AS-710	2/AS-710	-	HW-4A	1 HR	1,2,3	
EXISTING ELECTRICAL ROOM A916D	A916D	3'-0"	7'-0"	HM	PAINT	A	HM	PAINT	1	1/AS-710	2/AS-710	5B/AS-710	HW-5	-	1,3	
-	-	-	-	-	-	-	-	-	-	-	-	-	-	-	-	
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CINCINNATI - BUILDING 2																
TELECOM ROOM 0001	0001	4'-0"	7'-0"	SC WD	STAIN	A	HM	PAINT	1	3/AS-710 SIM.	4/AS-710 SIM.	-	HW-4A	1 HR	1,2,3,4	
TELECOM ROOM 1040A	1040A	4'-0"	7'-0"	SC WD	STAIN	A	HM	PAINT	1	3/AS-710 SIM	4/AS-710 SIM	-	HW-4A	1 HR	1,2,3,4	
TELECOM ROOM 204	204	EXIST.	EXIST.	EXIST.	EXIST.	EXIST.	EXIST.	EXIST.	EXIST.	-	-	-	HW-4A	EXIST.	1	
-	-	-	-	-	-	-	-	-	-	-	-	-	-	-	-	
-	-	-	-	-	-	-	-	-	-	-	-	-	-	-	-	
CINCINNATI - BUILDING 3																
TELECOM ROOM 13A	13A	3'-0"	6'-8"	HM	PAINT	A	HM	PAINT	1	1/AS-710 SIM.	2/AS-710 SIM.	5B/AS-710	HW-4A	1 HR	1,2,3	
-	-	-	-	-	-	-	-	-	-	-	-	-	-	-	-	
-	-	-	-	-	-	-	-	-	-	-	-	-	-	-	-	
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CINCINNATI - BUILDING 8																
TELECOM ROOM 205	205	3'-0"	6'-8"	HM	PAINT	A	HM	PAINT	1	1/AS-710	2/AS-710	6/AS-710	HW-4A	1 HR	1,2,3	
-	-	-	-	-	-	-	-	-	-	-	-	-	-	-	-	
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CINCINNATI - BUILDING 15																
TELECOM ROOM 119B	119B	4'-0"	7'-0"	HM	PAINT	A	HM	PAINT	3	1/AS-710	2/AS-710	-	HW-4A	1 HR	1,2,3,4	
-	-	-	-	-	-	-	-	-	-	-	-	-	-	-	-	
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CINCINNATI - BUILDING TB																
TELECOM ROOM AXXX	AXXX	4'-0"	7'-0"	SC WD	STAIN	A	HM	PAINT	1	3/AS-710 SIM.	4/AS-710 SIM.	5C/AS-710	HW-4A	1 HR	1,2,3	
-	-	-	-	-	-	-	-	-	-	-	-	-	-	-	-	
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CINCINNATI - BUILDING TE																
TELECOM ROOM 105A	105A	4'-0"	7'-0"	SC WD	STAIN	A	HM	PAINT	1	3/AS-710 SIM.	3/AS-710 SIM.	5C/AS-710	HW-4A	1 HR	1,2,3	
-	-	-	-	-	-	-	-	-	-	-	-	-	-	-	-	
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FT. THOMAS - BUILDING 64																
TELECOM ROOM 027B	027B	4'-0"	7'-0"	SC WD	STAIN	A	HM	PAINT	1	1/AS-710	2/AS-710	5B/AS-710	HW-4A	1 HR	1,2,3	
TELECOM ROOM 134	134	4'-0"	7'-0"	SC WD	STAIN	A	HM	PAINT	1	1/AS-710 SIM.	2/AS-710 SIM.	-	HW-4A	1 HR	1,2,3,4	
TELECOM ROOM 220	220	4'-0"	7'-0"	SC WD	STAIN	A	HM	PAINT	1	3/AS-710	4/AS-710	-	HW-4A	1 HR	1,2,3,4	
TELECOM ROOM 313	313	4'-0"	7'-0"	SC WD	STAIN	A	HM	PAINT	1	3/AS-710	4/AS-710	-	HW-4A	1 HR	1,2,3,4	
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GENERAL NOTES:


1. FIELD VERIFY DIMENSIONS FOR EXISTING DOOR OPENINGS TO RECEIVE NEW DOOR/FRAME ASSEMBLIES.
2. ALL DOOR FRAMES TO BE HOSPITAL TYPE 6" WIDE UNLESS NOTED OTHERWISE.
3. ALL TELECOM ROOM DOOR ASSEMBLIES TO HAVE ELECTRIC STRIKE AND CARD READER AS INDICATED ON DRAWINGS AND WILL UTILIZE EXISTING OR NEWLY PROVIDED POWER.

REMARKS


1. NEW DOOR/FRAME ASSEMBLY IN EXISTING WALL OPENING. MODIFY WALL OPENING ACCORDINGLY.
2. PROVIDE POWER FOR CARD READER AND ELECTRIC STRIKE.
3. PAINT/STAIN DOOR AND/OR PAINT DOOR FRAME TO MATCH EXISTING ADJACENT.
4. FLUSH OUT DIS-SIMILAR FLOORS.
5. PROVIDE NEW LOCKSET (CLASSROOM TYPE).
6. PROVIDE REMOVABLE ASTRAGAL.

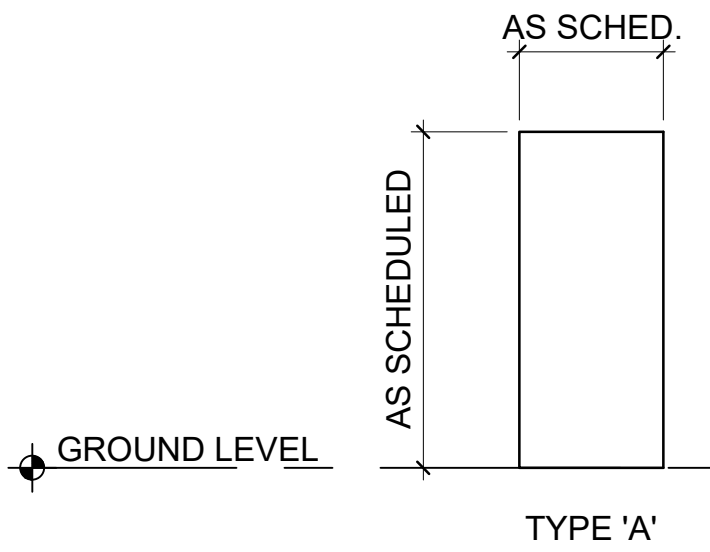

1 DOOR TYPES  
SCALE: 1/4" = 1'-0"

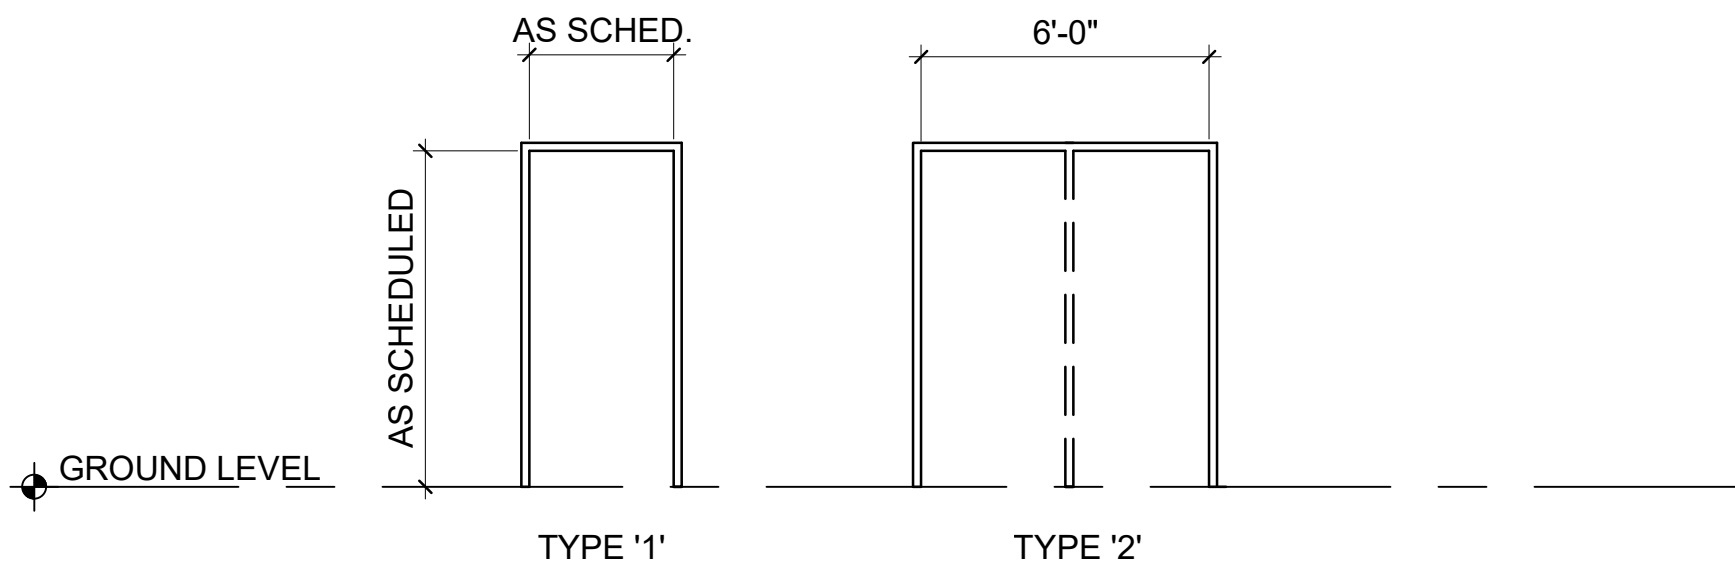



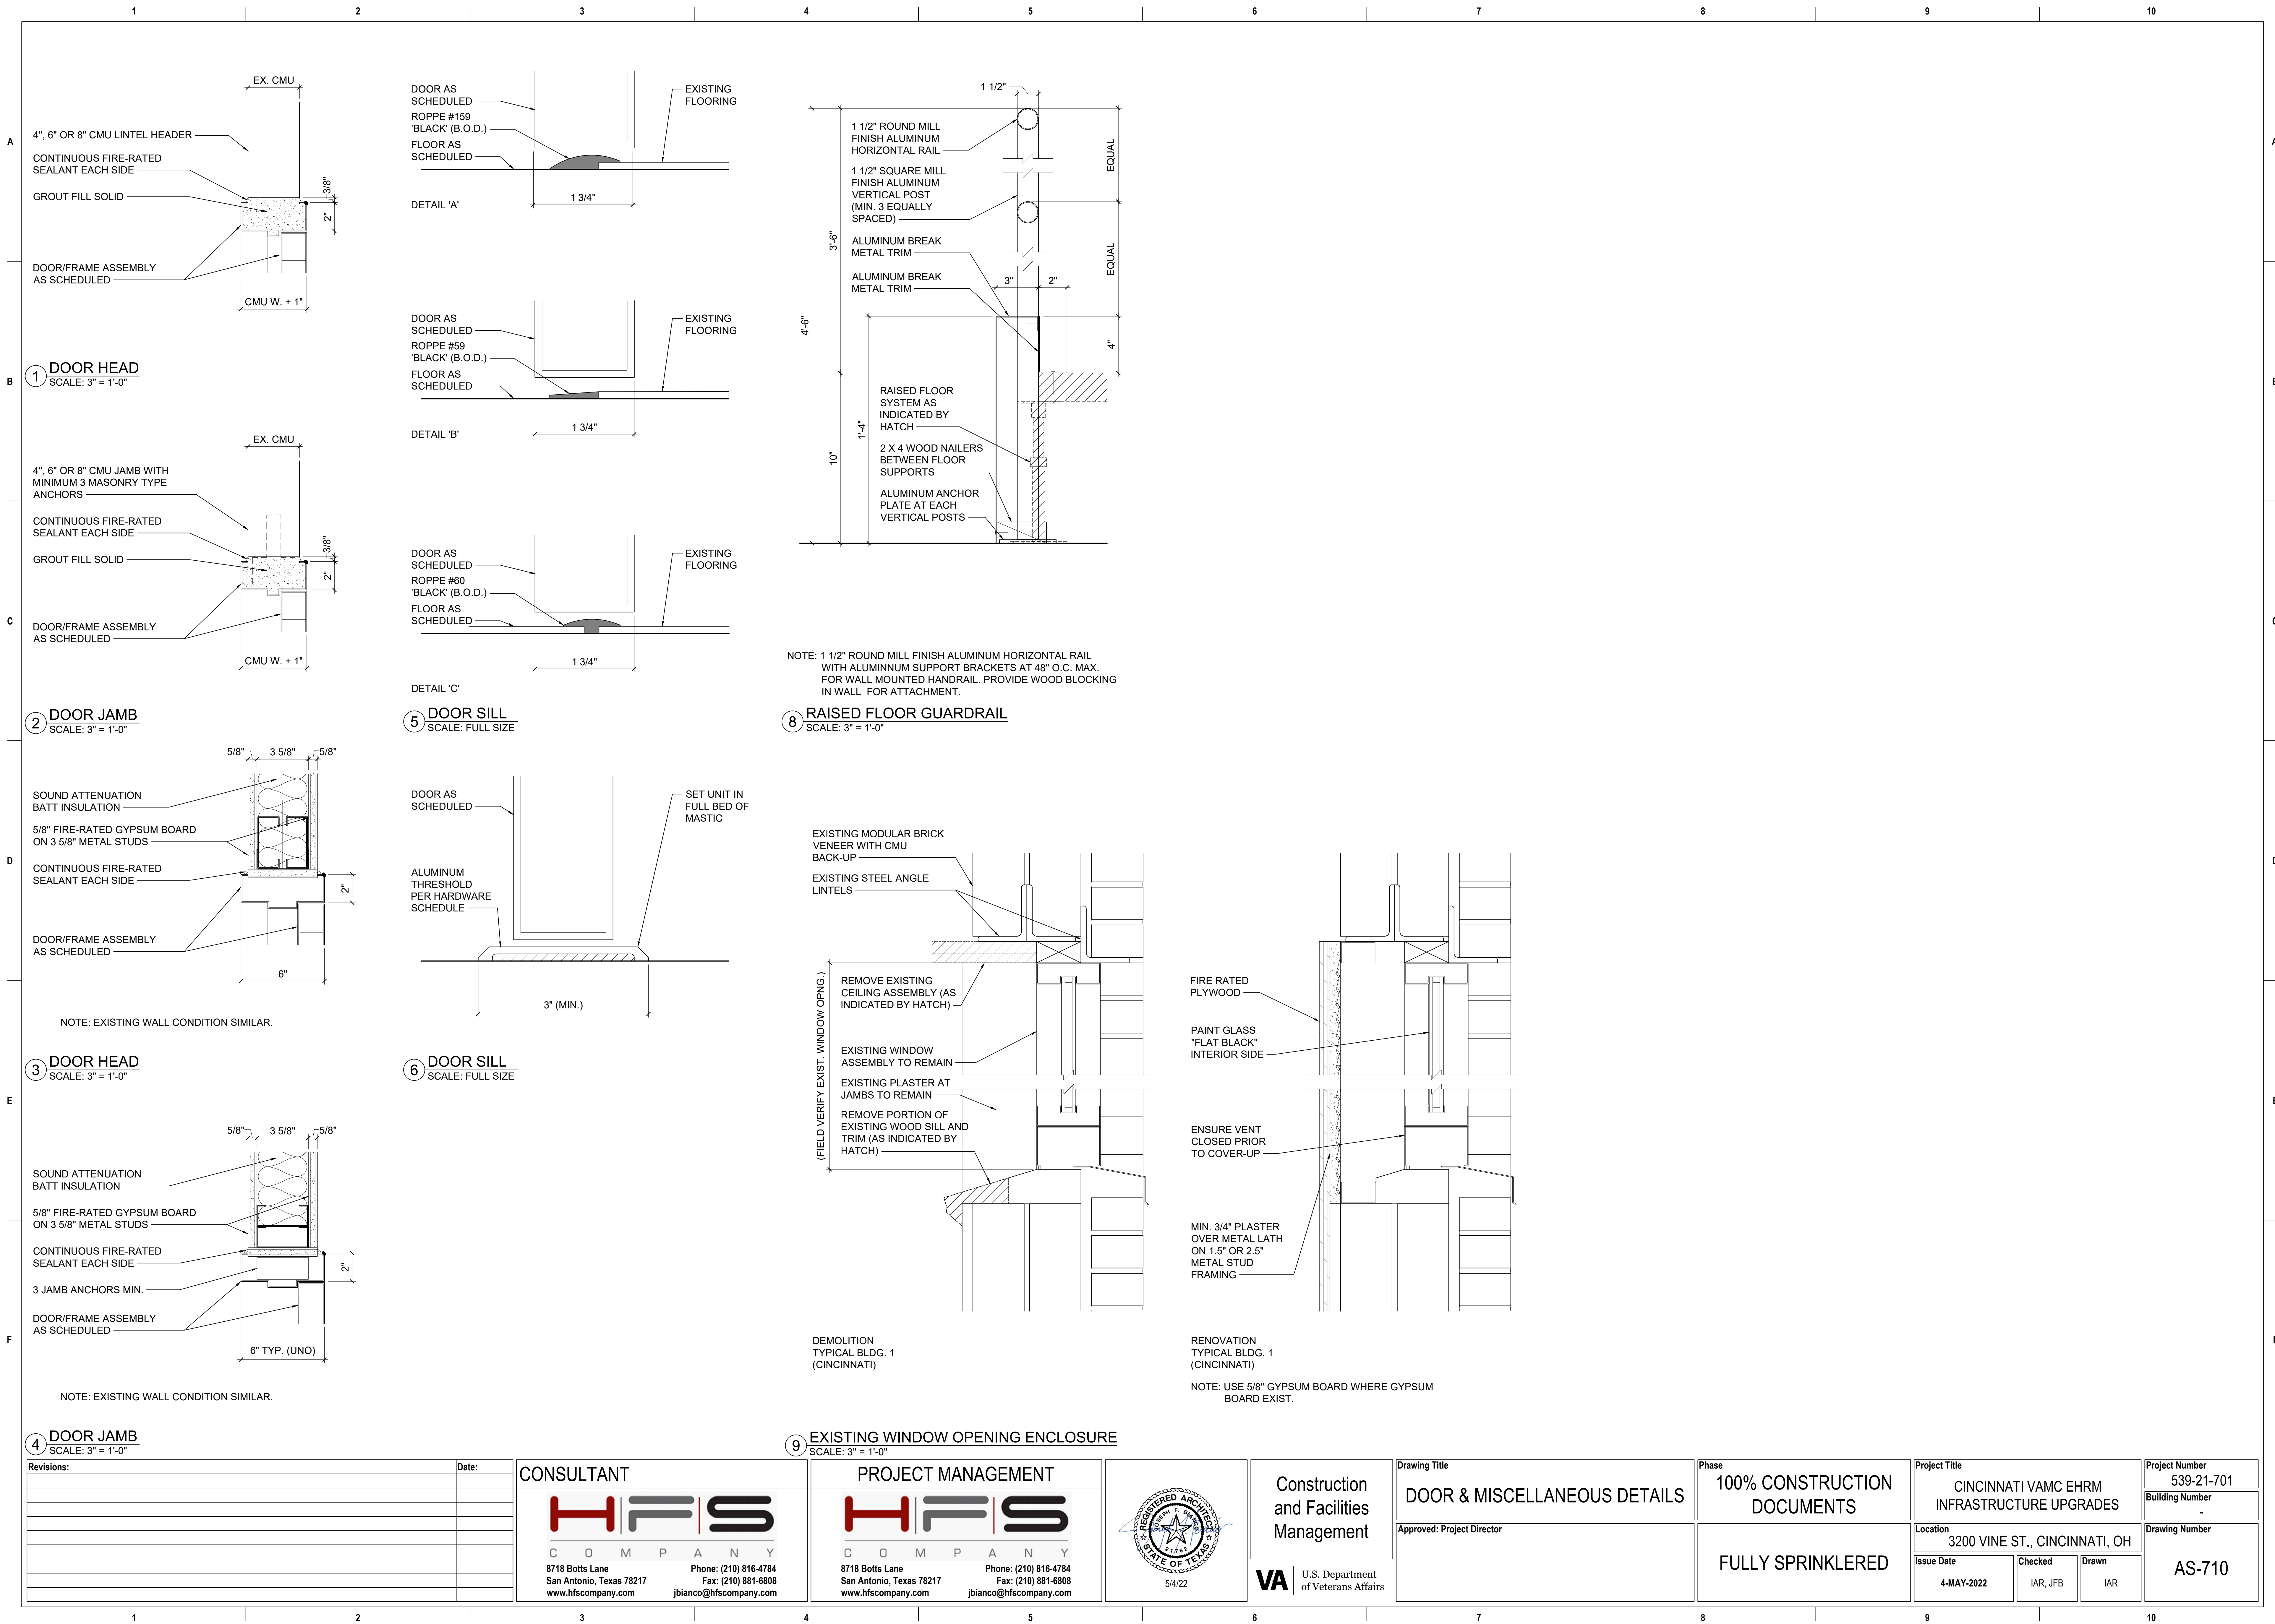



ROOM FINISH SCHEDULE										
ROOM NUMBER	ROOM NAME	FLOOR	BASE	NORTH	EAST	SOUTH	WEST	CEILING	WINDOW TREATMENT	REMARKS
CINCINNATI - BUILDING 1										
B021	TELECOM ROOM	SRT	RB	X-CMU/P	XCMU/P	X-CMU/P	XCMU/P	XEXS	-	-
A035	EXISTING TELEPHONE EQUIPMENT	XRT	XRБ	XCMU	XCMU	XCMU	XCMU	-	-	1
A0005	EXISTING ELECTRIC	X	X	X	X	X	X	XEXS	-	1,2,3
A134	EXISTING VENDING	XRT	XRБ/RB	XGYP	XGYP	XGYP	XGYP/GYP	XSAT	-	4,5
A134A	TELECOM ROOM	SRT	RB	XGYP/XCMU/P	XGYP/GYP	XGYP/XCMU/P	XGYP/XCMU/P	XEXS	-	-
A144A	TELECOM ROOM	SRT	RB	XGYP/P	XGYP/P	XGYP/P	XGYP/P	XEXS	-	-
B232	TELECOM ROOM	SRT	RB	XGYP/P	XGYP/P	XGYP/P	XGYP/P	XEXS	-	-
C236	EXISTING CONFERENCE ROOM	XCPT	XRБ/RB	XWC/XGYP	WC/GYP	XWC/XGYP	XWC/XGYP	XSAT/XGYP/GYP	-	6,7,8
C236A	TELECOM ROOM	SRT	RB	XGYP/P	XGYP/P	XGYP/P	XGYP/P	XEXS	-	-
A2008	EXISTING FACS READ	XRS	XRБ/RB	XGYP/GYP	XGYP	XGYP	XGYP	XSAT	-	9
A2008A	TELECOM ROOM	SRT	RB	XGYP/P	XGYP/P	XGYP/GYP/P	XGYP/P	XEXS	-	-
B312	EXISTING RESEARCH OFFICE	XRT	XRБ/RB	X	XGYP/GYP	XGYP	XGYP	XSAT	-	3
B312D	EXISTING TELECOM ROOM	SRT	RB	XGYP/P	XGYP/P	XGYP/GYP	GYP/P	XEXS	-	-
C*3*5	EXISTING CORRIDOR	X	XRБ/RB	XGYP/GYP	-	X	-	XSAT	-	10
C3006	TELECOM ROOM	SRT	RB	XGYP/P	XGYP	XGY/P	XGYP/P	XEXS	-	-
C310	EXISTING FAMILY WAITING	XCPT	XRБ/RB	XGYP	XGYP	XGYP/GYP	XGYP	XSAT	-	11
A383A	RESIDENT OFFICE/OVERNIGHT	LVT	RB	XGYP/GYP	XGYP	XGYP	XGYP	XSAT	-	12
C305	TELECOM ROOM	SRT	RB	XGYP	XGYP/XPL/P	XGYP/P	XGYP/P	XEXS	-	-
A441	TELECOM ROOM	SRT	RB	XCMU/P	XCMU/P	XCMU/P	XCMU	XEXS	-	-
A436	EXISTING SERVICE LOBBY	X	X/RB	XGYP/GYP/X	X	X	XGYP/GYP/X	XSAT	-	2,3,13
A437	EXISTING IRM NETWORK OPERATION CENTER	XRS	XRБ/RB	XGYP	XGYP/GYP	XGYP/GYP	X/GYP	XSAT	-	14, 15
C*4*1	EXISTING CORRIDOR	X	X	-	X	-	XGYP/GYP	X/GYP	-	3, 16
A437C	EXISTING COMPUTER ROOM	SRT/RFS	RB	XGYP/GYP	XGYP/GYP	XGYP/GYP	XGYP	XEXS	-	17
A540	TELECOM ROOM	SRT	RB	XCMU/P	XCMU/P/XPL/P	XCMU/P	XCMU/P	XEXS	-	-
A643	TELECOM ROOM	SRT	RB	XCMU/P	XCMU/XC/XPL/P	XCMU/P	XCMU/P	XEXS	-	-
A702A	STORAGE ROOM	LVT	RB	XGYP/GYP	XGYP/GYP	XGYP/GYP	XGYP/GYP	SAT	-	-
A704A	STORAGE ROOM	LVT	RB	XGYP	XGYP	XPL/P	GYP	SAT	-	-
A732A	TELECOM ROOM	SRT	RB	XGYP/GYP/P	XPL/P	XGYP/P	XCMU/P	XEXS	-	-
A838	TELECOM ROOM	SRT	RB	XCMU/XGYP/P	XGYP/XPL/P	XCMU/P	XCMU/P	XEXS	-	-
A916	EXISTING SERVICE LOBBY	X	X	XGMU	XGMU	X/PL	XPL/XGMU	XSAT/SAT/GYP	-	2, 18
A916A	TELECOM ROOM	SRT	RB	XCMU/P	XCMU/P	XCMU/XGMU	XPL	XEXS	-	-
A916D	EXISTING ELECTRIC	EXIST	EXIST	XCMU	XCMU	XCMU	XCMU	XEXS	-	1
-	-	-	-	-	-	-	-	-	-	-
CINCINNATI - BUILDING 2										
0001	TELECOM ROOM	SRT	RB	XGYP/P	XGYP/P	XCONC/P	XCONC/P	XEXS	-	19
1040	EXISTING LOUNGE	XCPT	XWD/WD	XGYP	XGYP/GYP	XGYP/GYP	XGYP	X/SAT	-	15,20
1040A	TELECOM ROOM	SRT	RB	GYP/P	XGYP/P	XGYP/P	GYP/P	XEXS	-	-
204	TELECOM ROOM	SRT	RB	XGYP	XGYP/P	XCONC/P	XGYP/P	XEXS	-	19
-	-	-	-	-	-	-	-	-	-	-
CINCINNATI - BUILDING 3										
1	EXISTING CONFERENCE ROOM	XRS	XRБ/RB	XGYP	XGYP	XGYP	GYP	XSAT	-	15, 21
13A	TELECOM ROOM	SRT	RB	XGYP/XCMU/P	GYF/P	XGYP/GYP/P	XGYP/GYP/P	XEXS	-	-
-	-	-	-	-	-	-	-	-	-	-
-	-	-	-	-	-	-	-	-	-	-
-	-	-	-	-	-	-	-	-	-	-
-	-	-	-	-	-	-	-	-	-	-
CINCINNATI - BUILDING 8										
205	TELECOM ROOM	SRT	RB	XGYP/P	XGYP/P	XGYP/P	XGYP/GYP/P	XEXS	-	-
-	-	-	-	-	-	-	-	-	-	-
-	-	-	-	-	-	-	-	-	-	-
-	-	-	-	-	-	-	-	-	-	-
-	-	-	-	-	-	-	-	-	-	-
-	-	-	-	-	-	-	-	-	-	-
CINCINNATI - BUILDING 15										
101	EXISTING ROOM	XRF	XRFB	CMU	XCMU	XCMU	XCMU	XEXS	-	22
119B	TELECOM ROOM	SRT	RV	XCMU/P	XCMU/P	CMU/P	XCMU/P	XEXS	-	-
-	-	-	-	-	-	-	-	-	-	-
-	-	-	-	-	-	-	-	-	-	-
-	-	-	-	-	-	-	-	-	-	-
CINCINNATI - BUILDING TB										
1	EXISTING HALL 1	XCPT	XRБ/RB	GYP	X	X	GYP	XSAT	-	21
2	EXISTING HALL 2	XCPT	XRБ/RB	-	GYP	X	-	XSAT	-	21
A035	EXISTING BREAK AREA	XCPT	XRБ/RB	-	X	X/GYP	-	XSAT	-	21
3	EXISTING TELECOM ROOM	SRT	RB	XGP/GYP/P	XGYP/GYP/P	GYP/P	GYP/P	XEXS	-	-
-	-	-	-	-	-	-	-	-	-	-
CINCINNATI - BUILDING TE										
-	EXISTING CORRIDOR	XCPT	RB	X/GYP	-	X	X	XSAT	-	23
105	EXISTING CONFERENCE	XCPT	XRБ/RB	X	X	X	GYP	XSAT	-	21
105A	TELECOM ROOM	SRT	RB	X/P	GYP/P	X/GYP	X/P	XEXS	-	-
-	-	-	-	-	-	-	-	-	-	-
-	-	-	-	-	-	-	-	-	-	-
FORT THOMAS - BUILDING 64										
027B	TELECOM ROOM	SRT	RB	XCMU/P	XCMU/P	XCMU/P	XCMU/P	XEXS	-	-
1	EXISTING CORRIDOR	XRT	XRБ/RB	-	X	-	XGYP/GYP	XSAT	-	24
2	EXISTING CORRIDOR	XRT	XRБ/RB	XGYP/GYP	-	X	-	XSAT	-	24
134	TELECOM ROOM	SRT	RB	XPL/P	XPL/P	XPL/P	XPL/P	XEXS	-	-
220	TELECOM ROOM	SRT	RB	GYP/P	XGYP/P	XGYP/GYP/P	XGYP/P	XEXS	-	-
220A	EXISTING WORKOUT ROOM	XAF	XRf/RB	XGYP/GYP	XGYP	GYP	XGYP	SAT	-	21
313	TELECOM ROOM	SRT	RB	XGYP/P	XGYP/GYP/P	XGYP/GYP/P	XGYP/P	XEXS	-	-
-	-	-	-	-	-	-	-	-	-	-
-	-	-	-	-	-	-	-	-	-	-
-	-	-	-	-	-	-	-	-	-	-
FORT THOMAS - BUILDING 117										
103	EXISTING GARAGE	X	X	X	X	X	X	X	-	25
-	-	-	-	-	-	-	-	-	-	-
-	-	-	-	-	-	-	-	-	-	-
-	-	-	-	-	-	-	-	-	-	-
-	-	-	-	-	-	-	-	-	-	-

FINISH ABBREVIATIONS:

FLOOR

SRT

XRT

X

XCPT

LVT

RFS

XRS

XRF

XAF

BASE

RB

XRБ

X

XWD

WD

XRFB

WALLS

XCMU

P

X

XGYP

GYP

XPL

PL

XGMU

XCONC

CEILINGS

XEXS

XSAT

SAT

EXTERIOR

BRICK

MORTAR

STATIC RESILIENT TILE  
EXISTING RESILIENT TILE VCT OR SIM. (TO REMAIN U.N.O)  
EXISTING UNIDENTIFIED FLOOR (TO REMAIN U.N.O)  
EXISTING CARPET (TO REMAIN U.N.O)  
LUXURY VINYL TILE  
RAISED FLOOR SYSTEM  
EXISTING RESILIENT STRIP FLOOR (TO REMAIN U.N.O)  
EXISTING RESINOUS FLOOR  
EXISTING ATHLETIC FLOOR (TO REMAIN U.N.O)

RUBBER (4" TYPICAL U.N.O)  
EXISTING RUBBER BASE (TO REMAIN U.N.O)  
EXISTING UNIDENTIFIED BASE (TO REMAIN U.N.O)  
EXISTING WOOD BASE (TO REMAIN U.N.O)  
WOOD BASE  
EXISTING RESINOUS FLOOR BASE

EXISTING CONCRETE MASONRY UNITS  
FIRE RATED PLYWOOD  
EXISTING UNIDENTIFIED WALL FINISH (TO REMAIN U.N.O)  
EXISTING GYPSUM BOARD (TO REMAIN U.N.O)  
GYPSUM BOARD (PAINTED U.N.O)  
EXISTING PLASTER (TO REMAIN U.N.O)  
PLASTER (INTERIOR)  
EXISTING GLAZED MASONRY UNIT  
EXISTING CONCRETE

EXISTING EXPOSED STRUCTURE  
EXISTING 2X2 SUSPENDED ACOUSTICAL (TO REMAIN U.N.O)  
SUSPENDED ACOUSTICAL TILE SYSTEM

MODULAR BRICK TO MATCH EXISTING (WHERE NOTED)  
MORTAR TO MATCH EXISTING

GENERAL NOTES:

- AT ALL ROOMS LISTED, UNLESS NOTED OTHERWISE, PROVIDE NEW BASE IN ENTIRE ROOM.
- AT ALL ROOMS LISTED, UNLESS NOTED OTHERWISE, ALL WALLS (NEW OR EXISTING) SHALL BE PAINTED.
- AT ALL ROOMS LISTED, UNLESS NOTED OTHERWISE, ALL EXPOSED STRUCTURE CEILINGS SHALL NOT BE PAINTED.
- PAINT/STAIN COLOR AND TEXTURE, UNLESS NOTED OTHERWISE, SHALL MATCH IMMEDIATE ADJACENT/NEARBY EXISTING.
- PROVIDE FLOOR TRANSITION STRIP, UNLESS NOTED OTHERWISE, WHERE DISSIMILAR FLOORS MEET AT DOORWAYS.
- REFERENCE PLAN DRAWING SHEETS FOR EXISTING WINDOW INTERIOR MODIFICATIONS.

REMARKS:

- DO NOT PAINT WALLS.
- FIELD VERIFY EXISTING UNIDENTIFIED FLOOR AND BASE FINISHES.
- FIELD VERIFY EXISTING UNIDENTIFIED WALL FINISHES.
- AT ENTIRE WEST WALL PROVIDE ALL NEW BASE TO MATCH EXISTING.
- ONLY PAINT ENTIRE WEST WALL TO MATCH EXISTING.
- PROVIDE 6" RUBBER BASE TO MATCH EXISTING NEW WALL.
- EXISTING/NEW GYPSUM BOARD FUR-DOWN.
- PROVIDE WALL COVERING TO MATCH EXISTING OVER GYPSUM BOARD.
- PAINT AND PROVIDE NEW BASE ( NORTH WALL ONLY TO MATCH EXISTING)
- PROVIDE NEW BASE TO MATCH EXISTING AT WORK AREAS ONLY.
- PROVIDE NEW RUBBER BASE (6") TO MATCH EXISTING, ENTIRE FAR SOUTH WALL ONLY.
- PROVIDE NEW 6" RUBBER BASE AT ENTIRE ROOM.
- PROVIDE NEW RUBBER BASE AT ENTIRE WALLS COMMON TO EXISTING COMPUTER ROOM A437C.
- PROVIDE NEW 6" RUBBER BASE AT NEW WALL CONSTRUCTION ONLY.
- PAINT NEW WALLS ONLY.
- GYPSUM BOARD FUR-DOWN AT DOOR AT DOOR A437 ALCOVE.
- SRT AND RB AT FLOOR LEVEL 4 AREAS ONLY.
- PAINT ONLY NEW GYPSUM BOARD FUR-DOWN AND MISCELLANEOUS NEW CONSTRUCTION.
- DO NOT PAINT EXISTING CONCRETE WALLS.
- PROVIDE NEW WOOD BASE TO MATCH EXISTING NEW WALLS ONLY.
- PROVIDE RUBBER BASE TO MATCH EXISTING WALL ONLY.
- NO BASE AT NEW NORTH WALL.
- PROVIDE NEW BASE TO MATCH EXISTING ENTIRE NORTH WALL.
- PROVIDE NEW BASE TO MATCH EXISTING WALL COMMON TO TELECOM ROOM 313.
- NO FINISHES WORK THIS ROOM.

FINISH MATERIAL SCHEDULE										
FINISH CODE	MATERIAL TYPE	BASIS OF DESIGN	MFGR. NO.	PATTERN	COLOR	SIZE	GROUT	REMARKS	OTHER	
FLOORS										
SRT	STATIC RESISTANT TILE	ARMSTRONG	51953	-	PEARL WHITE	12"X12"	-	EXCELON SDT	-	
LVT	LUXURY VINYL TILE	ARMSTRONG	NA193	STAGGERED	VIENNA SMOKE	12"X36"	-	AVILA OAK DESIGN/PLANK	-	
RFS	RAISED FLOOR SYSTEM	COMX	-	-	HPL/CX-2201-1	24"X24"	-	CONCRETE FILLED STEEL PANEL	STEEL ACCESS FLOOR SYSTEM	
-	-	-	-	-	-	-	-	-	-	
-	-	-	-	-	-	-	-	-	-	
BASE										
RB	RUBBER BASE	ROPPE	700 SERIES	-	MATCH EXISTING	VARIES	-	-	-	
WD	WOOD BASE	-	-	-	PAINT	-	-	PAINT TO MATCH EXISTING	-	
-	-	-	-	-	-	-	-	-	-	
-	-	-	-	-	-	-	-	-	-	
-	-	-	-	-	-	-	-	-	-	
WALLS										
P	3/4" FIRE-RATED PLYWOOD	-	-	-	PAINT	-	-	PAINT WITH 2 COATS FIRE RATED PAINT	PAINT	
GYP	GYPSUM BOARD	NATIONAL GYPSUM	-	-	-	5/8"	-	NON-RATED, FIRE RATED & MOISTURE RESISTANT	-	
PL	PLASTER (INTERIOR)	USG	-	-	-	3/4"	-	INTERIOR PLASTER	-	
-	-	-	-	-	-	-	-	-	-	
-	-	-	-	-	-	-	-	-	-	
CEILINGS										
SAT	SUSP. ACOUST. TILE/GRID	ARMSTRONG	928	FINE FISSURED	WHITE/SQUARE EDGE	24"X24"	-	PRELUDE XL 15/16" GRID SYSTEM	"FLAT WHITE"	
GYP	GYPSUM BOARD	NATIONAL GYPSUM	-	-	-	5/8"	-	NON-RATED	-	
-	-	-	-	-	-	-	-	-	-	
-	-	-	-	-	-	-	-	-	-	
-	-	-	-	-	-	-	-	-	-	
EXTERIOR										
BRICK	FACE BRICK	-	-	MODULAR	MATCH EXISTING	-	-	NO SPECIFICATION PROVIDED	-	
MORTAR	EXTERIOR BRICK MORTAR	-	-	MATCH EXIST.	MATCH EXISTING	3/8"	-	NO SPECIFICATION PROVIDED	-	
-	-	-	-	-	-	-	-	-	-	
-	-	-	-	-	-	-	-	-	-	
-	-	-	-	-	-	-	-	-	-	

NOTE: COLOR SELECTIONS NOTED SUBJECT TO CHANGE. ALL FINAL COLOR SELECTIONS NOTED ON THIS SCHEDULE OR ANYWHERE ELSE ON DRAWINGS ARE TO BE APPROVED BY



FIRE STOPPING NOTES

1. MATERIALS: USE ONLY FIRE STOP PRODUCTS THAT HAVE BEEN UL 1479, ASTM E-814, OR UL 2079 TESTED FOR SPECIFIC FIRE RATE CONSTRUCTION CONDITIONS CONFORMING TO CONSTRUCTION ASSEMBLY TYPE, PENETRATING ITEM TYPE, ANNULAR SPACE REQUIREMENTS, AND FIRE RATING INVOLVED FOR EACH SEPARATE INSTANCE.
2. FOR SINGLE PENETRATIONS: A READY-TO-USE LATEX BASED INTUMESCENT SEALANT IS REQUIRED TO MAINTAIN THE FIRE RATING OF THE ASSEMBLY PENETRATED. THE SEALANT MUST HAVE UL LISTING FOR BOTH SLEEVED AND NON-SLEEVED APPLICATIONS.
3. FOR LARGE OPENINGS: CONTAINING MULTIPLE PENETRATIONS (2 OR MORE), A READY-TO-USE FOAM INTUMESCENT BLOCK MATERIAL MUST BE ABLE TO BE REMOVED AND REINSTALLED WITHOUT COMPROMISING FIRE PROTECTION INTEGRITY. COMPLY WITH MANUFACTURER'S RECOMMENDED PROCEDURES AND PRECAUTIONS. DO NOT USE DAMAGED OR EXPIRED MATERIALS.
4. MANUFACTURERS: JOHNS MANVILLE INTERNATIONAL, 3M BRAND, CSO SEALING SYSTEMS, HILTI, OSHA-SEIGY, HEAVY-DUTY/NEALSON. REFER TO DIVISION 7 FOR FURTHER REQUIREMENTS.

FIRE PROTECTION SYMBOLS & ABBREVIATIONS

NOT ALL SYMBOLS ARE USED FOR THIS PROJECT

	AIR VENT (AUTOMATIC)
	DOUBLE CHECK VALVE ASSEMBLY
	DRY PIPE VALVE
	ELECTRONIC SUPERVISED INDICATING VALVE
	FIRE DEPARTMENT VALVE (FDV)
	FLOW SWITCH
	PREACTION VALVE
	PRESSURE RELIEF VALVE
	SOLENOID VALVE
	DRAIN LINE
	DRY PIPE
	FIRE MAIN (BULK)
	SPRINKLER MAIN/BRANCH PIPING
	SPRINKLER PIPING TO BE REMOVED
	DRIP CONNECTION
	FIRE DEPARTMENT CONNECTION-FREE STANDING
	FIRE DEPARTMENT CONNECTION-WALL MOUNT
	FLUSH TYPE FIRE DEPARTMENT INLET CONNECTION
	FIRE PUMP TEST HEADER-WALL MOUNT
	FIRE PUMP TEST HEADER-FREE STANDING
	EXISTING SPRINKLER HEAD
	EXISTING SPRINKLER HEAD TO BE REMOVED
	SPRINKLER HEAD (SEE SCHEDULE FOR TYPE)
	SIDEWALL SPRINKLER HEAD (SEE SCHEDULE FOR TYPE)
	AIR COMPRESSOR
	DOUBLE CHECK VALVE
	DRY PIPE VALVE
	DRY STANDPIPE PIPING
	DRY STANDPIPE VALVE
	FIRE DEPARTMENT CONNECTION
	FIRE DEPARTMENT VALVE
	FIRE EXTINGUISHER CABINET
	FIRE HOSE CABINET
	FIRE PUMP
	FIRE PUMP CONTROLLER
	FIRE PUMP TEST HEADER
	JOCKEY PUMP
	JOCKEY PUMP CONTROLLER
	AUTOMATIC SPRINKLER
	NO AUTOMATIC SPRINKLERS
	POST INDICATOR VALVE
	TAMPER SWITCH

FIRE PROTECTION DEMOLITION NOTES

1. ALL PIPING HANGERS AND SUPPORTS SHALL BE REMOVED ALONG WITH THE PIPING.
2. PROTECT PIPING WHICH IS NOT TO BE REMOVED FROM DAMAGE, DIRT AND DEBRIS.
3. ALL FIRE EQUIPMENT AND MATERIALS NOT CLAIMED BY THE OWNER SHALL BE REMOVED FROM THE PREMISES AND PROPERLY DISPOSED OF BY THE DEMOLITION CONTRACTOR.
4. THE CONTRACTOR SHALL PLUG OR CAP ALL PIPING OUTLETS NOT INTENDED FOR REUSE.
5. CEILING REMOVAL, STORAGE, AND REPLACEMENT WILL BE MADE BY THE CONTRACTOR AND IT IS THE RESPONSIBILITY OF THIS CONTRACTOR TO REPAIR THE EXISTING SURFACES TO REMAIN WHERE THEIR WORK HAS BEEN COMPLETED. REPAIR INCLUDES BUT SHALL NOT BE LIMITED TO: ANY EXISTING WALL, CEILING, OR FLOOR THAT IS SCHEDULED TO REMAIN, REPAIR, PAINTING, AND PATCHING SHALL BE COMPLETED BY AN APPROPRIATE CONTRACTOR QUALIFIED FOR THIS TYPE OF WORK. IF HAZARDOUS MATERIALS ARE ENCOUNTERED DURING DEMOLITION OPERATIONS, THE CONTRACTOR WILL NOTIFY BUILDING OWNER OF THE HAZARDOUS MATERIAL.
6. ARCHITECTURAL, TECHNOLOGY, PLUMBING, ELECTRICAL, AND MECHANICAL DEMOLITION DRAWINGS AND SPECIFICATIONS SHALL BE READ IN CONJUNCTION WITH THESE DRAWINGS.
7. THE CONTRACTOR SHALL COORDINATE DEMOLITION WORK WITH PROJECT 'S PHASING SCHEDULE PRIOR TO ANY WORK.

HAZARD GROUP AND DENSITY REQUIREMENTS

- A. TELECOM ROOMS AND DATA ROOMS TO BE PROVIDED WITH A DENSITY OF 0.1 GPM/SQ.FT. OVER THE HYDRAULIC REMOTE 1500 SQ.FT. (LIGHT HAZARD) WITH A HOSE STREAM ALLOWANCE OF 100 GPM.
- B. STORAGE ROOMS TO BE PROVIDED WITH A DENSITY OF 0.20 GPM/SQ.FT. OVER THE HYDRAULIC REMOTE 1,500 SQ. FT. (ORDINARY HAZARD GROUP 2) WITH A HOSE STREAM ALLOWANCE OF 250 GPM.
- C. CORRIDORS/ BREAKROOMS/ OFFICES/ AND OTHER ROOMS ALIKE SHALL BE PROVIDED WITH A DENSITY OF 0.10 GPM/ SQ.FT. (LIGHT HAZARD) OVER THE HYDRAULIC REMOTE 1500 SQ.FT. WITH A HOSE STREAM ALLOWANCE OF 100 GPM.

FIRE PROTECTION GENERAL NOTES

1. ALL WORK SHALL BE PERFORMED, INSTALLED, AND TESTED IN COMPLIANCE WITH THE CODES AND AMENDMENTS ADOPTED BY THE INSPECTION AUTHORITY. NOTHING IN THESE PLANS IS TO BE CONSTRUCTED TO PERMIT WORK NOT CONFORMING TO THESE CODES OR OTHERS APPLICABLE TO THIS PROJECT:
- A. VA FIRE PROTECTION DESIGN MANUAL VERSION 8
- B. 2018-INTERNATIONAL BUILDING CODE (IBC)
- C. OCCUPATIONAL SAFETY AND HEALTH ACT (OSHA)
- D. NATIONAL FIRE PROTECTION ASSOCIATION EDITIONS LISTED IN THE IBC OR MOST CURRENT EDITIONS OF THE FOLLOWING:
- a. NFPA 13
- b. NFPA 2001
- c. NFPA 75
2. THE WORK CONSISTS OF FURNISHING ALL LABOR AND MATERIALS NECESSARY TO INSTALL, COMPLETE AND READY CONTINUOUS OPERATION, THE FIRE PROTECTION SYSTEMS, APPARATUS AND EQUIPMENT FOR THIS PROJECT. AS SHOWN REQUIRED BY THE CONTRACT DOCUMENTS, PLUS AS REQUIRED BY NFPA 13 AND THE AUTHORITY HAVING JURISDICTION (AHJ).
3. THE CONTRACTOR SHALL INCLUDE IN THEIR BID, A FULLY CODE COMPLIANT AND COORDINATED SPRINKLER SYSTEM. PROJECT SHALL BE DESIGNED, CONSTRUCTED AND TESTED PER THE NFPA STANDARDS AND VA FIRE PROTECTION DESIGN MANUAL VERSION 8 REQUIREMENTS.
4. ALL SYSTEMS, EQUIPMENT, AND MATERIALS ARE TO BE INSTALLED IN A NEAT WORKMAN LIKE MANNER, WORK NOT DONE SO SHALL BE REMOVED AND REINSTALLED SATISFACTORILY.
5. THE FIRE PROTECTION BID IS A DESIGN/BUILD CONTRACT. BEFORE SUBMITTING THE BID, THE CONTRACTOR SHALL VISIT THE SITE AND BECOME THOROUGHLY FAMILIAR WITH ALL EXISTING CONDITIONS AND VERIFY LOCATIONS, ELEVATIONS, AND SIZES OF ALL UTILITIES AT SITE PRIOR TO PROCEEDING WITH WORK. THE CONTRACTOR SHALL BE HELD RESPONSIBLE FOR ANY ASSUMPTIONS, OMISSIONS, OR ERRORS MADE AS A RESULT OF THE FAILURE TO BECOME FULLY FAMILIAR WITH EXISTING CONDITIONS. EXISTING SYSTEMS AND STRUCTURE SHALL BE INVESTIGATED FOR BEST POSSIBLE ROUTING OF FIRE PROTECTION PIPING.
6. WHEN PLACING NEW SPRINKLERS AND ROUTING NEW SPRINKLER PIPING, CONTRACTOR SHALL VERIFY LOCATIONS OF POTENTIAL OBSTRUCTIONS FROM MECHANICAL EQUIPMENT AND ARCHITECTURAL FEATURES PRIOR TO BID AND PRICE ACCORDINGLY TO MAKE ALLOWANCES IN BID.
7. THE CONTRACTOR SHALL SUBMIT ALL DRAWINGS AND CALCULATIONS TO THE FIRE DEPARTMENT, GOVERNING AGENCIES, AND INSURING AGENCY AND RECEIVE APPROVAL PRIOR TO SUBMITTING DESIGN SHOP DRAWINGS.
8. SUBMIT ACCURATE AS-BUILT DRAWINGS TO THE ENGINEER AND OWNER.
9. IF THIS CONTRACTOR DOES NOT CLEARLY UNDERSTAND THESE PLANS OR IS NOT COMPLETELY SURE OF THEIR MEANING, THIS CONTRACTOR SHOULD OBTAIN THE ENGINEER 'S WRITTEN EXPLANATION AND/OR INTERPRETATION PRIOR TO SUBMITTING BIDS, SINCE THIS CONTRACTOR WILL BE HELD RIGIDLY TO THE INTERPRETATION OF THE ENGINEER.
10. THESE PLANS ARE DIAGRAMMATIC IN NATURE SINCE THE ONLY AVAILABLE INFORMATION HAS BEEN OBTAINED FROM EXISTING PLANS, SPECIFICATIONS, AND FILED SURVEYS. THE EXACT LOCATION OF PIPING AND EQUIPMENT MAY DEViate FROM THE LOCATION INDICATED BY THESE DRAWINGS. EXTREME ACCURACY IS NOT GUARANTEED. THIS CONTRACTOR SHALL BE PREPARED TO MAKE ALTERATIONS TO NEW AND/OR EXISTING SERVICES TO TIGHTEN CONDITIONS. THIS CONTRACTOR SHALL REPORT, IN WRITING, ANY DISCREPANCIES WHICH PREVENT THE INSTALLATION OF WORK AS SHOWN.
11. IT IS ASSUMED THAT AREAS OUTSIDE THE SCOPE OF WORK ARE TESTED, MAINTAINED, AND MEET THE CODE REQUIREMENTS WHEN IT WAS INSTALLED, AND THE EXISTING SYSTEM IS ACCEPTED BY THE LOCAL AHJ. WORK PERFORMED WITHIN SCOPE OF WORK WILL PROVIDE A SYSTEM TO MEET THE REQUIREMENTS SET BY THE AHJ LIMITED BY THE BOUNDARY OF WORK.
12. THE SPRINKLER CONTRACTOR PRIOR TO TIME OF BID SHALL EVALUATE THE SITE AND VERIFY ALL SPRINKLER PIPING AND EQUIPMENT THAT IS EXISTING TO REMAIN WITHIN OR SERVING THE SCOPE OF WORK, IS IN GOOD WORKING CONDITION.
13. FURNISH AND INSTALL TAMPER SWITCHES ON ALL INDICATING VALVES AND FLOW SWITCHES PER NFPA 13 REQUIREMENTS AND PER THE DESIGN DOCUMENTS BY THE CONTRACTOR.
14. THE CONTRACTOR SHALL FURNISH DRAIN VALVES AND INSPECTOR 'S TEST CONNECTIONS AS REQUIRED BY NFPA REQUIREMENTS AND AT THE DISCRETION OF THE FIRE MARSHAL, ENGINEER OR GOVERNING AGENCY.
15. ALL OPENINGS THROUGH FIRE RATED FLOORS, WALLS, OR PARTITIONS SHALL BE FIRE STOPPED WITH UL RATED ASSEMBLIES OF EQUAL OR GREATER FIRE RATING. REFER TO FIRE STOPPING NOTES FOR ADDITIONAL INFORMATION.
16. COORDINATE WITH STRUCTURAL ENGINEER WHEN SAW-CUTTING OR CORE DRILLING HOLES THROUGH CONCRETE FLOOR OR WALL CONSTRUCTION. LEAVE SUFFICIENT REBAR EXPOSED TO TIE NEW REINFORCING REPLACEMENT CONCRETE AND/OR OTHER STRUCTURAL ATTACHMENTS FOR NEW CONSTRUCTION.
17. VALVES, TAMPER SWITCHES, OR ANY MECHANICAL/ELECTRICAL ITEM SHALL NOT BE LOCATED ABOVE A HARD CEILING, UNLESS PROVIDED WITH EQUIVALENTLY RATED ACCESS AND SIGNAGE MEETING NFPA 13 REQUIREMENTS.
18. SPRINKLERS SHALL BE LOCATED IN THE CENTER OF CEILING TILES, COORDINATE FINAL LAYOUT WITH ARCHITECT, AND OTHER DISCIPLINES.
19. EXTENDED COVERAGE SPRINKLERS ARE NOT PERMITTED. CONTRACTOR SHALL VERIFY ADDITIONAL PRESSURE REQUIREMENTS IF THIS TYPE IS SELECTED.
20. THE SPRINKLER CONTRACTOR SHALL OBTAIN AND UTILIZE THE ARCHITECTURAL REFLECTED CEILING PLAN FOR THE LOCATING OF SPRINKLER HEADS. REFER TO MECHANICAL AND ELECTRICAL DRAWINGS FOR CEILING DEVICE LOCATIONS AND THE SPECIFICATIONS FOR COORDINATION DRAWING REQUIREMENTS.
21. PIPING SHALL BE INSTALLED ABOVE FINISHED CEILING ELEVATION TO ALLOW FOR SUITABLE ACCESS ABOVE CEILING.
22. INSTALL NO PIPING IN A LOCATION OR MANNER WHICH WILL ALLOW FREEZING.
23. COORDINATE PIPE ROUTING NEAR ELECTRICAL EQUIPMENT PER NFPA 70. PIPING IS NOT TO BE ROUTED ABOVE ELECTRICAL PANELS, TRANSFORMERS, COMPUTER RACKS ETC. FIELD VERIFY AND COORDINATE WITH ELECTRICAL CONTRACTOR ALL EXISTING AND NEW ELECTRICAL LOCATIONS PRIOR TO DESIGN OF THE FIRE PROTECTION PLANS.
24. ROUTING OF SPRINKLER MAINS, BRANCHLINES, AND HEADS SHALL BE THOROUGHLY COORDINATED WITH ALL OTHER DISCIPLINES AND BUILDING STRUCTURE PRIOR TO SUBMISSION OF COORDINATED SHOP DRAWINGS. THIS IS OF THE UTMOST IMPORTANCE ESPECIALLY WHERE SPACE IS LIMITED. FIRE PROTECTION CONTRACTOR IS RESPONSIBLE FOR COORDINATING, PREPARING, AND SUBMITTING COORDINATION DRAWINGS FOR APPROVAL/REVIEW.
25. ADVISE THE ENGINEERS OF ANY CONFLICTS, ERRORS, OMISSIONS, ETC. AT LEAST 10 DAYS PRIOR TO BID DATE, TO ALLOW CLARIFICATION BY WRITTEN ADDENDUM.
26. IF SEISMIC BRACING IS REQUIRED, FIRE PROTECTION CONTRACTOR SHALL FURNISH AND INSTALL ALL END OF BRANCH LINE RESTRAINTS PER NFPA 13 SECTION.
27. WHEN WORK REQUIRES TEMPORARY INTERRUPTIONS OF FIRE PROTECTION SERVICES OR UTILITIES THE FOLLOWING ACTIONS WILL BE TAKEN:
- A. COORDINATION WITH MAINTENANCE PERSONNEL TO SHUT OF SERVICES AT NEAREST MAIN.
- B. PROVIDE TEMPORARY AND ACCESSIBLE ISOLATION VALVES CLOSE TO THE POINT OF WORK.
- C. ENSURE BUILDING OPERATIONS CONTINUE WITH MINIMAL INTERRUPTIONS AND OPERATION OF EXISTING SYSTEMS BE INTERFACED WITH AS LITTLE DISRUPTION AS POSSIBLE EXCEPT IN VACATED AREAS.
- D. WORK INTERFERING WITH OPERATION OF DOWNTIME WILL BE SCHEDULED AFTER CONSULTATION WITH AND PERMISSION GIVEN BY OWNER 10 DAYS PRIOR TO ANTICIPATED INTERRUPTION OF SYSTEMS.
- E. SUCH WORK MAY BE REQUIRED TO BE PERFORMED OUTSIDE OF NORMAL WORKING HOURS.
- F. REFER TO FIRE WATCH NOTES FOR DISRUPTION OF FIRE SPRINKLER SYSTEMS IN OCCUPIED BUILDINGS WHEN DISRUPTION EXCEEDS 4 HOURS.
28. SPRINKLERS INSTALLED WITHIN TELECOM ROOMS AND DATA CENTER ARE TO BE STANDARD RESPONSE TYPE AND PROVIDED WITH PROTECTIVE CAGES.
29. REMOVE ALL PORTIONS OF THE BUILDING (CEILING TILES, WALLS, SPRINKLER HEADS, SPRINKLER HEAD ESCUTCHEON, ECT.) AS REQUIRED TO COMPLETE THE SCOPE INDICATED IN THE CONSTRUCTION DOCUMENTS (SEE ARCHITECTURAL, TECHNOLOGY, MECHANICAL, ELECTRICAL, AND PLUMBING DRAWINGS). REPLACE, REINSTALL, OR COORDINATE INSTALLATION WITH OTHER TRADES FOR ALL ITEMS REMOVED TO ACCOMMODATE THE INSTALLATION/ REMOVALS OF ANY SPRINKLER PIPE, SPRINKLER HEAD, PLUMBING PIPE, FIXTURE, EQUIPMENT, OR OTHER TRADES WORK. USING WORKERS QUALIFIED IN THE APPROPRIATE TRADE. REPLACE CEILING TILES DAMAGED WITH THIS WORK TO MATCH, REPAIR WALLS BACK TO THE ORIGINAL FINISH.
30. FIRE PROTECTION CONTRACTOR SHALL PROVIDE ONE OF THE FOLLOWING AFTER HOURS OF NORMAL WORK TIME:
- A. EXISTING SPRINKLERS WITHIN WORK AREAS.
- B. TEMPORARY SPRINKLER PROTECTION THROUGHOUT THE WORK AREA.
- C. COMBINATION OF EXISTING SPRINKLER AND TEMPORARY SPRINKLER PROTECTION THROUGHOUT WORK AREA.
- D. A FIRE WATCH.
31. ANY UNUSED SPRINKLER PIPING WITHIN NEW/ REMODELED TELECOM AND DATA ROOMS SHALL BE REMOVED TO A POINT OUTSIDE OF ROOM AND CAPPED.
32. ARCHITECTURAL, TECHNOLOGY PLUMBING, MECHANICAL, AND ELECTRICAL DEMOLITION AND NEW WORK PLANS/ DRAWINGS SHALL BE READ IN CONJUNCTION WITH THESE DRAWINGS.
33. SPRINKLERS INSTALLED WITHIN TELECOM ROOMS AND DATA CENTER ARE TO BE STANDARD RESPONSE TYPE AND PROVIDED WITH PROTECTIVE CAGES.

Revisions:	Date:

CONSULTANT


Ross & Baruzzini

6 SOUTH OLD ORCHARD  
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F: 314.918.1786

ARCHITECT/ENGINEER OF RECORD

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Construction  
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Management

VA U.S. Department  
of Veterans  
Affairs

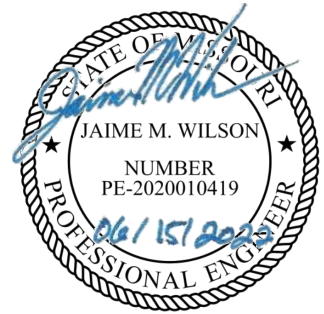Drawing Title
FIRE PROTECTION SYMBOLS AND ABBREVIATIONS
Approved: Project Director

Phase
100% CONSTRUCTION DOCUMENTS
FULLY SPRINKLED

Project Title
CINCINNATI VAMC EHRM INFRASTRUCTURE UPGRADES
Location
3200 VINE ST. CINCINNATI, OH.
Issue Date
15-JUNE-2022
Checked
JA
Drawn
DDP
Project Number
539-21-701
Building Number
Drawing Number
FP-000





1 FIRE PROTECTION - BUILDING #1 - OVERALL BASEMENT PLAN  
1/16" = 1'-0"

Revisions:	Date:

CONSULTANT

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6 SOUTH OLD ORCHARD  
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F: 314.918.1766


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Construction and Facilities Management

**VA** U.S. Department of Veterans Affairs

Drawing Title

FIRE PROTECTION BASEMENT OVERALL PLAN

Approved: Project Director

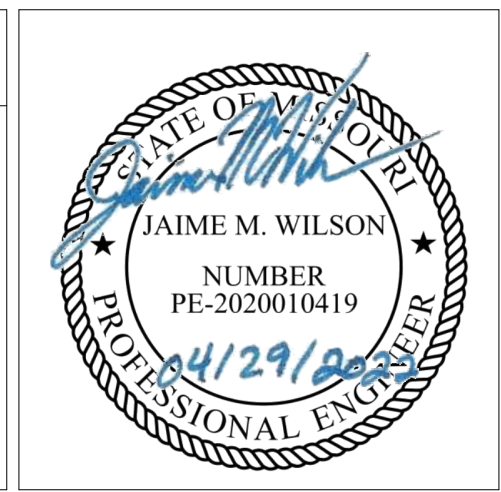Phase

100% CONSTRUCTION DOCUMENTS

FULLY SPRINKLED

Project Title

CINCINNATI VAMC EHRM INFRASTRUCTURE UPGRADES

Location

3200 VINE ST. CINCINNATI, OH.

Issue Date

04-MAY-2022

Checked

JA

Drawn

DDP

Project Number

539-21-701

Building Number

1

Drawing Number

FP-110-C.1.B




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Revisions:	Date:

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<b>Ross &amp; Baruzzini</b>
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Construction and Facilities Management
U.S. Department of Veterans Affairs

Drawing Title
FIRE PROTECTION FIRST FLOOR OVERALL PLAN
Approved: Project Director


Phase
100% CONSTRUCTION DOCUMENTS
FULLY SPRINKLED

Project Title
CINCINNATI VAMC EHRM INFRASTRUCTURE UPGRADES
Location
3200 VINE ST. CINCINNATI, OH.
Issue Date
04-MAY-2022
Checked
JA
Drawn
DDP

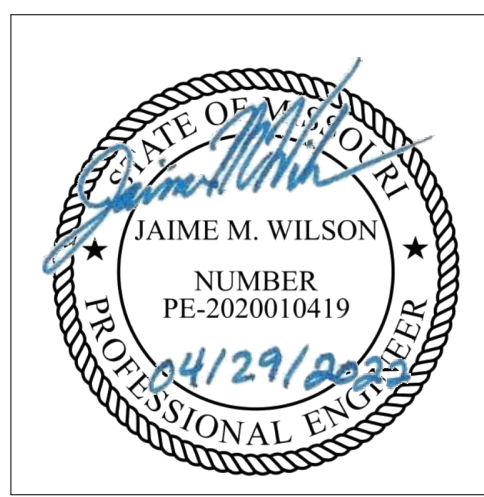Project Number
539-21-701
Building Number
1
Drawing Number
FP-120-C.1.1



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1 FIRE PROTECTION - BUILDING #1 -  
OVERALL SECOND FLOOR PLAN  
1/16" = 1'-0"

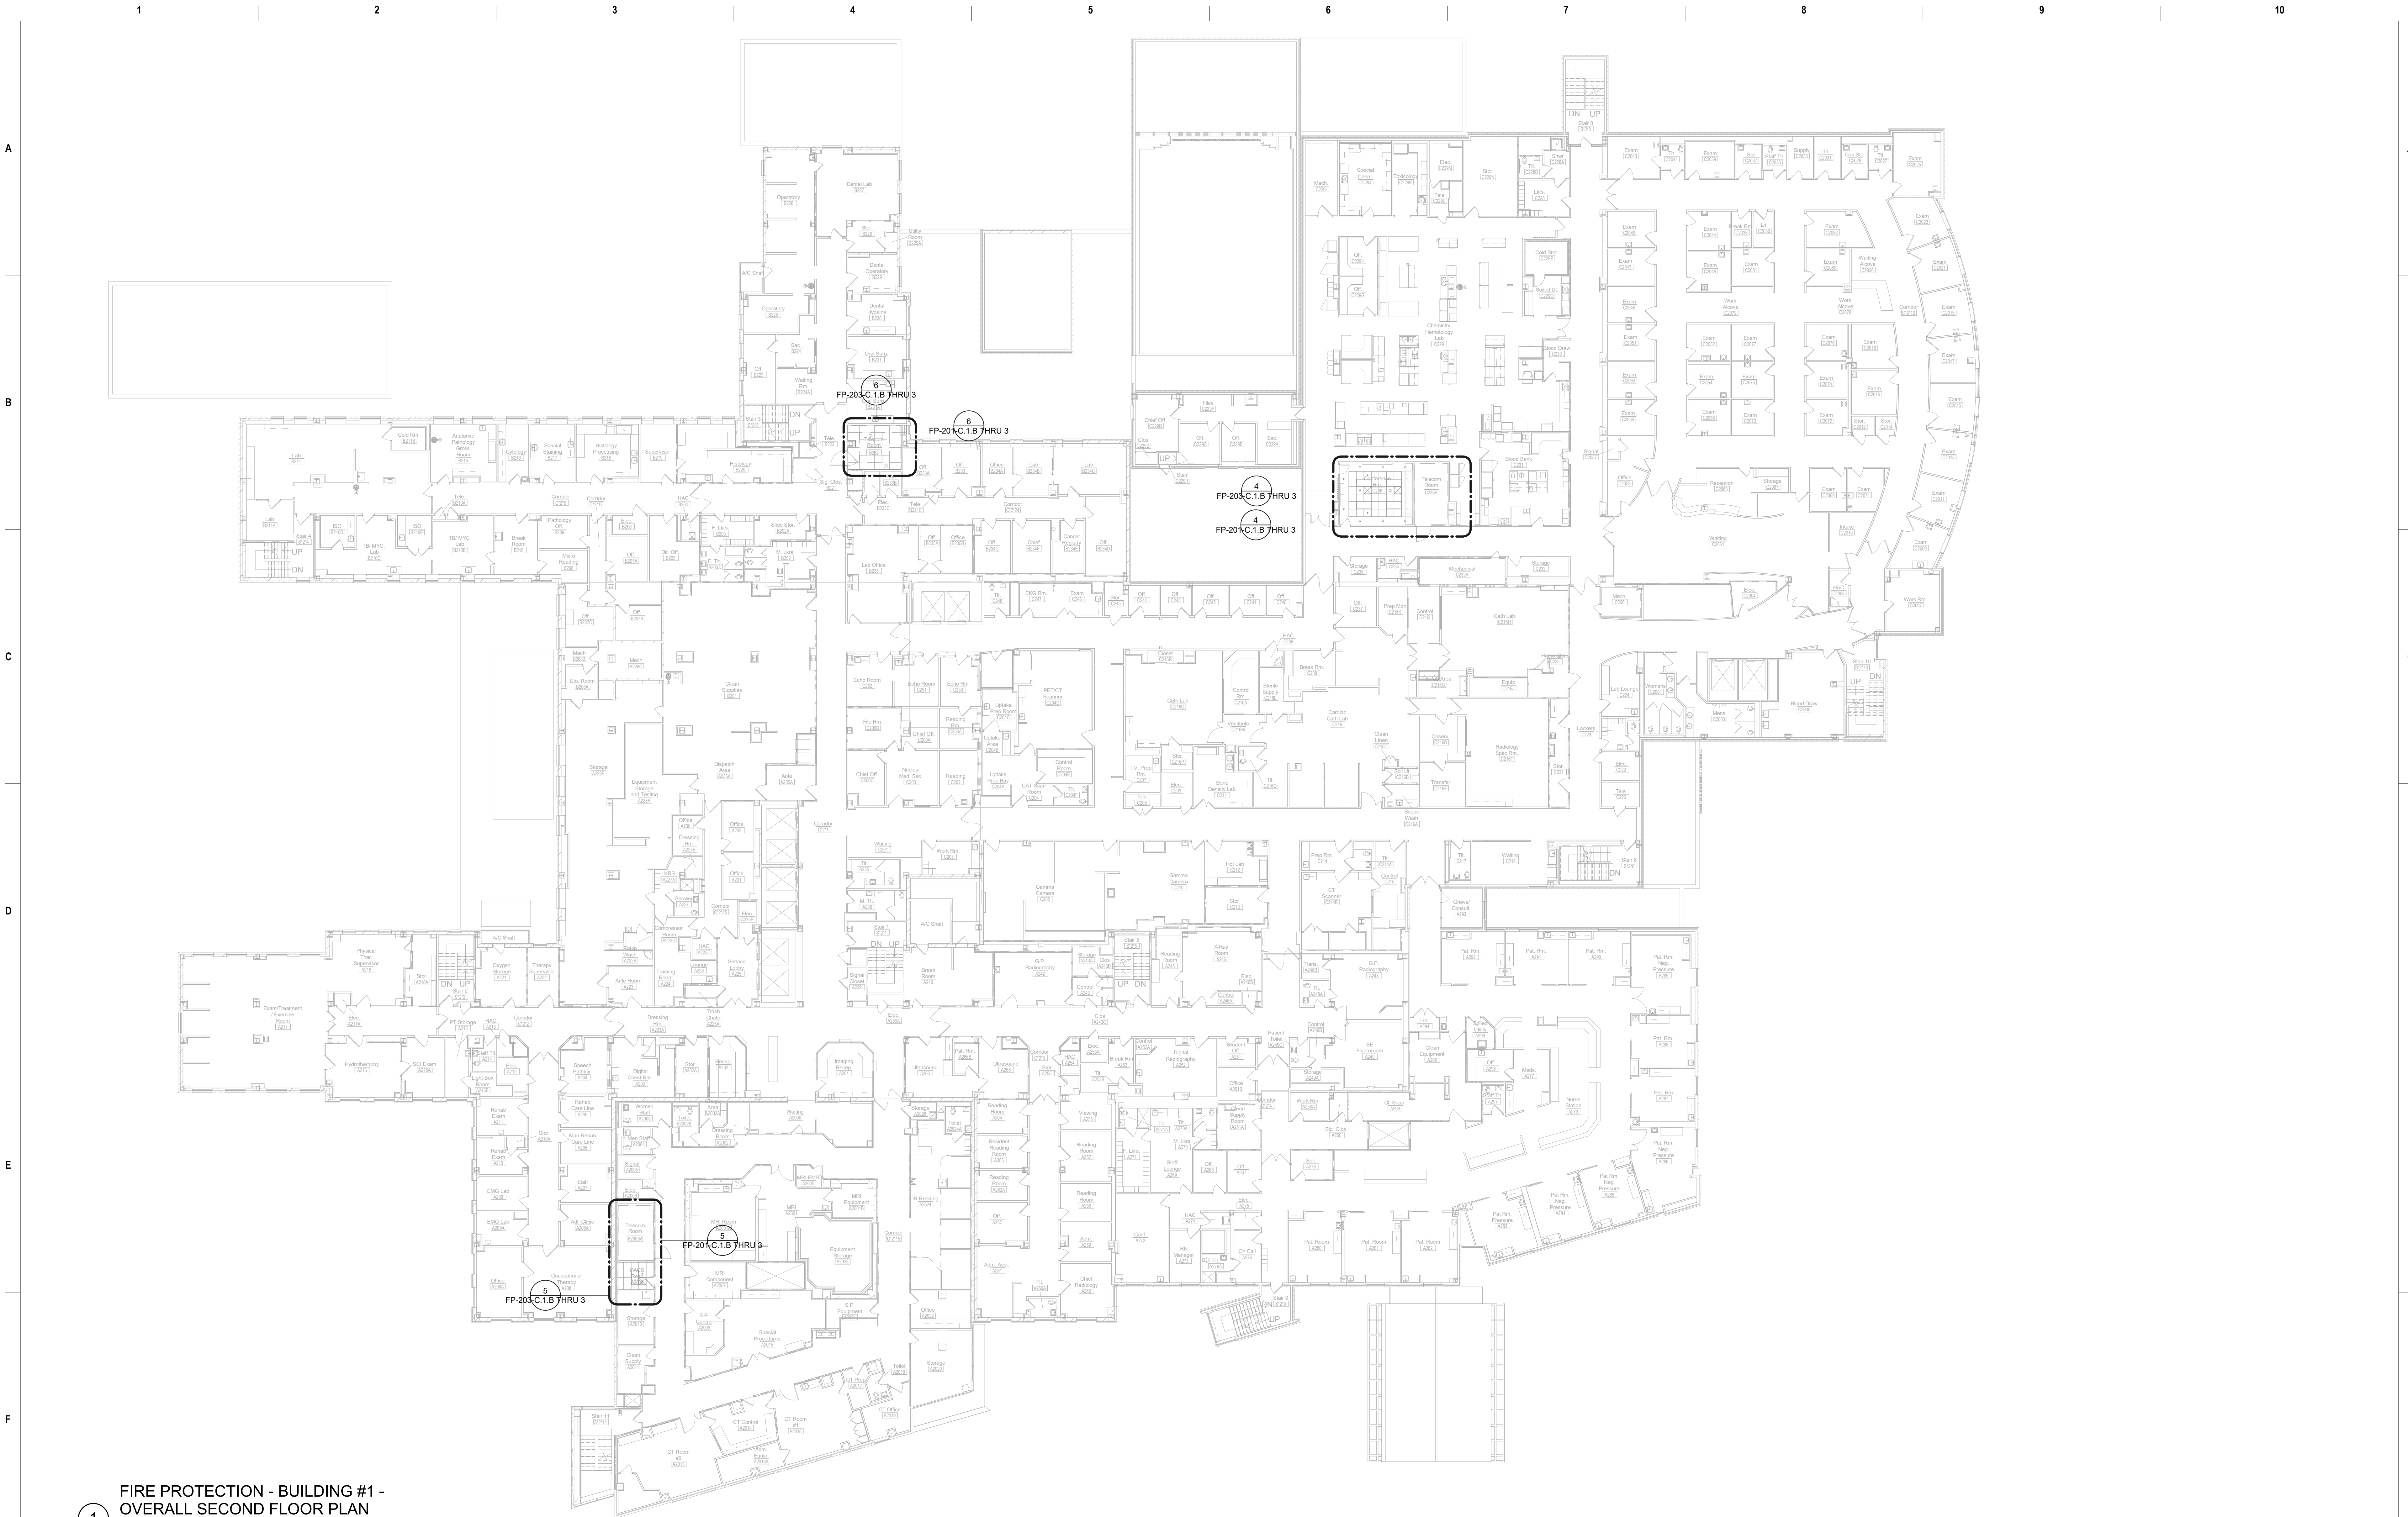Revisions:	Date:

CONSULTANT

**Ross & Baruzzini**


6 SOUTH OLD ORCHARD  
WEBSTER GROVES, MO 63119  
P: 314.918.8383  
F: 314.918.1766

ARCHITECT/ENGINEER OF RECORD

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Construction  
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Management

**VA** U.S. Department  
of Veterans  
Affairs

Drawing Title

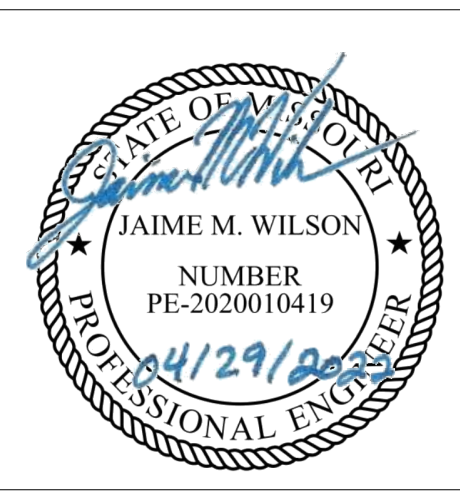FIRE PROTECTION SECOND FLOOR  
OVERALL PLAN

Approved: Project Director

Phase

100% CONSTRUCTION  
DOCUMENTS

FULLY SPRINKLED

Project Title

CINCINNATI VAMC EHRM  
INFRASTRUCTURE UPGRADES

Location

3200 VINE ST. CINCINNATI, OH.

Issue Date

04-MAY-2022

Checked

JA

Drawn

DDP

Project Number

539-21-701

Building Number

1

Drawing Number

FP-130-C.1.2






1 FIRE PROTECTION - BUILDING #1 -  
OVERALL THIRD FLOOR PLAN  
1/16" = 1'-0"

Revisions:		Date:	CONSULTANT		ARCHITECT/ENGINEER OF RECORD		Drawing Title		Phase		Project Title		Project Number	
			<b>Ross &amp; Baruzzini</b>		<b>HFS</b>		FIRE PROTECTION THIRD FLOOR OVERALL PLAN		100% CONSTRUCTION DOCUMENTS		CINCINNATI VAMC EHRM INFRASTRUCTURE UPGRADES		539-21-701	
			6 SOUTH OLD ORCHARD WEBSTER GROVES, MO 63119 P: 314.918.8383 F: 314.918.1766		C O M P A N Y 8718 Botts Lane San Antonio, Texas 78217 www.hfscmpany.com jbianco@hfscmpany.com		Approved: Project Director		FULLY SPRINKLED		Location 3200 VINE ST. CINCINNATI, OH.		Building Number 1	
											Issue Date 04-MAY-2022		Checked JA	
											Drawn DDP		Drawing Number FP-140-C.1.3	



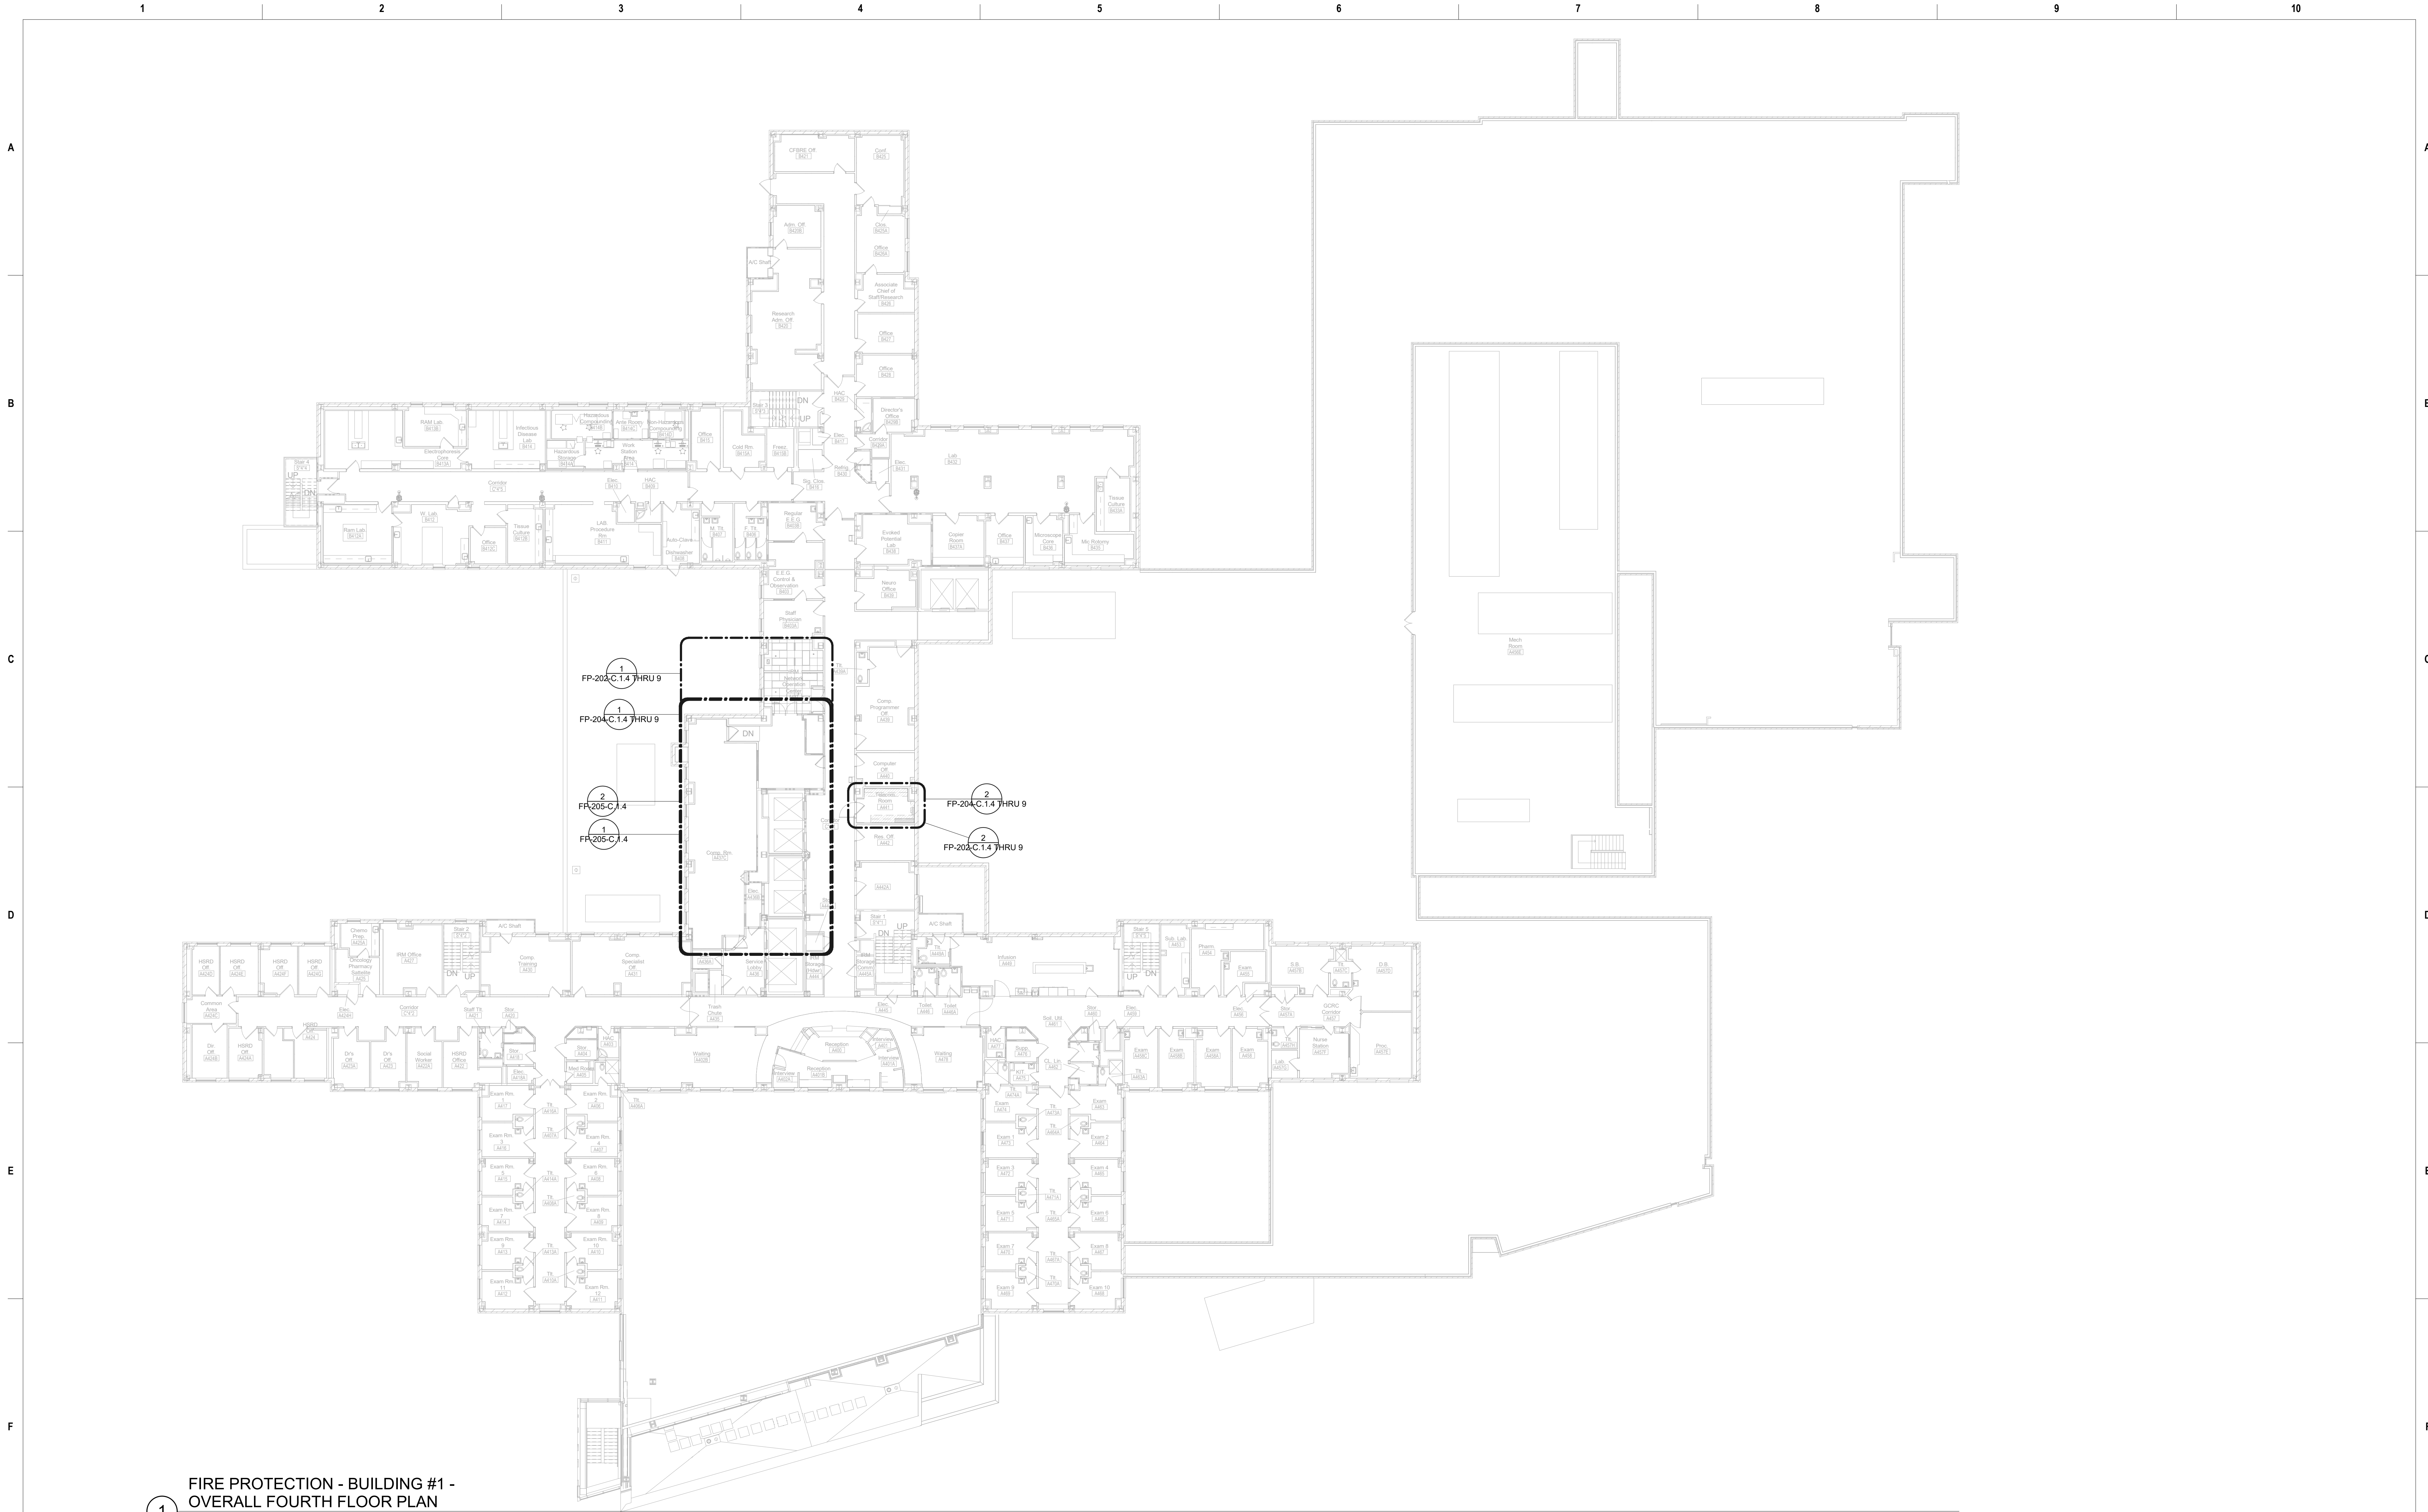


1 FIRE PROTECTION - BUILDING #1 -  
OVERALL FOURTH FLOOR PLAN  
1/16" = 1'-0"

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Revisions:		Date:	CONSULTANT		ARCHITECT/ENGINEER OF RECORD		Drawing Title		Phase		Project Title		Project Number	
			<b>Ross &amp; Baruzzini</b>		<b>HFS</b>		FIRE PROTECTION FOURTH FLOOR OVERALL PLAN		100% CONSTRUCTION DOCUMENTS		CINCINNATI VAMC EHRM INFRASTRUCTURE UPGRADES		539-21-701	
			6 SOUTH OLD ORCHARD WEBSTER GROVES, MO 63119 P: 314.918.8383 F: 314.918.1766		C O M P A N Y 8718 Botts Lane San Antonio, Texas 78217 www.hfscompany.com jbianco@hfscompany.com		Approved: Project Director		FULLY SPRINKLED		Location 3200 VINE ST. CINCINNATI, OH.		Building Number 1	
											Issue Date 04-MAY-2022		Checked JA	
											Drawn DDP		Drawing Number FP-150-C.1.4	



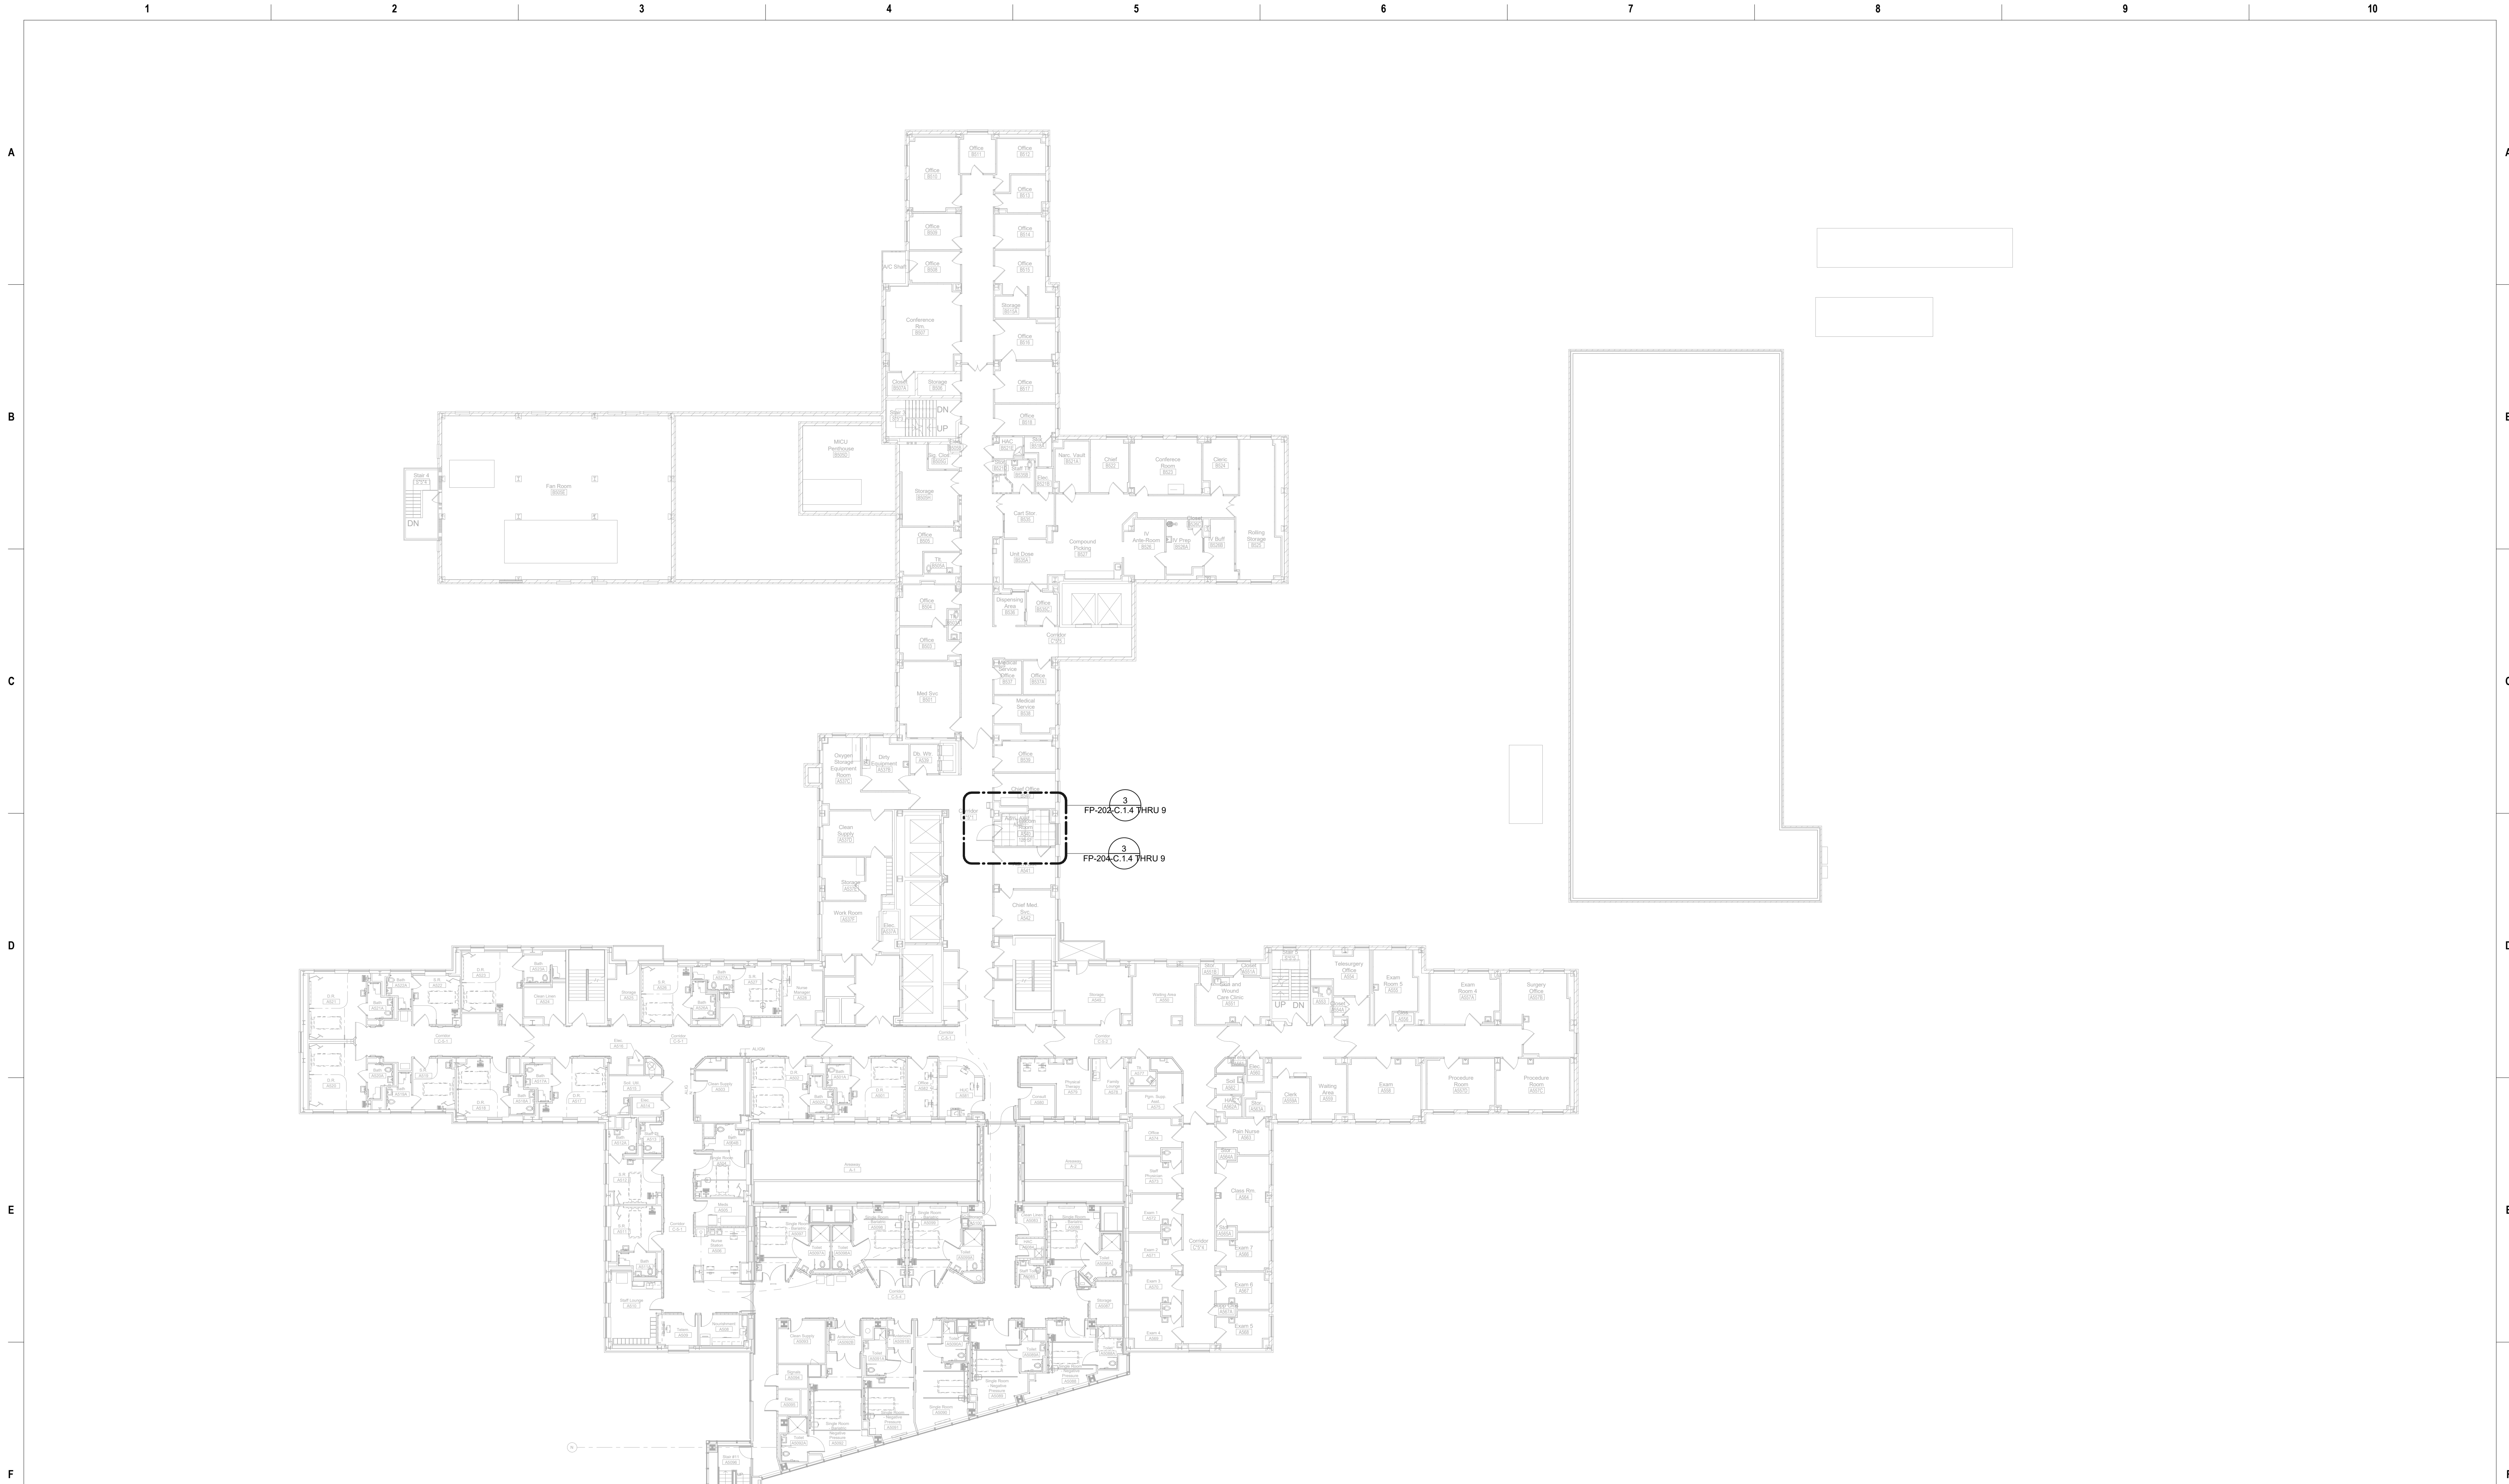


1 FIRE PROTECTION - BUILDING #1 -  
OVERALL FIFTH FLOOR PLAN  
1/16" = 1'-0"

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Revisions:		Date:	CONSULTANT		ARCHITECT/ENGINEER OF RECORD		Drawing Title		Phase		Project Title		Project Number					
			<div>Ross &amp; Baruzzini</div> <div>6 SOUTH OLD ORCHARD WEBSTER GROVES, MO 63119 T: 314.918.8383 F: 314.918.1766</div>		<div>HFS</div> <div>C O M P A N Y</div> <div>8718 Botts Lane San Antonio, Texas 78217 www.hfscorporation.com jbianco@hfscorporation.com</div> <div>Phone: (210) 816-4784 Fax: (210) 881-6808</div>		<div>Construction and Facilities Management</div> <div>VA U.S. Department of Veterans Affairs</div>		FIRE PROTECTION FIFTH FLOOR OVERALL PLAN		100% CONSTRUCTION DOCUMENTS		CINCINNATI VAMC EHRM INFRASTRUCTURE UPGRADES		539-21-701			
		Building Number 1																
		Drawing Number																
		FP-160-C.1.5																
							Approved: Project Director		FULLY SPRINKLED		Location 3200 VINE ST. CINCINNATI, OH.		Issue Date 04-MAY-2022		Checked JA		Drawn DDP	



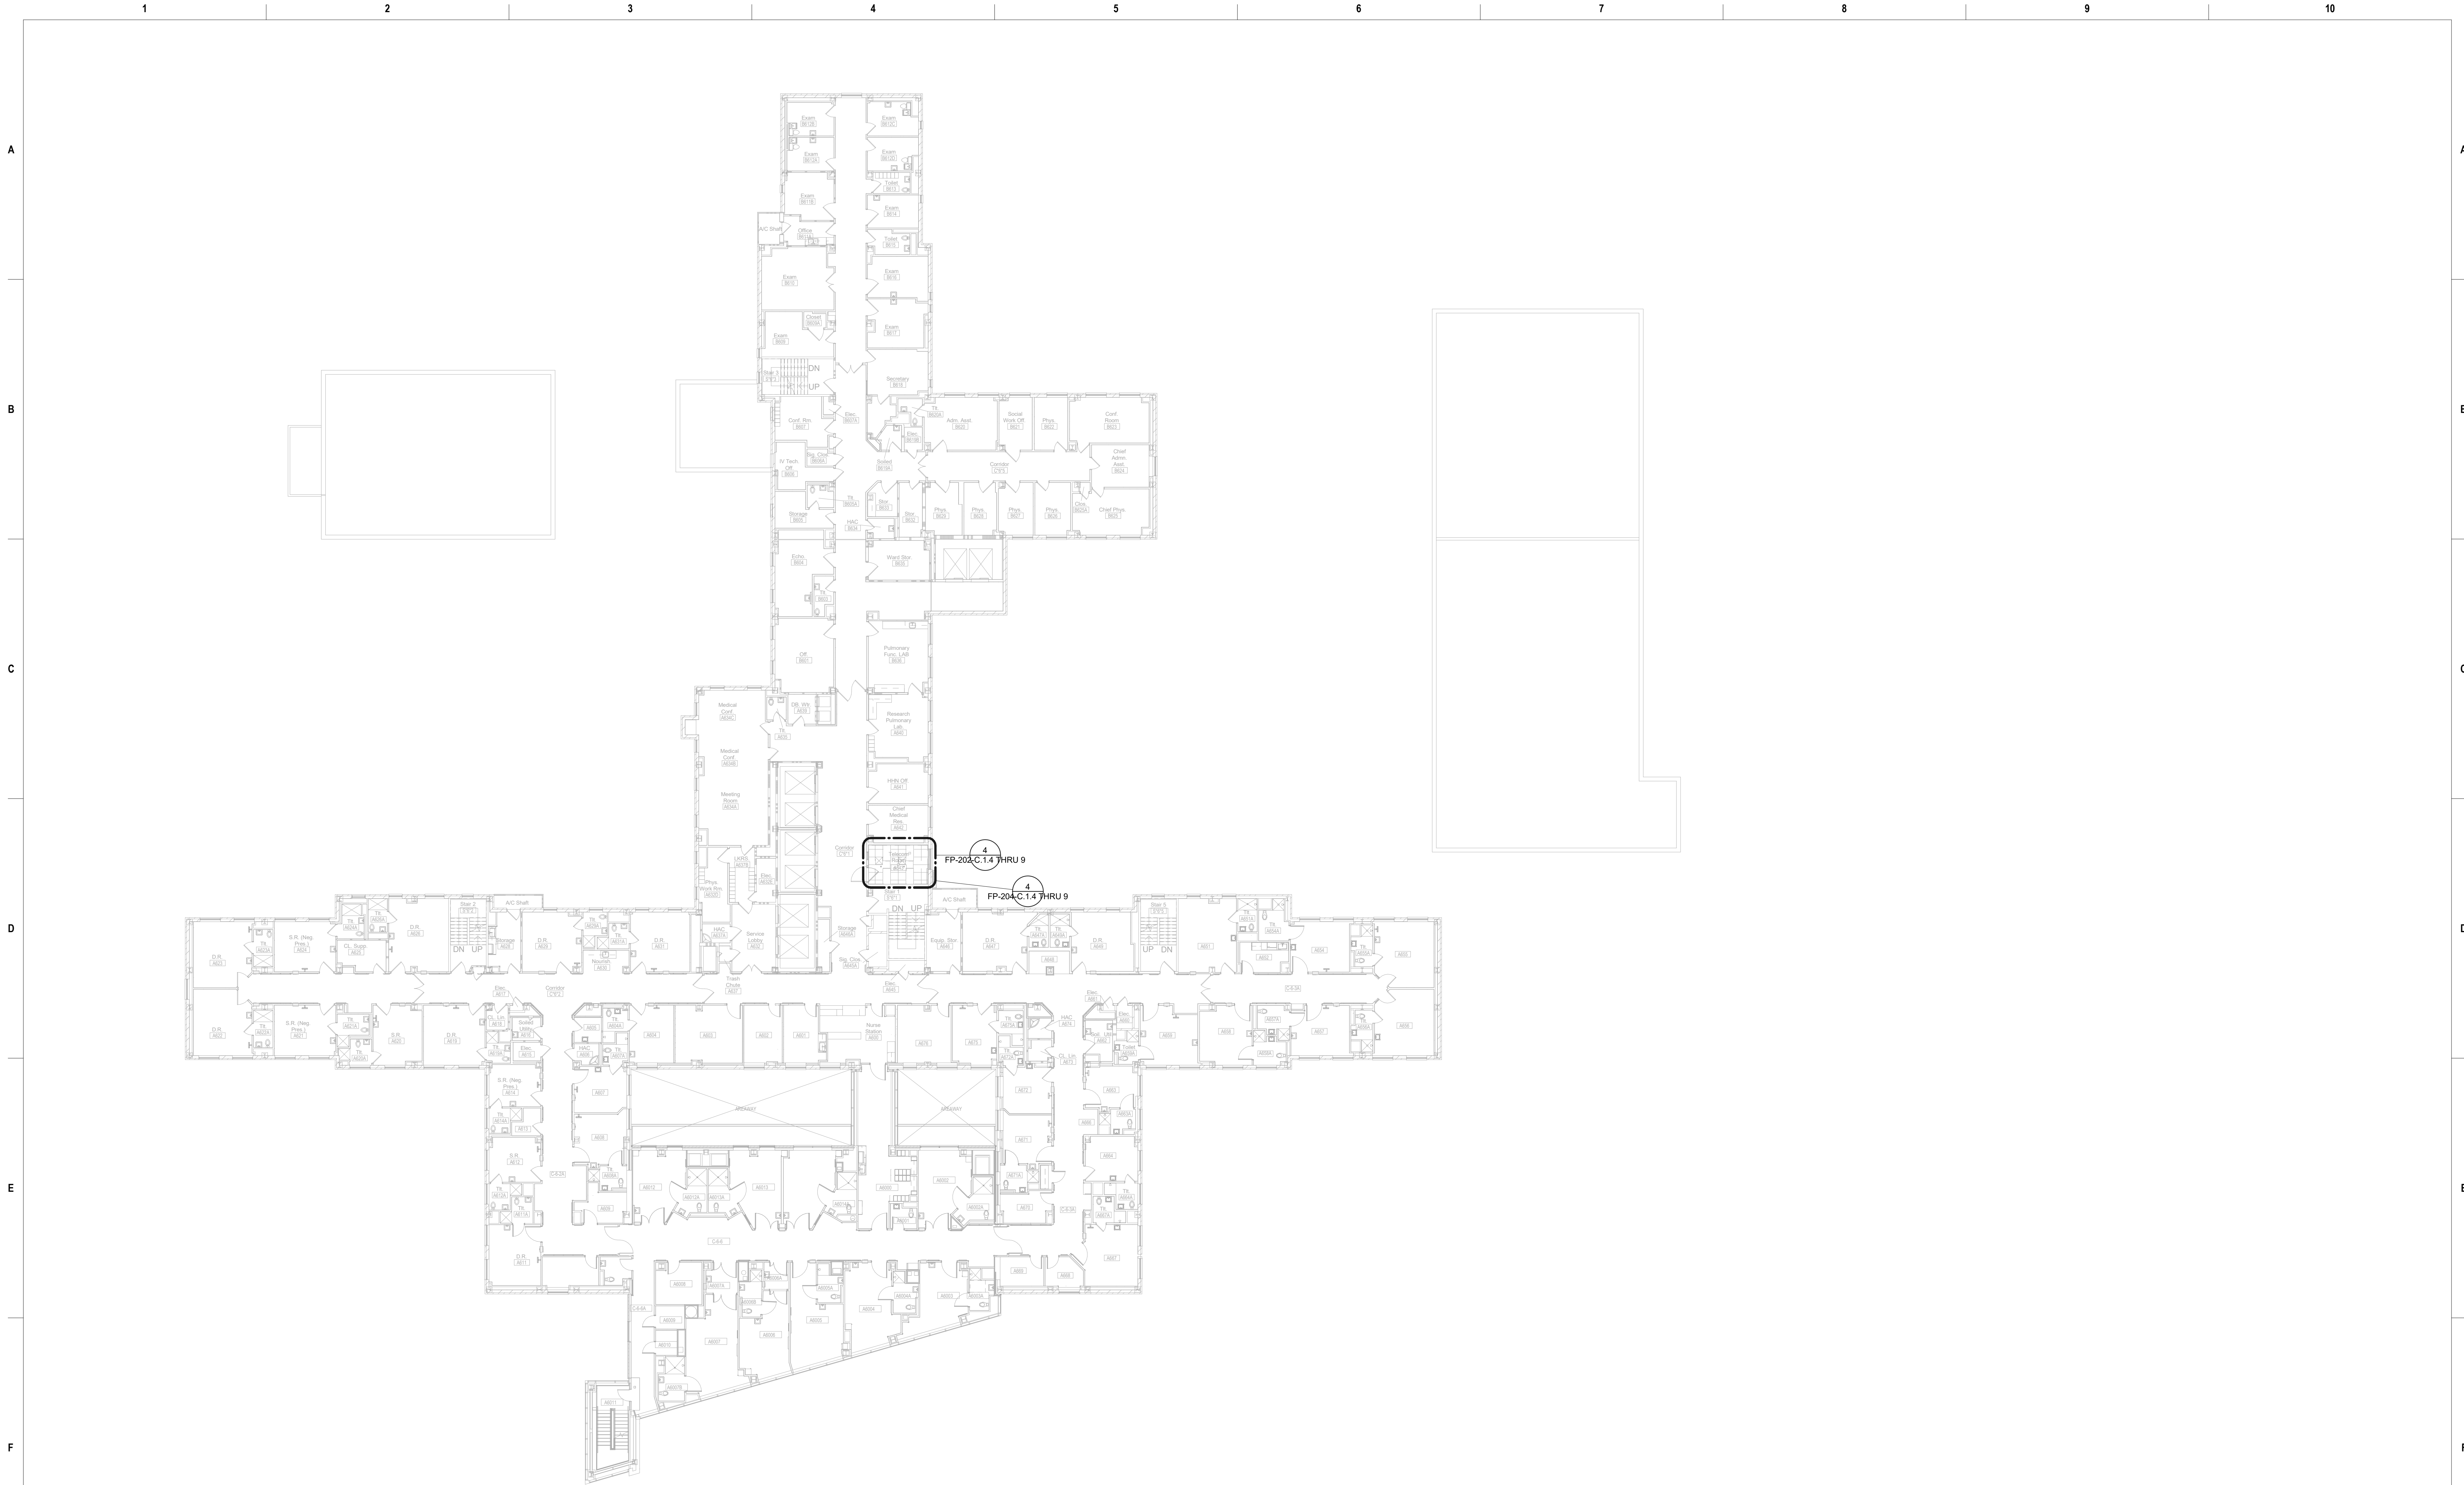

**FIRE PROTECTION - BUILDING #1 -  
OVERALL SIXTH FLOOR PLAN**

1/16" = 1'-0"

Revisions:	Date:

**CONSULTANT**

**Ross & Baruzzini**

6 SOUTH OLD ORCHARD  
WEBSTER GROVES, MO 63119  
T: 314.918.8383  
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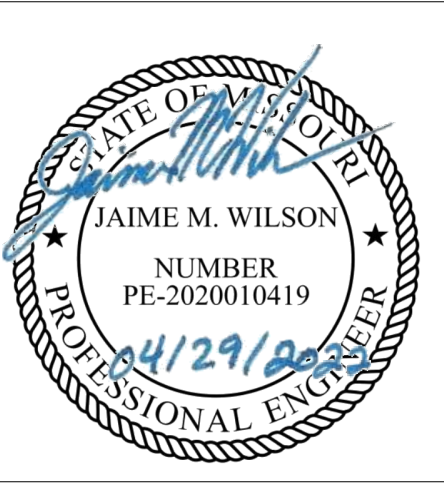
**ARCHITECT/ENGINEER OF RECORD**

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**Construction and Facilities Management**

**VA** U.S. Department of Veterans Affairs

Drawing Title  
**FIRE PROTECTION SIXTH FLOOR OVERALL PLAN**

Approved: Project Director

Phase  
**100% CONSTRUCTION DOCUMENTS**

**FULLY SPRINKLED**

Project Title  
**CINCINNATI VAMC EHRM INFRASTRUCTURE UPGRADES**

Location  
3200 VINE ST. CINCINNATI, OH.

Issue Date  
04-MAY-2022

Checked  
JA

Drawn  
DDP


Project Number  
**539-21-701**

Building Number  
**1**

Drawing Number  
**FP-170-C.1.6**

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Revisions:	Date:

CONSULTANT

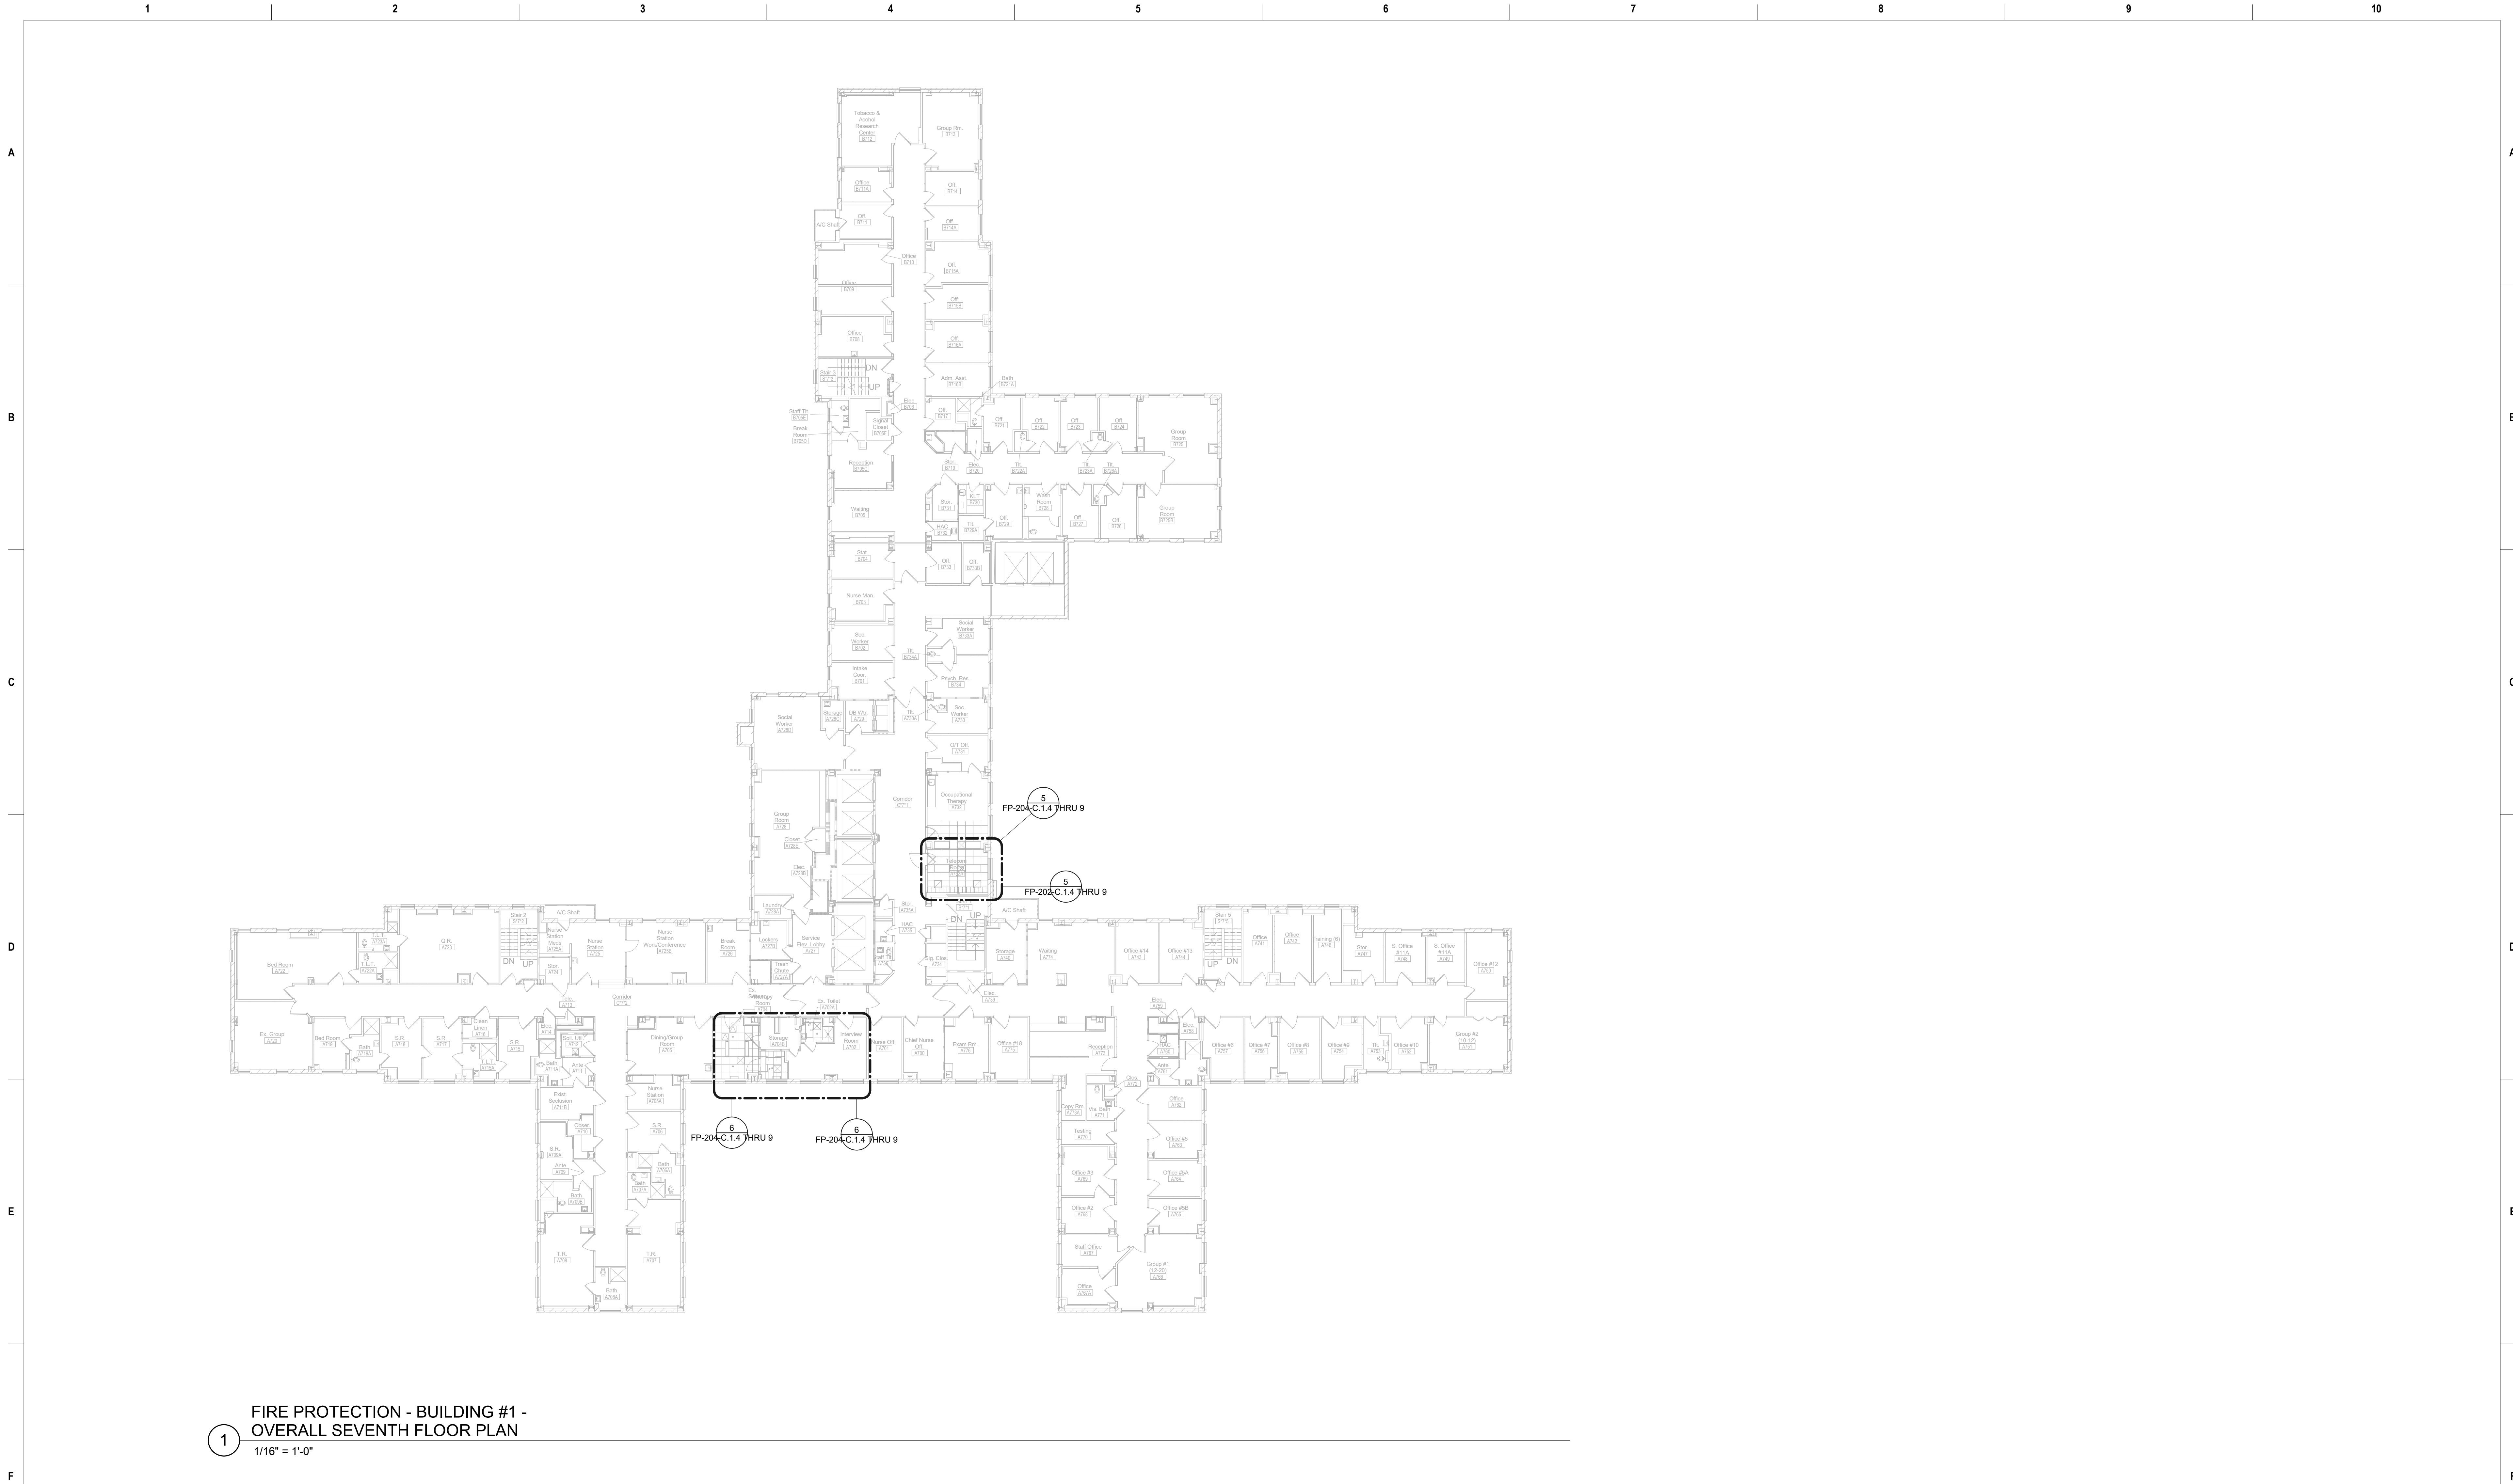**Ross & Baruzzini**

6 SOUTH OLD ORCHARD  
WEBSTER GROVES, MO. 63119  
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F: 314.918.1766


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Construction  
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**VA** U.S. Department  
of Veterans  
Affairs

Drawing Title

FIRE PROTECTION SEVENTH FLOOR  
OVERALL PLAN

Approved: Project Director

Phase

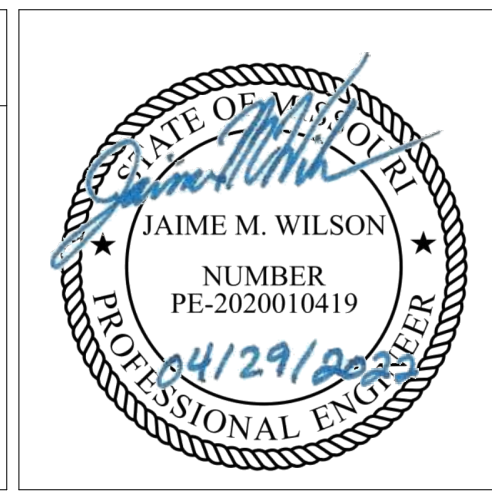100% CONSTRUCTION  
DOCUMENTS

FULLY SPRINKLED

Project Title

CINCINNATI VAMC EHRM  
INFRASTRUCTURE UPGRADES

Location

3200 VINE ST. CINCINNATI, OH.

Issue Date

04-MAY-2022

Checked

JA

Drawn

DDP

Project Number

539-21-701


Building Number

1

Drawing Number

FP-180-C.1.7




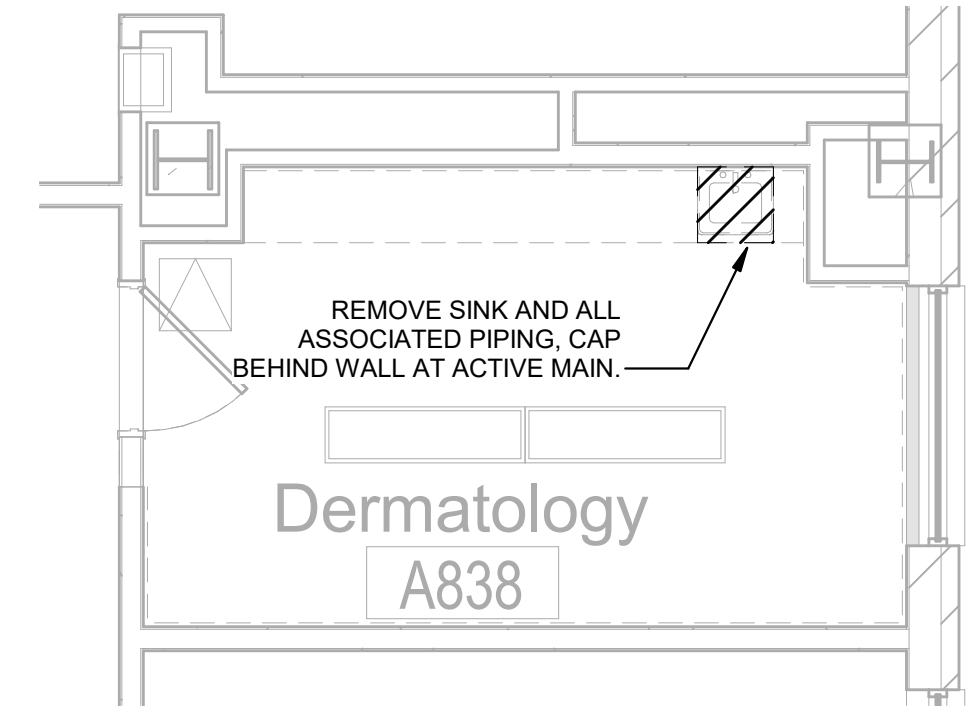

1 FIRE PROTECTION - BUILDING #1 -  
OVERALL EIGHTH FLOOR PLAN  
1/16" = 1'-0"

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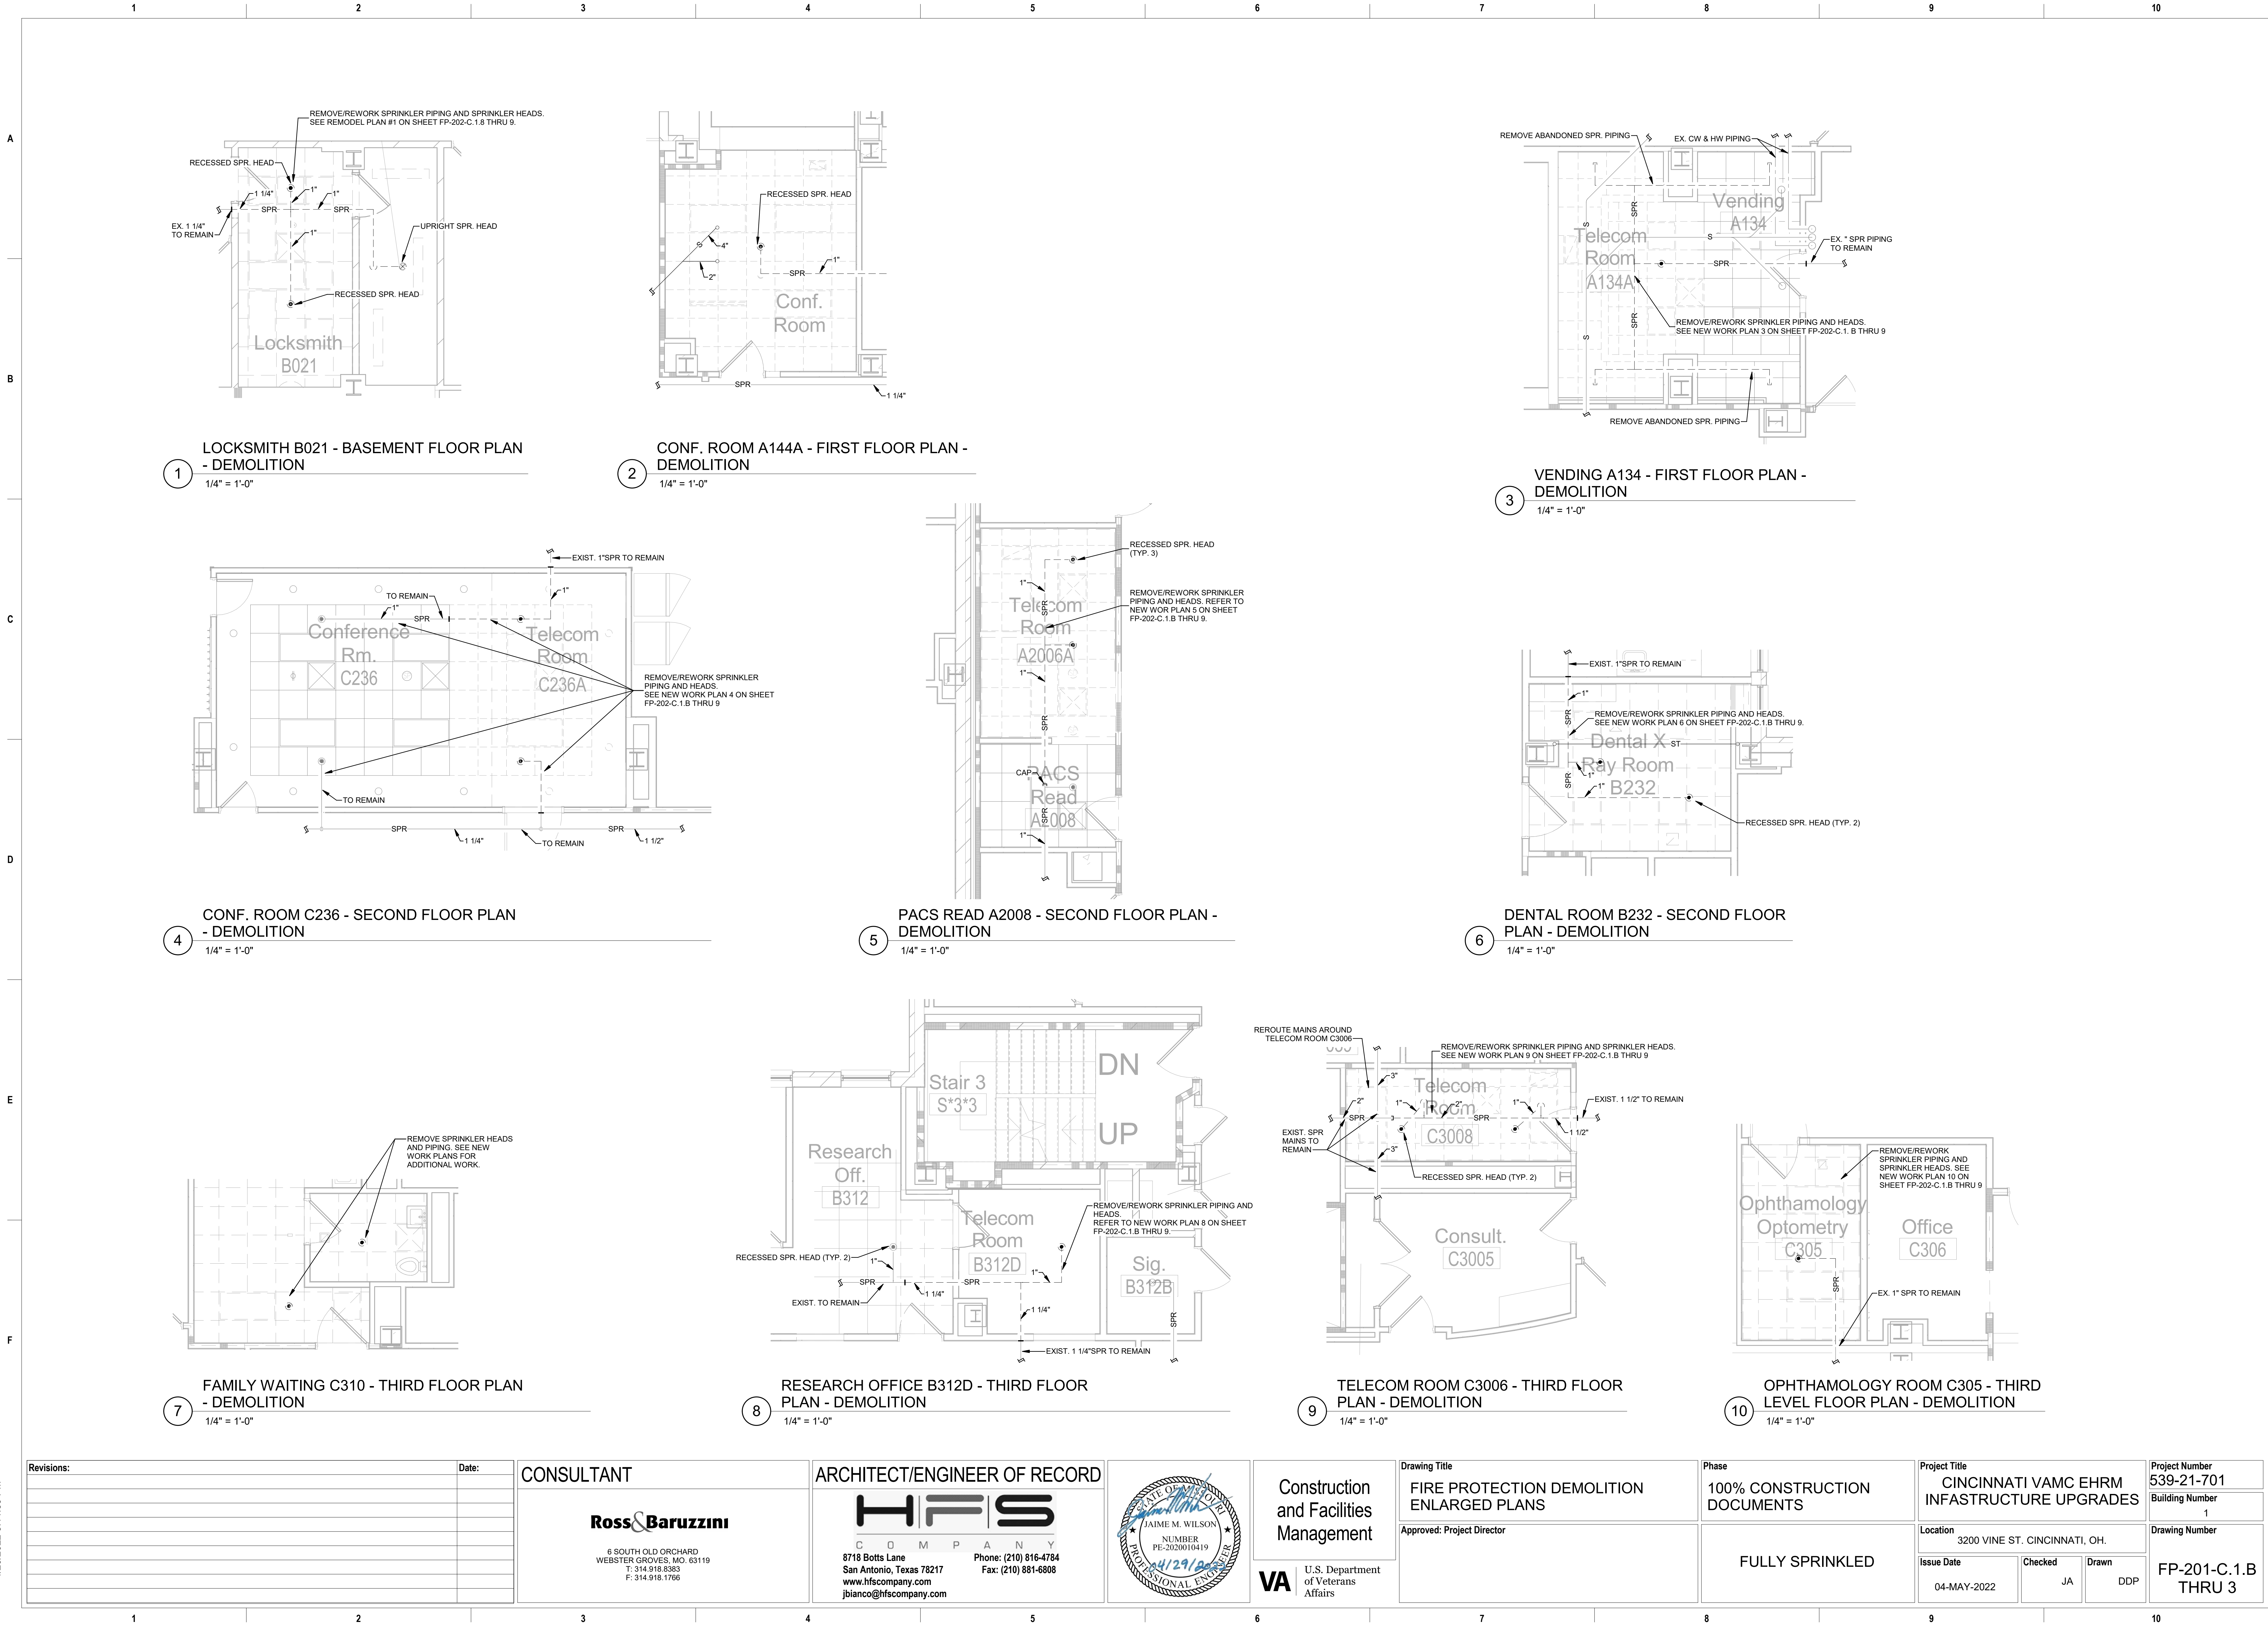


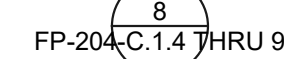

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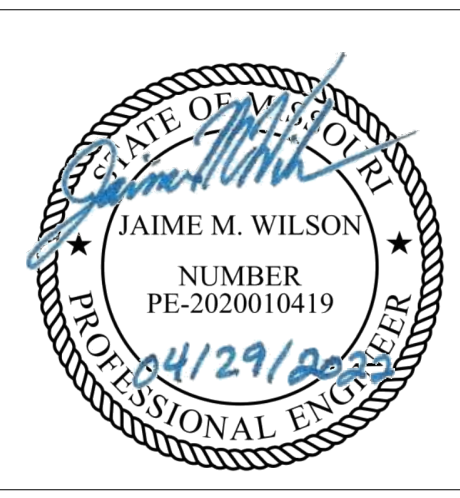


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Revisions:	Date:

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VA U.S. Department of Veterans Affairs


Drawing Title
FIRE PROTECTION DEMOLITION ENLARGED PLANS
Approved: Project Director

Phase
100% CONSTRUCTION DOCUMENTS
FULLY SPRINKLED

Project Title
CINCINNATI VAMC EHRM INFRASTRUCTURE UPGRADES
Location
3200 VINE ST. CINCINNATI, OH.
Issue Date
04-MAY-2022
Checked
JA
Drawn
DDP

Project Number
539-21-701
Building Number
1
Drawing Number
FP-201-C.1.B THRU 3



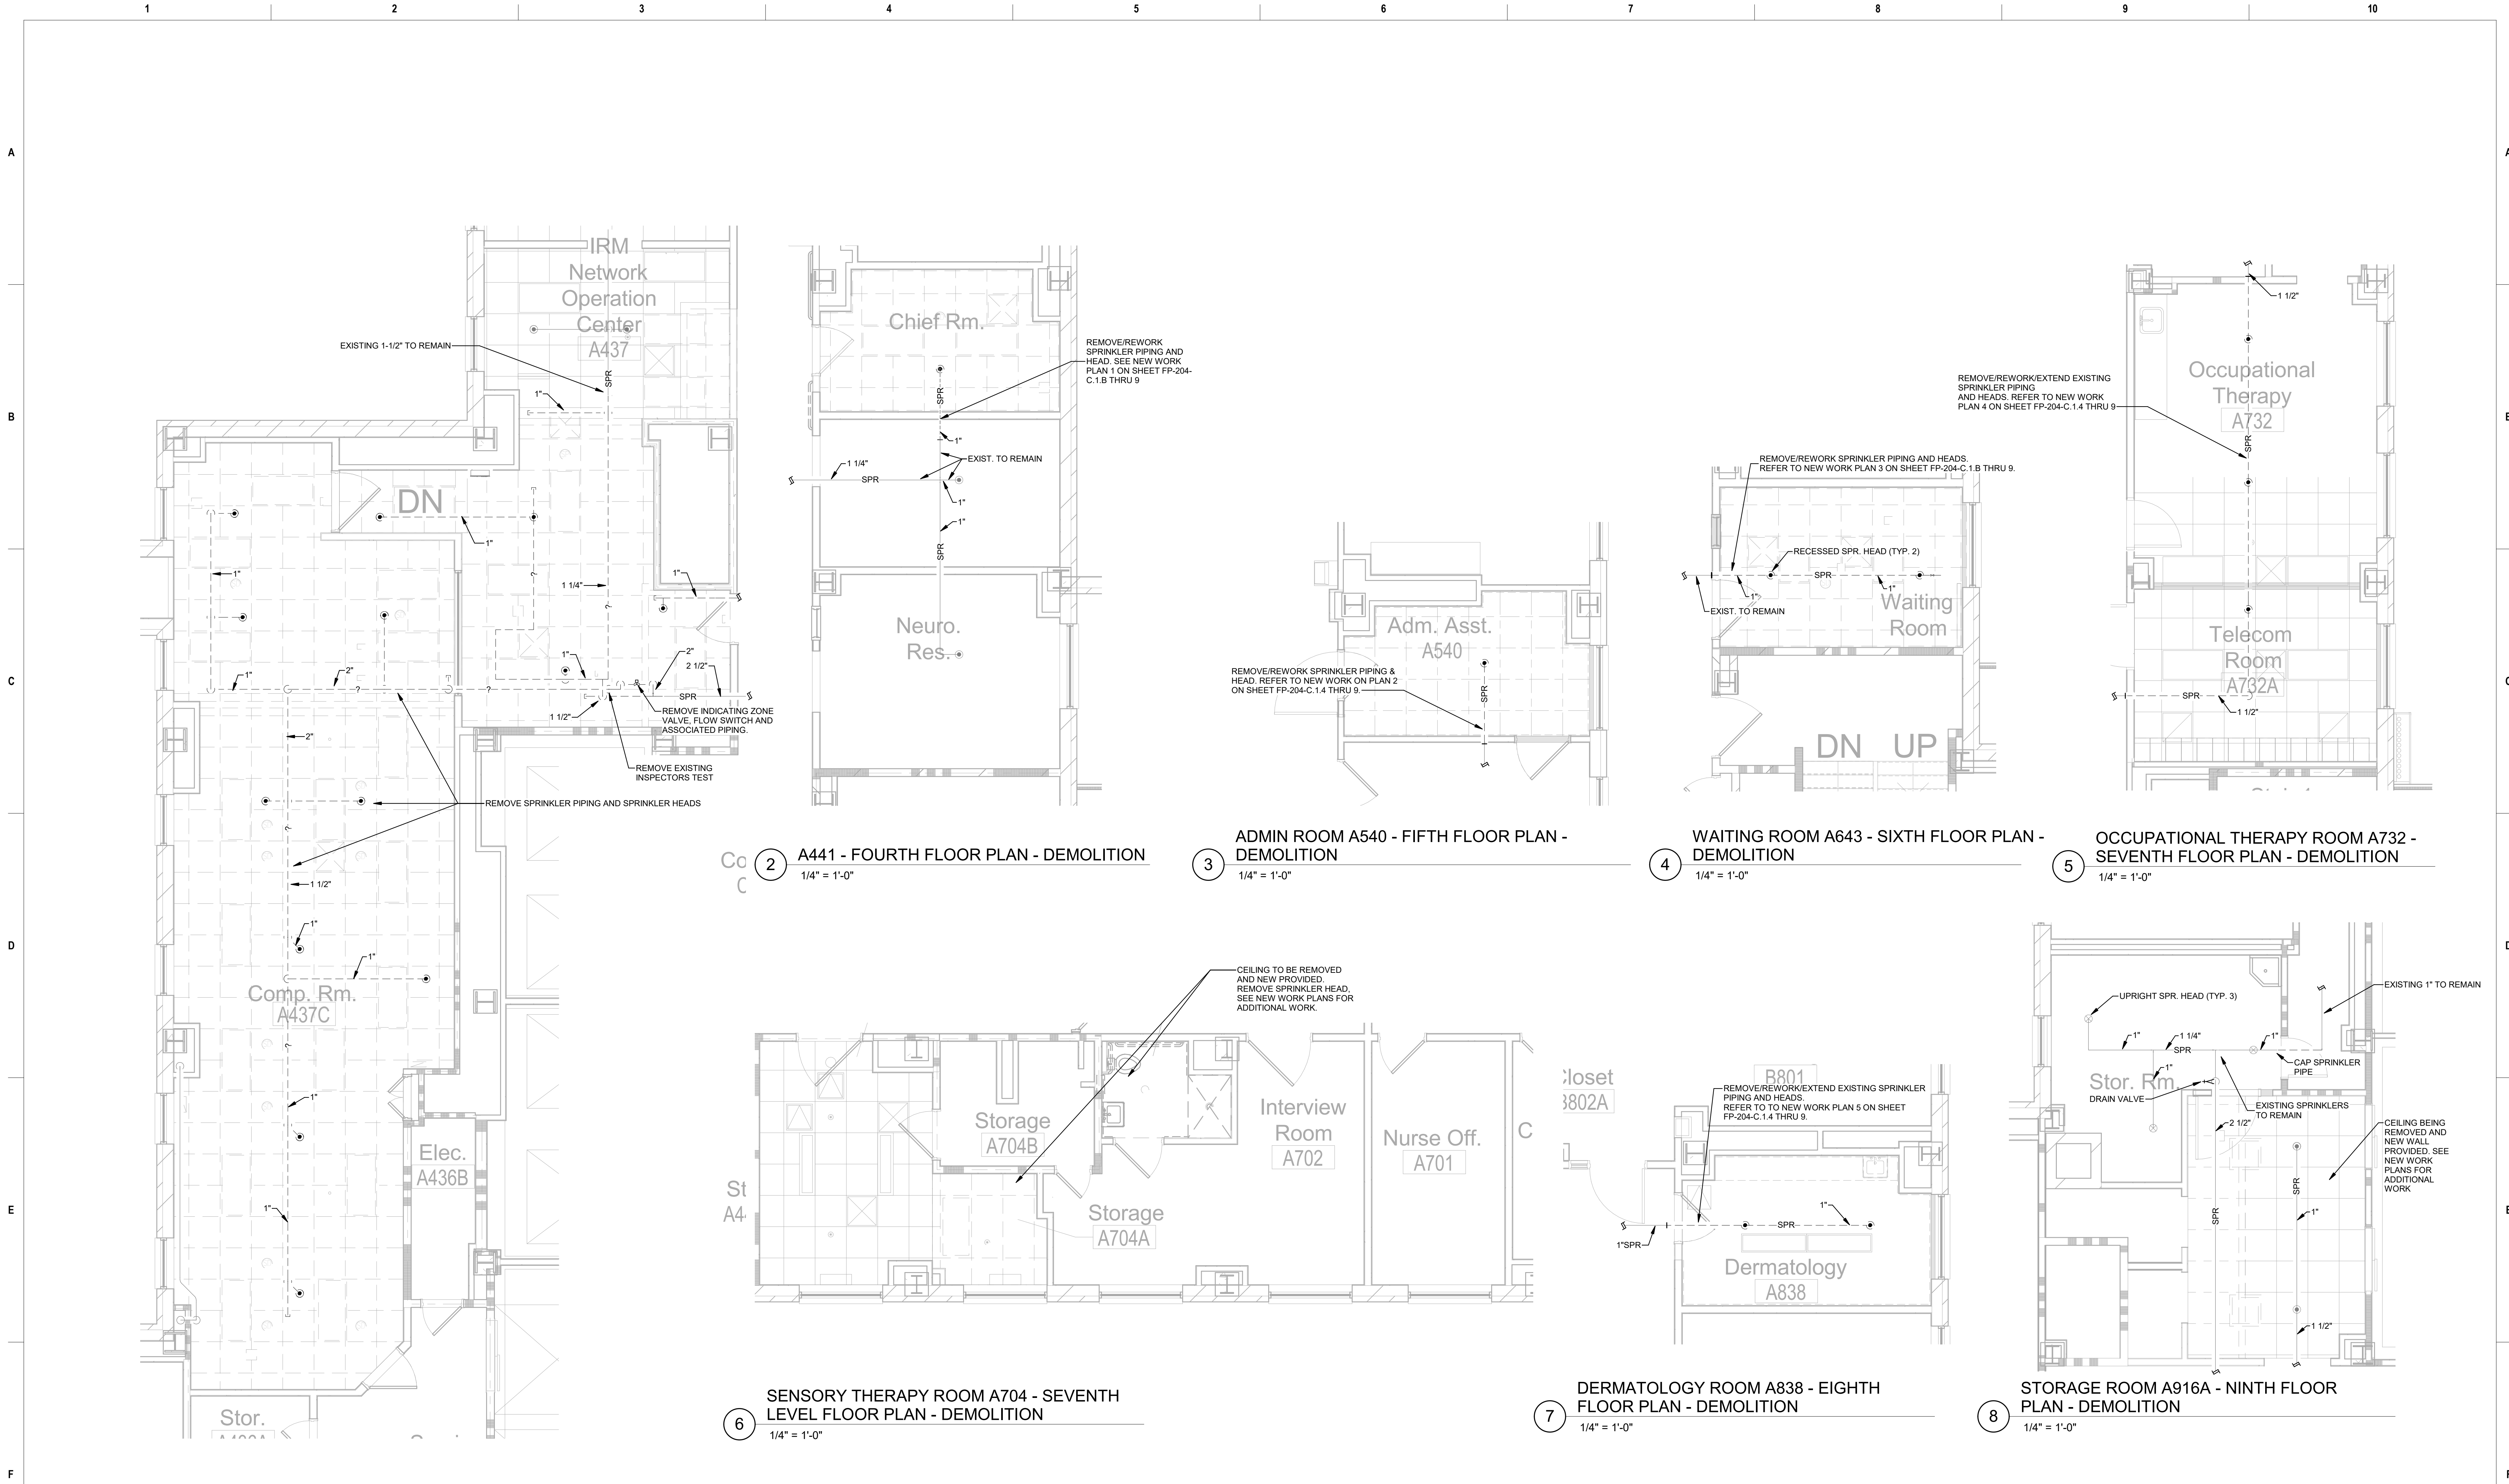

1 CONFERENCE ROOM A437 - FOURTH FLOOR PLAN - DEMOLITION  
1/4" = 1'-0"

2 A441 - FOURTH FLOOR PLAN - DEMOLITION  
1/4" = 1'-0"

3 ADMIN ROOM A540 - FIFTH FLOOR PLAN - DEMOLITION  
1/4" = 1'-0"

4 WAITING ROOM A643 - SIXTH FLOOR PLAN - DEMOLITION  
1/4" = 1'-0"

5 OCCUPATIONAL THERAPY ROOM A732 - SEVENTH FLOOR PLAN - DEMOLITION  
1/4" = 1'-0"

6 SENSORY THERAPY ROOM A704 - SEVENTH LEVEL FLOOR PLAN - DEMOLITION  
1/4" = 1'-0"

7 DERMATOLOGY ROOM A838 - EIGHTH FLOOR PLAN - DEMOLITION  
1/4" = 1'-0"

8 STORAGE ROOM A916A - NINTH FLOOR PLAN - DEMOLITION  
1/4" = 1'-0"

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Revisions:		Date:	CONSULTANT		ARCHITECT/ENGINEER OF RECORD		Drawing Title		Phase		Project Title		Project Number	
			<b>Ross &amp; Baruzzini</b>		<b>HFS</b>		FIRE PROTECTION DEMOLITION ENLARGED PLANS		100% CONSTRUCTION DOCUMENTS		CINCINNATI VAMC EHRM INFRASTRUCTURE UPGRADES		539-21-701	
			6 SOUTH OLD ORCHARD WEBSTER GROVES, MO. 63119 T: 314.918.8383 F: 314.918.1766		C O M P A N Y 8718 Botts Lane San Antonio, Texas 78217 www.hfscompany.com jbianco@hfscompany.com		Approved: Project Director		FULLY SPRINKLED		3200 VINE ST. CINCINNATI, OH.		Building Number	
											Issue Date		Drawing Number	
											04-MAY-2022		FP-202-C.1.4 THRU 9	
											Checked			
											JA			
											Drawn			
											DDP			